

- 3. THE CONTRACTOR MUST TAKE ALL NECESSARY SAFETY PRECAUTIONS TO PROTECT ABUTTING PROPERTY, UTILITIES, PEDESTRIANS, AND VEHICULAR TRAFFIC.
- 4. IT IS CALLED TO THE CONTRACTOR'S ATTENTION THAT CERTAIN PERMITS AND FEES WILL BE REQUIRED BY VARIOUS DEPARTMENTS OF THE CITY OF CHICAGO. ALL PERMITS ARE INCIDENTAL.
- PARKING METER AND PARKING PAY BOX WORK REQUIRED DUE TO CONSTRUCTION MUST BE PERFORMED BY THE CITY OF CHICAGO DEPARTMENT OF REVENUE ONLY. THE CONTRACTOR SHALL PAY ALL FEES REQUIRED BY SECTION 9-68-050 OF THE MUNICIPAL CODE OF CHICAGO. REFER TO ARTICLE 10, SECTION E OF THE PROJECT SPECIFICATIONS FOR FURTHER INFORMATION. THIS INCLUDES ANY AND ALL PARKING METERS AND PARKING PAY BOXES TO BE INSTALLED, REMOVED OR RELOCATED AT THE PROJECT LOCATION OR AT ANY AND ALL LOCATIONS DIRECTLY OR INDIRECTLY INVOLVED WITH THE PROJECT.
- 6. THE CTA SHALL REMOVE/REPLACE ALL CTA BUS STOP SIGNS AND BUS SHELTERS WITHIN THE PROJECT LIMITS. THE CONTRACTOR MUST CONTACT THE CTA AT TRAFFIC.PLANNING@TRANSITCHICAGO.COM AT LEAST TWO WEEKS PRIOR TO SIDEWALK REMOVAL OPERATIONS TO COORDINATE THIS WORK.
- 7. PRIOR TO THE START OF CONSTRUCTION, THE CONTRACTOR MUST SUBMIT A PROPOSED CONSTRUCTION SCHEDULE IN A FORMAT APPROVED BY THE PBC / COMMISSIONER. NO WORK WILL BE PERMITTED TO PROCEED UNTIL THE PROPOSED SCHEDULE IS REVIEWED AND APPROVED BY THE PBC / COMMISSIONER.
- 8. THE CITY / PBC RESERVES THE RIGHT TO ORDER, IN WRITING, CHANGES IN THE WORK OR THE CONTRACT TIME. THESE CHANGES MAY CONSIST OF ADDITIONS, DELETIONS OR OTHER REVISIONS, AT THE DISCRETION OF THE CITY / PBC.
- 9. WHEN UNSEEN CIRCUMSTANCES IMPACT THE CONTRACTORS APPROVED CONSTRUCTION SCHEDULE, IT MAY BE NECESSARY TO ADJUST OR REVISE THE SCHEDULE IN ORDER TO MAINTAIN PROGRESS AND PROVIDE FOR PEDESTRIAN AND VEHICULAR SAFETY, THE CONTRACTOR SHALL COOPERATE FULLY WITH THE PBC AND THE CITY IN THIS REGARD.
- 10. LANE CLOSURES, WORK ZONE RESTRICTIONS, REVISED WORK DAY HOURS AND WEEKEND OR HOLIDAY WORK SCHEDULES ARE SUBJECT TO THE APPROVAL OF THE COMMISSIONER, THE CONTRACTOR MUST RECEIVE WRITTEN AUTHORIZATION, EITHER BY PERMIT OR NOTIFICATION BY THE COMMISSIONER, BEFORE PROCEEDING WITH WORK UNDER THESE CIRCUMSTANCES.
- 11. THE CONTRACTOR MUST NOTIFY THE DEPARTMENT OF STREETS AND SANITATION AT (312) 746-4524 72 HOURS PRIOR TO THE NEED FOR TOWING RELOCATION OF VEHICLES, THE CITY OF CHICAGO WILL BE RESPONSIBLE FOR REMOVING PARKED VEHICLES LOCATED IN THE SCHEDULED WORK AREA. SIGNS PREVENTING PARKING WILL BE POSTED BY THE COMMISSIONER OR HIS STAFF 72 HOURS BEFORE THE WORK IS SCHEDULED. PRIOR TO POSTING SIGNS THE COMMISSIONER SHALL NOTIFY THE ALDERMAN'S OFFICE OF THE RECONSTRUCTION SCHEDULE. THE POLICE ARE TO BE PRESENT TO ISSUE TICKETS AND SUPERVISE TOWING PRIOR TO THE RELOCATION OF VEHICLES.
- 12. THE CONTRACTOR SHALL FURNISH THE NAME(S) OF THE QC MANAGER LEVEL II TECHNICIAN ASSIGNED TO THE PROJECT AT THE TIME OF THE PRE-CONSTRUCTION MEETING.
- 13. 10 FEET TRANSITIONS SHALL BE USED TO MATCH PROPOSED CURB AND GUTTER AND MEDIAN ITEMS OF WORK TO EXISTING CURB AND GUTTER AND MEDIAN IN THE FIELD, UNLESS OTHERWISE SHOWN. THE TRANSITIONS SHALL BE PAID FOR AT THE CONTRACT UNIT PRICE FOR THE PROPOSED ITEMS OF WORK SPECIFIED IN THIS CONTRACT.
- 14. THE CONTRACTORS SHALL COORDINATE ACTIVITIES WITH UTILITY COMPANIES, THE PBC, AND THE CITY OF CHICAGO.
- 15. BUTT JOINTS SHALL BE INSTALLED AT THE ENDS OF ALL RESURFACING (WHERE RESURFACING MEETS THE EXISTING PAVEMENT), IN ACCORDANCE WITH THE "BUTT JOINT DETAILS AT INTERSECTIONS".
- 16. THREE QUARTER INCH (3/4") THICK EXPANSION JOINT SHALL BE PLACED BETWEEN THE SIDEWALK AND ALL STRUCTURES SUCH AS ADJACENT BUILDINGS, CURBS, LIGHT STANDARDS TRAFFIC LIGHT STANDARDS AND MANHOLES WHICH EXTEND THROUGH THE SIDEWALK. THIS WORK SHALL BE CONSIDERED INCIDENTAL TO THE COST OF PCC SIDEWALK.
- 17. CONTRACTOR IS TO RESTORE ALL UNPAVED AREAS DAMAGED DURING CONSTRUCTION OPERATIONS TO THEIR ORGINAL CONDITION INCLUDING THE FINE GRADING AND SODDING BEYOND THE AREA OF THE PROPOSED SEEDING AND SODDING, AS SHOWN ON THE STANDARD DETAILS. AT NO ADDITIONAL COST TO THE CITY.
- 18. IT SHALL BE THE CONTRACTOR'S RESPONSIBILITY TO VERIFY ALL DIMENSIONS AND CONDITIONS EXISTING IN THE FIELD PRIOR TO ORDERING MATERIALS AND BEGINNING OF CONSTRUCTION.
- 19. PAY ITEMS IN THE SUMMARY OF QUANTITIES HAVE BEEN ESTIMATED. IF, IN THE PBC'S AND ENGINEER'S OPINION, THE WORK IS NOT REQUIRED, THE ITEM WILL BE DEDUCTED FROM THE CONTRACT AND NO ADDITIONAL COMPENSATION TO THE CONTRACTOR WILL BE ALLOWED.
- 20. BUS PAD STANDARD DIMENSION SHALL BE 10' X 80' AND SHALL BE INSTALLED AFTER THE PLACEMENT OF THE FINAL SURFACE COURSE. THE FINAL LOCATION OF ALL BUS STOPS PADS MUST BE VERIFIED IN THE FIELD AND APPROVED BY THE COMMISSIONER PRIOR TO CONSTRUCTION.
- 21. THE CONTRACTOR SHALL IMMEDIATELY NOTIFY THE DEPARTMENT OF TRANSPORTATION AND THE PBC OF ANY DAMAGE TO CITY OWNED AND MAINTANED TRAFFIC SIGNS, SIGNALS, GUARDRAILS, FENCES, ETC.
- 22. THE ENTIRE AREA WHICH IS TO RECEIVE BITUMINOUS MATERIAL (TACK COAT) SHALL BE SWEPT CLEAN BEFORE THE MATERIAL APPLICATION. SWEEPINGS SHALL NOT BE DEPOSITED IN THE GUTTER OR ON THE CURB, PARKWAY, OR SIDEWALK, BUT SHALL BE PICKED UP AND DISPOSED OF PROPERLY.

- 23. THE CONTRACTOR SHALL COMPLY WITH THE REQUIREMENTS OF THE SSRBC AND THE ILLINOIS ENVIRONMENTAL PROTECTION AGENCY (IEPA) AS REGARDS TO THE DISPOSAL OF EXCAVATED MATERIALS. THE CONTRACTOR SHALL BE RESPONSIBLE FOR TESTING FOR THE PRESENCE OF CONTAMINATED SUBSTANCES PRIOR TO STARTING ANY EXCAVATION ACTIVITIES, BASED ON THE RESULTS OF THE ENVIRONMENTAL TESTING, THE CONTRACTOR SHALL MAKE ALL NECESSARY ARRANGEMENTS TO LEGALLY DISPOSE OF ALL EXCAVATED MATERIALS. MATERIALS CLASSIFIED AS 'CLEAN CONSTRUCTION OR DEMOLITION DEBRIS' ('CCDD') OR 'NON-HAZARDOUS NON-SPECIAL WASTE' AS PER IEPA CRITERIA, SHALL BE INCLUDED AND CONSIDERED INCIDENTAL TO THE INDIVIDUAL REMOVAL AND EXCAVATION ITEMS IN THE CONTRACT. A LICENSED PROFESSIONAL ENGINEER REPRESENTING THE CONTRACTOR SHALL PREPARE AND EXECUTE ALL IEPA REQUIRED FORMS AND CERTIFICATIONS NECESSARY TO LEGALLY DISPOSE OF ALL EXCAVATED MATERIALS.
- 24. CONTRACTOR WILL BE REQUIRED TO PREPARE A PHASING AND LOGISTICS PLAN WITHIN THIRTY (30) DAYS OF ISSUANCE OF THE NOTICE TO PROCEED ('NTP') FOR REVIEW AND APPROVAL BY CDOT AND PBC, PRIOR TO THE MOBILIZATION AND COMMENCEMENT OF ANY WORK. THE CONTRACTOR SHALL ALSO BE RESPONSIBLE FOR PROVIDING CRITICAL SUBMITTALS, AS DETERMINED BY THE PBC, WITHIN THIRTY (30) DAYS OF ISSUANCE OF THE NTP.

MAINTENANCE OF TRAFFIC NOTES

- 1. TRAFFIC WILL BE MAINTAINED ON ALL STREETS AND PARKING WILL BE PROHIBITED WITHIN 50 FEET OF THE CONSTRUCTION AREA AT ALL TIMES. THE CONTRACTOR IS REQUIRED TO NOTIFY THE DIVISION OF ENGINEERING-TRAFFIC SECTION 48 HOURS BEFORE COMMENCING CONSTRUCTION.
- WHEN THE PAVEMENT CONSTRUCTED IS PORTLAND CEMENT CONCRETE BASE COURSE OR PORTLAND CEMENT CONCRETE PAVEMENT, IT SHALL NOT BE OPENED TO TRAFFIC, INCLUDING CONSTRUCTION TRAFFIC, UNTIL AFTER THE SPECIFIED CURING PERIOD AS DEFINED IN ARTICLE 701.17(c)(5) OF THE 'STANDARD SPECIFICATIONS' AND UNTIL THE JOINTS HAVE BEEN SEALED.
- THE CONTRACTOR'S VEHICLES SHALL ALWAYS MOVE WITH AND NOT AGAINST OR ACROSS THE FLOW OF TRAFFIC. THESE VEHICLES SHALL ENTER OR LEAVE THE WORK AREA IN A MANNER WHICH WILL NOT BE HAZARDOUS TO OR INTERFERE WITH NORMAL TRAFFIC AND SHALL NOT PARK OR STOP EXCEPT WITHIN DESIGNATED WORK AREAS. PERSONAL VEHICLES WILL NOT BE PERMITTED TO PARK WITHIN THE RIGHT-OF-WAY EXCEPT IN SPECIFIC AREAS DESIGNATED BY THE COMMISSIONER.
- ACCESS TO EXISTING CROSS ROADS AND DRIVES MUST BE MAINTAINED AT ALL TIMES DURING CONSTRUCTION.
- ADEQUATE PROVISIONS FOR PEDESTRIAN TRAFFIC MUST BE PROVIDED AT ALL TIMES.
- FOR ADDITIONAL REQUIREMENTS, SEE CDOT SPECIAL PROVISION FOR TRAFFIC CONTROL COMPLETE IN BOOK 3.
- IN AREAS WHERE MULTIPLE LOCATIONS ARE PROPOSED TO BE CONSTRUCTED, THE CONTRACTOR WILL BE REQUIRED TO STAGE WORK SO AS NOT TO ADVERSELY AFFECT THE FLOW OF PEDESTRIAN AND VEHICULAR TRAFFIC WITHIN THE GENERAL AREA. THE PROPOSED CONSTRUCTION SCHEDULE SHOULD REFLECT A PROGRESSION OF WORK THAT WILL MAINTAIN TRAFFIC TO THE SATISFACTION OF THE COMMISSIONER.
- STOCKPILING OF EXCAVATED MATERIALS AND/OR CONSTRUCTION DEBRIS ON THE JOBSITE WILL NOT BE PERMITTED AND SHALL BE REMOVED FROM THE JOBSITE EACH AND EVERY DAY AND DISPOSED OF IN ACCORDANCE WITH ARTICLE 202,03 OF THE STANDARD SPECIFICATIONS. FAILURE TO COMPLY WITH THIS REQUIREMENT SHALL BE CONSIDERED A TRAFFIC CONTROL DEFICIENCY WILL BE SUBJECT TO THE CHARGES IN ACCORDANCE WITH THE ITEM TRAFFIC CONTROL COMPLETE.
- "FRESH OIL" SIGNS MUST BE POSTED AT ALL INGRESSES TO PRIMED SURFACES. FAILURE TO INSTALL AND MAINTAIN THESE SIGNS WILL BE CONSIDERED A TRAFFIC CONTROL DEFICIENCY AND THE CONTRACTOR SHALL BE SUBJECT TO CHARGES IN ACCORDANCE WITH THE ITEM TRAFFIC CONTROL COMPLETE.
- 10. THE CONTRACTOR SHALL PROTECT ALL SECTIONS OF NEWLY COMPACTED HMA SURFACE COURSES FROM PEDESTRIAN AND VEHICULAR TRAFFIC UNTIL THEY COOL DOWN TO THE SATISFACTION OF THE COMMISSIONER, DAMAGES TO THE MAT SHALL BE FIXED IMMEDIATELY TO THE SATISFACTION OF THE COMMISSIONER.
- 11. IN THE EVENT THAT THE CONTRACTOR CANNOT FINISH THE MILLING AND/OR PAVING OPERATION DUE TO DELAYS CAUSED BY THE CITY OR PRIVATE UTILITY WORK OR ADJACENT CONSTRUCTION AND MOVES TO ANOTHER LOCATION, OR TERMINATES HIS OPERATION, THE CONTRACTOR MUST FINISH THE MILLING AND/OR PAVING OPERATION AS SOON AS SAID LOCATION IS CLEARED OF ALL CONFLICTING WORK AT NO ADDITIONAL COST TO THE CITY.

CIVIL NOTES

- 1. THE ENTIRE AREA WHICH IS TO RECEIVE 'BITUMINOUS MATERIALS (PRIME COAT)' MUST BE SWEPT CLEAN BEFORE THE MATERIAL IS APPLIED. THE SWEEPINGS WILL NOT BE DEPOSITED IN THE GUTTER OR ON THE CURB, PARKWAY, OR SIDEWALK, BUT ARE TO BE PICKED UP AND DISPOSED OF PROPERLY BEYOND THE LIMITS OF THE PROJECT ON THE SAME DAY THAT THE SWEEPING IS DONE. THE WORK WILL NOT BE PAID FOR SEPARATELY, BUT WILL BE CONSIDERED INCIDENTAL TO 'BITUMINOUS MATERIALS (PRIME COAT)'.
- IF AN EXISTING MAILBOX MUST BE REMOVED OR RELOCATED TO COMPLETE THE WORK, THE CONTRACTOR MUST NOTIFY THE POST OFFICE AND THE PBC. THE COST OF ANY COORDINATION WITH THE POST OFFICE WILL BE CONSIDERED INCIDENTAL TO 'SIDEWALK REMOVAL'.
- THE EXISTING PAVEMENT IS REQUIRED TO BE SAWCUT IN ORDER TO PROVIDE FOR A STRAIGHT EDGE BUTT JOINT WHERE COMBINATION CONCRETE CURB AND GUTTER IS TO BE REPLACED, WHERE FULL DEPTH PATCHES ARE TO BE CONSTRUCTED, WHERE TRENCHES FOR PROPOSED DRAINAGE STRUCTURES ARE TO BE EXCAVATED, AS SHOWN ON THE PLANS, AND AS DIRECTED BY THE COMMISSIONER. FOR COMBINATION CONCRETE CURB AND GUTTER, THE SAWCUT IS REQUIRED TO BE DEEP ENOUGH TO PENETRATE THE EXISTING BASE COURSE WHERE NECESSARY TO ASSURE A STRAIGHT EDGE FOR THE FULL DEPTH OF COMBINATION CONCRETE CURB AND GUTTER. FOR PATCHES AND DRAINAGE STRUCTURES, THE SAWCUT SHALL BE FULL DEPTH. ALL OTHER SAWCUTTING WILL BE TO THE DEPTHS SHOWN ON THE PLANS OR GIVEN IN THE SPECIFICATIONS.

- 4. ALL ELEVATIONS SHOWN ON THE PLANS ARE BASED ON CHICAGO CITY DATUM WHICH IS 579.88 FEET ABOVE MEAN SEA LEVEL, 1935 ADJUSTMENT.
- 5. THE CONTRACTOR SHALL INFORM THE COMMISSIONER AND THE PBC 72 HOURS PRIOR TO REMOVING ANY STREET CAR TRACKS. THE COMMISSIONER WILL VERIFY THAT THE TRACKS AND/OR THE BURIED NEGATIVE GROUND CABLE IS NOT BEING USED FOR ELECTROLYSIS.
- 6. THE GENERAL CONTRACTOR IS REQUIRED TO HIRE AN ENVIRONMENTAL FIRM TO CONTINUOUSLY MONITOR THE WORKER SAFETY AND SOIL CONTAMINATION AT SEVERAL LOCATIONS. SEE SPECIAL PROVISION AND SUPPLMENTAL SPECIFICATIONS FOR DETAILS.
- 7. CURB AND GUTTER CONSTRUCTION SHALL PROVIDE A MINIMUM CURB HEIGHT OF 3 INCHES AND A MAXIMUM HEIGHT OF 9 INCHES.
- THE COST OF REMOVING BRICKS WITHIN SIDEWALK REMOVAL LIMITS SHALL BE CONSIDERED INCLUDED IN THE COST OF SIDEWALK REMOVAL. REMOVAL OF EXISTING BENCHES, BICYCLE RACKS, AND TRASH RECEPTACLES WILL BE CONSIDERED INCLUDED IN THE COST OF SIDEWALK REMOVAL.
- THE CONTRACTOR SHALL CHECK THE ELEVATION AT THE PROPERTY LINE BEFORE SETTING THE TOP OF CURB ELEVATION AND, IF NECESSARY, SHALL ALTER THE CURB EXPOSED AND/OR GUTTER ELEVATION TO MEET THE ADJACENT PROPERTY LINE ELEVATION TO THE SATISFACTION OF THE COMMISSIONER.
- 10. ALL WORK MUST CONFORM TO THE MOST CURRENT CHICAGO DEPARTMENT OF TRANSPORTATION RULES AND REGULATIONS FOR WORK IN THE PUBLIC WAY IN COMPLIANCE WITH THE AMERICANS WITH DISABILITY ACT, AVAILABLE ON THE CITY OF CHICAGO WEBSITE.

UTILITY NOTES

- 1. PLAN DIMENSIONS AND DETAILS RELATIVE TO EXISTING STRUCTURES HAVE BEEN TAKEN FROM EXISTING PLANS AND ARE SUBJECT TO NOMINAL CONSTRUCTION VARIATIONS. IT SHALL BE THE CONTRACTOR'S RESPONSIBILITY TO VERIFY SUCH DIMENSIONS AND DETAILS IN THE FIELD AND MAKE THE NECESSARY APPROVED ADJUSTMENTS PRIOR TO CONSTRUCTION OR ORDERING MATERIALS. SUCH VARIATIONS WILL NOT BE CAUSE FOR ADDITIONAL COMPENSATION FOR A CHANGE IN THE SCOPE OF THE WORK; HOWEVER, THE CONTRACTOR WILL BE PAID AT THE CONTRACT UNIT PRICE FOR THE WORK.
- 2. THE CONTRACTOR IS RESPONSIBLE FOR CONTACTING THE CHICAGO UTILITY ALERT NETWORK AT (312) 744-7000 OR J.U.L.I.E. AT (800) 892-0123 SO THAT UTILITIES AND THEIR APPURTENANCES MAY BE LOCATED AND ADJUSTED OR MOVED, IF NECESSARY, AT LEAST 48 HOURS PRIOR TO THE START OF CONSTRUCTION OPERATIONS. THE CONTRACTOR MUST COOPERATE WITH ALL UTILITY OWNERS AS PROVIDED FOR IN THE 'STANDARD SPECIFICATIONS'.
- THE CITY DOES NOT GUARANTEE THE COMPLETENESS OR ACCURACY OF THE INFORMATION SHOWN ON THE PLANS REGARDING UTILITIES, EITHER PUBLIC OR PRIVATE, SUCH AS SEWERS, MANHOLES, CATCH BASINS, GAS AND WATER MAIN, TELEPHONE AND ELECTRICAL DUCT LINES, AND SIMILAR STRUCTURES. THE CONTRACTOR MUST VERIFY THE EXACT LOCATION OF ALL UTILITIES THAT MAY INTERFERE WITH THE CONSTRUCTION OPERATIONS AND MUST REPORT TO THE COMMISSIONER ANY OMISSIONS AND DIFFERENCES FROM LOCATIONS SHOWN ON THE PLANS. THE COST OF THIS WORK WILL BE CONSIDERED INCIDENTAL TO THE CONTRACT.
- 4. THE CONTRACTOR IS REQUIRED TO PROTECT ANY EXISTING AND NEW UTILITIES WHEN CONSIDERED NECESSARY BY THE COMMISSIONER, USING METHODS APPROVED BY THE COMMISSIONER. THE CONTRACTOR WILL BRACE AND SUPPORT THE UTILITIES PROPERLY TO PREVENT SETTLEMENT, DISPLACEMENT, OR CHANGE TO THE UTILITIES. THE COST OF UTILITY PROTECTION AS SPECIFIED IN HEREIN WILL BE CONSIDERED INCIDENTAL TO THE CONTRACT.
- ANY UTILITY THAT IS DAMAGED DURING CONSTRUCTION WILL BE REPAIRED OR REPLACED BY THE CONTRACTOR AT HIS/HER OWN EXPENSE.
- 6. EXCEPT AS NOTED ON THE PLANS, IN THE GENERAL NOTES, AND IN THE SPECIFICATIONS UTILITY RELOCATION OR ADJUSTMENT WILL BE PERFORMED BY THE RESPECTIVE UTILITY OWNERS AT THEIR OWN EXPENSE AND WILL NOT BE CONSIDERED PART OF THIS CONTRACT, THE CONTRACTOR WILL NOTIFY THE AFFECTED UTILITY OWNERS AND SCHEDULE HIS/HER WORK ACCORDINGLY. THE COST OF THIS COORDINATION WILL BE CONSIDERED INCIDENTAL TO THE CONTRACT.
- 7. ANY PAVEMENT REMOVAL AND REPLACEMENT OPERATION TO BE DIRECTLY ABOVE A COMMONWEALTH EDISON (COMED) COMPANY LINE WILL BE CLOSELY COORDINATED WITH COMED. REPRESENTATIVES FROM THE CITY OF CHICAGO DEPARTMENT OF TRANSPORTATION AND COMED MUST BE PRESENT DURING PERFORMANCE OF THIS WORK. AS ARRANGED BY THE CONTRACTOR.
- PEOPLES GAS FACILITIES ARE PRESENT WITHIN AREA OF CONSTRUCTION, SERVICE IS AFFECTED USE EXTREME CAUTION NEAR ALL GAS FACILITIES DURING CONSTRUCTION AND RELATED EXCAVATION ACTIVITIES. HAND DIGGING OR NON-INVASIVE EXCAVATION IS REQUIRED TO FIELD VERIFY THE HORIZONTAL AND VERTICAL LOCATION OF GAS FACILITIES PRIOR TO CROSSING AND WORKING WITHIN 3' OF ALL GAS FACILITIES. A MINIMUM OF 3' HORIZONTAL EDGE-TO-EDGE CLEARANCE IS REQUIRED FOR GAS FACILITIES WITH DIAMETERS OF 16" OR SMALLER, AND 5' EDGE-TO-EDGE CLEARANCE FOR GAS FACILITIES WITH DIAMETERS 18" AND LARGER. MAINTAIN A MINIMUM OF 18" EDGE TO EDGE VERTICAL CLEARANCE WHEN CROSSING GAS FACILITIES 16" OR LESS IN DIAMETER, AND 24" EDGE-TO-EDGE VERTICAL CLEARANCE WHEN CROSSING 18" AND LARGER DIAMETER GAS FACILITIES. CONTACT 811 CHICAGO/DIGGER 312-744-7000 FOR LOCATES 48 HOURS PRIOR TO START OF CONSTRUCTION.
- THE USE OF CONCRETE, FLOW FILL, OR THE LIKE IS PROHIBITED WITHIN 24 INCHES OF ALL GAS FACILITIES, NOR SHALL IT ENCASE ANY GAS FACILITY. A BUFFER OF 24" SAND IS TO BE USED BETWEEN FLOW FILL AND ALL GAS FACILITIES. A MINIMUM OF 6" FA-02 OR FM-02 SAND SHALL BE USED WHEN BACKFILLING OTHER MATERIALS AROUND ANY EXPOSED GAS FACILITY. CONTRACTOR EXPOSING GAS FACILITY IS RESPONSIBLE FOR PROVIDING THE SAND. ANY DAMAGES TO PEOPLES GAS FACILITIES SHALL BE THE RESPONSIBILITY OF THE INSTALLING UTILITY AND THEIR CONTRACTOR(S). CALL 866-556-6002 IMMEDIATELY FOR ANY DAMAGES TO THE GAS FACILITIES. VERTICAL ADJUSTMENTS REQUIRED FOR VALVE BASIN FRAMES, COVERS, GAS SHUT-OFF VALVES ROADWAY BOXES SHALL BE COMMUNICATED TO JACIE SPUDIC, PLANNING-PERMIT GROUP, JACIE.SPUDIC@PEOPLESGASDELIVERY.COM, 4 WEEKS PRIOR TO THE START OF RESTORATION FOR PLANNING & SCHEDULING. ALL GAS FACILITIES ARE TO BE MAINTAINED.



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OF CHICAGO	USER NAME	= mike.thon	DESIGNED	-	MJJ	REVISED	-		
			DRAWN	-	MGT	REVISED	-		
	PLOT SCALE	= 10.000 ' / in.	CHECKED	-	JAC	REVISED	-		
	PLOT DATE	= 12/13/2024	DATE	-	12/13/2024	ISSUED FOR	BID	-	12/17/2024



SCALE:

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ILLINOIS | FED. AID PROJECT

UTILITY NOTES (CONT.)

- 10. PEOPLES GAS CAST IRON AND DUCTILE IRON GAS MAINS MAY REQUIRE SUPPORT DURING CONSTRUCTION AND RELATED EXCAVATION ACTIVITIES. ANY EXPOSED JOINTS MUST BE SUPPORTED AND CAST IRON JOINTS SEALED BY GAS COMPANY PERSONNEL. CONTACT THE LOCAL PGL SHOP ENGINEERING SUPERVISOR, A MINIMUM OF 5 BUSINESS DAYS PRIOR TO EXCAVATION TO SET UP ON-SITE INSPECTION. INSPECTION BY PEOPLES GAS IS REQUIRED PRIOR TO BACKFILL. INSPECT GAS MAIN AND COATING INTEGRITY PRIOR TO BACKFILL.
- 11. ANY ISSUES OR WORK NEEDED WHEN CROSSING OR ADJACENT TO ANY COMED ASSETS PLEASE CONTACT JENNIFER MABERTO @ 779.231.2246 OR VIA EMAIL @ JENNIFER.MABERTO@COMED.COM AT LEAST SIX WEEKS PRIOR TO CONSTRUCTION START. HAND DIG IS REQUIRED WHEN CROSSING COMED UNDERGROUND CABLE/CONDUITS. MAINTAIN 12 INCHES VERTICAL CLEARANCE (18 INCHES IF POSSIBLE) FROM ANY COMED FACILITIES. WHEN FIELD CONDITIONS REQUIRE COMED ASSISTANCE, PLEASE CONTACT JENNIFER MABERTO @ 779.231.2246 OR VIA EMAIL @ JENNIFER.MABERTO@COMED.COM AT LEAST 6 WEEKS PRIOR TO CONSTRUCTION START.

ADA NOTES

1. FOR THE LATEST CITY OF CHICAGO ADA REQUIREMENTS FOR THE PLANS GO TO WWW.CITYOFCHICAGO.ORG.

LANDSCAPING NOTES

- 1. THE CONTRACTOR IS REQUIRED TO OBTAIN A PERMIT TO REMOVE, PLANT, SPRAY, OR IN ANY WAY AFFECT THE GENERAL HEALTH OR STRUCTURE OF TREES IN THE PUBLIC WAY. THIS PERMIT MAY BE OBTAINED FROM THE DEPUTY COMMISSIONER OF CITY OF CHICAGO BUREAU OF FORESTRY.
- 2. TREES MUST BE TAGGED BY C.D.O.T. CONTACT JEFF BRINK AT (312) 744-7844.

DEPT. OF WATER MANAGEMENT NOTES

- 1. THE CONTRACTOR IS RESPONSIBLE FOR THE ADEQUATE PROTECTION OF THE EXISTING SEWERS, DRAIN CONNECTIONS, SEWER STRUCTURES, AND BENCH MONUMENTS DURING CONSTRUCTION OPERATIONS, AND THE USE OF HEAVY EQUIPMENT WITHIN THE LIMITS OF THE PROJECT.
- 2. IT IS THE RESPONSIBILITY OF THE UTILITY COMPANY/GOVERNMENT AGENCY AND ITS CONSULTANTS/CONTRACTORS TO OBTAIN THE NECESSARY BACKGROUND INFORMATION FROM THE DRAWINGS/CONTRACT PLANS AND FOR EXISTING FACILITIES PROTECTION DURING THE CONSTRUCTION STAGE. RECORDS FROM THE DEPARTMENT OF BUILDINGS, SEWER UNIT INCLUDE: EXISTING SEWERS, DRAIN CONNECTIONS, SEWER STRUCTURES, BENCH MONUMENT LOCATIONS, ORDINANCE GRADES, AGE OF SEWER, AND PIPE MATERIAL. COPIES OF SEWER RECORDS CAN BE OBTAINED ON PAYMENT TO THE DEPARTMENT OF BUILDINGS, SEWER UNIT, LOCATED AT CITY HALL, 121 N. LASALLE ST. ROOM 900, CHICAGO, IL 60602.
- 3. A PERMIT IS REQUIRED FROM THE DEPARTMENT OF BUILDINGS, SEWER UNIT PRIOR TO THE CONSTRUCTION OF, OR REPAIRS TO, UNDERGROUND SEWERS, DRAIN CONNECTIONS, OR SEWER STRUCTURES, INCLUDING THE ADJUSTMENT OF SEWER STRUCTURES AND THE REMOVAL/REPLACEMENT OF FRAMES AND LIDS. THE PERMIT MUST BE OBTAINED BY A DRAINLAYER CURRENTLY LICENSED FROM THE DEPARTMENT OF BUILDINGS, SEWER UNIT.
- 4. IN ORDER TO PROTECT THE CITY'S BENCH MONUMENTS, ALL BENCH MONUMENT LOCATIONS WITHIN THE LIMITS OF THE PROJECT SHOULD BE LISTED ON THE PLAN SHEETS. IF ANY BENCH MONUMENTS ARE NOT LOCATED OR IF DAMAGE TO ANY BENCH MONUMENTS IS ENCOUNTERED, PLEASE CONTACT THE DEPARTMENT OF WATER MANAGEMENT IMMEDIATELY AT (312) 747-7892 OR (312) 747-7893. THE CONTRACTOR IS RESPONSIBLE FOR THE COST OF REPLACEMENT OF ANY BENCH MONUMENT DAMAGED OR DESTROYED DURING CONSTRUCTION.
- 5. IN THE RELOCATION OR CONSTRUCTION OF PRIVATE OR PUBLIC UTILITIES, INCLUDING PIPE UNDERDRAINS AND/OR SUBDRAINS, THE UTILITY SHOULD BE LOCATED AS FAR AWAY AS POSSIBLE FROM THE DEPARTMENT OF WATER MANAGEMENT FACILITY. A MINIMUM DISTANCE OF THE OUTSIDE DIAMETER OF THE SEWER (O.D.) PLUS 4 FEET MUST BE MAINTAINED BETWEEN THE SEWER AND THE UTILITY CENTER LINES. IF THE OUTSIDE DIAMETER/WIDTH OF UTILITY CONDUIT IS MORE THAN THE SEWER O.D., A MINIMUM OF 4 FEET HORIZONTAL CLEARANCE MUST BE OBTAINED FROM THE OUTSIDE FACE TO OUTSIDE FACE. FOUR FEET HORIZONTAL CLEARANCE IS ALSO REQUIRED FROM ALL SEWER STRUCTURES. A MINIMUM OF 10 FEET HORIZONTAL CLEARANCE AND 18 INCHES VERTICAL CLEARANCE IS DESIRABLE BETWEEN THE SEWER AND A WATER MAIN.
- MANHOLES, CATCH BASINS, AND INLETS MUST BE PROTECTED FROM THE ENTRY OF ASPHALT/DEBRIS INTO THE SEWER SYSTEM DURING CONSTRUCTION. THE CONTRACTOR WILL MARK LOCATIONS OF ALL SEWER STRUCTURES ON THE SIDEWALK BEFORE STARTING PAVEMENT REMOVAL/REPLACEMENT. ADJUSTMENT OF FRAMES AND LIDS OF SEWER STRUCTURES MUST BE COMPLETED PRIOR TO STREET RESURFACING.
- 7. THE UTILITY COMPANY/GOVERNMENT AGENCY OR ITS REPRESENTING CONTRACTOR MUST MAINTAIN ACCESS TO THE EXISTING SEWER FACILITIES, INCLUDING SEWER STRUCTURES, AT ALL TIMES AND COORDINATE THE PROPOSED IMPROVEMENTS WITH THE DEPARTMENT OF WATER MANAGEMENT ENGINEER/INSPECTOR TO AVOID ANY INTERRUPTION OF THE SEWER FACILITIES' MAINTENANCE OR SERVICES. THE SEWER FLOW MUST BE MAINTAINED AT ALL TIMES.
- 8. THE CONTRACTOR MUST LOCATE AND PROMPTLY AND PROPERLY CONNECT TO THE NEW SEWERS ALL LIVE HOUSE DRAINS, CATCH BASIN DRAINS, AND OTHER EXISTING LATERALS, DRAINS, AND SEWERS OF WHATEVER NATURE WHICH ARE CONNECTED TO THE EXISTING SEWERS BEING REPAIRED OR REPLACED.

- EXISTING CATCH BASIN LATERALS TO BE REUSED MUST BE RODDED AND FLUSHED IN THE PRESENCE OF THE DEPARTMENT OF WATER MANAGEMENT INSPECTOR. A NEW CONNECTION TO THE MAIN SEWER IS REQUIRED IF THE EXISTING CATCH BASIN LATERAL IS NOT APPROVED BY THE SEWER INSPECTOR.
- 10. WHEN A SEWER STRUCTURE IS ABANDONED, ALL PIPE OPENINGS MUST BE PLUGGED, STRUCTURES FILLED WITH TRENCH BACKFILL, LIDS AND FRAMES REMOVED, AND SURFACE RESTORED AS PER THE DEPARTMENT OF WATER MANAGEMENT STANDARDS AND SPECIFICATIONS.
- 11. WHEN DIRECTED BY THE COMMISSIONER, THE CONTRACTOR IS REQUIRED TO REPLACE ANY BROKEN FRAMES AND LIDS OF SEWER STRUCTURES WITH THE DEPARTMENT OF WATER MANAGEMENT STANDARD FRAMES AND LIDS.
- 12. THE FRAMES AND LIDS OF SEWER STRUCTURES TO BE ABANDONED, REMOVED, OR FILLED SHOULD BE SALVAGED, AND THE CONTRACTOR MUST NOTIFY THE DEPARTMENT OF WATER MANAGEMENT FOR PICK UP.
- 13. IN ARTERIAL STREETS, PERFORATED LIDS MUST BE PLACED ON ALL SEWER STRUCTURES UNLESS OTHERWISE APPROVED BY THE COMMISSIONER. IN RESIDENTIAL STREETS, MANHOLES MAY REQUIRE CLOSED LIDS. CONTRACTOR TO COORDINATE WITH THE DEPARTMENT OF WATER MANAGEMENT INSPECTOR.
- 14. DURING CONSTRUCTION OF THIS PROJECT, THE CONTRACTOR SHALL MAINTAIN THE SURFACE DRAINAGE OF THE ROAD AT ALL TIMES.
- 15. IF THE CONDITION OF EXISTING CATCH BASINS OR INLETS IS SUCH THAT THEIR ADJUSTMENT IS NOT FEASIBLE AT THE TIME OF CONSTRUCTION, THE CONTRACTOR MUST FURNISH AND INSTALL NEW CATCH BASINS OR INLETS AND THEIR APPURTENANCES AS DIRECTED BY THE COMMISSIONER AND WITH THE CONCURRENCE OF THE DEPARTMENT OF WATER MANAGEMENT. THIS WORK WILL BE PAID FOR AT THE CONTRACT UNIT PRICE EACH FOR 'CATCH BASINS, TYPE A, 4 FT DIAMETER, TYPE 1 FRAME, OPEN LID (CITY OF CHICAGO)' OR FOR 'INLETS, TYPE A, TYPE 1 FRAME, OPEN LID (CITY OF CHICAGO)'.
- 16. THE LOCATION OF PROPOSED WATER LINES, METER VAULTS, VALVES AND RPZ'S SHOWN ON THE PLANS ARE APPROXIMATE. THE CONTRACTOR SHALL MARK THE LAYOUT AND LOCATION OF THE WATER LINES, METER VAULTS, VALVES, AND RPZ'S FOR REVIEW BY COMMISSIONER PRIOR TO ANY EXCAVATION.
- 17. THE CONTRACTOR SHALL VERIFY THE LOCATION OF ALL PROPOSED WATER SERVICE CONNECTIONS PRIOR THE INSTALLATION OF THE IRRIGATION SYSTEM. THE CITY OF CHICAGO, DEPARTMENT OF WATER MANAGEMENT WILL PERFORM THE WATER SERVICE CONNECTION TO THE EXISTING WATER MAIN. IT SHALL BE THE CONTRACTOR'S RESPONSIBILITY TO OBTAIN ALL NECESSARY PERMITS AND PAY THE ASSOCIATED FEES. ALL PERMIT FEES WILL BE CONSIDERED INCIDENTAL TO THE CONTRACT.
- 18. IN CASE OF DAMAGE TO THE CITY'S SEWER SYSTEM, PRIVATE AND PUBLIC DRAIN CONNECTIONS, AND/OR BENCH MONUMENTS, THE CONTRACTOR MUST CONTACT THE DEPARTMENT OF BUILDINGS, SEWER UNIT, IMMEDIATELY AT PHONE NUMBER (312) 744-3351. THE CONTRACTOR MUST, AT HIS/HER OWN COST, REPLACE THE AFFECTED SEWERS, DRAIN CONNECTIONS, SEWER STRUCTURES AND/OR BENCH MONUMENTS AS NECESSARY. THE SEWER FLOWS MUST BE MAINTAINED AT ALL TIMES.
- 19. FLOW RESTRICTORS MUST BE INSTALLED IN ALL CATCH BASINS, OUTSIDE OF THE CENTRAL BUSINESS DISTRICT. FLOW RESTRICTORS MUST NOT BE INSTALLED IN CLOSE PROXIMITY TO VIADUCT AREAS, BUS STOPS, OR EMERGENCY ENTRANCES. FLOW RESTRICTORS ARE AVAILABLE FOR PICK-UP AT THE DWM'S CENTRAL DISTRICT, LOCATED AT 3901 S. ASHLAND AVENUE, BY CALLING (312) 747-1777, BETWEEN 7:00 AM 3:00 PM, 48 HOURS IN ADVANCE.
- 20. AS-BUILT PLANS MUST BE SUBMITTED SOON AFTER WORK COMPLETION. FINAL PAYMENT WILL NOT BE MADE TO THE CONTRACTOR UNTIL THE SEWER UNIT OF THE DWM ACKNOWLEDGES RECEIPT OF "AS-BUILT PLANS".
- 21. IN CASE OF DAMAGE TO THE CITY OF CHICAGO SEWERS, PRIVATE AND PUBLIC DRAINS, SEWER STRUCTURES AND/OR BENCH MONUMENTS, THE CONTRACTOR SHALL IMMEDIATELY CONTACT THE DEPARTMENT OF WATER MANAGEMENT AT (312) 747-7892 OR (312) 747-7893.
- 22. PERFORATED LIDS SHALL BE PLACED ON ALL MANHOLES AND CATCH BASINS.
- 23. CITY OF CHICAGO WATER VALVE VAULTS AND SEWER STRUCTURES SHALL NOT BE CLOSED, COVERED OR OTHERWISE OBSTRUCTED DURING CONSTRUCTION WITHOUT WRITTEN PERMISSION FROM THE CITY OF CHICAGO DEPARTMENT OF WATER MANAGEMENT.
- 24. WHENEVER, DURING CONSTRUCTION OPERATIONS, ANY LOOSE MATERIAL IS DEPOSITED IN THE FLOW LINE OF DRAINAGE STRUCTURES SUCH THAT THE NATURAL FLOW OF WATER IS OBSTRUCTED, IT SHALL BE REMOVED AT THE CLOSE OF EACH WORKING DAY. AT THE CONCLUSION OF CONSTRUCTION OPERATIONS, ALL UTILITY STRUCTURES SHALL BE FREE FROM DIRT AND DEBRIS. THE WORK SPECIFIED ABOVE WILL NOT BE PAID FOR SEPARATELY BUT SHALL BE INCLUDED IN THE COST FOR DRAINAGE AND UTILITY STRUCTURES TO BE ADJUSTED IN THIS CONTRACT.
- 25. ANY EXISTING STORM SEWER DAMAGED BY THE CONTRACTOR DURING CONSTRUCTION SHALL BE REPLACED BY THE CONTRACTOR AT NO COST TO THE CITY.
- 26. THE CONTRACTOR SHALL MAINTAIN THE SURFACE DRAINAGE OF THE ROAD DURING CONSTRUCTION UNTIL THE CITY ACCEPTS MAINTENANCE OF THE IMPROVED STREET.
- 27. FOR FULL DEPTH CONSTRUCTION OF THE STREET, ALL SEWER(S) IN THE PROJECT AREA WILL BE TELEVISED BEFORE AND AFTER CONSTRUCTION. CONTACT DEPARTMENT OF WATER MANAGEMENT AT (312) 747-4680.
- 28. THE CONTRACTOR IS REQUIRED TO CONDUCT A PRE-CONSTRUCTION VIDEOTAPED INSPECTION PRIOR TO THE ISSUANCE OF A SEWER PERMIT AND A POST-CONSTRUCTION VIDEOTAPED INSPECTION PRIOR TO ACCEPTANCE OF THE SEWER. THE VIDEOTAPE MUST BE SUBMITTED TO THE SEWER UNIT OF THE DWM FOR REVIEW AND APPROVAL. SHOULD PRE-CONSTRUCTION TELEVISING INDICATE CONDITIONAL ISSUES WITH THE SEWER, IT SHALL BE REPLACED OR REHABILITATED PRIOR TO CONSTRUCTION AS PART OF THE PROJECT IMPROVEMENT.
- 29. PLEASE SEE CDWM-SEWER SECTION'S REQUIREMENTS FOR EXISTING FACILITY CONSTRUCTION.

- 30. CONTACT THE FORCE ACCOUNT CONSTRUCTION MANAGER AT FACM@CTRWATER.COM TWO (2) WEEKS PRIOR TO THE ANTICIPATED START OF CONSTRUCTION DATE SUCH THAT A RESIDENT ENGINEER CAN BE ASSIGNED TO THIS PROJECT. FAILURE TO COMPLY WITH THIS REQUIREMENTS MAY RESULT IN ADDITIONAL EXPENSES TO THE PROPOSED PROJECT TO VERIFY THAT ALL WORK CONFORMS TO DWM'S STANDARDS.
- 31. THE CONTRACTOR MUST SUBMIT TO THE DWM COPIES OF THE SHOP DRAWINGS FOR ALL MATERIALS TO BE USED. ALL MATERIALS MUST BE APPROVED BY THE DWM PRIOR TO STARTING CONSTRUCTION.
- 32. THE CONTRACTOR MUST OBTAIN A "B-PERMIT" PRIOR TO CONSTRUCTION FROM THE CITY OF CHICAGO, DEPARTMENT OF BUILDINGS, PLUMBING PERMIT & PLAN SECTION, CITY HALL, 121 N LA SALLE STREET, ROOM 906.
- 33. ALL VALVE OPERATIONS ARE TO BE COMPLETED BY THE DWM.
- 34. IF CONSTRUCTION REQUIRES THE USE OF WATER FROM A CITY FIRE HYDRANT, PERMITS MUST BE OBTAINED FROM THE CITY OF CHICAGO, DEPARTMENT OF BUILDINGS, PLUMBING PERMIT & PLAN SECTION, CITY HALL, 121 N LA SALLE STREET, ROOM 906.
- 35. THE CONTRACTOR SHALL BE RESPONSIBLE FOR STAKING-OUT ALL PROPOSED HORIZONTAL AND VERTICAL FACILITIES FOR THE DWM AS REQUIRED FOR CONSTRUCTION.
- 36. THE CONTRACTOR SHALL BE RESPONSIBLE FOR OBTAINING ALL APPLICABLE PERMITS (INCLUDING A SEWER PERMIT FROM THE DEPARTMENT OF BUILDINGS SEWER SECTION), EXCAVATION/OSHA SHORING, BACKFILLING/COMPACTION, AND ALL RESTORATION TO CDOT STANDARDS AS REQUIRED FOR CONSTRUCTION PER THE DWM INVOLVEMENT LETTER FOR THIS PROJECT.
- 37. THE CONTRACTOR SHALL BE RESPONSIBLE FOR MAINTAINING WATER SERVICES AND FIRE PROTECTION DURING CONSTRUCTION.
- 38. THE CONTRACTOR SHALL MAINTAIN DRAINAGE AT ALL TIMES.
- 39. THE CONTRACTOR SHALL BE RESPONSIBLE FOR OBTAINING EXACT LOCATIONS AND ELEVATIONS OF ALL THE UTILITIES FROM THE OWNERS OF THE RESPECTIVE UTILITIES.
- 40. THE CONTRACTOR IS RESPONSIBLE FOR RESOLVING ANY UTILITY CONFLICTS, AND/OR VERIFYING THAT ANY UTILITY IN CONFLICT WITH THE PROPOSED WATER MAIN HAS BEEN RELOCATED.
- 41. THE CONTRACTOR SHALL PROVIDE THE DWM WITH TWO COPIES OF A REDLINE MARKED-UP AS-BUILT DRAWING OF THE WATER MAIN INSTALLATION WITH ANY DESIGN CHANGES THAT HAVE BEEN MADE. THIS DRAWING SHALL NOTE EXACT LOCATIONS OF THE WATER MAINS, VALVES, FITTINGS, CONNECTIONS TO EXISTING WATER MAINS, SERVICES, AND ANY SPECIAL INSTALLATIONS. LOCATIONS SHALL BE REFERENCED TO STREET RIGHT-OF-WAYS, AND THE DEPTH OF COVER SHALL ALSO BE INDICATED. THE AS-BUILT SHALL BE SIGNED AND DATED BY THE CONTRACTOR'S PROJECT COORDINATOR, ALONG WITH THEIR CONTACT INFORMATION.
- 42. NO WATER SERVICE CONNECTION OR TAPS CAN BE MADE UNTIL THE WATER MAIN HAS BEEN APPROVED BY THE DWM AND IS IN SERVICE. INDIVIDUAL WATER SERVICE TAP PERMITS MUST BE ISSUED BY THE DEPARTMENT OF BUILDINGS PLUMBING PERMIT AND PLAN DESK, AND METERS MUST BE INSTALLED PRIOR TO THE SERVICE CONNECTION BEING MADE BY THE DWM.
- 43. LOCATION OF UTILITIES AND PROPERTY LINES ARE FROM THE BEST INFORMATION AVAILABLE. EXACT LOCATION AND COMPLETENESS ARE NOT GUARANTEED.
- 44. THE CONTRACTOR MUST VERIFY THE LOCATION OF UNDERGROUND UTILITIES WITH THE UTILITY OWNERS PRIOR TO DOING ANY WORK IN THE VICINITY. THE CONTRACTOR MUST COMPLY WITH REQUIREMENTS OF UTILITY OWNERS REGARDING NOTICE OF WORK AND PROTECTION OF UTILITIES. THE CONTRACTOR MUST COMPLY WITH THE CITY OF CHICAGO, DEPARTMENT OF TRANSPORTATION DAMAGE PREVENETION PROTOCOL CITY INFRASTRUCTURE DEPARTMENTS. ALL UTILITIES MUST BE NOTIFIED AT LEAST 48 HOURS BEFORE CONSTRUCTION. (CALL DIGGER 312-744-7000).
- 45. TEST PITS MUST BE EXCAVATED IN ADVANCE OF PIPELINE CONSTRUCTION IN ORDER TO CONFIRM DEPTH AND LOCATION OF EXISTING UTILITIES AND WHEN DIRECTED BY THE DEPARTMENT MANAGER. NO ADDITIONAL PAYMENT WILL BE MADE FOR TEST PIT EXCAVATION.
- 46. IF ANY PUBLIC OR PRIVATE UTILITIES CROSS THE WATER MAIN TRENCH AND MUST REMAIN IN PLACE, THE CONTRACTOR MUST PROTECT SAID UTILITY IN CONFORMANCE WITH THE SPECIFICATIONS OR AS DIRECTED BY THE COMMISSIONER.
- 47. PROVIDE EROSION CONTROL IN ACCORDANCE WITH THE SPECIFICATIONS.
- 48. FITTINGS AND THEIR LOCATIONS INDICATED ON THE DRAWINGS ARE TENTATIVE. THE CONTRACTOR MUST COMPLETE THE INSTALLATION WITH THE NECESSARY FITTINGS DICTATED BY FIELD CONDITIONS. NO ADDITIONAL PAYMENT WILL BE MADE FOR DEVIATIONS FROM THE INDICATED FITTINGS.
- 49. WORK INDICATED ON THE PLANS AND NOT REFERENCED TO A BID ITEM IS CONSIDERED INCIDENTAL TO THE WORK TO WHICH IT APPLIES AND NO ADDITIONAL COMPENSATION WILL BE ALLOWED.
- 50. WATER MAIN AND FITTINGS LOCATIONS SHOWN ON THE DRAWINGS FOR THE NEW WATER MAINS AND APPURTENANCES MAY BE CHANGED BY THE COMMISSIONER DUE TO FIELD CONDITIONS. NO ADDITIONAL COMPENSATION WILL BE ALLOWED FOR SUCH CHANGES, UNLESS PREVIOUSLY APPROVED BY THE COMMISSIONER.
- 51. THE CONTRACTOR MUST PROVIDE THRUST RESTRAINTS IN ACCORDANCE WITH THE SPECIFICATIONS. THE CONTRACTOR MUST FURNISH AND INSTALL MECHANICAL JOINT THRUST RESTRAINT GLANDS AT ALL FITTINGS AND MECHANICAL JOINTS.
- 52. ALL OPENINGS IN EXISTING WATER MAINS MUST BE PLUGGED OR CAPPED WITH DUCTILE IRON FITTINGS UNTIL THE MAIN IS ABANDONED.
- 53. ALL VALVE BASINS MUST BE CONSTRUCTED OF PRE-CAST REINFORCED CONCRETE UNLESS DIRECTED OTHERWISE BY THE COMMISSIONER.
- 54. NOTES INDICATING S.N.L., E.W.L., ETC., MEAN SOUTH OF THE NORTH PROPERTY LINE, EAST OF THE WEST PROPERTY LINE, ETC., AND ARE MEASURED FROM THE NEAREST STREET.
- 55. HOUSE DRAINS ARE NOT SHOWN ON THE DRAWINGS. THE CONTRACTOR MUST LOCATE ALL HOUSE DRAINS WITHIN THE AREA OF EXCAVATION AND MAKE ADJUSTMENTS AND/OR REPAIRS.
- 56. ABANDON EXISTING WATER MAINS IN ACCORDANCE WITH THE SPECIFICATONS.



FCHICAGO	USER NAME = mike.thon	DESIGNED	_	MJJ	REVISED -	
		DRAWN	-	MGT	REVISED -	
	PLOT SCALE = 10.000 ' / in.	CHECKED	-	JAC	REVISED -	
	PLOT DATE = 12/13/2024	DATE	-	12/13/2024	ISSUED FOR BID -	12/17/2024

CITY OF CHICAGO
DEPARTMENT OF TRANSPORTATION

	GENERAL NOTES			F.A. RTE.	SECTION	COUNTY	TOTAL SHEETS			
						соок	49	3		
								CONTRACT	NO. C1	617
SCALE:	SHEET 2	OF 2	SHEETS	STA.	TO STA.		ILLINOIS FED. AI	D PROJECT		

SUMMARY OF QUANTITIES

ITEM NO.	ITEM DESCRIPTION	UNIT	TOTAL QUANTITY
1	TREE REMOVAL (6 TO 15 UNITS DIAMETER)	UNIT	80
2	TREE REMOVAL (OVER 15 UNITS DIAMETER)	UNIT	84
3	TREE PROTECTION	EACH	3
4	ROOT PRUNING	FOOT	0
5	EARTH EXCAVATION	CU YD	1678
6	POROUS GRANULAR EMBANKMENT, SUBGRADE	CU YD	148
7	TRENCH BACKFILL	CU YD	60
8	TRENCH BACKFILL, WATERMAIN	CU YD	350
9	TOPSOIL FURNISH AND PLACE, 4-INCH	SQ YD	514
10	SHREDDED HARDWOOD BARK MULCH	SQ YD	0
11	SODDING, SALT TOLERANT	SQ YD	514
12	TREE PLANTING 2-1/2 INCH TO 3-INCH B&B	EACH	14
13	INLET FILTERS	EACH	2
14	SAND CUSHION, VARIABLE DEPTH	CU YD	38
15	SUBBASE GRANULAR MATERIAL, TYPE B, 6-INCH	CU YD	309
16	PORTLAND CEMENT CONCRETE BASE COURSE, 7-INCH	SQ YD	1409
17	BITUMINOUS MATERIALS (TACK COAT)	POUND	951
18	LEVELING BINDER (HAND METHOD), N50	TON	2
19	LEVELING BINDER (MACHINE METHOD), N50 1-1/2 INCH	TON	118
20	HOT-MIX ASPHALT SURFACE COURSE, IL-19, MIX "D", N50, 2 INCH	TON	158
21	BITUMINOUS COST ADJUSTMENT	CAL MONTH	3
22	PROTECTIVE COAT	SQ YD	825
23	PORTLAND CEMENT CONCRETE DRIVEWAY AND ALLEY PAVEMENTS, & INCH	- SQ YD	95
24	PORTLAND CEMENT CONCRETE SIDEWALK 5 INCH	SQ FT	2723
25	PORTLAND CEMENT CONCRETE ADA RAMP 5 INCH	SQ FT	265
26	PORTLAND CEMENT CONCRETE SIDEWALK 8 INCH	SQ FT	435
27	PORTLAND CEMENT CONCRETE ADA RAMP 8 INCH	SQ FT	50
28	LINEAR DETECTABLE WARNING TILES (CAST IRON)	SQ FT	36
29	HOT-MIX ASPHALT SURFACE REMOVAL, VARIABLE DEPTH	SQ YD	0
30	PAVEMENT REMOVAL	SQ YD	1771
31	CURB REMOVAL	FOOT	36
32	COMBINATION CURB AND GUTTER REMOVAL	FOOT	93
33	SIDEWALK REMOVAL	SQ FT	3038
34	SAW CUTTING PAVEMENT	FOOT	108
35	DRIVEWAY AND ALLEY RETURN PAVEMENT REMOVAL (SPECIAL)	SQYD	175
36	STORM SEWER, EXTRA STRENGTH VITRIFIED CLAY PIPE, TYPE 2, 8 INCI		6
37	STORM SEWER, DUCTILE IRON PIPE, TYPE 2, 8 INCH	FOOT	0
38	STORM SEWER, DUCTILE IRON PIPE, TYPE 2, 18 INCH	FOOT	36
39	STORM SEWER, DUCTILE IRON PIPE, TYPE 2, 24 INCH	FOOT	19
40	SEWER CLEANING AND TELEVISING	FOOT	2076
41	DUCTILE IRON WATER MAIN TEE, 8"X8"	EACH	2
42	WATER MAIN INSTALLED IN OPEN CUT, 8 INCH	FOOT	691
43	DUCTILE IRON WATER MAIN REDUCER, 8"X6"	EACH	0
44	WATER VALVE, 8 INCH	EACH	2
45	DUCTILE IRON WATER MAIN FITTINGS 8" 11.25 DEGREE BEND	EACH	2
			. /

ITEM NO.	ITEM DESCRIPTION	UNIT	TOTAL QUANTITY
46	DUCTILE IRON WATER MAIN FITTINGS 8" 45 DEGREE BEND	EACH	6
47	WATER SERVICE LINE 3/4"	FOOT	173
48	WATER SERVICE LINE 1"	FOOT	0
49	REMOVE EXISTING FIRE HYDRANT	EACH	2
50	HYDRANT INSTALLATION	EACH	2
51	FIRE HYDRANTS (SPECIAL - FLUSHING HYDRANT)	EACH	0
52	REMOVE EXISTING VALVE AND VAULT	EACH	2
53	SERVICE CONTROL VALVE AND BUFFALO BOX	EACH	5
54	RESILIENT WEDGE VALVE 8"	EACH	0
55	CATCH BASINS, TYPE A, 4'-DIAMETER, TYPE 1 FRAME, OPEN LID (CITY	EACH	2
56	OF CHICAGO) MANHOLES, TYPE B, 3'-DIAMETER, TYPE 1 FRAME, CLOSED LID (CITY OF	EACH	1
57	CHICAGO) ADDITIONAL MASONRY	FOOT	0
58	MANHOLES, TYPE A, 5'-DIAMETER, TYPE 1 FRAME, CLOSED LID (CITY OF	EACH	2
59	CHICAGO) MANHOLES TO BE ADJUSTED	EACH	0
60	VALVE VAULTS TO BE ADJUSTED	EACH	0
61	REMOVING MANHOLES	EACH	1
62	REMOVING CATCH BASINS	EACH	3
63	CONCRETE CURB, TYPE B	FOOT	264
64	COMBINATION CONCRETE CURB AND GUTTER, TYPE B-V12	FOOT	1414
65	CONSTRUCTION SIGN	EACH	2
66	NON-SPECIAL WASTE DISPOSAL	CU YD	1678
67	SOIL DISPOSAL ANALYSIS	EACH	1
68	REGULATED SUBSTANCES PRE-CONSTRUCTION PLAN	L SUM	1
69	REGULATED SUBSTANCES FINAL CONSTRUCTION REPORT	L SUM	1
70	REGULATED SUBSTANCES MONITORING	CAL DAY	20
71	ENGINEER'S FIELD OFFICE	CAL MONTH	3
72	TRAFFIC CONTROL COMPLETE	L SUM	1
73	AGGREGATE FOR TEMPORARY ACCESS	TON	56
74	SIGN PANEL, TYPE 1, RETROREFLECTIVE	SQ FT	28
75	REMOVE AND SALVAGE SIGN PANEL	EACH	5
76	REMOVE AND SALVAGE SIGN PANEL AND POLE ASSEMBLY	EACH	2
77	SIGN SUPPORT POST, DIG METHOD	EACH	3
78	SIGN SUPPORT POST, DRILL METHOD	EACH	0
79	THERMOPLASTIC PAVEMENT MARKING, LINE 6 IN	FOOT	0
80	THERMOPLASTIC PAVEMENT MARKING, LINE 24 IN	FOOT	80
81	DRILL AND GROUT DOWEL AND TIE BARS	EACH	756
82	MAINTENANCE OF STREET LIGHTING SYSTEM	L SUM	1
83	CONDUIT IN TRENCH, GALVANIZED STEEL, 2" DIA.	FOOT	0
84	CONDUIT IN TRENCH, GALVANIZED STEEL, 2 DIA. CONDUIT IN TRENCH, PVC (SCHEDULE 80), 2" DIA.	FOOT	70
84 85	CONDUIT, DIRECTIONAL BORED, COILABLE NONMETALLIC CONDUIT,	FOOT	762
85 86	SCHEDULE 80, 2" DIA.		762
	TRENCH AND BACKFILL WITH SCREENINGS	FOOT	
87	INTERCEPT EXISTING CONDUIT	EACH	0
88	CONDUIT RISER ATTACHED TO POLE, 2"	EACH	0
89	HANDHOLE, ELECTRIC, WITH 24" FRAME AND COVER	EACH	0
90	CLEAN EXISTING CITY MANHOLE OR HANDHOLE	EACH	1

ITEM NO.	ITEM DESCRIPTION	UNIT	TOTAL QUANTITY
91	DRILL EXISTING ELECTRIC HANDHOLE OR MANHOLE	EACH	1
92	ELECTRIC CABLE IN CONDUIT, TRIPLEX, 2-1/C NO. 6, 1-1/C NO. 8 GROUND	FOOT	920
93	RACK, SECONDARY AERIAL 3 WIRE	EACH	3
94	LUMINAIRE, LED, ACORN, ARTERIAL, RESIDENTIAL	EACH	8
95	LUMINAIRE, LED, COBRA HEAD, RESIDENTIAL	EACH	8
96	LUMINAIRE NODE, INTERNAL	EACH	8
97	CONTROLLER, STREET LIGHTING, POLE MOUNTED, CONSTANT POWER, 1-PHASE, 120/240V, 60A	EACH	0
98	LIGHT POLE, ALUMINUM, DAVIT, 18 FT. M.H., 8 FT DAVIT ARM	EACH	8
99	LIGHT POLE FOUNDATION, METAL, 10" BOLT CIRCLE, 8 5/8" X 5'	EACH	9
100	RELOCATE EXISTING LIGHTING UNIT	EACH	1
101	REMOVE EXISTING STREET LIGHTING EQUIPMENT	L SUM	1
102	BREAKDOWN CONCRETE FOUNDATION, LIGHT POLE	EACH	4
103	AERIAL CABLE, 3-1/C NO. 4 WITH MESSENGER WIRE	LN FT	162

TREE PLANTING SCHEDULE

SPRING PLANTING


SYMBOL	NAME	COMMON NAME	QUANTITY
+ AE	ULMUS CARPINIFOLIA MORTON	ACCOLADE ELM	5 EACH
+ RL	TILIA AMERICANA	REDMOND LINDEN	5 EACH
+ MM	ACER FREEMANII	MARMO MAPLE	4 EACH
		TOTALS	14 EACH
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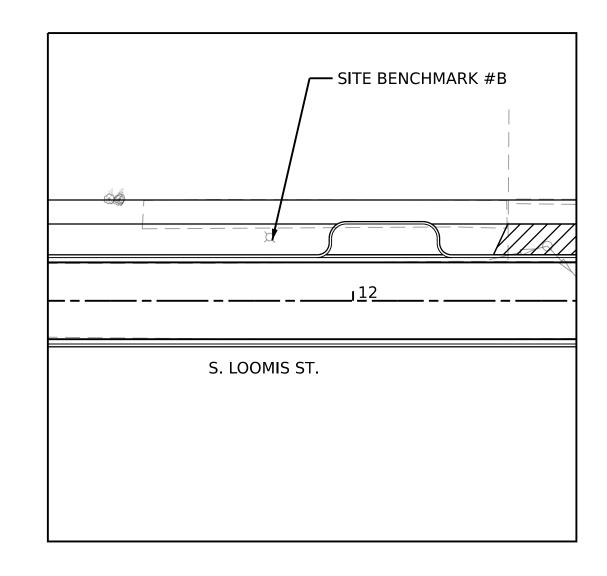
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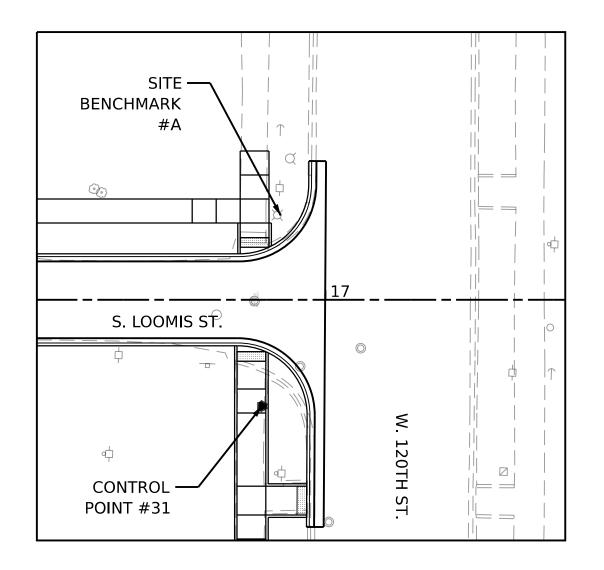
CHICAGO	USER NAME = mike.thon	DESIGNED -	MJJ	REVISED -
		DRAWN -	MGT	REVISED -
	PLOT SCALE = 10.000 ' / in.	CHECKED -	JAC	REVISED -
	PLOT DATE = 12/13/2024	DATE -	12/13/2024	ISSUED FOR BID - 12/17/2024

CITY OF CHICAGO
DEPARTMENT OF TRANSPORTATION

OLIBARA DV. OF OLIARITITIES	F.A. RTE	SECTION	COUNTY	TOTAL SHEETS	SHEET NO.
SUMMARY OF QUANTITIES			соок	49	4
			CONTRACT	NO. C1	617
SHEET 1 OF 1 SHEETS STA. TO STA.		ILLINOIS FI	ED. AID PROJECT		






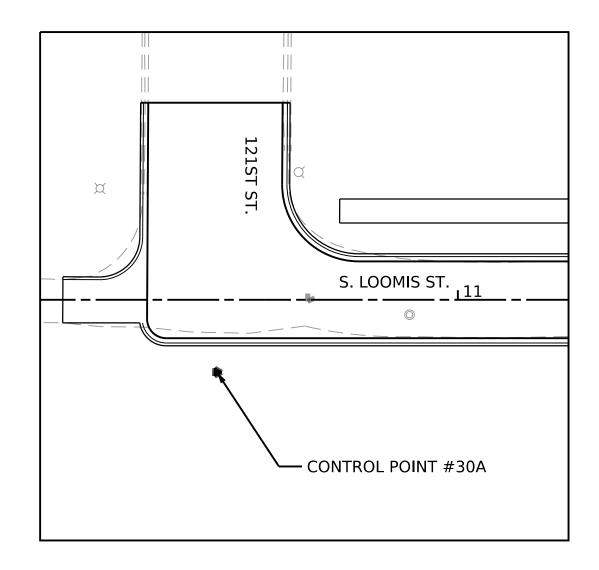

ALIGNMENT, TIES, AND BENCHMARKS S. LOOMIS ST.

CONTROL POINT	DESCRIPTION	NORTHING	EASTING	ELEVATION	STATION	OFFSET
CITY BENCHMARK #591	W. 120TH ST. AND S. JUSTINE ST. ABOUT 25.5 FT SOUTH OF THE SOUTH LINE OF W. 120TH ST. ABOUT 14.5 FT WEST OF THE EAST LINE OF S. JUSTINE ST.	SEE DESCRIPTION	SEE DESCRIPTION	28.989	SEE NOTE	SEE NOTE
BM #A	NE BOLT ON BASE OF STREET LIGHT CHISELED "+" ON TOP OF BOLT	NOT AVAILABLE	NOT AVAILABLE	29.554	16+90.69	17.55' LT
BM #B	NE BOLT ON BASE OF STREET LIGHT 4' W. OF W. EDGE OF PAVEMENT 105' N. OF N. LINE OF W. 121ST ST.	NOT AVAILABLE	NOT AVAILABLE	29.659	11+83.21	12.60' LT
CP #30A	DESCRIPTION UNCERTAIN	NOT AVAILABLE	NOT AVAILABLE	29.864	10+49.80	15.08' RT
CP #31	DESCRIPTION UNCERTAIN	NOT AVAILABLE	NOT AVAILABLE	29.234	16+86.81	22.15' RT

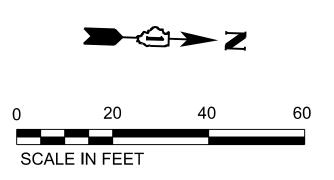

NOTE: BENCHMARK/CONTROL POINTS LOCATED OUTSIDE OF PROJECT BOUNDARIES. NOT SHOWN ON SHEET.


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CHICAGO	USER NAME = mike.thon	DESIGNED -	MJJ	REVISED -	
		DRAWN -	MGT	REVISED -	
	PLOT SCALE = 20.000 ' / in.	CHECKED -	JAC	REVISED -	
X //.	PLOT DATE = 12/13/2024	DATE -	12/13/2024	ISSUED FOR BID - 12/17/2024	

CITY	OF	CHICAGO
DEPARTMENT	OF	TRANSPORTATION

SCALE: 1"=20'


ALLONINAENIT TIEG AND DENIGLINAADVO	F.A. RTE.	SECTION	COUNTY	TOTAL SHEETS	SHEET NO.
ALIGNMENT, TIES, AND BENCHMARKS			COOK	49	5
			CONTRACT	NO. C16	517
SHEET 1 OF 1 SHEETS STA. TO STA.		ILLINOIS FED. AID	D PROIECT		

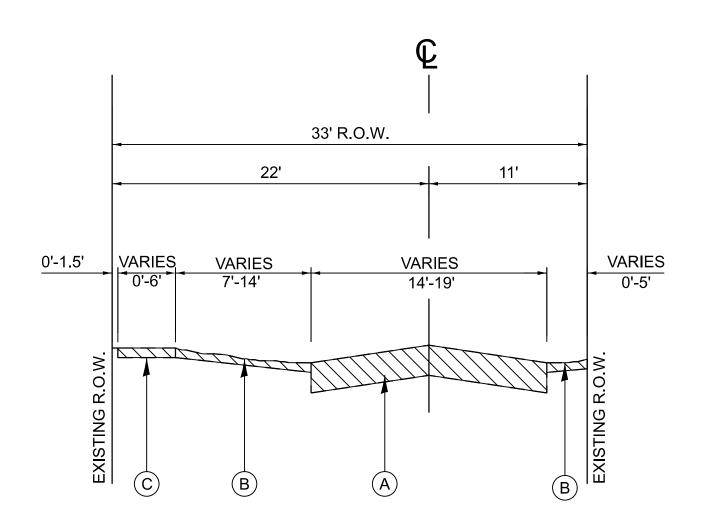

EXISTING TYPICAL SECTION

S LOOMIS ST STA. 10+35.26* TO 16+99.95 (NTS)

*DRIVEWAY IMPROVEMENT FROM STA 10+17.68 TO STA 10+35.26

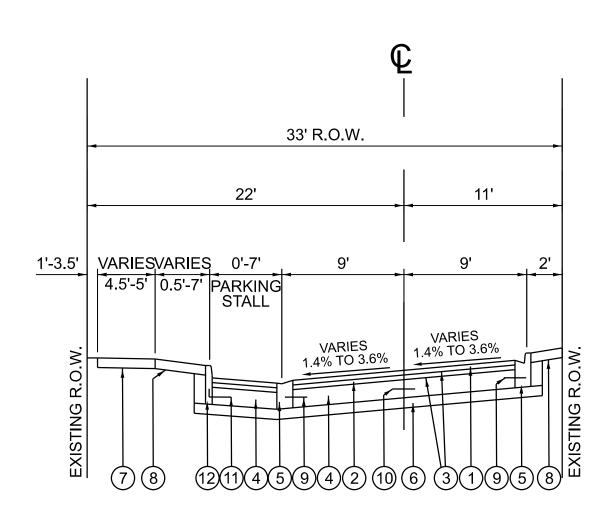


PROPOSED TYPICAL SECTION

S LOOMIS ST STA. 10+35.26* TO 16+99.95 (NTS)

*DRIVEWAY IMPROVEMENT FROM STA 10+17.68 TO STA 10+35.26

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CITY OF CHICAGO DEPARTMENT OF TRANSPORTATION

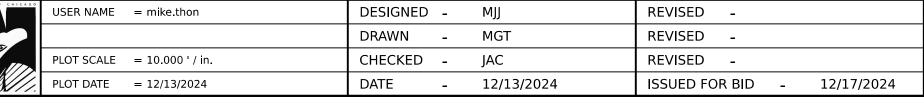SCALE:

	-				F.A. RTE	SECTION
	TYPICA	L SEC	HONS			
EET 1	OF 1	SHEETS	STA.	TO STA.		ILLING

EXISTING LEGEND

- (A) EXISTING PAVEMENT
- (B) GRASS OR GRAVEL PARKWAY
- © EXISTING CONCRETE SIDEWALK

REMOVAL LEGEND



PROPOSED LEGEND

- (1) HOT MIX ASPHALT SURFACE COURSE, MIX D, N50, 2"
- (2) LEVELING BINDER COURSE, (MACHINE METHOD), N50, 1 1/2"
- 3) BITUMINOUS MATERIALS (TACK COAT)
- (4) P.C.C. BASE COURSE, 7"
- (5) COMBINATION CURB AND GUTTER, TYPE B-V.12
- (6) SUB-BASE GRANULAR MATERIAL, TYPE B, 6"
- (7) P.C.C. SIDEWALK, 5" OR 8" (SEE NOTE 1)
- (8) TOPSOIL FURNISH AND PLACE, 4" AND SODDING, SALT TOLERANT
- 9) TIE BAR #5, 30" LONG SPACED @ 30" C-C (EPOXY COATED)
- TIE BAR, DEFORMED 1/2" DIA., SPACED @ 30" C-C (MAX.)
- (11) TIE BARS, ROUNDED 1/2" DIA., 30" LONG, SPACED @ 30" C-C
- (12) CONCRETE CURB, TYPE B

NOTES

- 1. SIDEWALK SHALL BE REPLACED AT LOCATIONS NOTED ON THE PLANS OR AS DIRECTED BY THE PBC PM/CDOT RE.
- 2. BITUMINOUS TACK COAT MUST BE APPLIED AT THE RATE OF 0.05 TO 0.025 POUNDS PER SQUARE FOOT. TACK COAT MUST BE APPLIED WHEN SO DIRECTED BY THE COMMISSIONER.
- 3. THE SUBBASE MATERIAL MUST BE CRUSHED STONE HAVING A CA-6 GRADATION WHICH MUST BE FURNISHED, PLACED TO A 6 INCH DEPTH, AND COMPACTED IN ACCORDANCE WITH THE REQUIREMENTS FOR SUBBASE GRANULAR MATERIAL, TYPE B, AS STATED IN APPLICABLE PORTIONS OF SECTION 311 OF THE STANDARD SPECIFICATIONS FOR ROAD AND BRIDGE CONSTRUCTION.
- 4. PAVEMENT REMOVAL MUST BE PRECEDED BY FULL DEPTH SAW CUTTING TO SEPARATE THE PORTION TO BE REMOVED FROM THE PORTION TO REMAIN. ANY PAVEMENT BEYOND THE LIMITS MARKED FOR REMOVAL THAT IS DAMAGED BY THE CONSTRUCTION MUST BE CUT FULL DEPTH WITH A CONCRETE SAW AND REPLACED AT NO ADDITIONAL COST TO THE CONTRACT.
- 5. FOR PORTLAND CEMENT CONCRETE PAVEMENT JOINTING AND COMBINATION CONCRETE CURB AND GUTTER JOINTING DETAILS, REFER TO THE LATEST DETAIL CONSTRUCTION STANDARDS OF THE DIVISION OF ENGINEERING, CHICAGO DEPARTMENT OF TRANSPORTATION.
- 6. PROPOSED SIDEWALK VARIES IN LOCATIONS, TYPICAL AT INTERSECTIONS, DRIVEWAYS AND ALLEYS. SEE PLANS FOR LOCATIONS.
- 7. ALL HMA MILLING SHALL BE PAID FOR AS HOT-MIX ASPHALT SURFACE REMOVAL, VARIABLE DEPTH.
- 8. ALL SOIL AND OTHER MATERIAL EXCAVATION SHALL BE PAID FOR AS EARTH EXCAVATION. THE TRANSPORTATION AND DISPOSAL OF SOIL AND OTHER MATERIALS FROM AN EXCAVATION DETERMINED TO BE CONTAMINATED SHALL BE PAID FOR AS NON-SPECIAL WASTE DISPOSAL.

TOTAL SHEET NO.

49

CONTRACT NO. C1617

COUNTY

COOK

ILLINOIS FED. AID PROJECT





LEGEND

CONSTRUCTION WORK ZONE

 \Longrightarrow

DIRECTION OF TRAVEL

PLASTIC DRUMS (20' MAX SPACING)

 \mathbb{X}


PORTABLE MESSAGE BOARD

TYPE 3 BARRICADE WITH

FLASHING BEACON AND
"ROAD CLOSED" SIGN


CDOT TO POST 24/7 NO PARKING SIGNS ON S LOOMIS ST, W 120TH ST, AND W 121ST ST IN THE VICINITY OF THE WORK ZONE AND TAPERS FOR THE DURATION OF THE CONSTRUCTION STAGE.


CONTRACTOR MUST MAINTAIN ALL CROSSWALKS AND ADA ACCESS AT ALL TIMES.

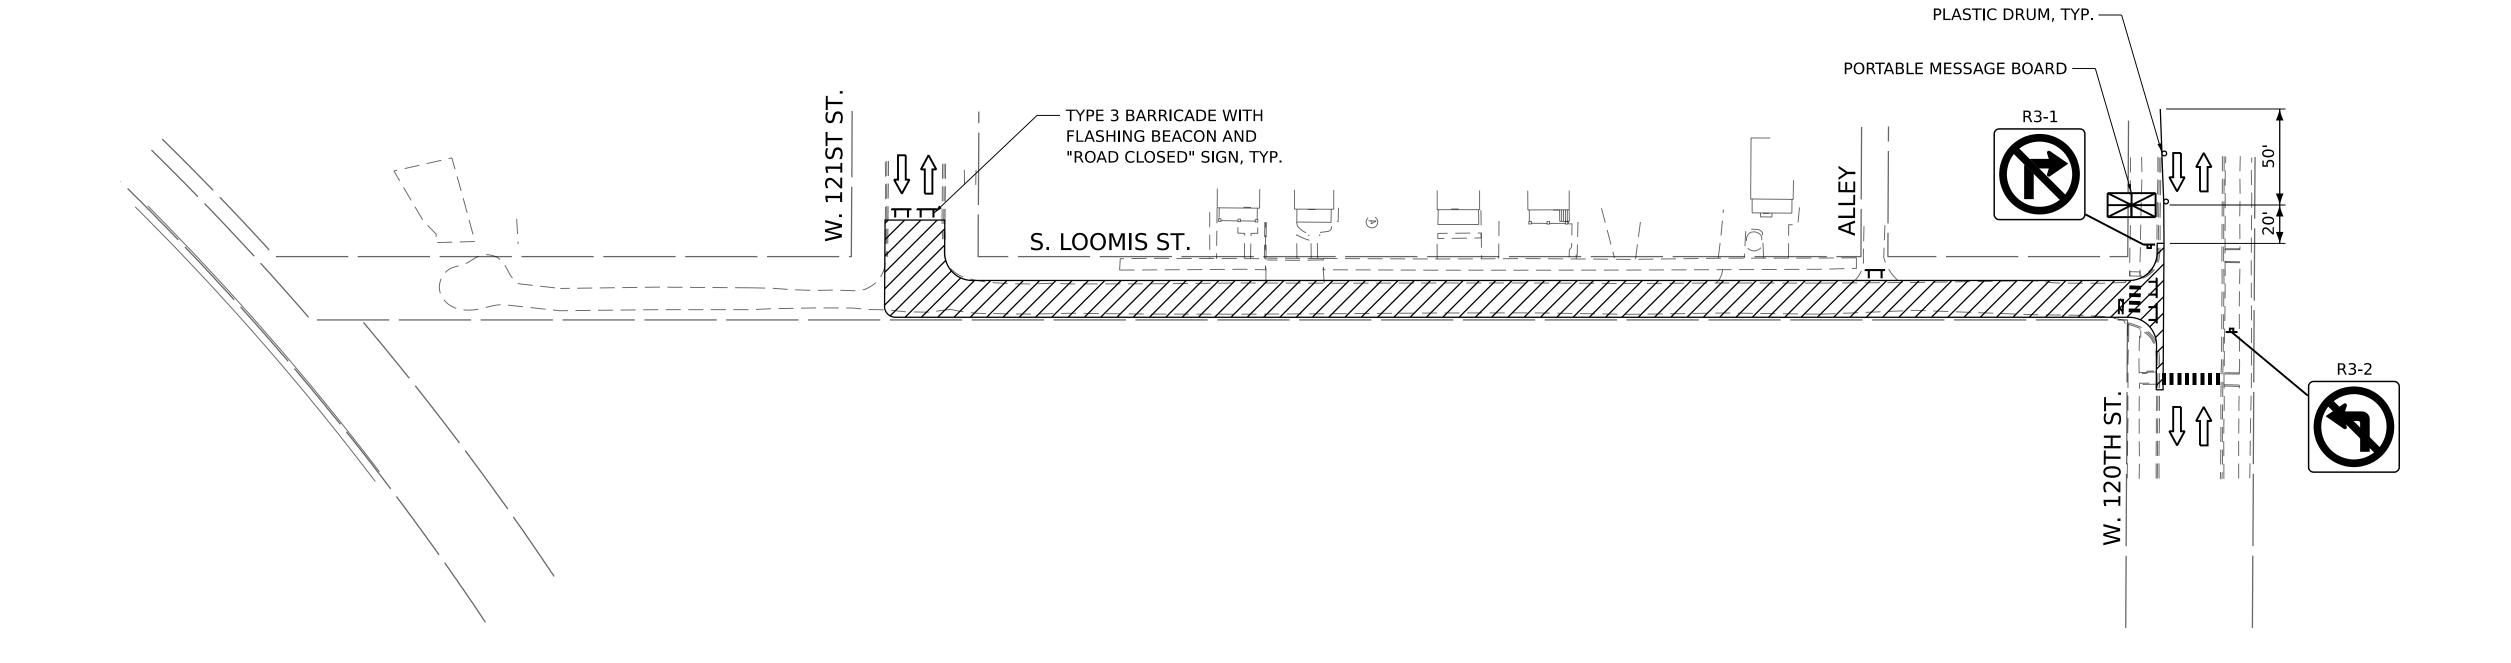


CAGO	USER NAME = mike.thon	DESIGNED -	МЈЈ	REVISED -
		DRAWN -	MGT	REVISED -
	PLOT SCALE = 49.998 ' / in.	CHECKED -	JAC	REVISED -
//.	PLOT DATE = 12/13/2024	DATE -	12/13/2024	ISSUED FOR BID - 12/17/2024

SCALE: 1"=50'

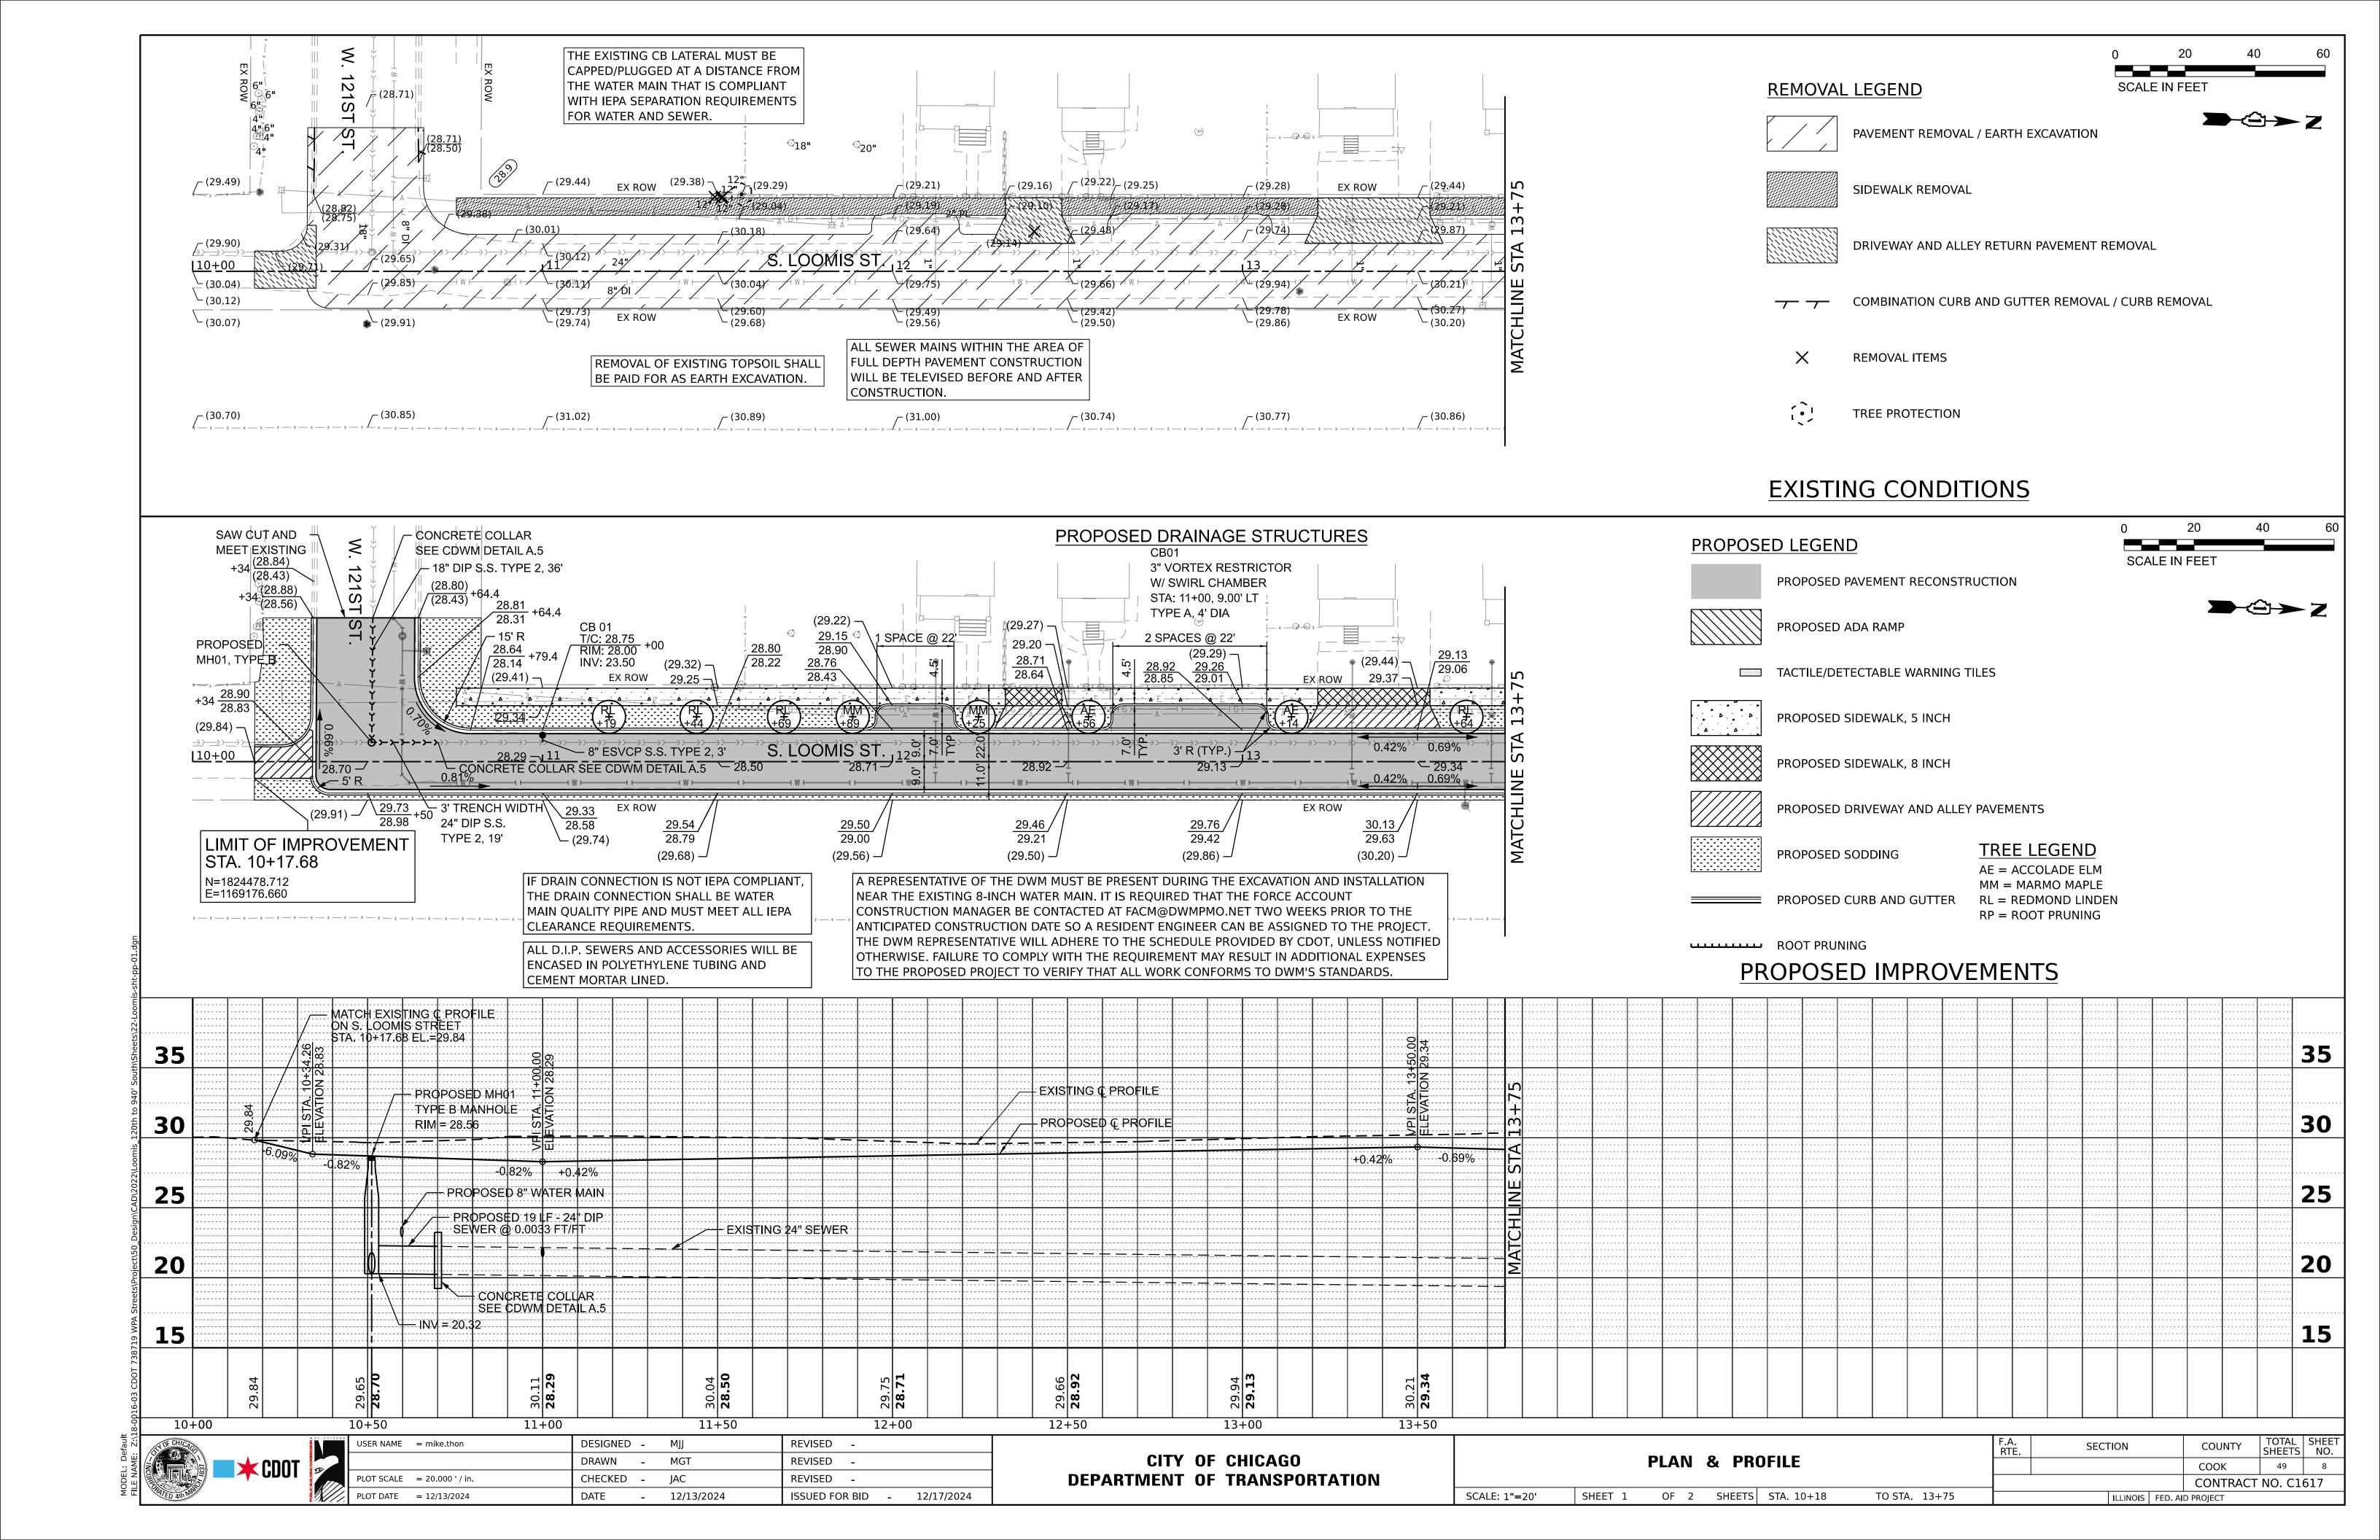


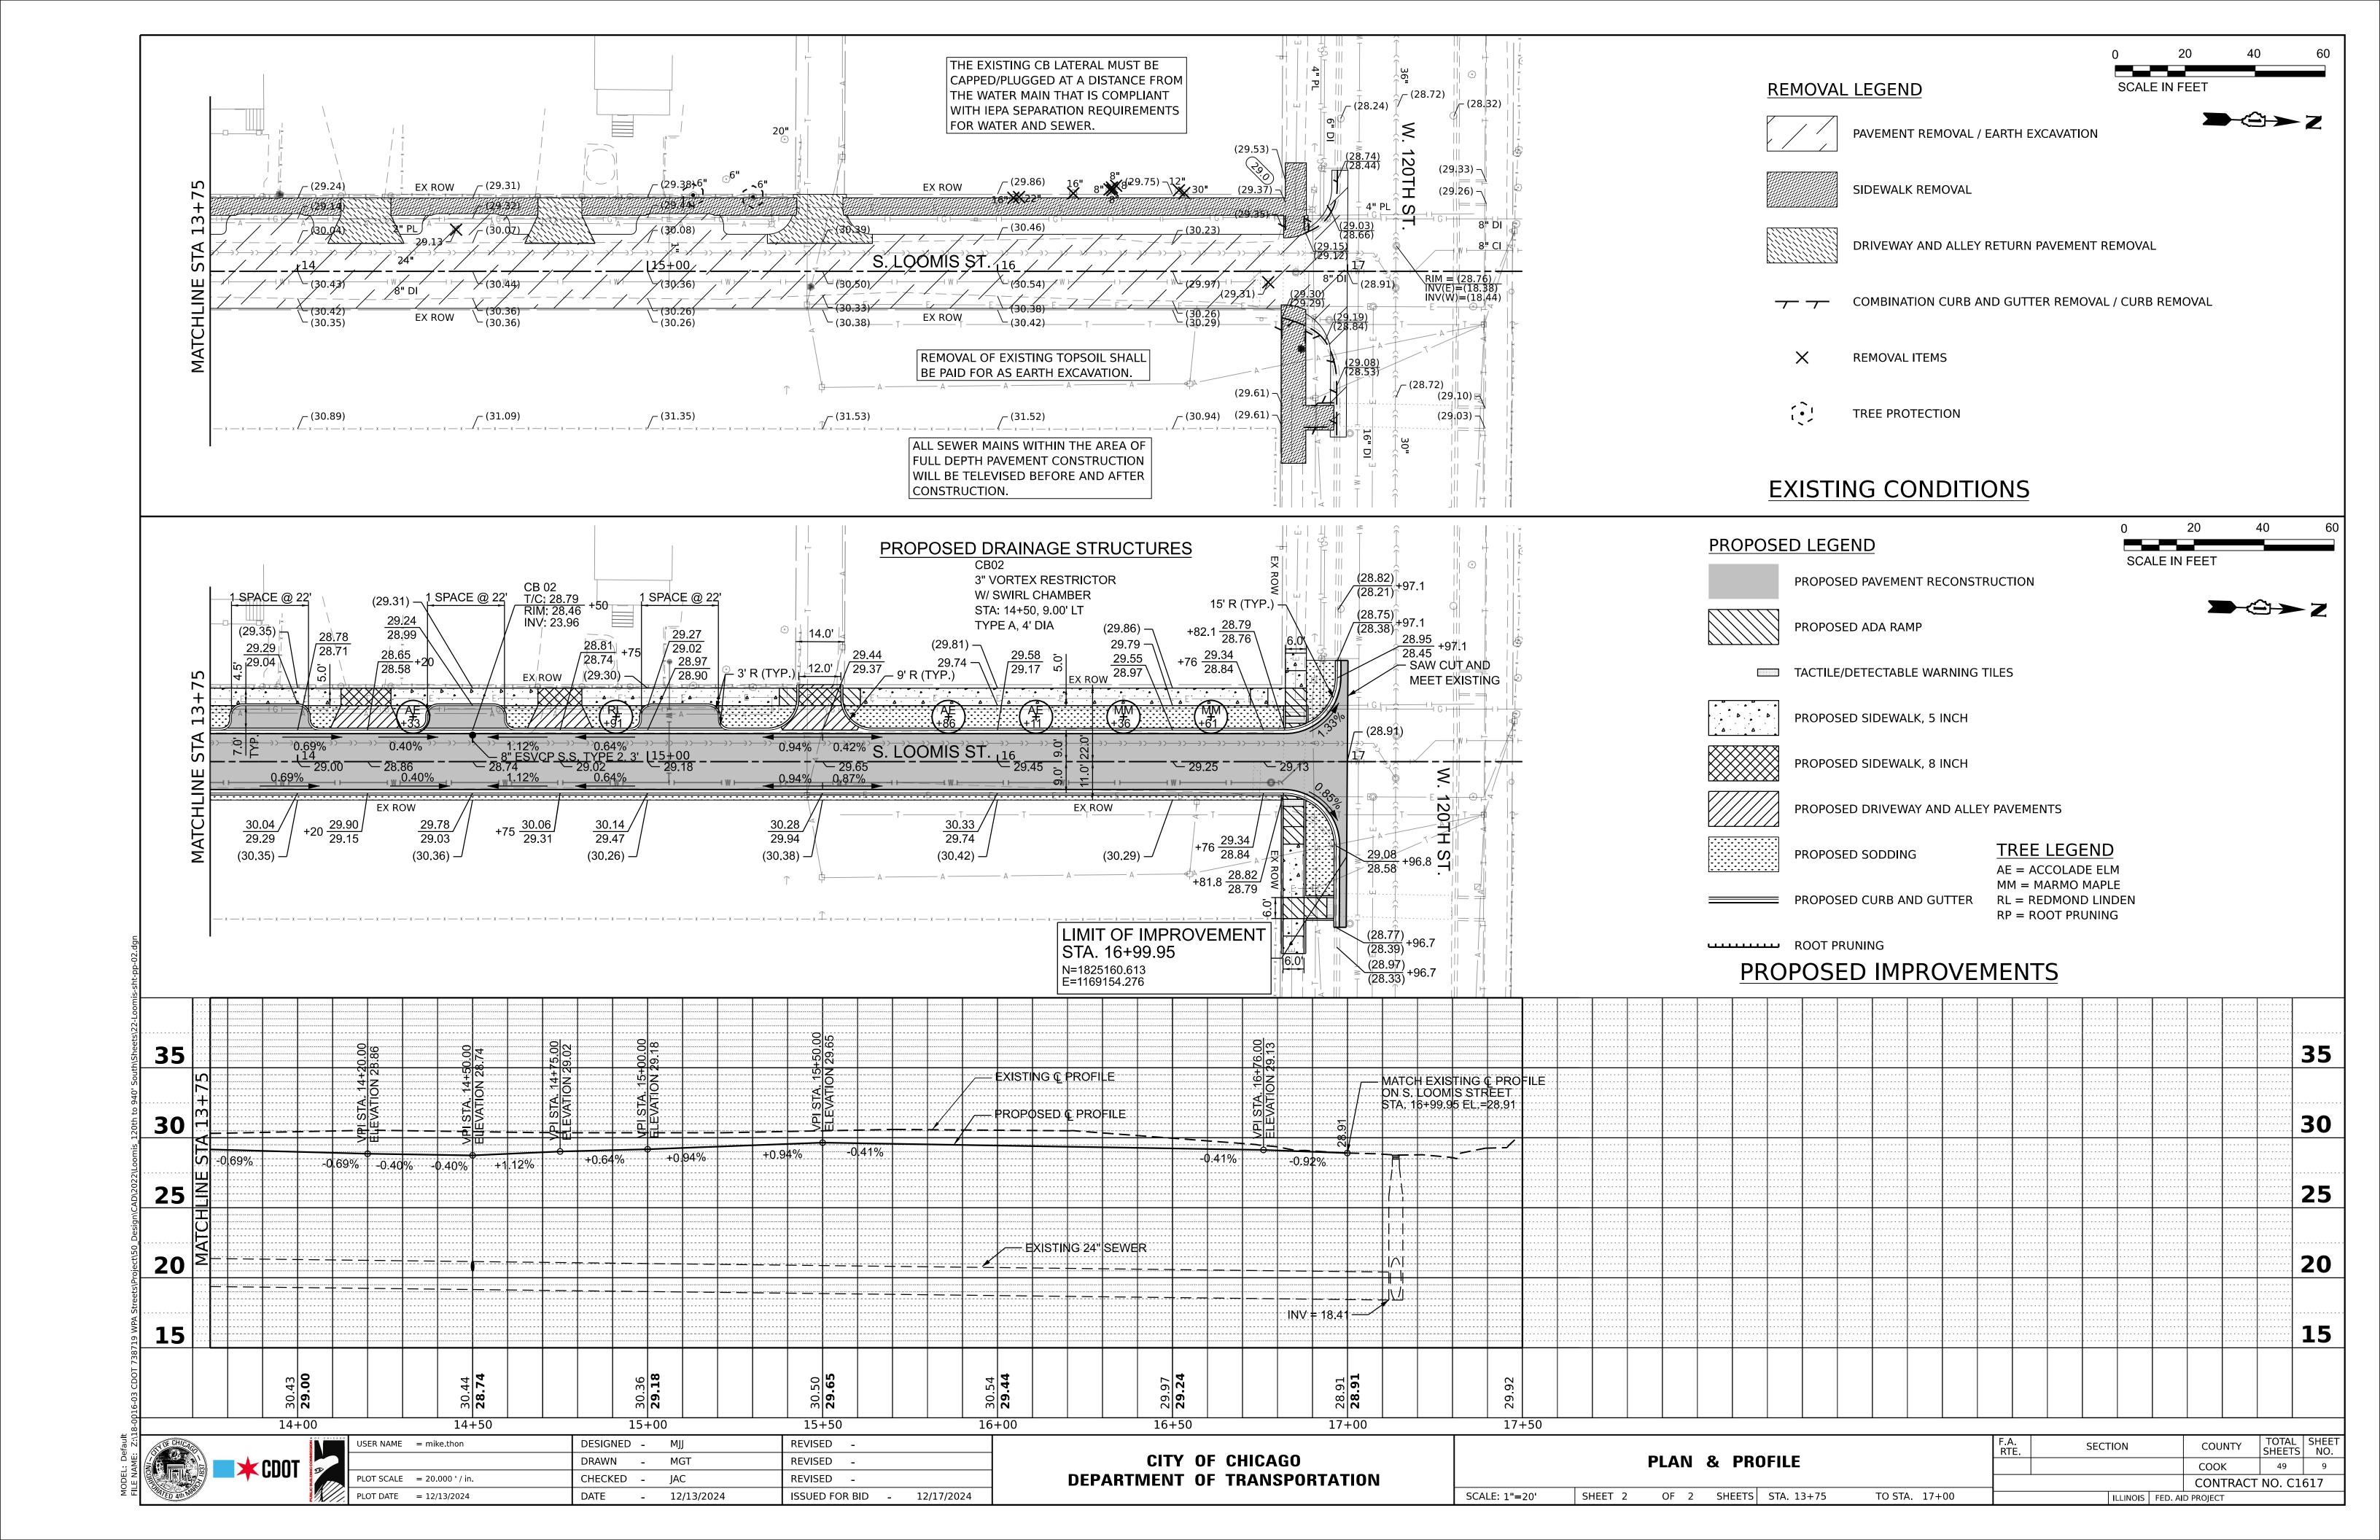

SW CORNER LOOMIS ST. & 120TH ST.

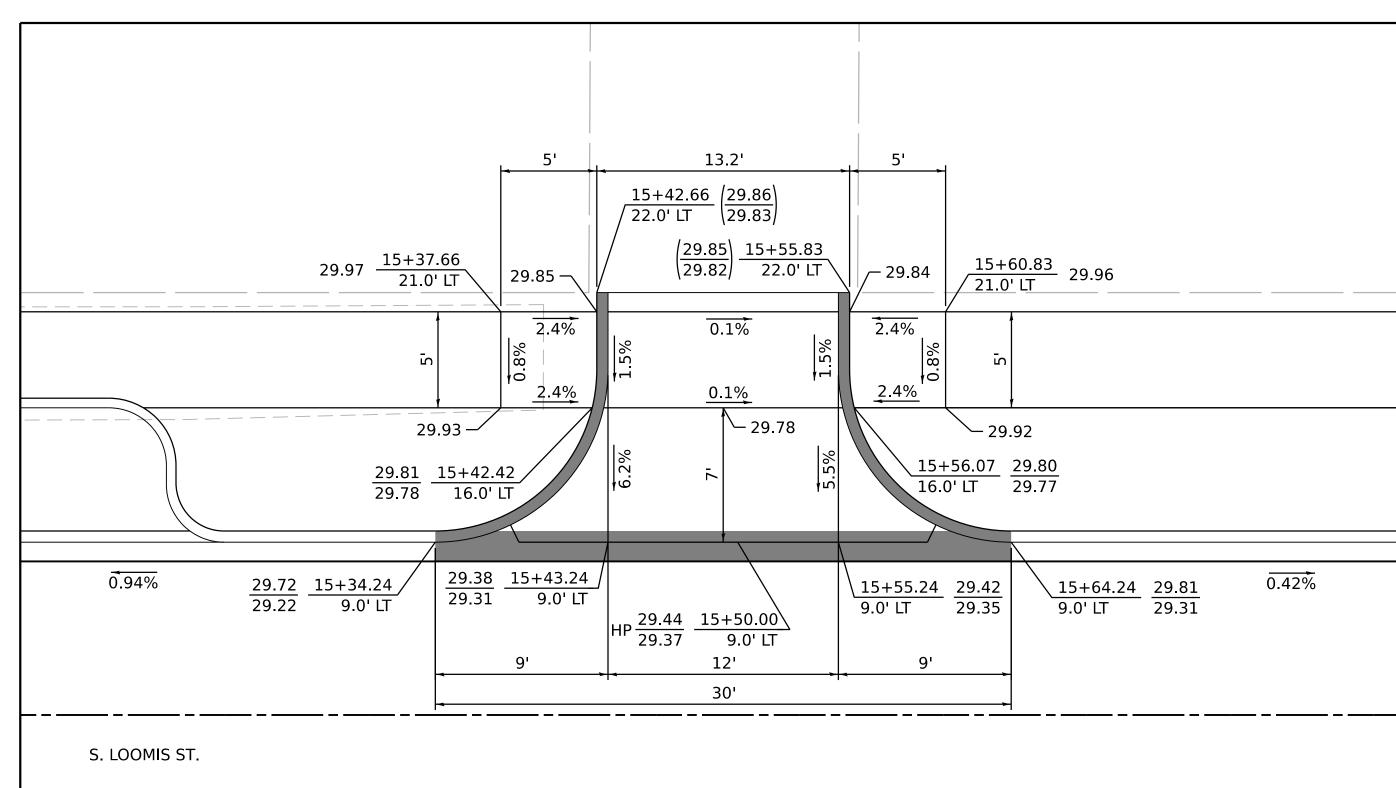

LOOMIS STREET - SOUTHBOUND STA. 15+49.24

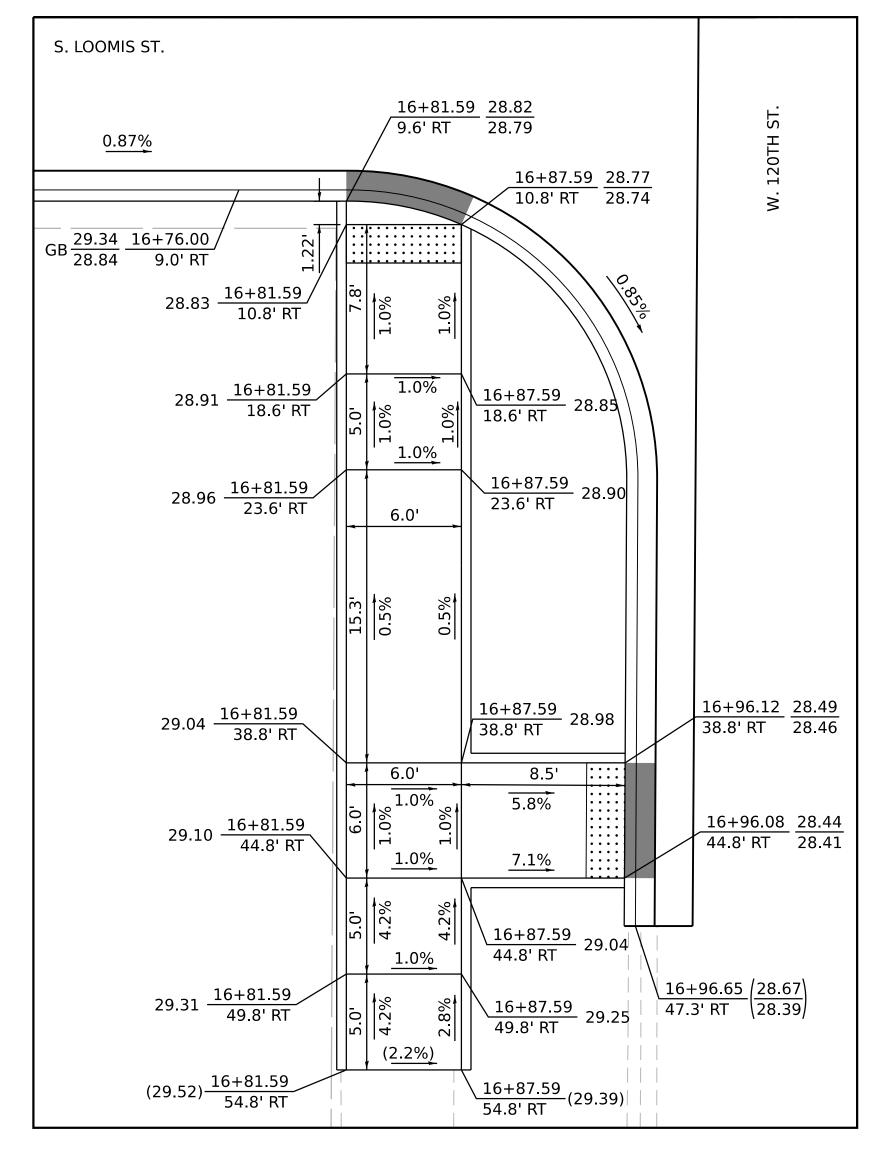

SE CORNER LOOMIS ST. & 120TH ST.





<u>NOTES</u>

XX.XX - PROPOSED ELEVATION (XX.XX) - EXISTING ELEVATION

XX.XX - TOP OF CURB ELEVATION XX.XX - FLOWLINE ELEVATION

HP - HIGH POINT GB - GRADE BREAK

VARY CURB HEIGHT AS NEEDED TO ACHIEVE ELEVATIONS AS SHOWN. (MINIMUM CURB HEIGHT = 3")

- DEPRESSED CURB


DESIGNED -REVISED -USER NAME = mike.thon MJJ REVISED DRAWN MGT PLOT SCALE = 5.000 '/ in. REVISED CHECKED -JAC PLOT DATE = 12/13/2024DATE - 12/13/2024 ISSUED FOR BID 12/17/2024


CITY OF CHICAGO **DEPARTMENT OF TRANSPORTATION**


F.A. RTE. **ADA GRADING DETAILS** OF 1 SHEETS STA. SCALE: 1"=5' SHEET 1 TO STA.

TOTAL SHEET NO. 49 10 COOK CONTRACT NO. C1617 ILLINOIS FED. AID PROJECT


SECTION

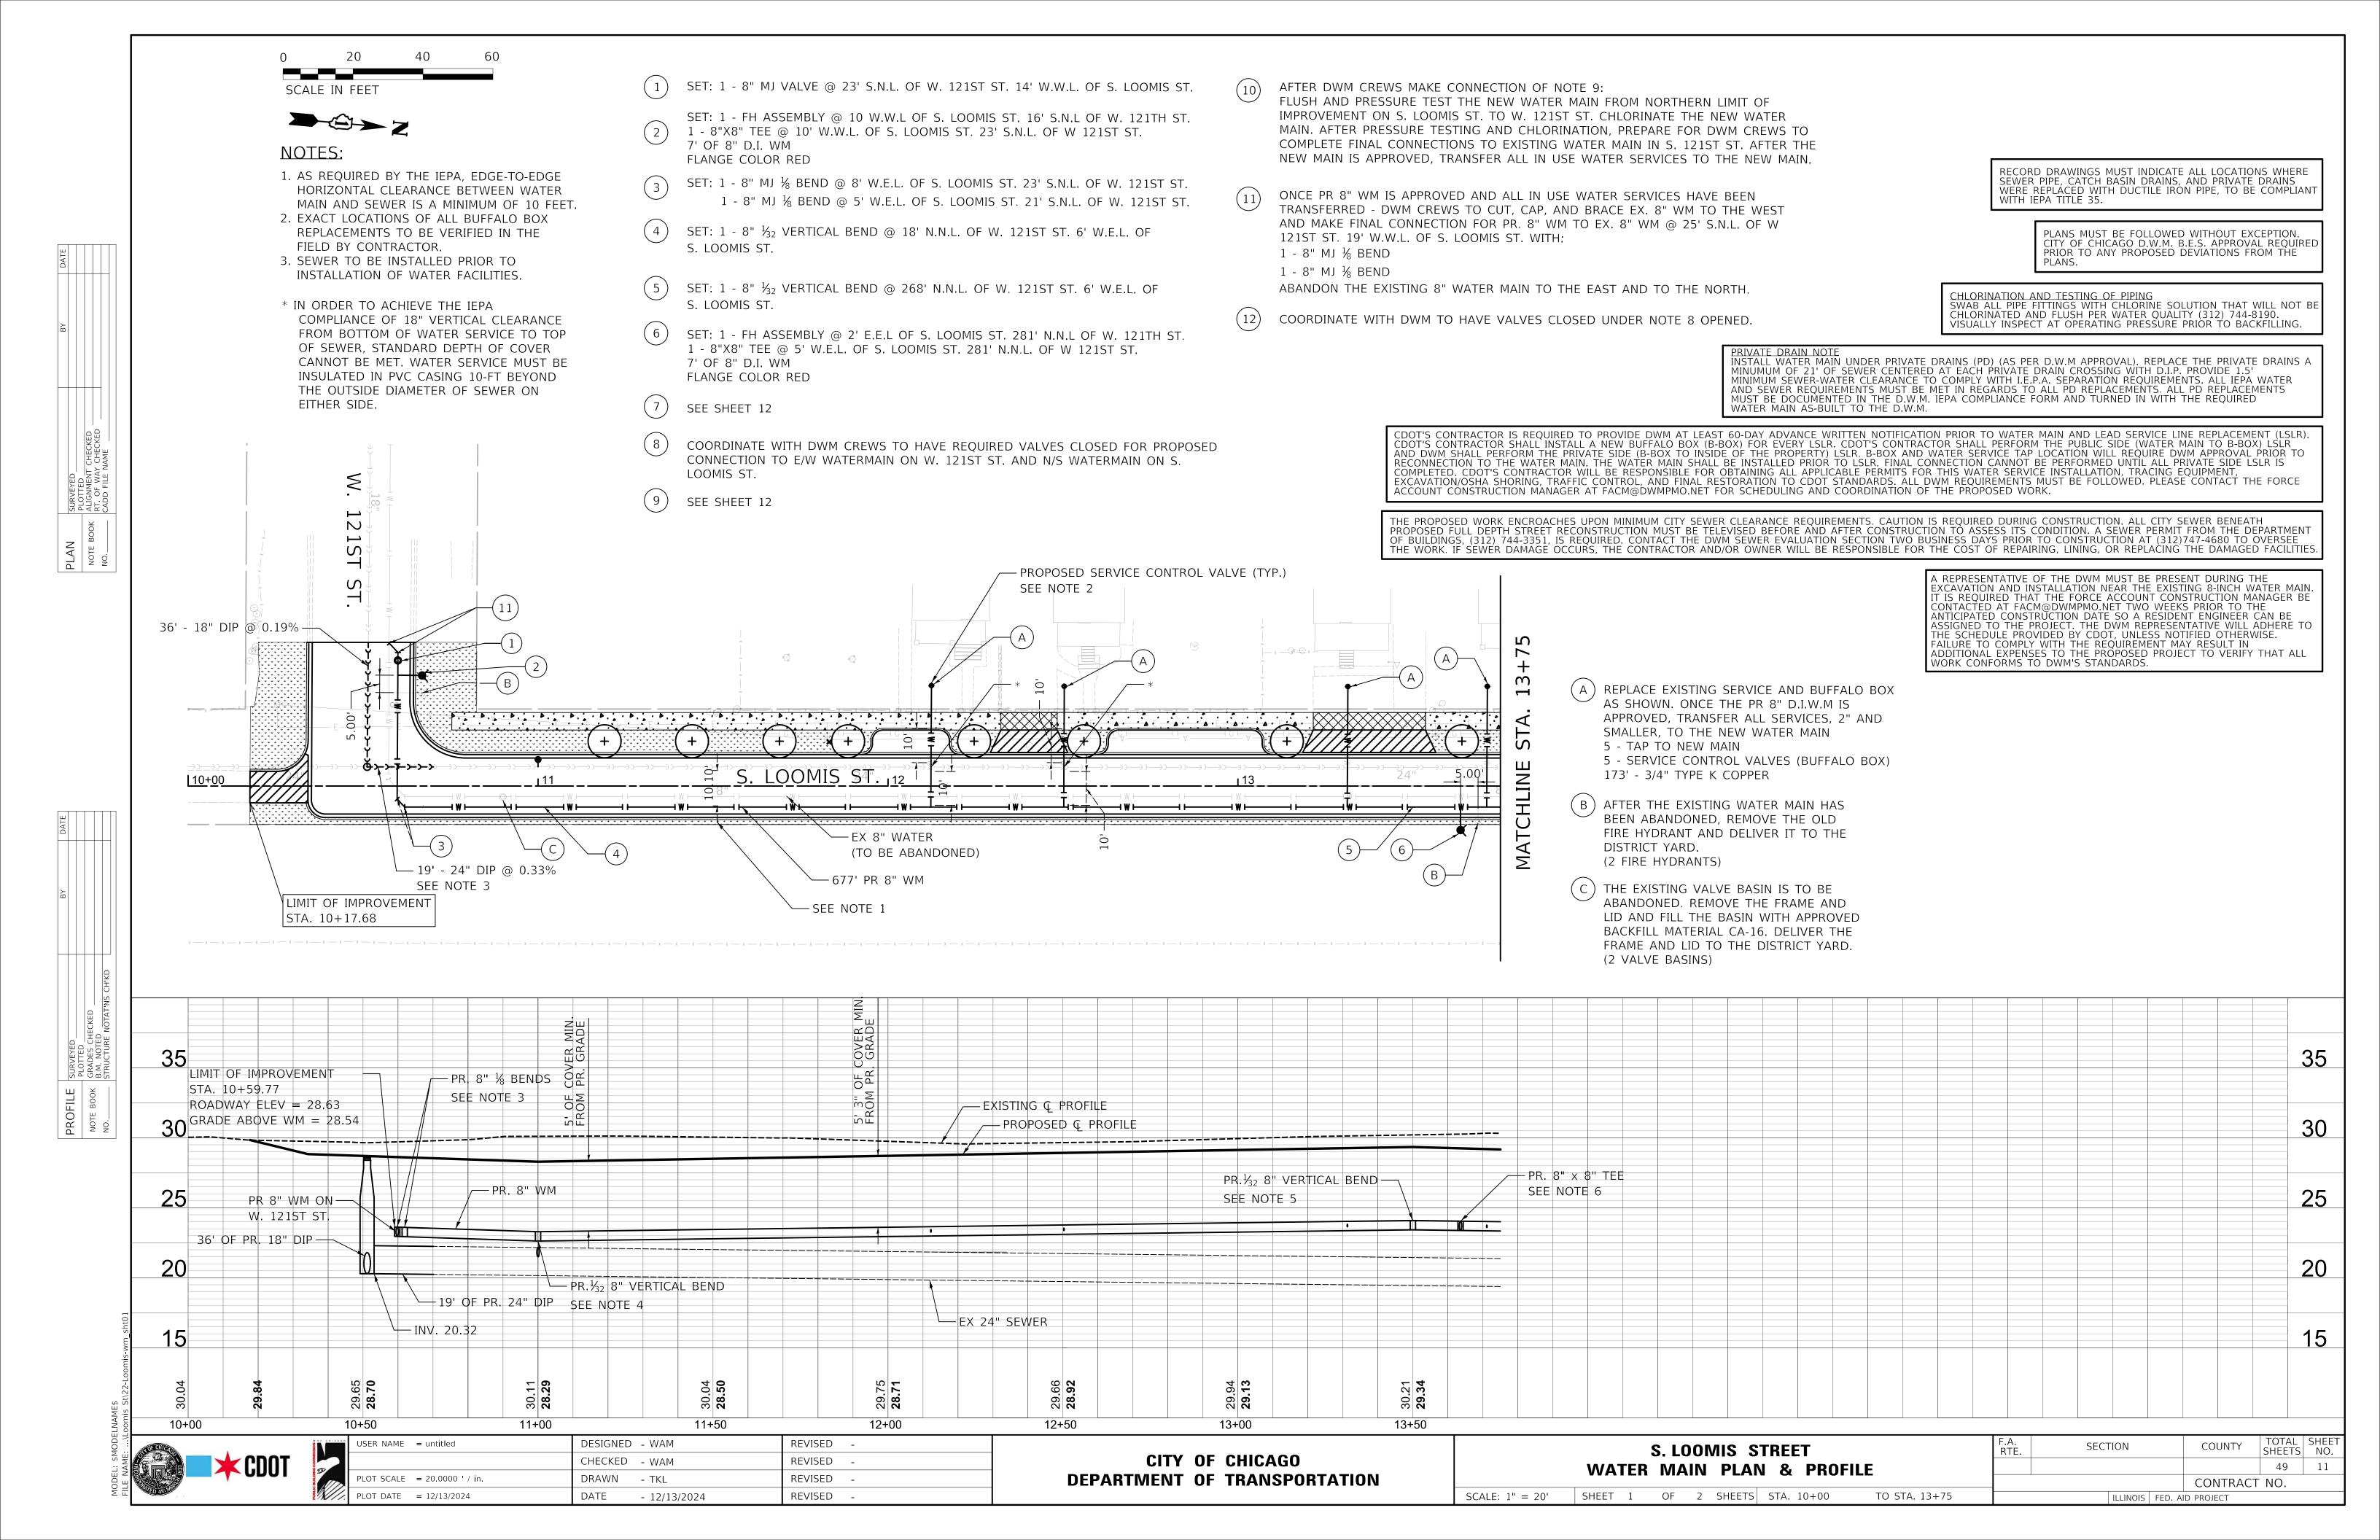


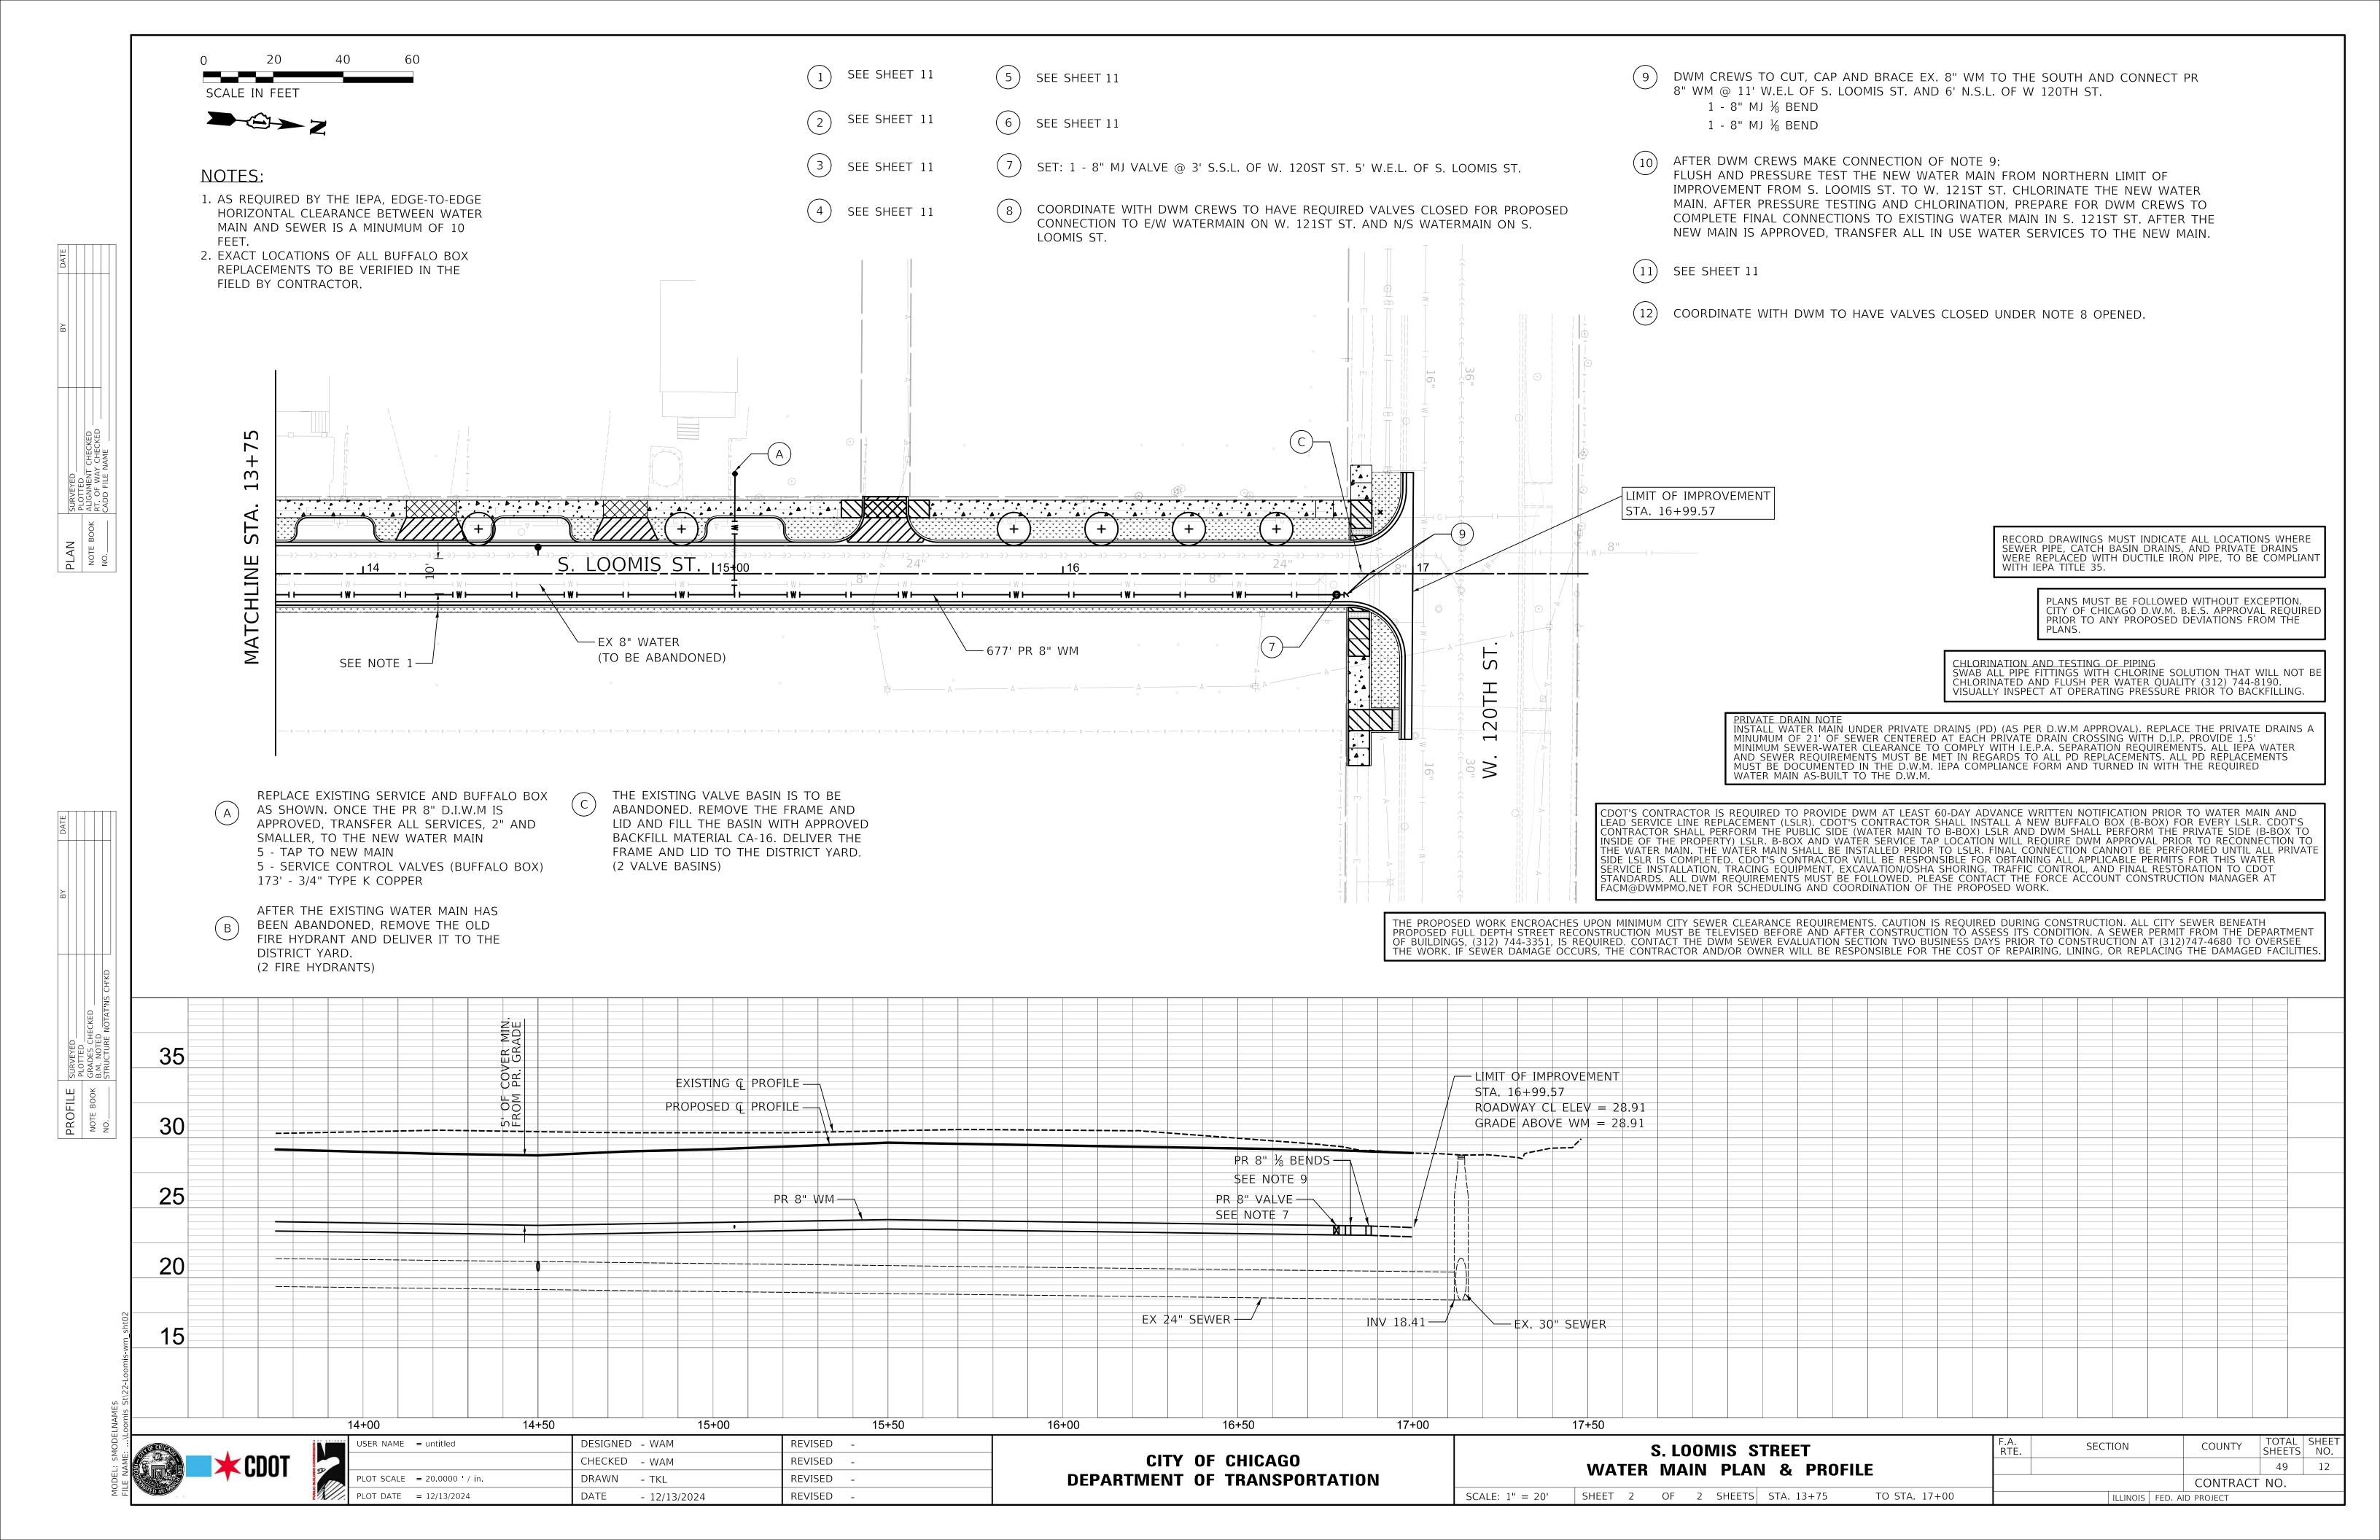

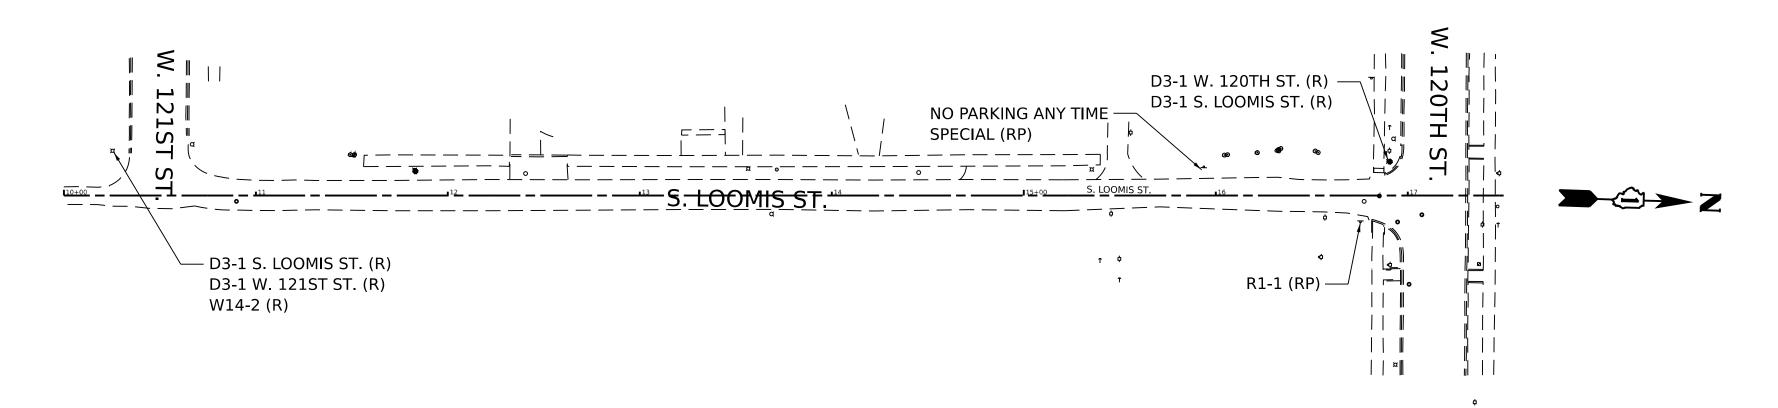

STRIPING LEGEND

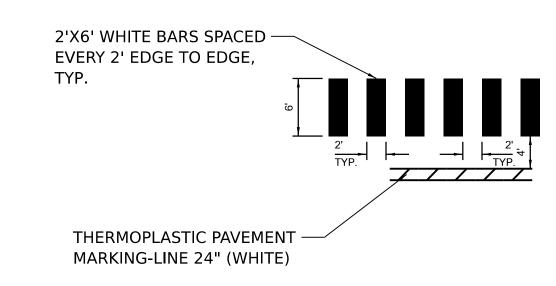

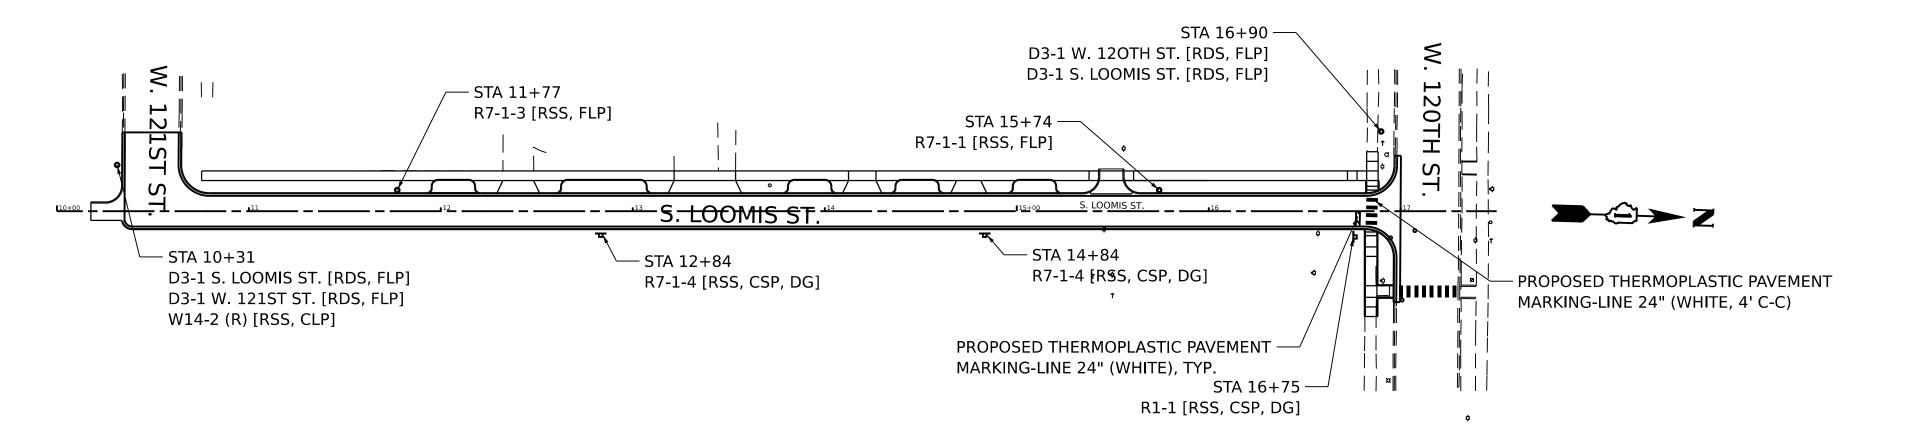

EXISTING SIGN LEGEND

SIGN CODE (SPECIAL TEXT) [ACTIVITY CODE] SPECIAL TEXT

> STREET NAME OR SPECIAL TEXT THAT DIFFERS FROM THE TEXT ASSOCIATED WITH EACH SIGN CODE (IF NEEDED)

ACTIVITY CODE

- R = REMOVE EXISTING SIGN PANEL AND SALVAGE
- RP = REMOVE EXISTING SIGN PANEL AND POLE ASSEMBLY, FROM PARKWAY, AND SALVAGE
- RS = REMOVE EXISTING SIGN PANEL AND POLE ASSEMBLY, FROM SIDEWALK, AND SALVAGE

PROPOSED SIGN LEGEND

STATION

SIGN CODE (SPECIAL TEXT) [FURNISH CODE, MOUNT CODE, POLE CODE]

SPECIAL TEXT

STREET NAME OR SPECIAL TEXT THAT DIFFERS FROM THE TEXT ASSOCIATED WITH EACH SIGN CODE (IF NEEDED)

FURNISH CODE

RSS = SIGN PANEL, TYPE 1, REFLECTIVE,

SINGLE SIDED

RDS = SIGN PANEL, TYPE 1, REFLECTIVE, DOUBLE SIDED

MOUNT CODE

CSP = CENTER MOUNT ON SIGN POLE

FSP = FLAG MOUNT ON SIGN POLE

CLP = CENTER MOUNT BANDED TO LIGHT POLE


FLP = FLAG MOUNT BANDED TO LIGHT POLE

POLE CODE (IF REQUIRED)

DG = SIGN SUPPORT POST, DIG METHOD


DR = SIGN SUPPORT POST, DRILL METHOD

SIGNING LEGEND

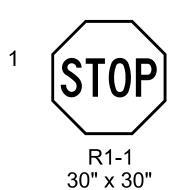


OUTLET

W14-2 30" x 30"

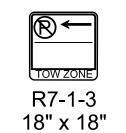

R7-1-4

18" x 18"

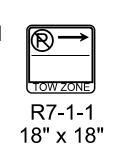

s LOOMIS st D3-1 36.00" x 6.75" w **121ST** sт D3-1

36.00" x 6.75"

w **120TH** sт D3-1 36.00" x 6.75"

CODE	DESCRIPTION	ADEA (SO ET)	FURNISH AND MOUNT CODES						
CODE	DESCRIPTION	AREA (SQ FT)	RSS	RDS	CSP	FSP	CLP	FLP	
R1-1	STOP	6.25	1		1				
R7-1-1	NO PARKING TOW ZONE RA	2.25	1					1	
R7-1-3	NO PARKING TOW ZONE LA	2.25	1					1	
R7-1-4	NO PARKING TOW ZONE	2.25	2		2				
W14-2	NO OUTLET	6.25	1				1		
D3-1	STREET NAME	1.69		4					
		TOTALS	6	4	3	0	1	E	
	TOTAL AREA F	21.5	6.76						

SCALE: 1"=50'




TOTAL SHEET NO.



F CHICAGO	USER NAME = mike.thon	DESIGNED -	MJJ	REVISED -
		DRAWN -	MGT	REVISED -
	PLOT SCALE = 49.998 ' / in.	CHECKED -	JAC	REVISED -
	PLOT DATE = 12/13/2024	DATE -	12/13/2024	ISSUED FOR BID - 12/17/2024

CITY OF CHICAGO DEPARTMENT OF TRANSPORTATION

				4.815		F.A. RTE.	SECTION		COUNTY	TOTAL SHEETS	SHEE NO.
P	AVEMENT	IVIA	RKING	AND	SIGNAGE				COOK	49	13
	Γ								CONTRACT	NO. C1	617
	SHEET	OF	SHEETS	STA.	TO STA.		ILLINOIS	FED. All	D PROJECT		

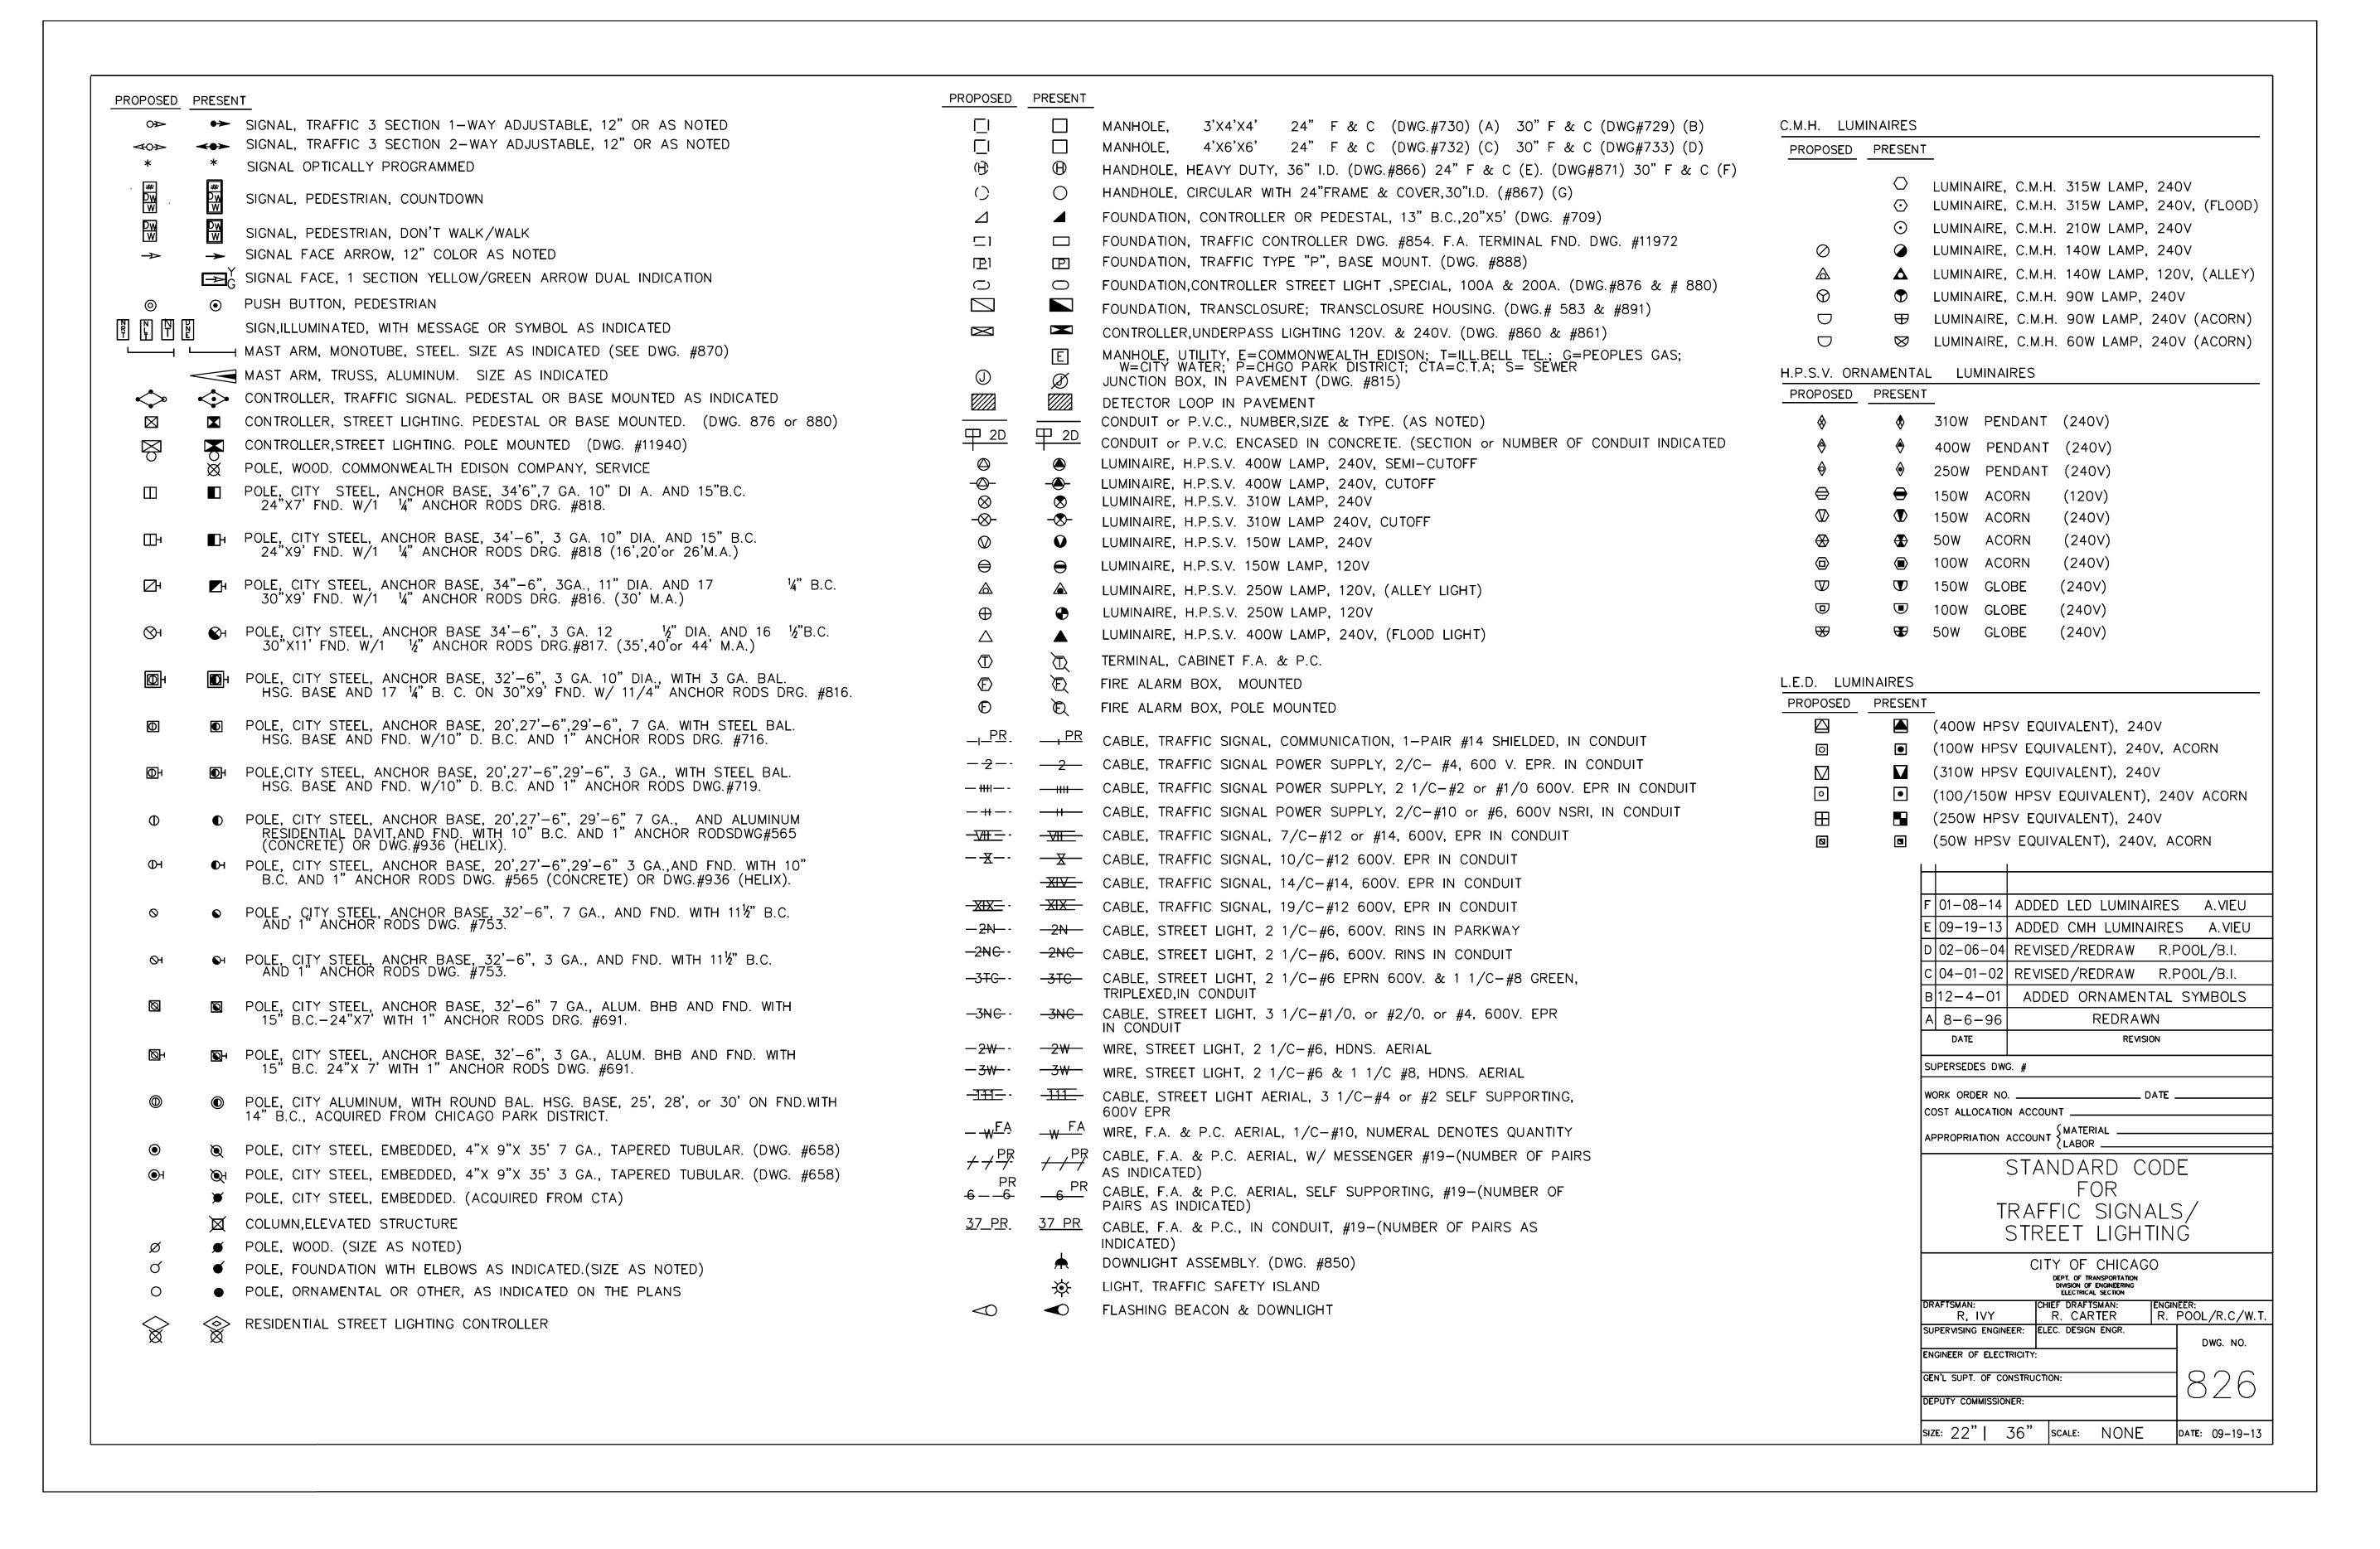



T	PUBLIC BUILDING COMMISSION

USER NAME = \$USER\$	DESIGNED	-	JVD	REVISED -
	DRAWN	-	JVD	REVISED -
PLOT SCALE = \$SCALE\$	CHECKED	-	RP / MG	REVISED -
PLOT DATE = 16-DEC-2024 08:46	DATE	-	12/05/2024	REVISED -

	CDOT	ELECTRI	CAL		F.A. RTE.	SECTION		COUNTY	TOTAL SHEETS	SHEE NO.
	STAND	VBD DE.	ΓAILS					COOK	49	14
<u> </u>	SIANDI	AND DE	IAILS					CONTRACT	NO.	
SHEET 01	OF 13	SHEETS	STA.	TO STA.		ILLINOIS	FED. AIC	PROJECT		

ELECTRICAL GENERAL NOTES

- ALL WORK FOR THIS CONTRACT SHALL BE IN ACCORDANCE WITH THE NATIONAL ELECTRICAL CODE (NEC), CITY OF CHICAGO DIVISION OF ELECTRICAL OPERATIONS STANDARDS (DEO), CHICAGO ELECTRICAL CODE, IDOT STANDARD SPECIFICATIONS ADOPTED APRIL 1, 2016, AND NEMA.
- THE CONTRACTOR SHALL PREPARE A PRELIMINARY SCHEDULE WHEN THE CONTRACT COMMENCES WHICH ESTABLISHES THE PROJECT DATES WHEN THE EXISTING AND TEMPORARY ELECTRICAL SERVICES WILL BE TRANSFERRED TO THE NEW PERMANENT SERVICES AS SHOWN ON THE DRAWINGS. THIS SCHEDULE SHALL BE APPROVED BY THE CONTRACTOR AND RESIDENT ENGINEER. THEN FORWARDED IN WRITING TO THE CITY OF CHICAGO, DIVISION OF ELECTRICAL OPERATIONS (DEO), AND COMED. SUBSEQUENT UPDATING OF THE SCHEDULE MUST BE FORWARDED TO THE ABOVE LISTED ENTITIES AS CHANGES OCCUR IN THE DATES. AT LEAST FIVE (5) WORKING DAYS BEFORE THE ELECTRICAL SERVICES ARE SCHEDULED TO BE TRANSFERRED. THE CONTRACTOR SHALL NOTIFY THE CITY OF CHICAGO DEO AND COMED BY PHONE AND CONFIRM THE REQUEST IN WRITING. ALL ELECTRICAL SERVICE WORK DOCUMENTATION MUST BE FORWARDED TO THE CITY FOR REVIEW AND APPROVAL. THE CONTRACTOR SHALL CONTACT THE FOLLOWING PERSONNEL PRIOR TO STARTING ANY WORK ON THE PRIMARY ELECTRICAL SERVICE EQUIPMENT:

INSPECTIONAL SERVICES. CITY OF CHICAGO DIVISION OF ELECTRICAL OPERATIONS 312-746-5048.

MR. STEVE TRIBUZZI, COMED MODIFICATIONS 773-682-1521

773-410-6200

MR. STEVE BYSTRIANSKY, JC DECAUX

MR. JEFF CAIRNS, CHICAGO OFFICE OF PUBLIC SAFETY ADMINISTRATION

312-746-9840

- THE CONTRACTOR SHALL HANDLE COORDINATION OF ALL PROPOSED ELECTRICAL CONNECTIONS, LIGHTING UNITS, CONTROL EQUIPMENT, AND/OR ANY OTHER WORK DEEMED NECESSARY BY THE COMMISSIONER TO ASSURE THAT ANY FUTURE OR CONCURRENT CONTRACT WORK PROCEEDS AS SCHEDULED AND WITHOUT DELAY.
- THE CONTRACTOR SHALL COORDINATE ALL WORK AND MATERIALS WITH SPECIAL ATTENTION TO ALL OTHER CONSTRUCTION CONTRACTS.
- THE CONTRACTOR SHALL REFER TO THE CIVIL DRAWINGS FOR LOCATIONS OF EXISTING EQUIPMENT AND UTILITIES NOT SPECIFICALLY SHOWN ON ELECTRICAL DRAWINGS.
- THE CONTRACTOR SHALL REFER TO THE TRAFFIC CONTROL DRAWINGS AND STATE STANDARDS FOR TRAFFIC CONTROL RELATED TO STREET LIGHTING AND TRAFFIC SIGNAL WORK.
- THE CONTRACTOR SHALL COORDINATE ALL WORK WITH THE GENERAL CIVIL, SEWER AND GENERAL TRAFFIC CONTROL NOTES ON DRAWINGS AND/OR SPECIFICATIONS.
- THE CONTRACTOR SHALL COORDINATE WITH ROADWAY, BRIDGE, SEWER, PIPING, AND TRAFFIC CONTROL CONTRACTORS FOR STAGING AND SEQUENCE OF INSTALLATIONS, BACKFILL, AND/OR CONSTRUCTION SCHEDULING.
- ALL CITY OF CHICAGO LIGHTING EQUIPMENT REMOVED AS PART OF THIS CONTRACT WILL REMAIN THE PROPERTY OF THE CITY AND SHALL BE DELIVERED TO CITY'S STORAGE FACILITY LOCATED WITHIN THE CITY LIMITS IN ACCORDANCE WITH THE CONTRACT SPECIFICATION, UNLESS NOTED OTHERWISE.
- RECORD DRAWINGS SHOWING EXISTING STREET LIGHTING INSTALLATIONS AND CABINET LOCATIONS. ARE AVAILABLE FOR THE CONTRACTOR'S INFORMATION AT THE OFFICES OF CITY OF CHICAGO DEPARTMENT OF STREETS AND SANITATION. DIVISION OF ELECTRICAL OPERATIONS.
- ALL EXISTING AREAS THAT ARE DAMAGED AS A PART OF THIS WORK, INCLUDING BUT NOT LIMITED TO FENCING, CURBS AND GUTTERS, AND SIDEWALKS, WHERE RESTORATION IS NOT COVERED BY THE APPLICABLE CONTRACT PAY ITEMS, SHALL BE RESTORED TO THE SATISFACTION OF THE COMMISSIONER AND SEPARATE PAYMENT WILL NOT BE MADE.
- ALL NEW ELECTRICAL EQUIPMENT INSTALLED UNDER THIS CONTRACT SHALL BE DONE IN SUCH A MANNER AS NOT TO DAMAGE THE EXISTING LANDSCAPE (TREES. BUSHES. ETC.) DURING THE PROGRESSION OF WORK. IF THE CONTRACTOR HAS A CONFLICT WITH THE EXISTING LANDSCAPE HE SHALL STOP THE WORK, IMMEDIATELY NOTIFY THE RESIDENT ENGINEER AND PUBLIC BUILDING COMISSION OF CHICAGO, AND WAIT FOR RESOLUTION.
- THE EXISTING ROADWAY LIGHTING SYSTEM WITHIN THE CONSTRUCTION LIMITS OF THE PROJECT SHALL REMAIN IN OPERATION FOR THE DURATION OF THIS PROJECT UNTIL SUCH TIME THAT THE NEW LIGHTING SYSTEM HAS BEEN INSTALLED, ENERGIZED, TESTED, ADJUSTED. AND ACCEPTED BY THE COMMISSIONER. THE COST OF THIS WORK WILL BE INCLUDED AS PART OF THE MAINTAIN EXISTING LIGHTING SYSTEM PAY ITEM AND SEPARATE PAYMENT WILL NOT BE MADE.
- WORK FOR ELECTRICAL SYSTEMS SHALL BE COMPLETED, APPROVED, AND FULLY OPERATIONAL BEFORE A FINAL ACCEPTANCE INSPECTION FOR THE WHOLE PROJECT CAN BE SCHEDULED. LIGHTING CONTROLLERS MAY NOT BE TRANSFERRED IN GROUPS OR INDIVIDUALLY TO THE CITY FOR MAINTENANCE PURPOSES PRIOR TO CONTRACT COMPLETION UNLESS OTHERWISE DIRECTED BY THE COMMISSIONER.
- AT THE COMMENCEMENT OF CONTRACTOR ACTIVITIES, ELECTRICAL OR OTHERWISE, THE CONTRACTOR WILL BE RESPONSIBLE FOR THE PROPER OPERATION AND MAINTENANCE OF ALL EXISTING LIGHTING AND POWER SYSTEMS IN ACCORDANCE WITH THE STANDARD SPECIFICATIONS. UNLESS OTHERWISE DIRECTED BY THE COMMISSIONER.
- ALL PROPOSED DUCT BANKS, CONDUITS, JUNCTION BOXES, AND APPURTENANCES ARE ILLUSTRATED DIAGRAMMATICALLY. THE ACTUAL LOCATIONS IN THE FIELD SHALL BE APPROVED BY THE COMMISSIONER.


- DE-ENERGIZING OF EXISTING LIGHTING UNITS WILL BE INCLUDED IN THE COST OF THE REMOVE EXISTING STREET LIGHTING EQUIPMENT PAY ITEM WORK. SEPARATE PAYMENT WILL NOT BE MADE.
- DISCONNECTION AND REMOVAL OF EXISTING BEAM CLAMPS, HANGERS, BRACKETS, CONDUITS, WIRES IN CONDUIT, AND AERIAL CABLES ATTACHED TO STRUCTURE AND TO EXISTING LIGHTING UNITS WILL BE INCLUDED IN THE COST OF REMOVE EXISTING STREET LIGHTING EQUIPMENT. SEPARATE PAYMENT WILL NOT BE MADE.
- QUAZITE BOXES SHOULD BE FILLED WITH SAND AND CONDUITS THAT ENTER QUAZITE BOXES SHOULD BE CAPPED UNTIL FUTURE UTILITY OWNER PULLS CABLES IN FOR DAS SYSTEMS. THIS WILL PREVENT DAMAGE TO QUAZITE BOXES AND MITIGATE AGAINST MAINTENANCE RESPONSIBILITIES FOR CDOT UNTIL THE QUAZITE BOXES ARE TURNED OVER TO UTILITY OWNERSHIP.
- REMOVAL OF EXISTING ELECTRICAL CABLES FEEDING EACH OF THE EXISTING LIGHTING/SIGNAL UNITS WILL BE INCLUDED IN THE COST OF REMOVE EXISTING STREET LIGHTING EQUIPMENT AND SEPARATE PAYMENT WILL NOT BE MADE.
- EXISTING EMBEDDED AND UNDERGROUND RACEWAYS BETWEEN EXISTING LIGHTING UNITS OR EXISTING EQUIPMENT SHALL BE REMOVED, UNLESS NOTED OTHERWISE.
- THE CONTRACTOR SHALL COORDINATE WITH THE COMMISSIONER AND ALL CONCERNED ORGANIZATIONS AS TO POSSIBLE REMOVAL, REPLACEMENT, DISPLACEMENT, AND/OR METHOD OF AVOIDANCE OF EXISTING OBSTRUCTIONS OR PROPOSED CONSTRUCTION ELEMENTS REQUIRED BY NEW INSTALLATIONS.
- THE CONTRACTOR SHALL PROVIDE AND INSTALL ANY ADDITIONAL TEMPORARY ELECTRICAL EQUIPMENT CONNECTIONS AS NECESSARY TO MAINTAIN EXISTING LIGHTING CONTINUITY AS THE PROPOSED WORK FOR INSTALLATION AND REMOVAL OF EXISTING LIGHTING EQUIPMENT PROGRESSES. THE COST OF THIS WORK WILL BE INCLUDED IN MAINTAIN EXISTING LIGHTING SYSTEM.
- WHERE THE CONTRACTOR'S EXCAVATION MEETS AN OBSTRUCTION OR EXISTING FOUNDATION. THE CONTRACTOR MUST NOTIFY THE COMMISSIONER FOR DIRECTION IN WRITING PRIOR TO FURTHER EXCAVATION. THE CONTRACTOR SHALL RESTORE ANY DAMAGE TO EXISTING SYSTEMS OR UTILITIES AND REMOVE EXISTING OBSTRUCTIONS AND FOUNDATIONS TO THE SATISFACTION OF THE COMMISSIONER. THIS WORK WILL BE INCLUDED IN THE APPROPRIATE EXCAVATION PAY ITEM.
- THE CONTRACTOR SHALL REFER TO ALL CITY OF CHICAGO EDISON SERVICE ATLAS DRAWINGS, CHICAGO PARK DISTRICT DRAWINGS, COMED DRAWINGS, AND AT&T DRAWINGS FOR POSSIBLE UNDERGROUND WIRES, CABLES, CONDUITS, DUCT RUNS, EQUIPMENT, OR DEVICES.
- THE CONTRACTOR SHALL BE RESPONSIBLE FOR MARKING THE PROPOSED LOCATION OF ALL CITY LIGHT POLES, LUMINAIRES, CABINETS, JUNCTION BOXES. CONDUIT ROUTES. AND OTHER EQUIPMENT AND ITEMS FOR A CONTRACTOR REQUESTED PRE-CONSTRUCTION INSPECTION BY THE COMMISSIONER, THE CITY OF CHICAGO DIVISION OF ELECTRICAL OPERATIONS. THE EXACT LOCATIONS OF ALL ITEMS SHALL BE APPROVED BY THE CITY OF CHICAGO DIVISION OF ELECTRICAL OPERATIONS PRIOR TO STARTING WORK. ANY WORK INSTALLED WITHOUT LOCATION APPROVAL FROM THE CITY OF CHICAGO DIVISION OF ELECTRICAL OPERATIONS WILL BE SUBJECTED TO CORRECTIVE ACTION AT THE CONTRACTOR'S EXPENSE.
- THE CONTRACTOR SHALL IDENTIFY EACH ELECTRIC CABLE ASSEMBLY FOR STREET LIGHTING. CABLES SHALL BE TAGGED IN ALL HANDHOLES, MANHOLES, CONTROLLER CABINETS, AND LIGHT POLE BASES.
- CONDUIT STUBOUTS IN EQUIPMENT FOUNDATIONS WILL NOT BE MEASURED FOR PAYMENT, BUT WILL BE CONSIDERED AS PART OF THE APPLICABLE FOUNDATION PAY ITEM. REFER TO SPECIFICATIONS.
- THE QUANTITIES OF RIGID GALVANIZED STEEL CONDUIT AND PVC, WHERE INDICATED ON THESE PLAN DRAWINGS, ARE APPROXIMATIONS ONLY. THE CONTRACTOR SHALL FIELD VERIFY ALL LENGTHS AND SHALL INSTALL RACEWAYS IN COMPLIANCE WITH THE SPECIFIED REQUIREMENTS.
- THE ELECTRIC CABLE PHASE AND NEUTRAL CONDUCTORS SHALL BE RUN CONTINUOUS WITHOUT ANY UNDERGROUND SPLICES, JUNCTION BOX SPLICES. PULL BOX SPLICES. HANDHOLE SPLICES. OR MANHOLE SPLICES. SPLICES OF ELECTRIC CABLE PHASE AND NEUTRAL CONDUCTORS WILL BE PERMITTED ONLY IN THE BASE OF THE PROPOSED LIGHT POLES AND CONTROLLERS UNLESS NOTED OTHERWISE. THIS WORK WILL BE INCLUDED IN THE ELECTRIC CABLE PAY ITEM AND SEPARATE PAYMENT WILL NOT BE MADE.
- THE CONTRACTOR SHALL DETERMINE WHICH CABLES ARE TO BE ROUTED IN EACH CELL WHERE MULTIPLE EMBEDDED CONDUITS ARE INDICATED. CONDUCTORS DEDICATED TO A CIRCUIT SHALL NOT BE SEPARATED. DETERMINATION OF WHICH FEEDER IS TO BE PULLED THROUGH A SPECIFIC CELL SHOULD BE BASED ON SIMPLICITY OF CABLE PULL. LEAST AMOUNT OF CROSS-OVERS IN MANHOLES OR HANDHOLES, AND FUTURE CABLE REPLACEMENT REQUIRED.
- WHERE DUCT RUN OR EMBEDDED CONDUIT INSTALLATIONS MUST DEVIATE FROM THAT SHOWN ON DRAWINGS AND DEVIATIONS INCREASE DUCT LENGTH OR ADD BENDS BETWEEN MANHOLES/HANDHOLES OR DEVICES. THE CONTRACTOR SHALL NOTIFY THE COMMISSIONER AND PRODUCE EVIDENCE THAT CABLES CAN BE PULLED THROUGH THE EXISTING OR PROPOSED DUCT WITHOUT EXCEEDING MAXIMUM ALLOWABLE CABLE PULLING TENSION.
- THE CONTRACTOR SHALL SCHEDULE A FINAL ACCEPTANCE INSPECTION WITH THE COMMISSIONER, THE CITY OF CHICAGO DIVISION OF ELECTRICAL OPERATIONS. AND PUBLIC BUILDING COMMISSION OF CHICAGO UPON COMPLETION OF ALL PROPOSED STREET LIGHTING WORK. UPON FINAL ACCEPTANCE BY THE DEO. THE COMMISSIONER. AND PUBLIC BUILDING COMMISSION OF CHICAGO THE CONTRACTOR SHALL TRANSFER ALL STREET LIGHTING, AND POWER DISTRIBUTION INSTALLATIONS TO THE CITY DEO FOR MAINTENANCE PURPOSES.
- ALL EMPTY CONDUIT FOR FUTURE USE SHALL HAVE A PULL STRING OR CABLE INSTALLED TO ASSIST IN FUTURE CABLING. THE COST OF THE CABLE OR STRING WILL BE CONSIDERED INCLUDED IN THE COST OF THE CONDUIT.
- THE CONTRACTOR IS RESPONSIBLE TO VERIFY CONDUIT INSTALLATION AGAINST EXISTING AND PROPOSED UNDERGROUND UTILITIES. THE MINIMUM HORIZONTAL CLEARANCE OF 3FT MUST BE PROVIDED BETWEEN THE PROPOSED UNDERGROUND CONDUIT AND THE EXISTING OR PROPOSED WATERMAIN. THE CONDUIT INSTALLATION MUST MAINTAIN A MINIMUM VERTICAL CLEARANCE OF 18 INCHES WHERE IT CROSSES THE WATERMAIN.
- CITY CONTRACTORS ARE REQUESTED TO TAKE EXTRA PRECAUTIONS WHEN WORKING NEAR COMED OVERHEAD WIRES. THESE WIRES ARE NOT INSULATED. WHEN FIELD CONDITIONS REQUIRE COMED ASSISTANCE (SUCH AS MANHOLE FRAME & COVER ADJUSTMENTS), PLEASE CONTACT COMED, PROJECT ENGINEER, CAITLIN BALL, 773-838-2905, 6-WEEKS PRIOR TO START OF WORK.


SHEET 02

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-
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CITY	OF	CHICAGO
DEPARTMENT	OF	TRANSPORTATION

ELECTRICAL GENERAL				F.A. RTE.	SECT	ΓΙΟΝ		COUNTY	TOTAL SHEETS	SHEE NO.
NOTES							COOK	49	15	
					CONTRACT NO.					
OF 13	SHEETS	STA.	TO STA.			ILLINOIS	FFD All	D PROJECT		



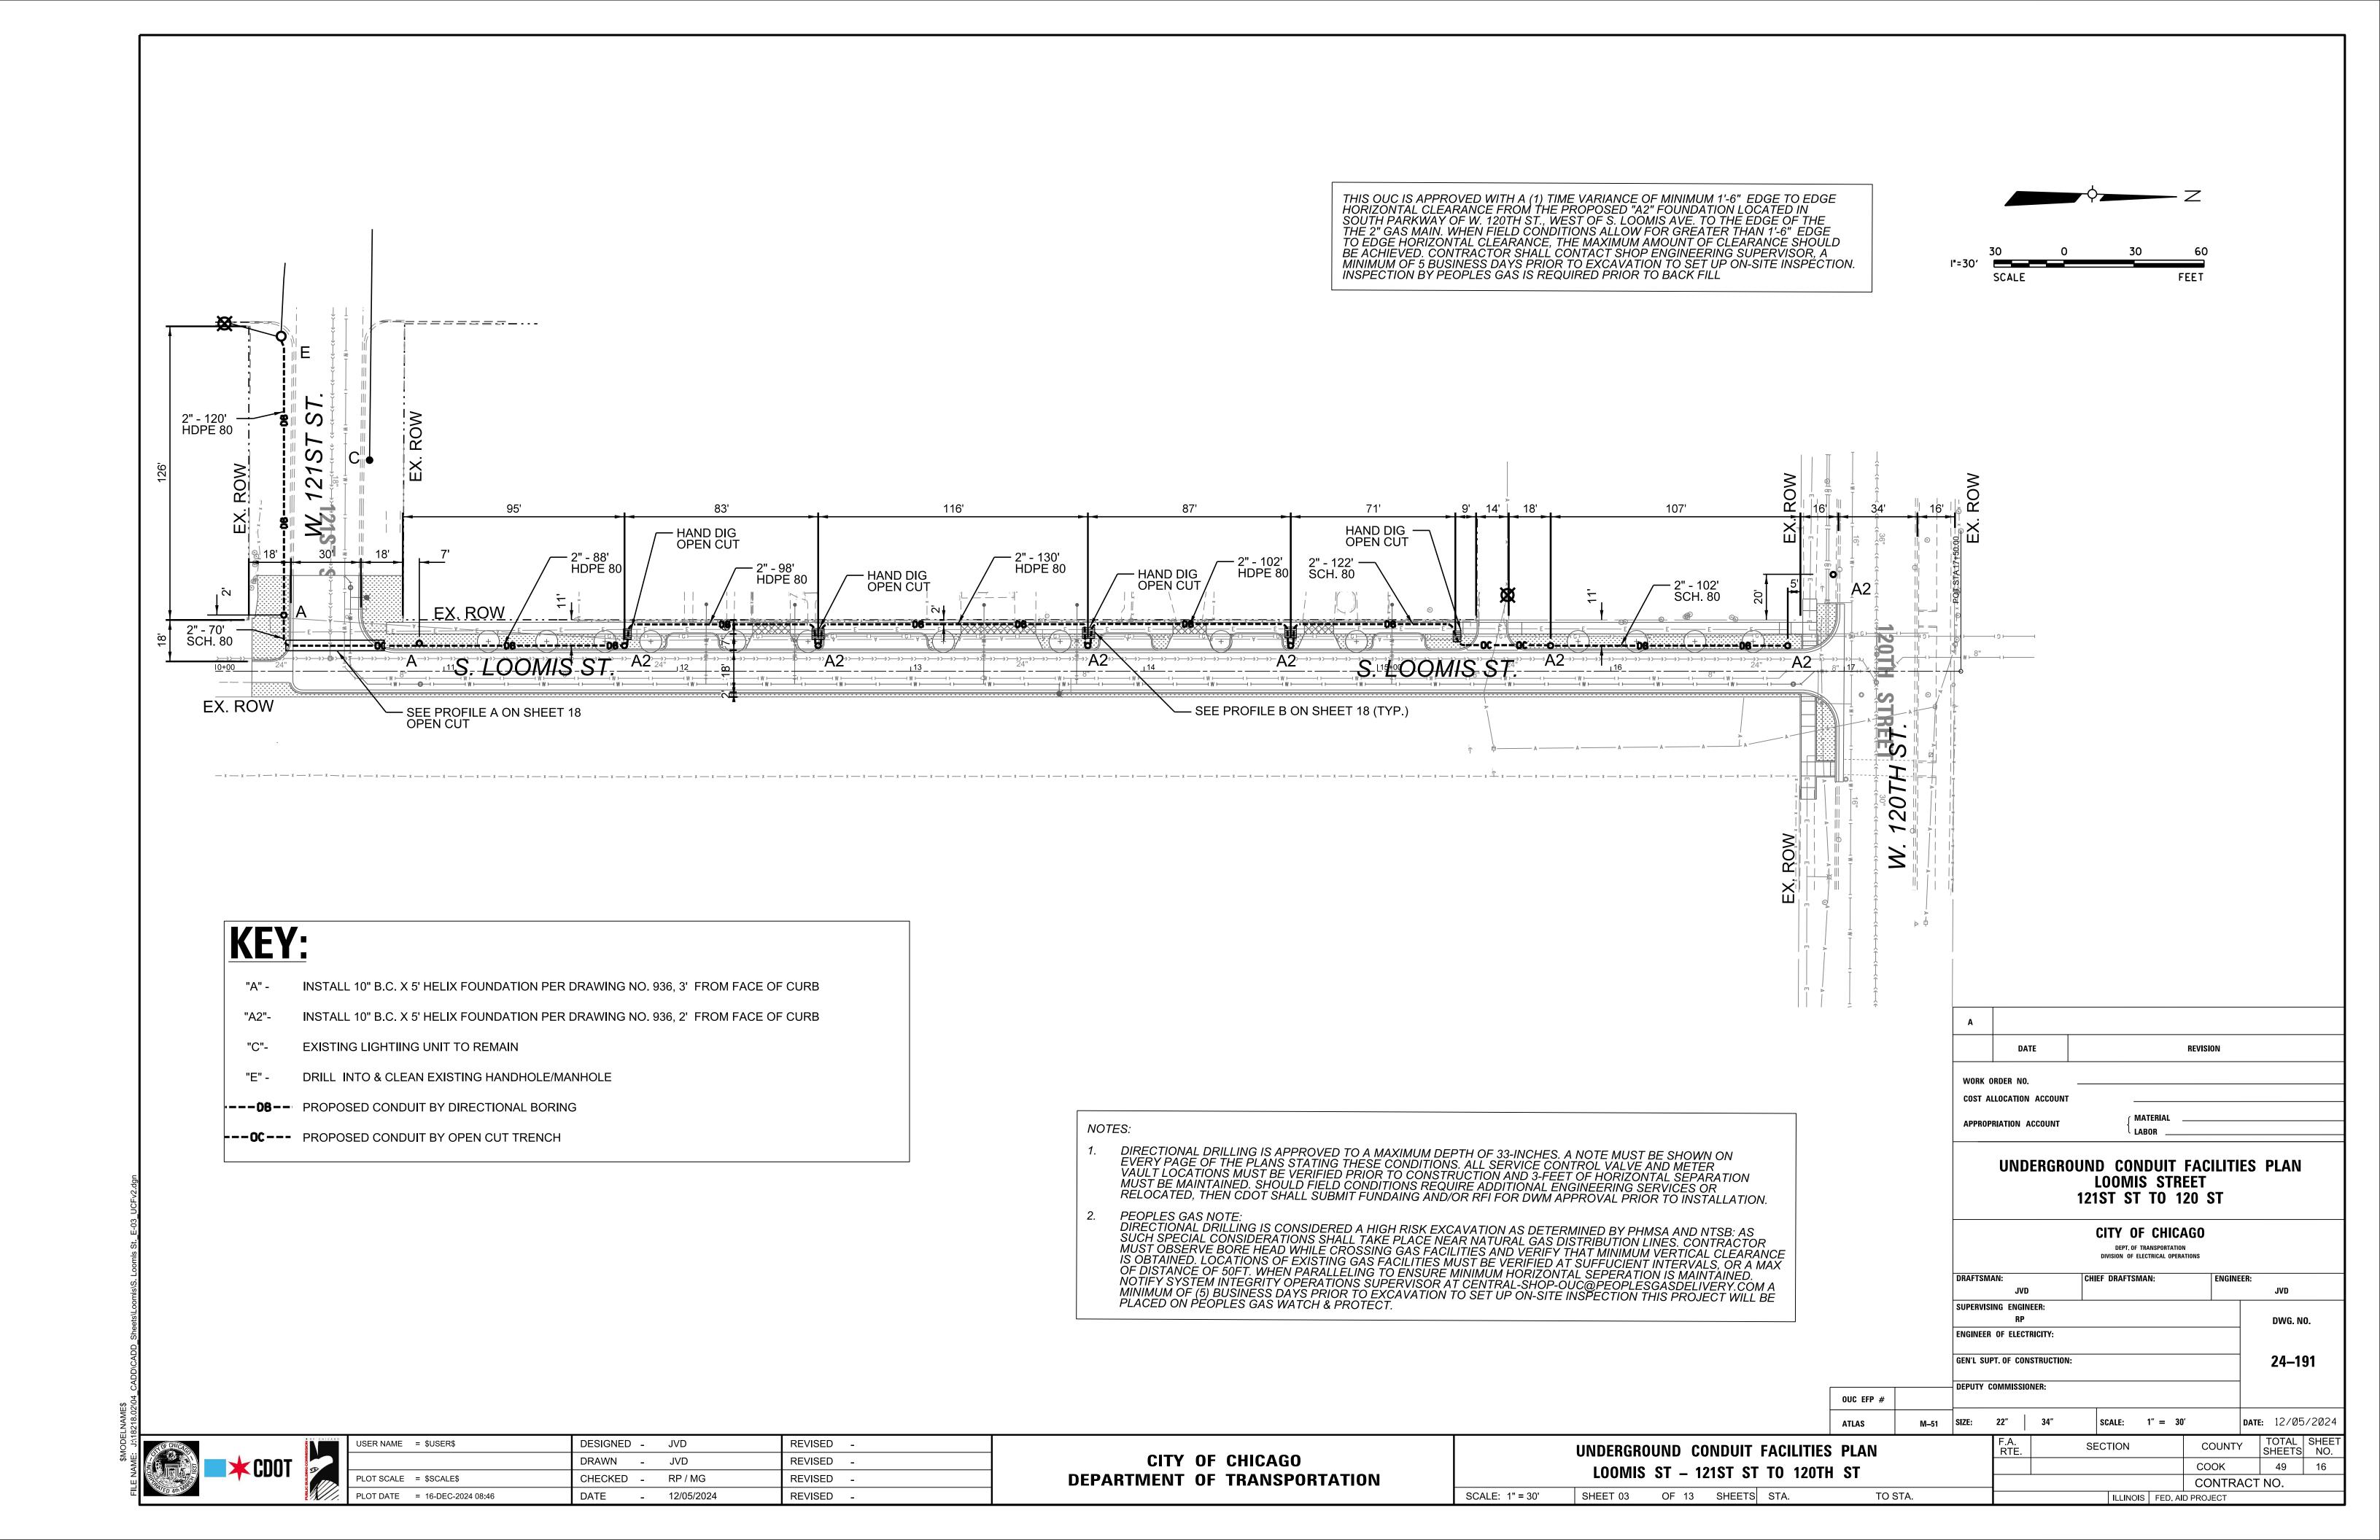

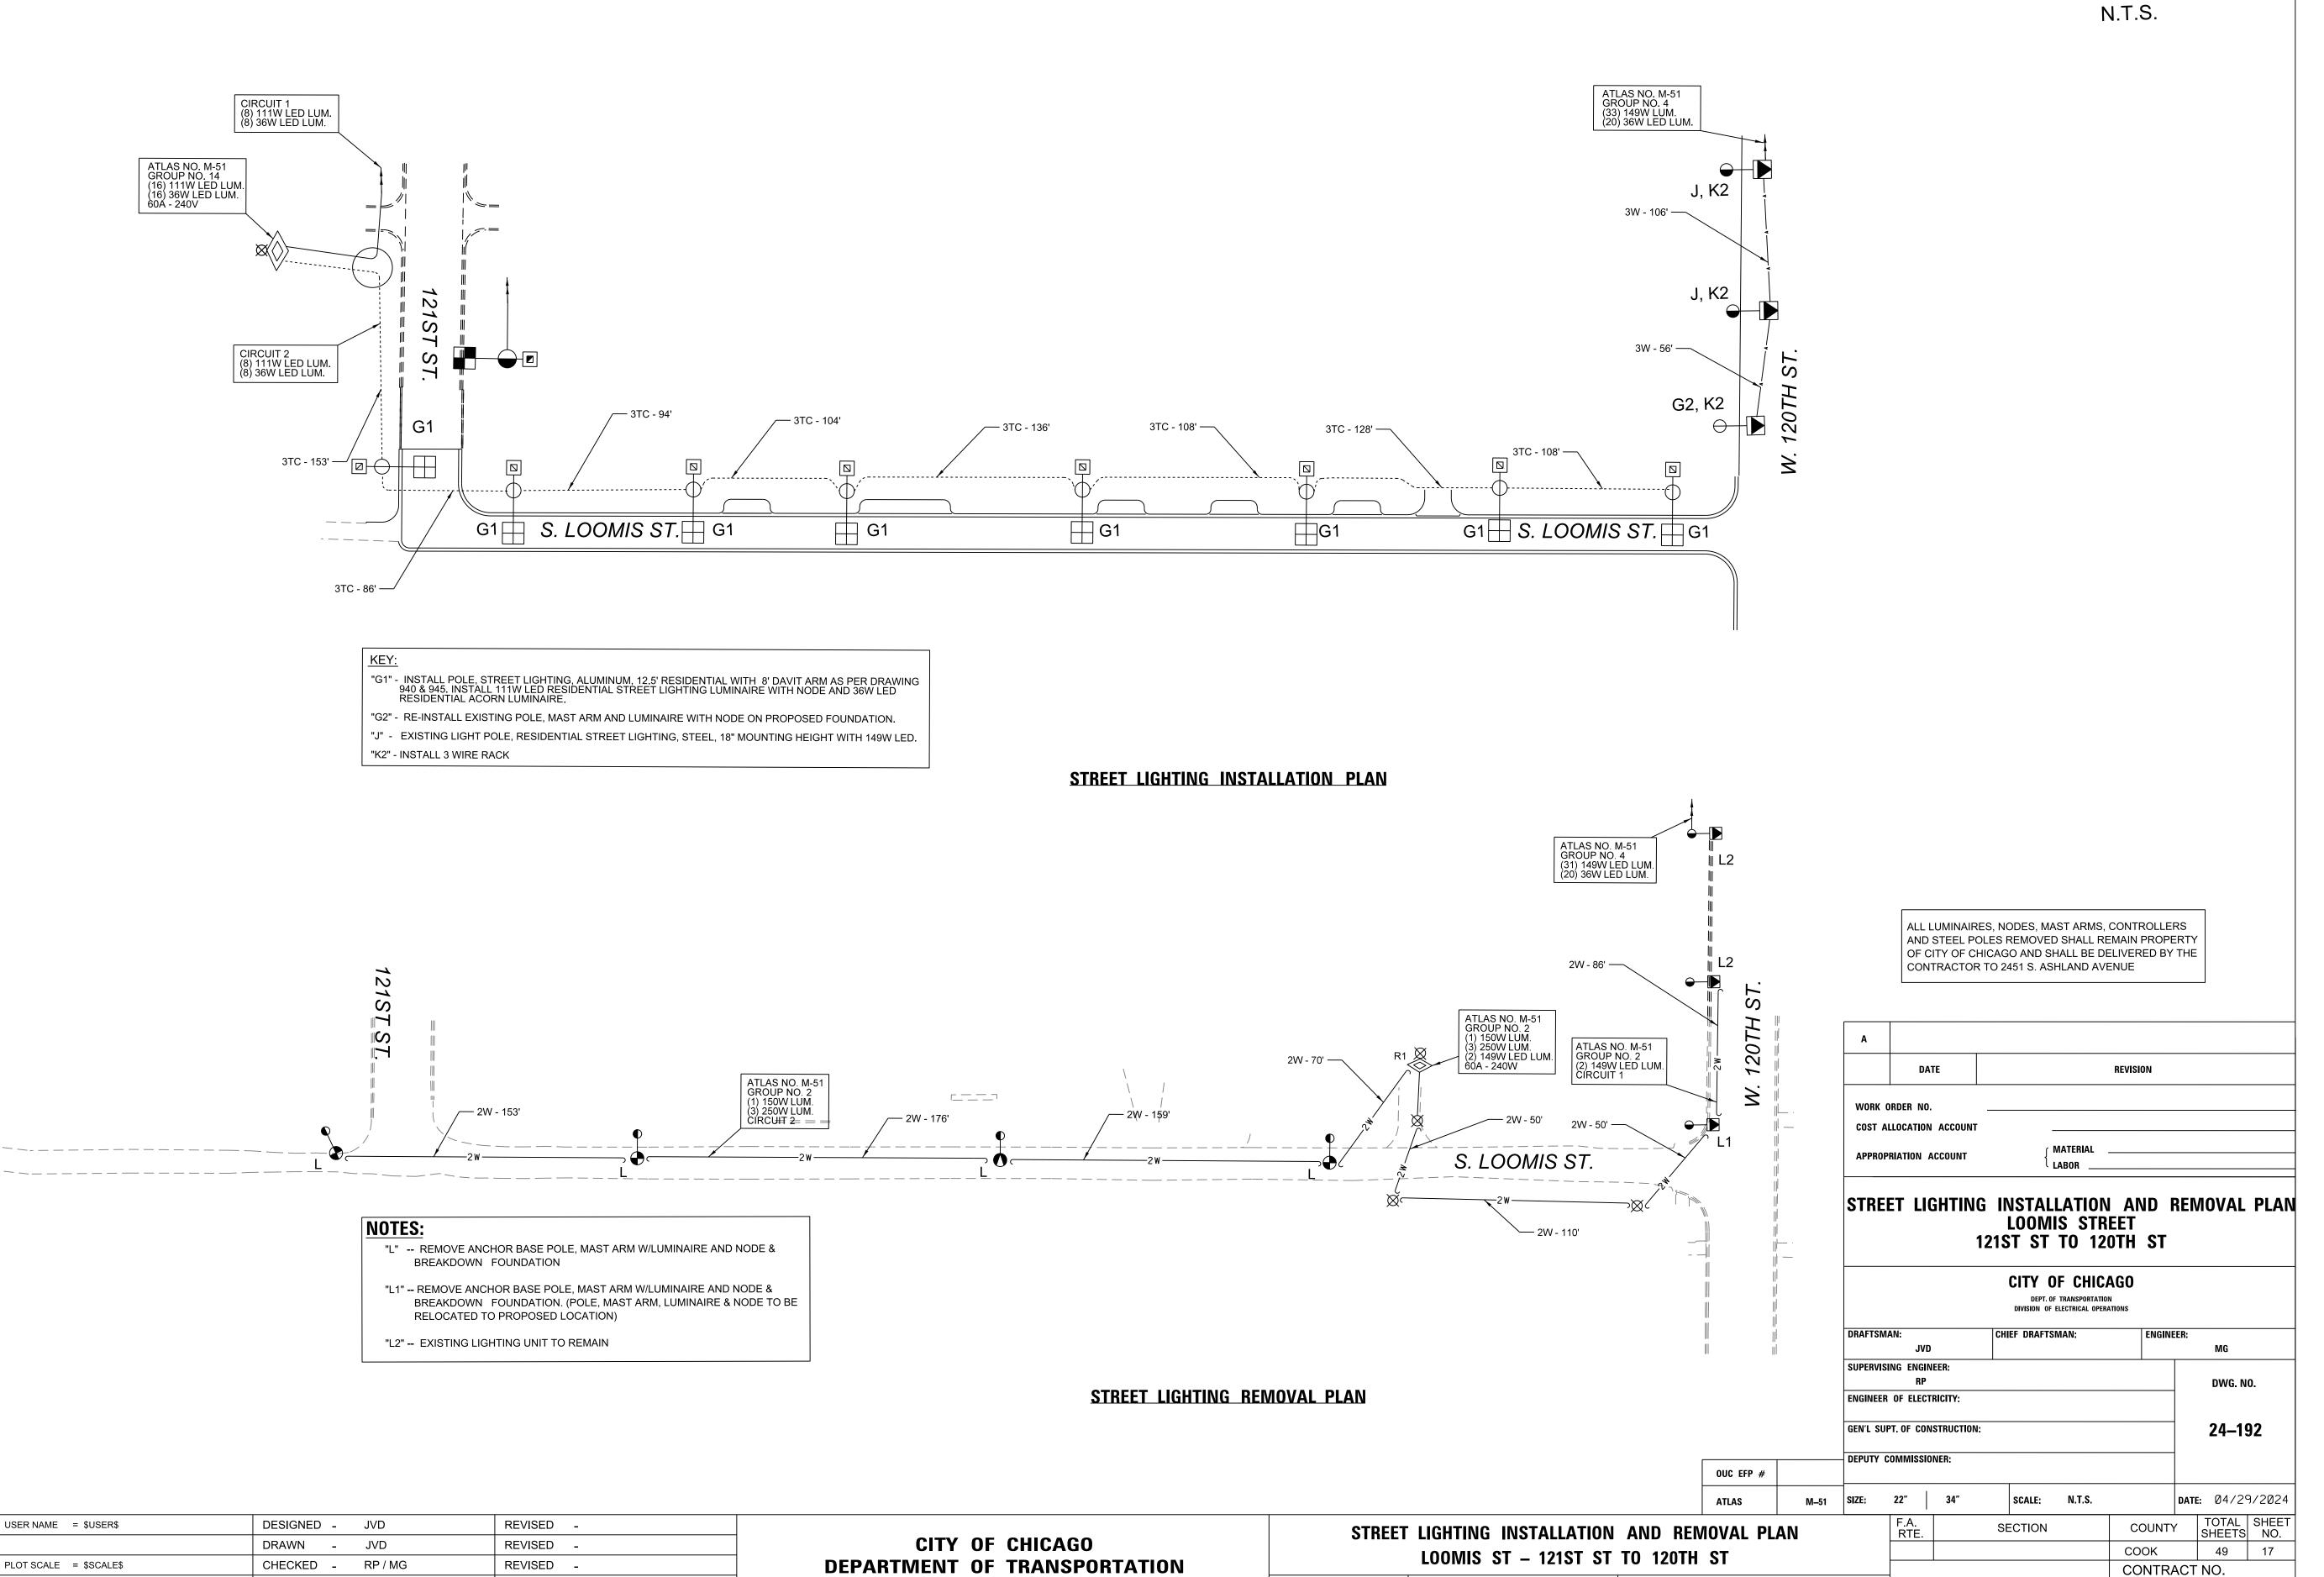SCALE: N.T.S.

SHEET 04

OF 13 SHEETS STA.

TO STA.

ILLINOIS FED. AID PROJECT



PLOT DATE = 16-DEC-2024 08:46

DATE

- 12/05/2024

REVISED -

LOOMIS ST. $10+33 \quad 10+71$ 32 TOP OF PAVEMENT PROP. 2" CONDUIT SCH.#80_ VIA OPEN CUT TRENCH EXIST. 8" WM -TO BE ABANDONED -PROP. 8" WM EXIST. 18" SEWER — -20 -10 **0** 10 20 30 PROPOSED WEST LEG CONDUIT
CROSS SECTION AT THE
INTERSECTION OF LOOMIS ST &
121TH ST
LOOKING WEST

PROFILE A

LOOMIS ST. TOP OF PAVEMENT PROPOSED POLE -24 EXIST. 8" WM -PROP. 2" CONDUIT HDPE 80 OR SCH.#80 VIA HAND DIG OPEN CUT AND DIRECTIONAL BORING EXIST. 24" SEWER -20 -10 **0** 10 20 30 PROPOSED WEST PARKWAY
CONDUIT CROSS SECTION AT S.
LOOMIS ST. BETWEEN W. 120TH
ST. & W. 121ST ST. (TYP.)
LOOKING SOUTH

PROFILE B






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		DRAV
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PLOT DATE	= 16-DEC-2024 09:00	DATE

USER NAME = \$USER\$	DESIGNED - JVD	REVISED -
	DRAWN - JVD	REVISED -
PLOT SCALE = \$SCALE\$	CHECKED - RP / MG	REVISED -
PLOT DATE = 16-DEC-2024 09:00	DATE - 12/05/2024	REVISED -

CITY	OF	CHICAGO	
DEPARTMENT	OF	TRANSPORTATION	

	DDODOCED CONDUIT DDOELLE							SECTION	COUNTY	TOTAL SHEETS	SHEET NO.
ı	PROPOSED CONDUIT PROFILE							COOK	49	18	
ŀ		<u> </u>							CONTRACT	ΓNO.	
	SCALE:	SHEET 05	OF 13	SHEETS	STA.	TO STA.		ILLINOIS F	ED. AID PROJECT		



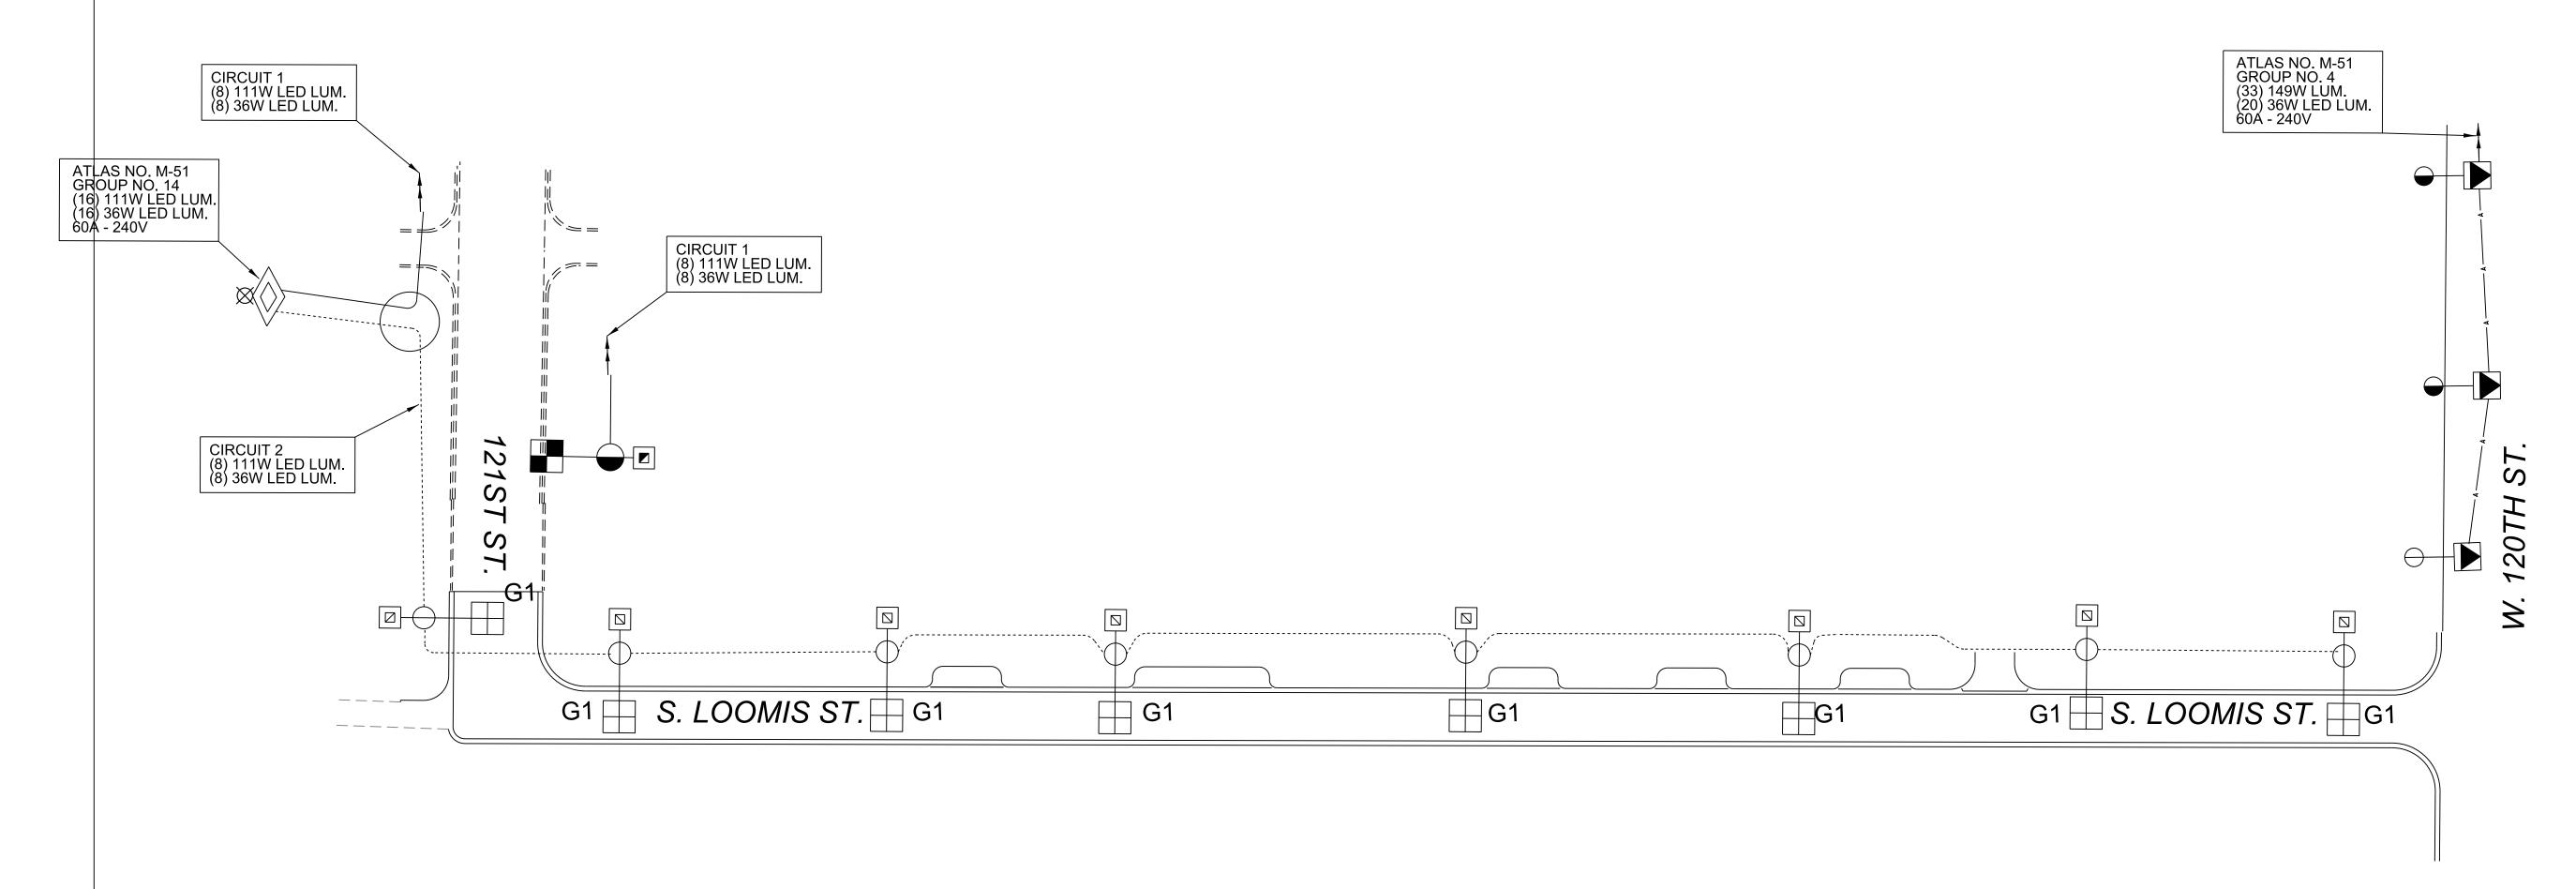







	• OF CHICAGO
	WIELD BUILDING COMMISSION
Т	COMIN
L	ED I


:	PLOT DATE = 16-DEC-2024 08:47	DATE - 12/05/2	024 REVISED	-
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		DRAWN - JVD	REVISED	-
	USER NAME = \$USER\$	DESIGNED - JVD	REVISED	-


SCALE: N.T.S.

OUC EFP #

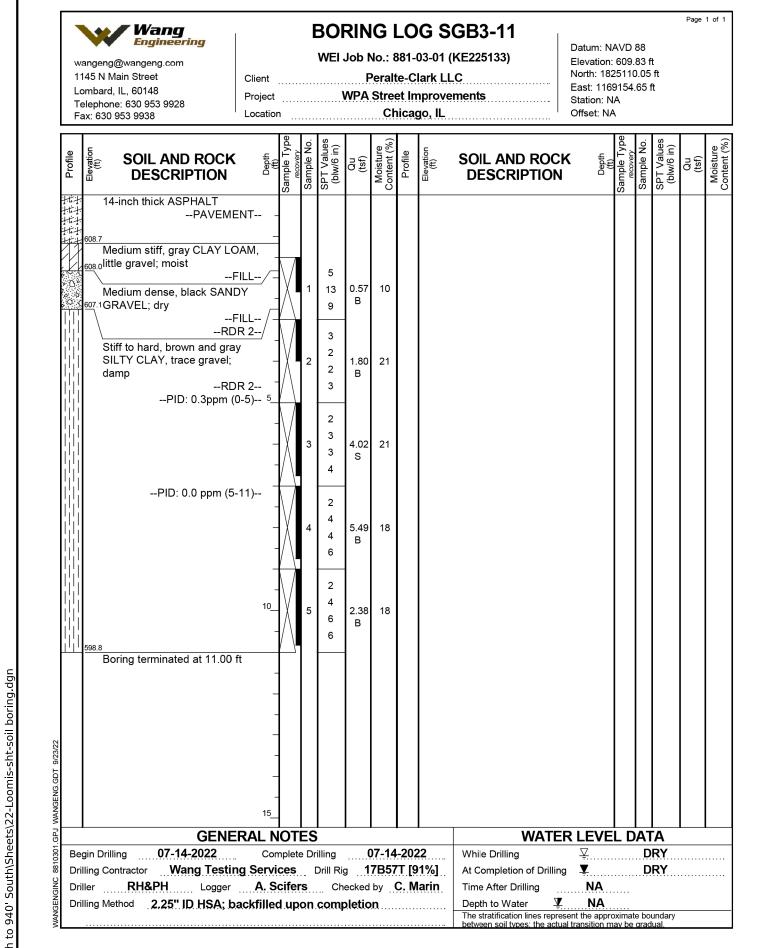

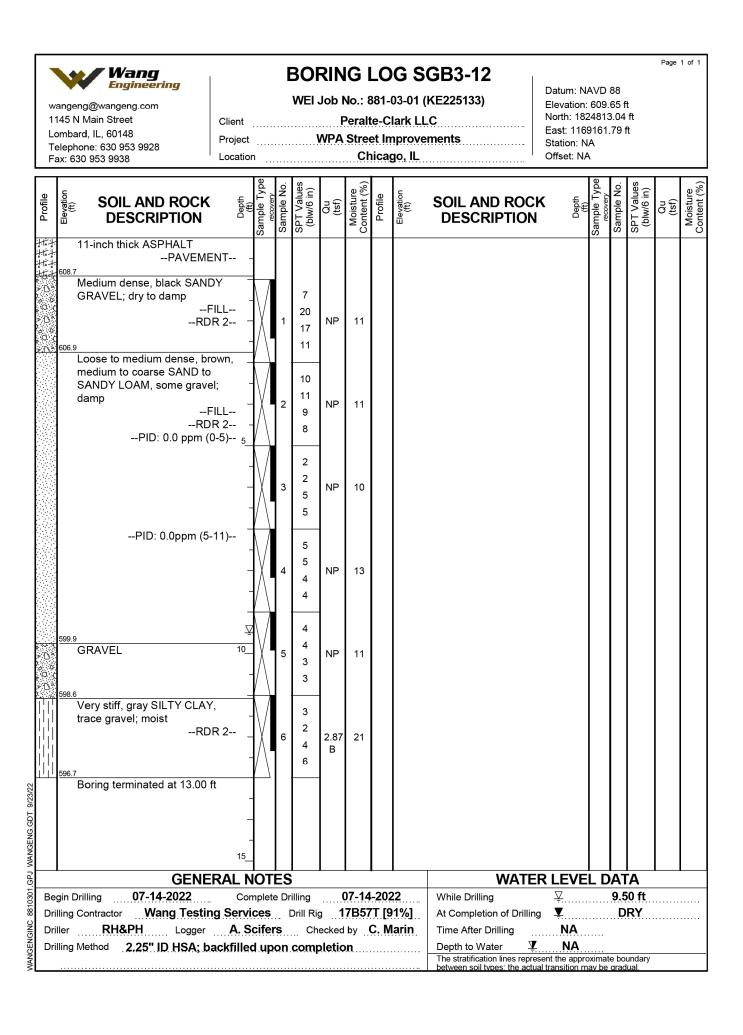


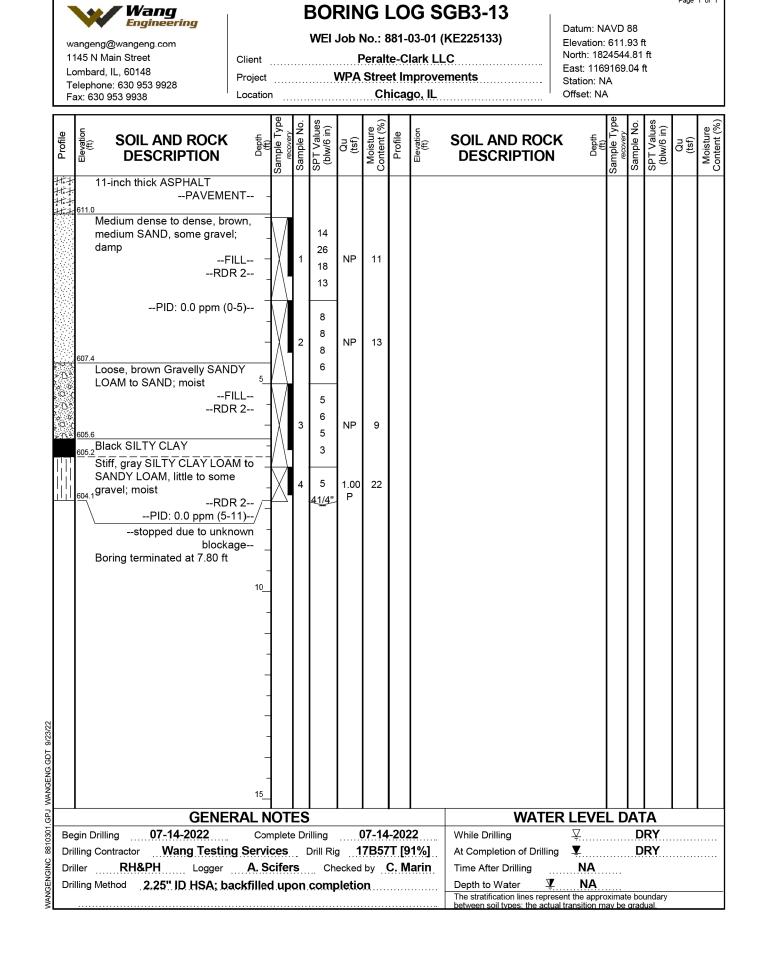


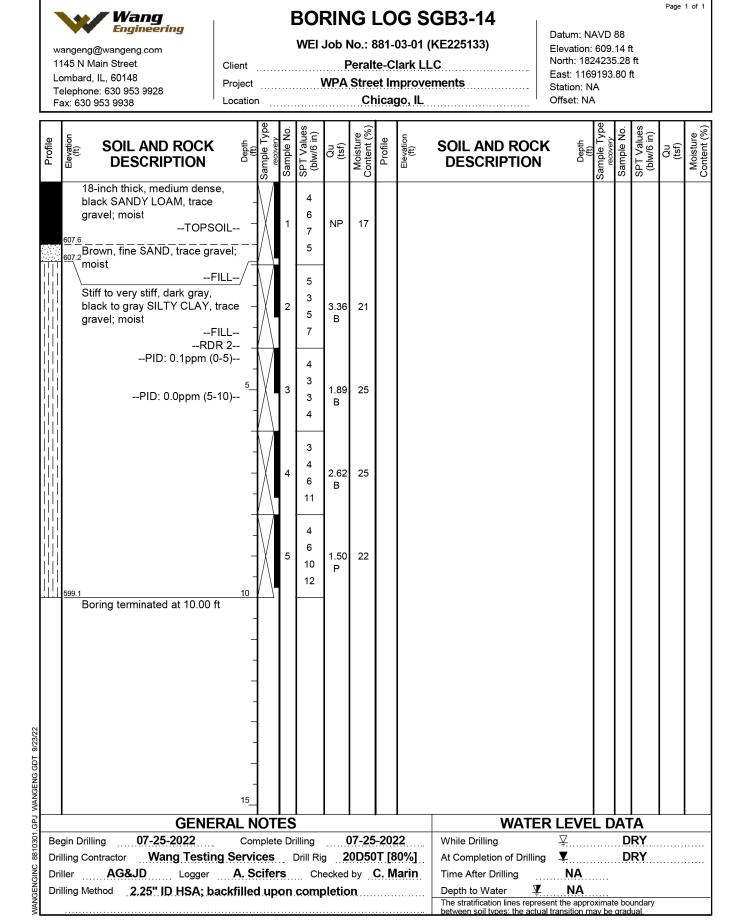




CHICAGO	USER NAME = mike.thon	DESIGNED -	REVISED -
		DRAWN -	REVISED -
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	PLOT DATE = 12/13/2024	DATE - 12/13/2024	ISSUED FOR BID - 12/17/2024

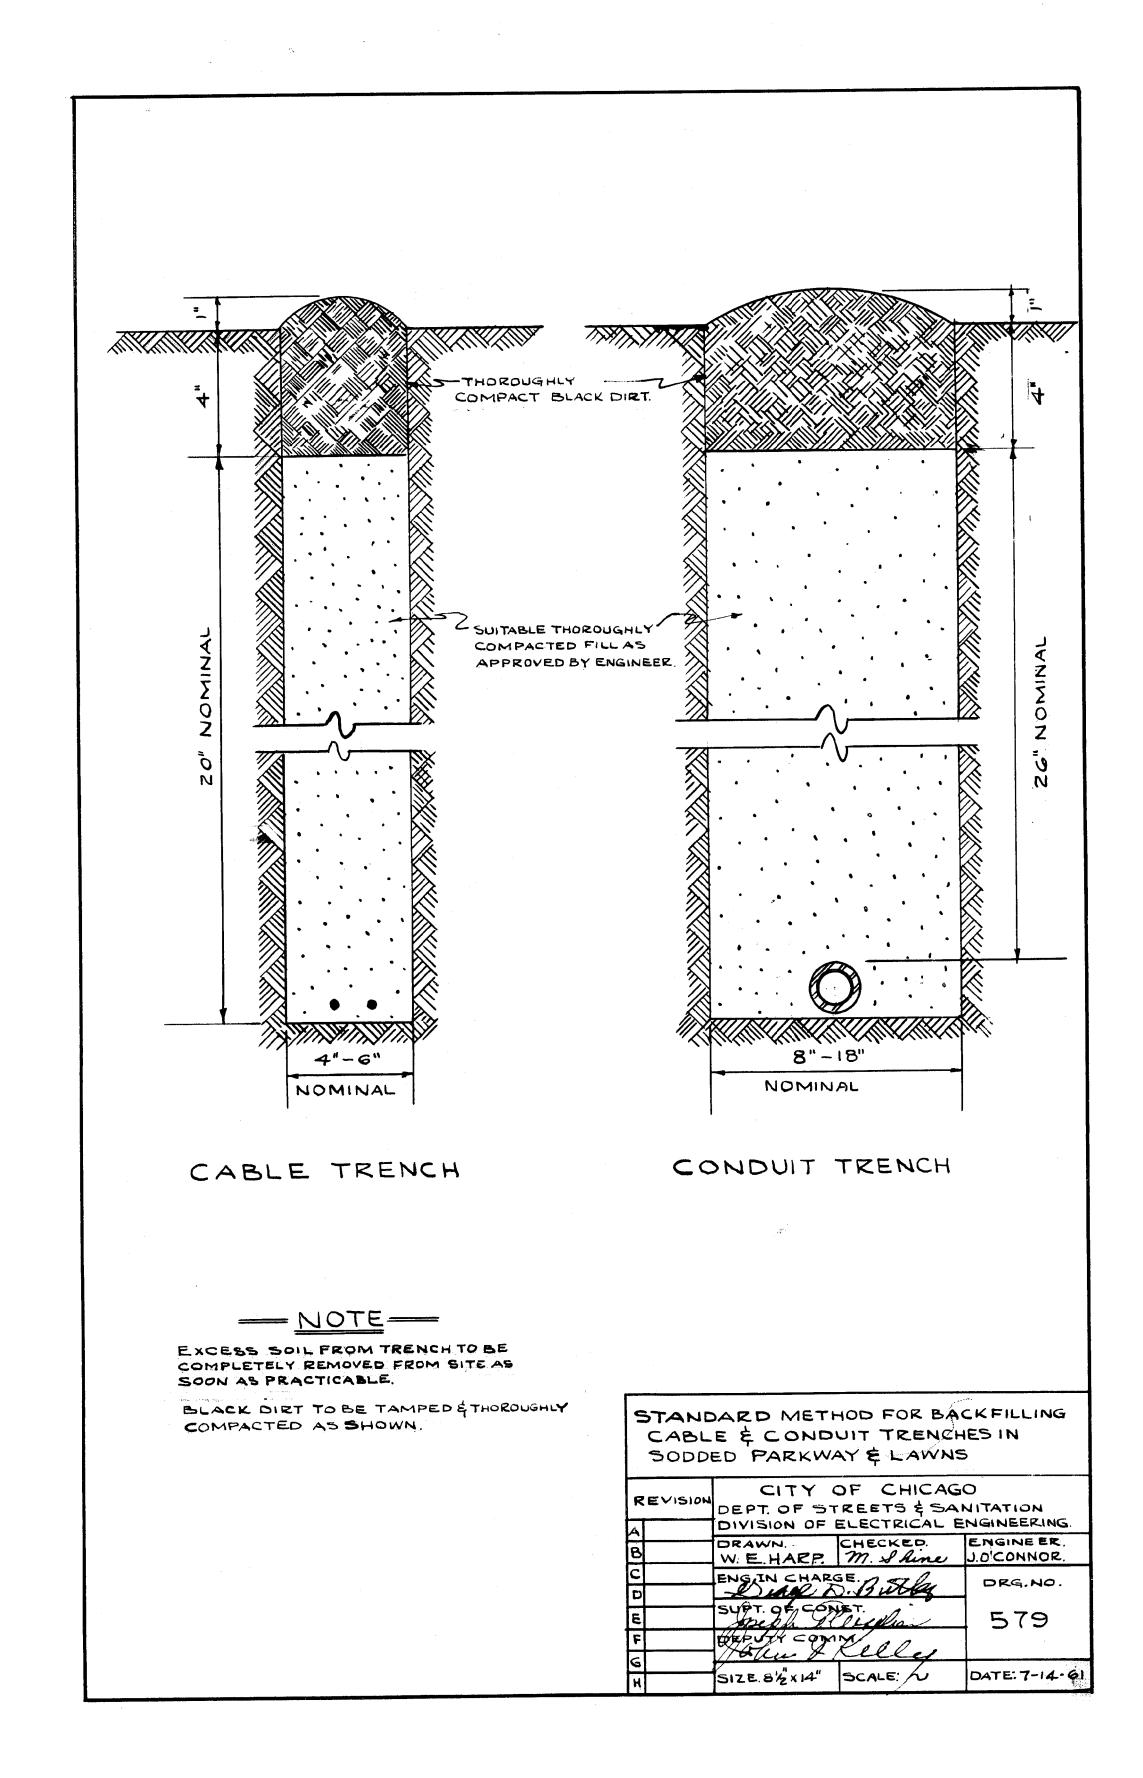

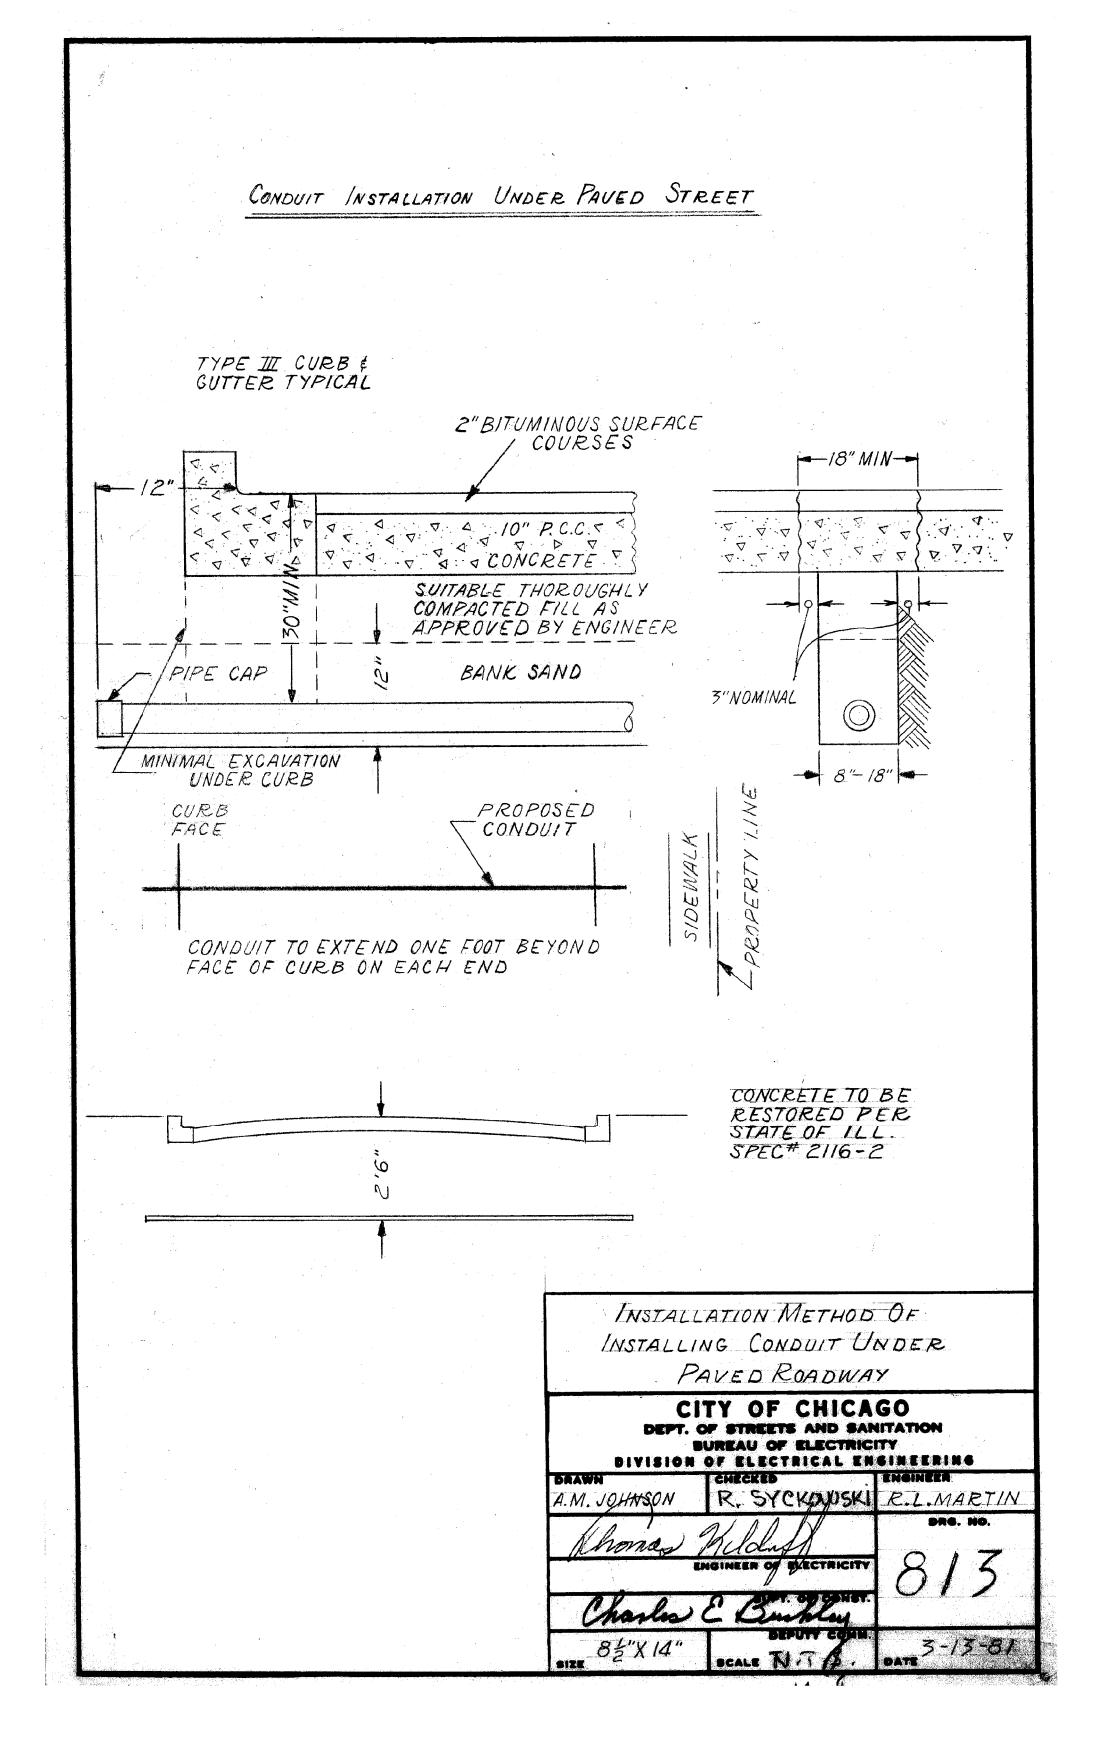







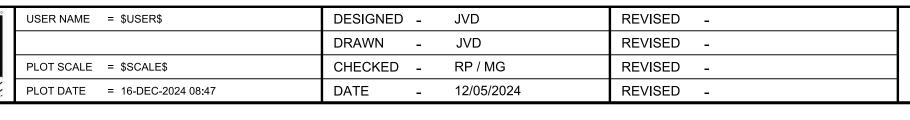

CITY OF CHICAGO
DEPARTMENT OF TRANSPORTATION

		CDOT ELEC	TRICAL		F.A. RTE.	SECTION		COUNTY	TOTAL SHEETS	SHEE NO.
STANDARD DETAILS							COOK	49	21	
		OTANDAND	DEIAILO					CONTRACT	NO.	
	SHEET 07	OF 13 SHE	ETS STA.	TO STA.		ILLINOIS	FED. All	O PROJECT		

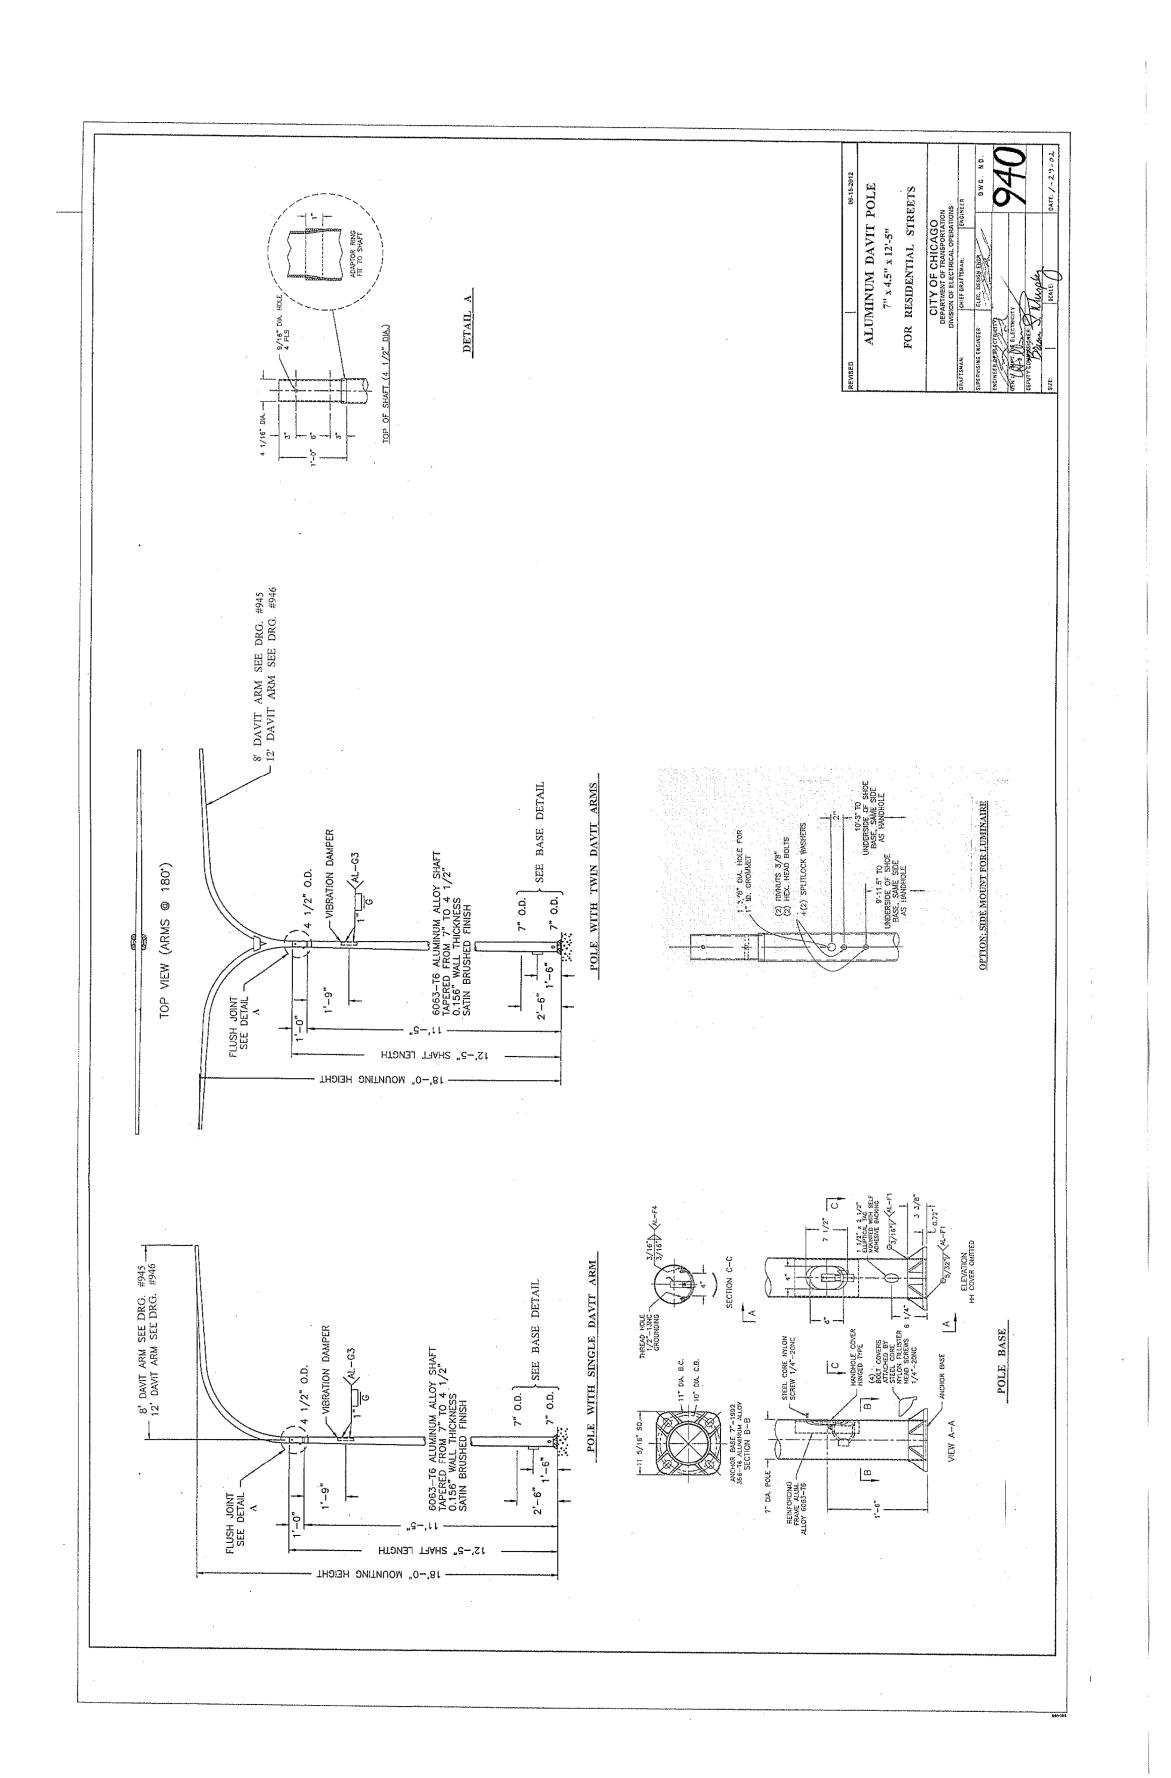

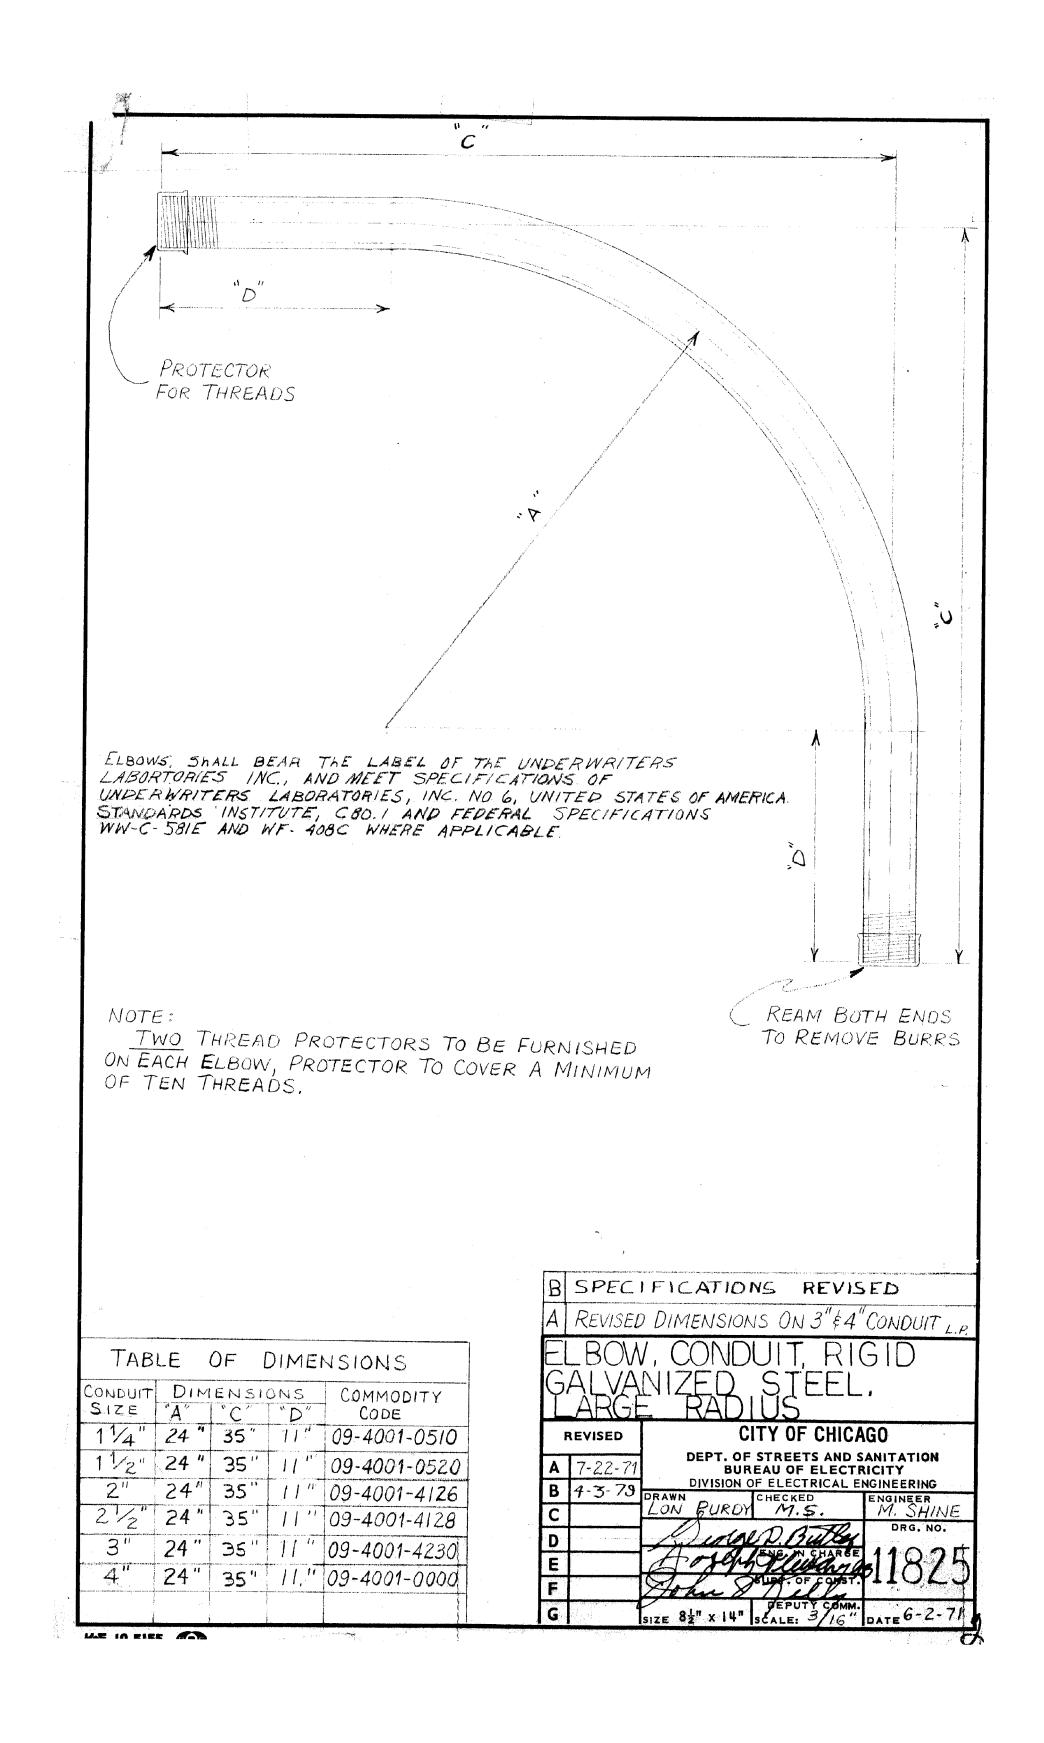


CHICAGO CHICAG


PUBLIC BUILDING COMMISSION


GO	USER NAME = \$USER\$	DESIGNED -	=	JVD	REVISED	-
		DRAWN -	-	JVD	REVISED	-
	PLOT SCALE = \$SCALE\$	CHECKED -	-	RP / MG	REVISED	-
/.	PLOT DATE = 16-DEC-2024 08:47	DATE -	-	12/05/2024	REVISED	-

CITY	OF	CHICAGO
DEPARTMENT	OF	TRANSPORTATION

CDOT ELECTRICAL STANDARD DETAILS								SECTION		COUNTY	TOTAL SHEETS	SHEET NO.
										соок	49	22
										CONTRAC	ΓNO.	
	SHEET 08	OF	13	SHEETS	STA.	TO STA.		ILLINOIS FED. AID PROJECT				

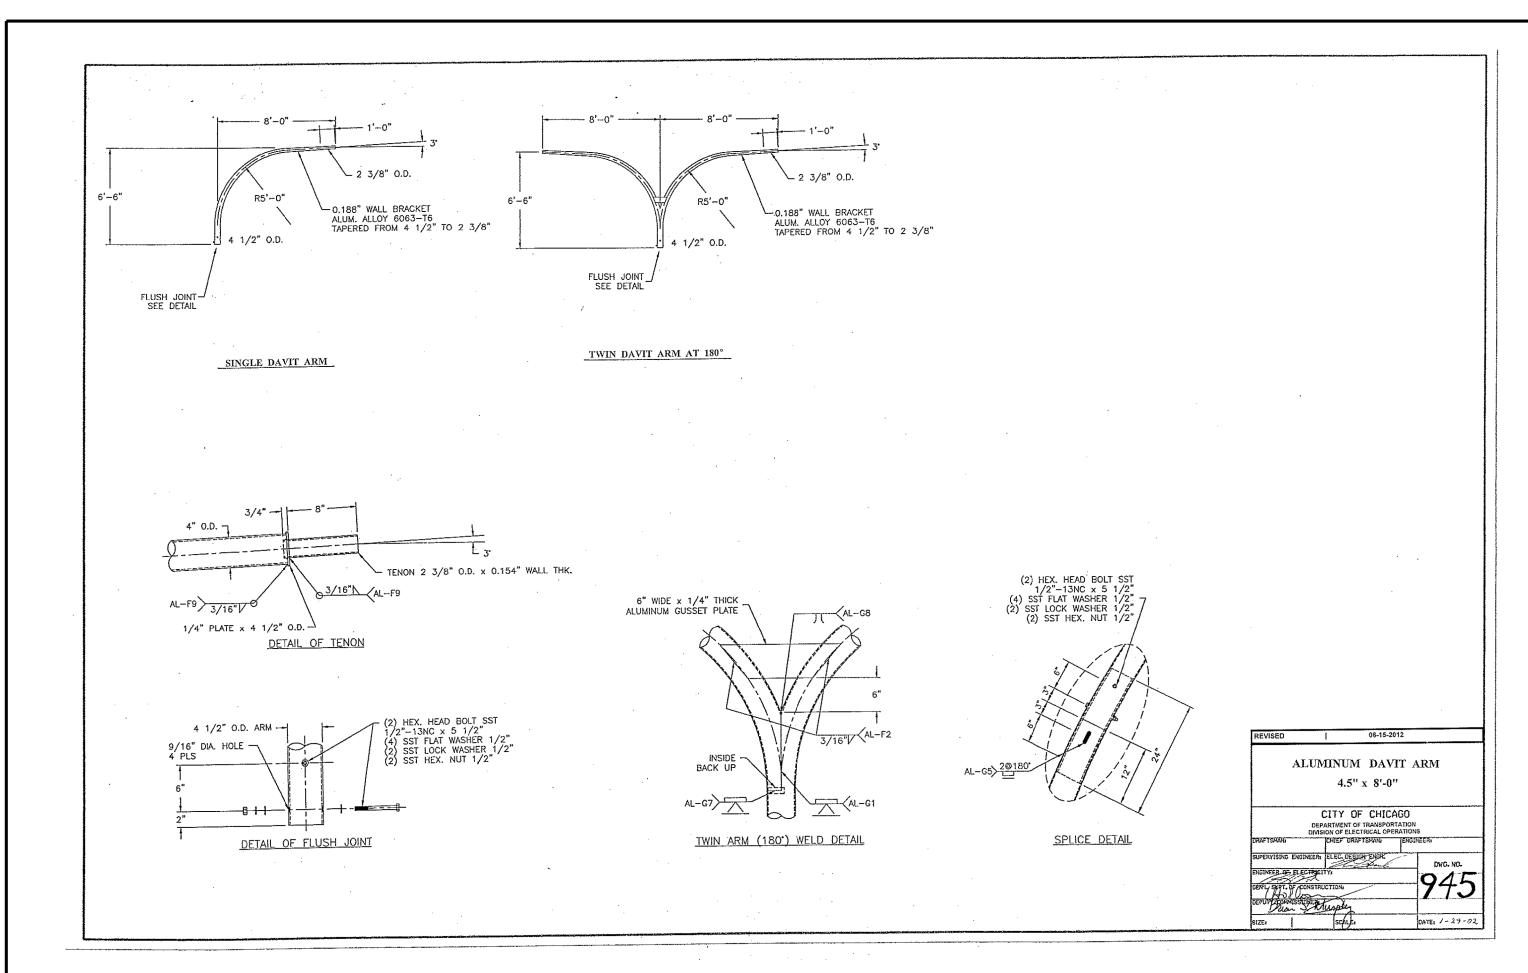

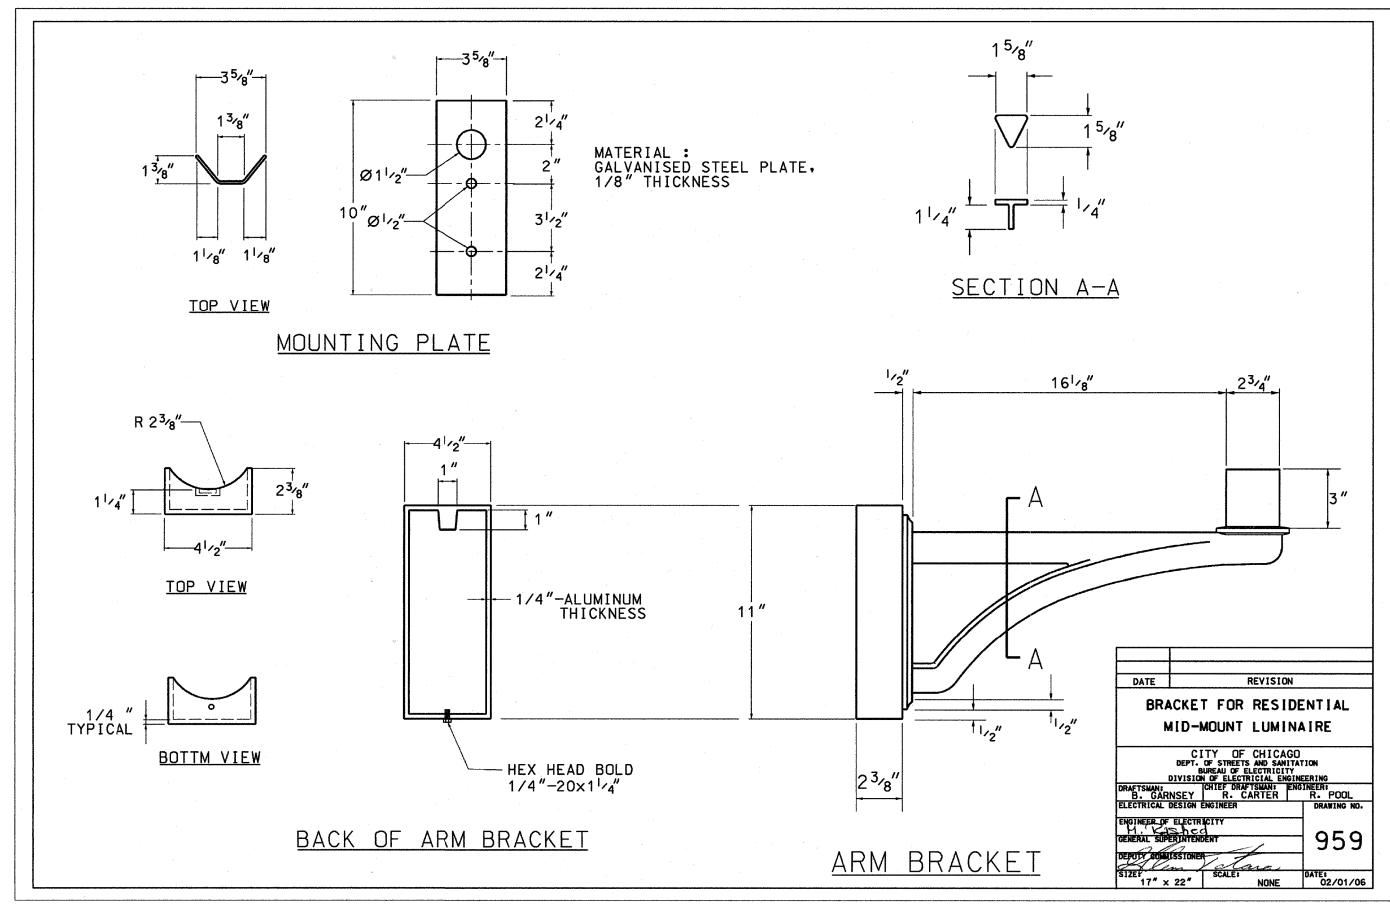

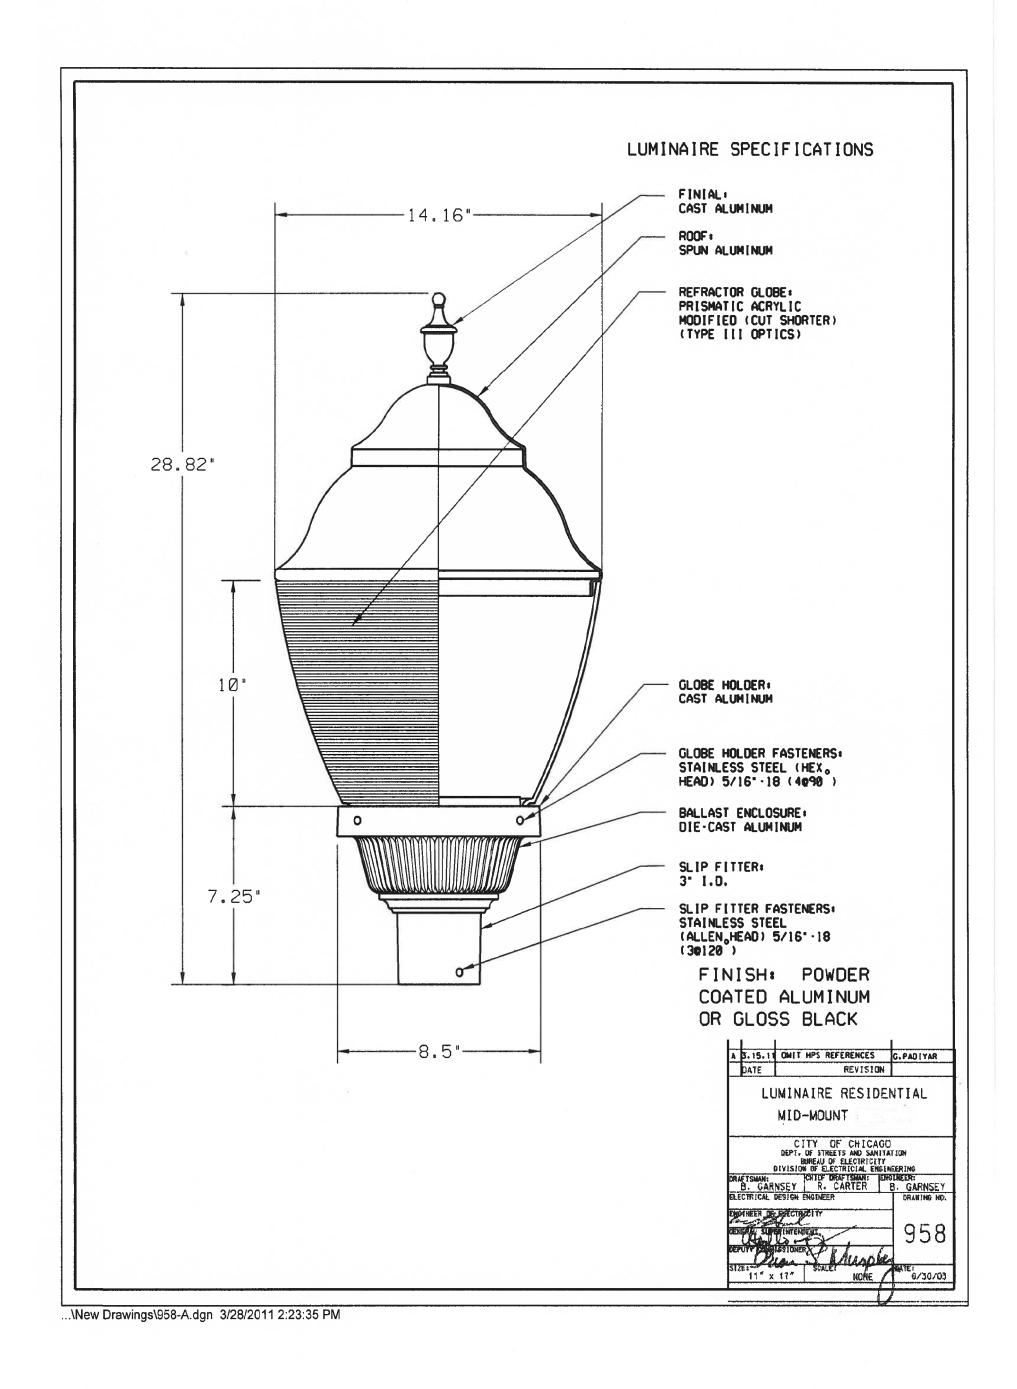



G O	USER NAME = \$USER\$	DESIGNED	-	JVD	REVISED -
		DRAWN	-	JVD	REVISED -
	PLOT SCALE = \$SCALE\$	CHECKED	-	RP / MG	REVISED -
/.	PLOT DATE = 16-DEC-2024 08:47	DATE	-	12/05/2024	REVISED -

CITY OF CHICAGO
DEPARTMENT OF TRANSPORTATION


SCALE:

SHEET 09

CDOT ELECTRICAL				F.A. RTE.	SEC ⁻	TION		COUNTY	TOTAL SHEETS	SHEI NO
STANDARD DETAILS								COOK	49	23
								CONTRACT	NO.	
OF 13	SHEETS	STA.	TO STA.	ILLINOIS FED. AID PROJECT						





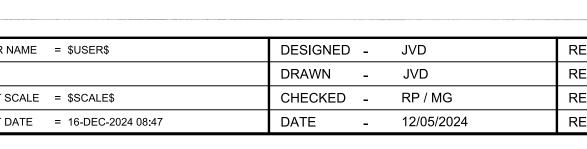

USER NAME = \$USER\$ REVISED -REVISED -PLOT SCALE = \$SCALE\$ REVISED -PLOT DATE = 16-DEC-2024 08:47 REVISED -

CONSTRUCTION NOTES:


1. 8" BED OF STONE FOR DRAINAGE.

2. ALL METALLIC CONDUITS ENTERING HANDHOLE SHALL EXTEND MINIMUM 1" & MAXIMUM 3" INSIDE INNER WALL AND BE EQUIPPED WITH AN APPROVED TYPE OF THREADED GROUNDING BUSHING. A Ver ri WINIMUM 30"

DIA. HANDHOLE

CONCRETE

98

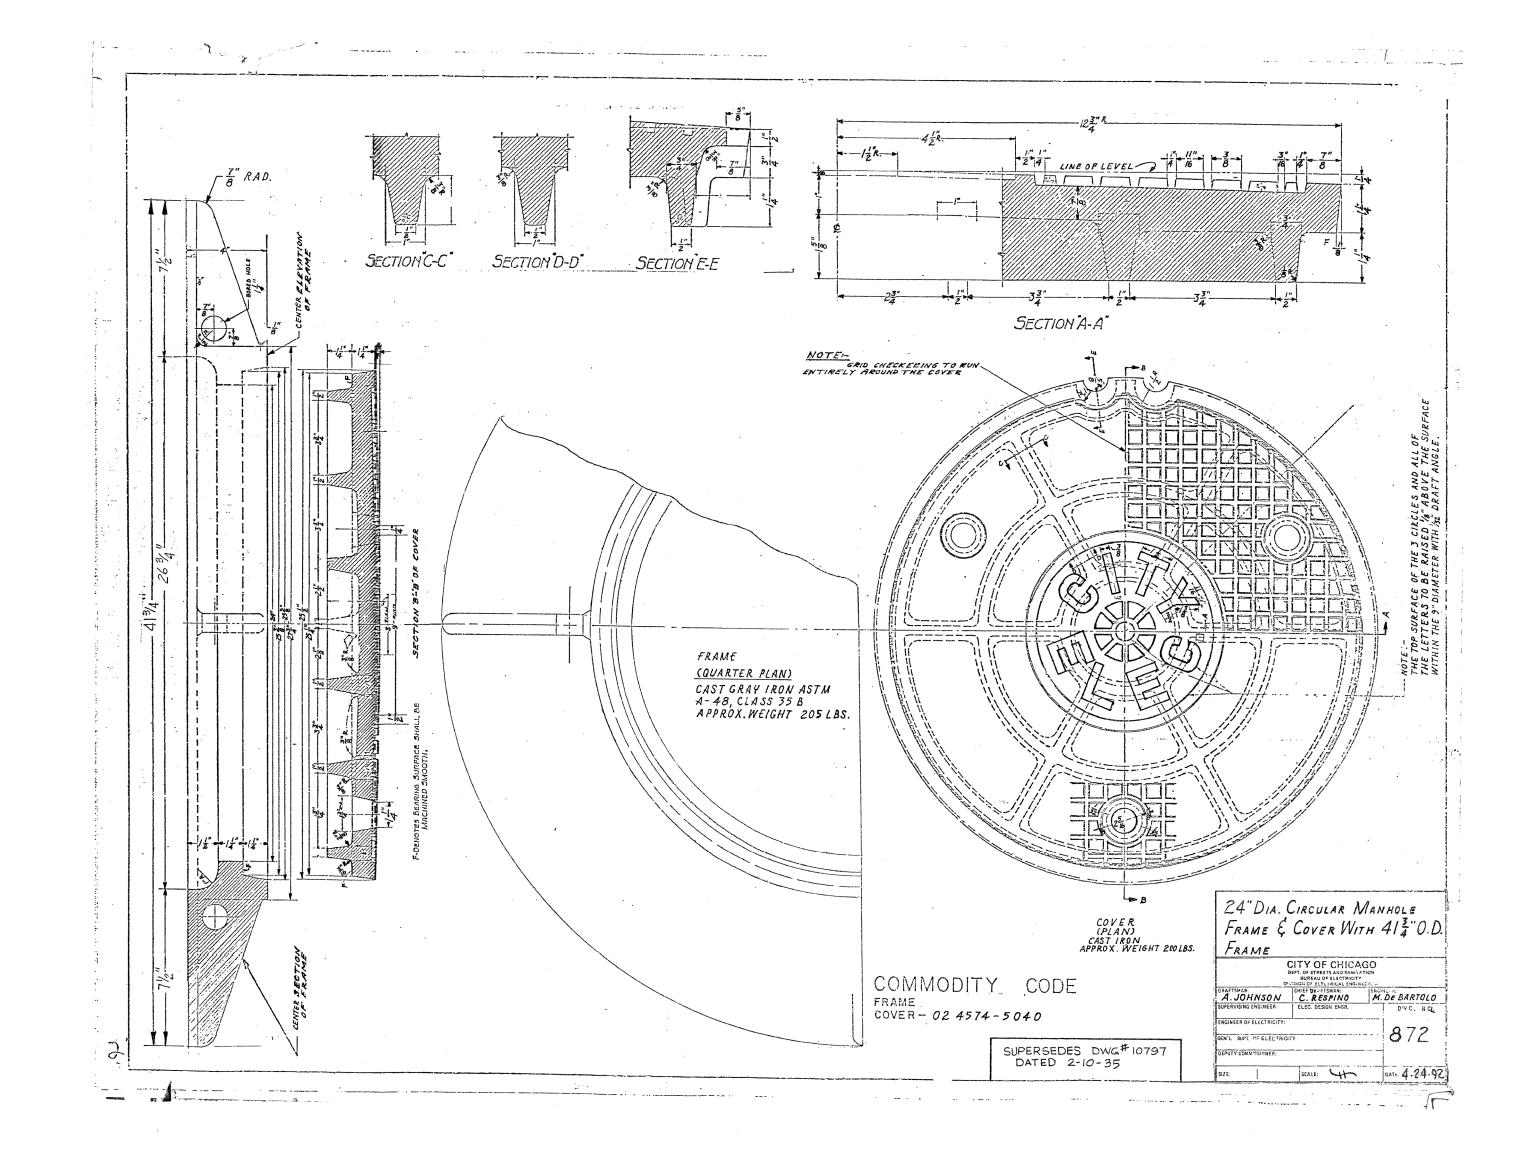

CITY OF CHICAGO **DEPARTMENT OF TRANSPORTATION**


CDOT ELECTRICAL STANDARD DETAILS


SCALE:

SHEET 10 OF 13 SHEETS STA.

TO STA.


SECTION 49 24 COOK CONTRACT NO. ILLINOIS FED. AID PROJECT

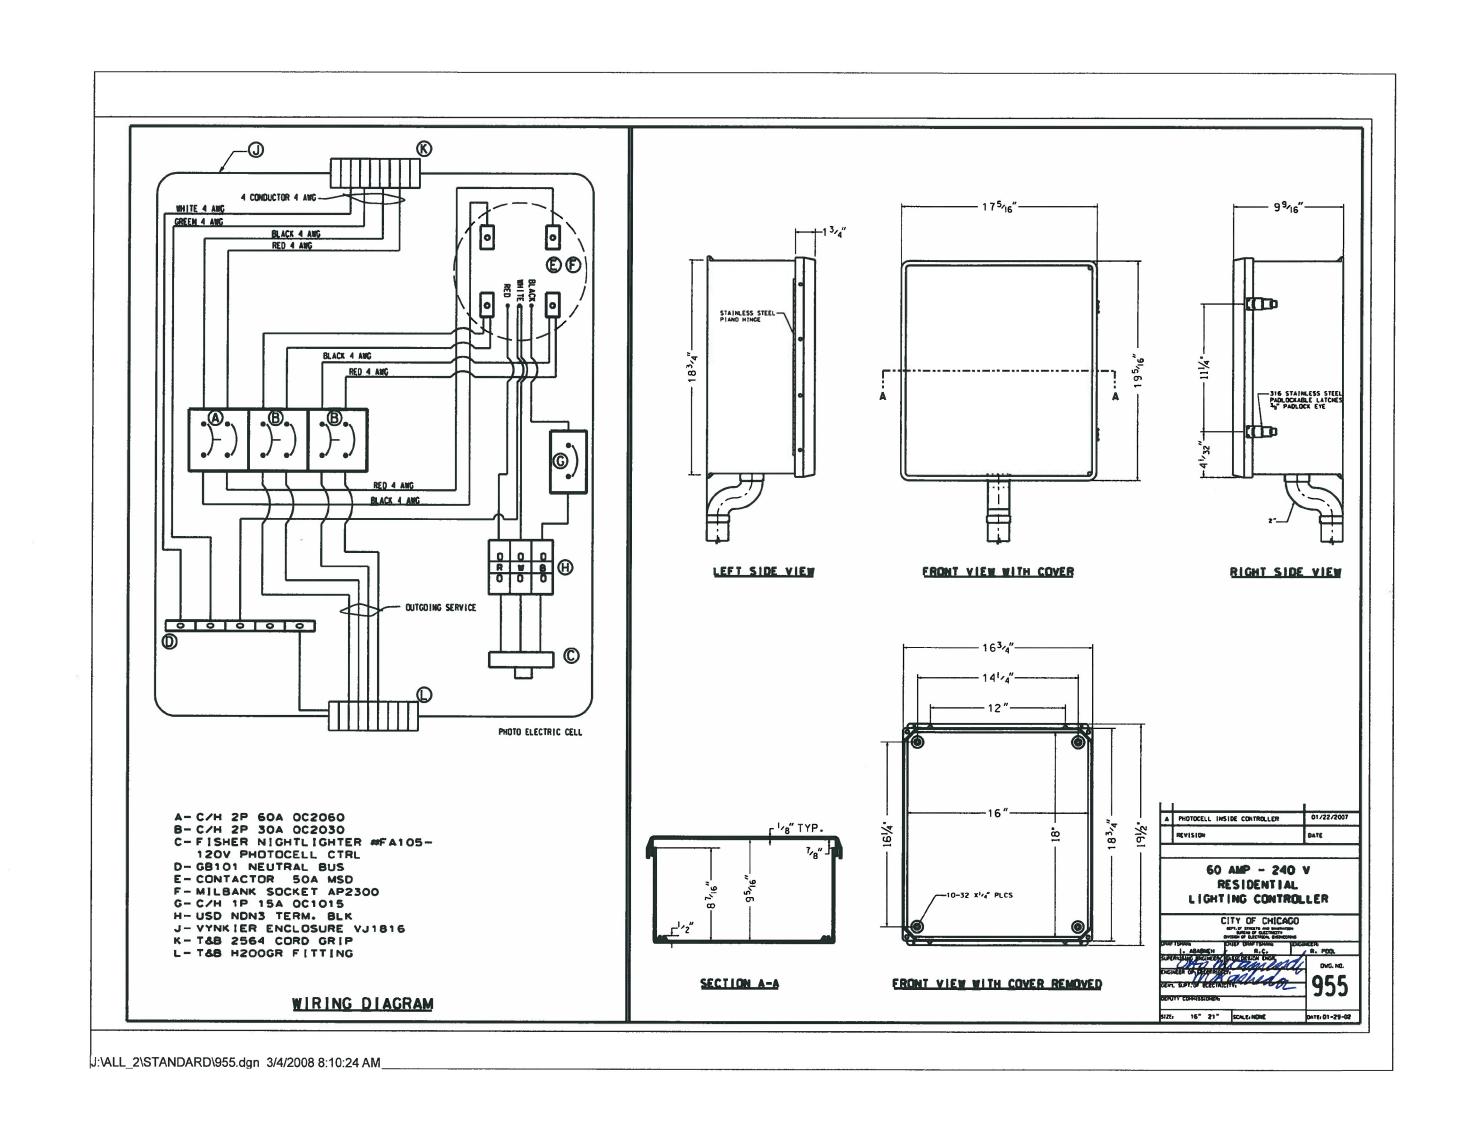

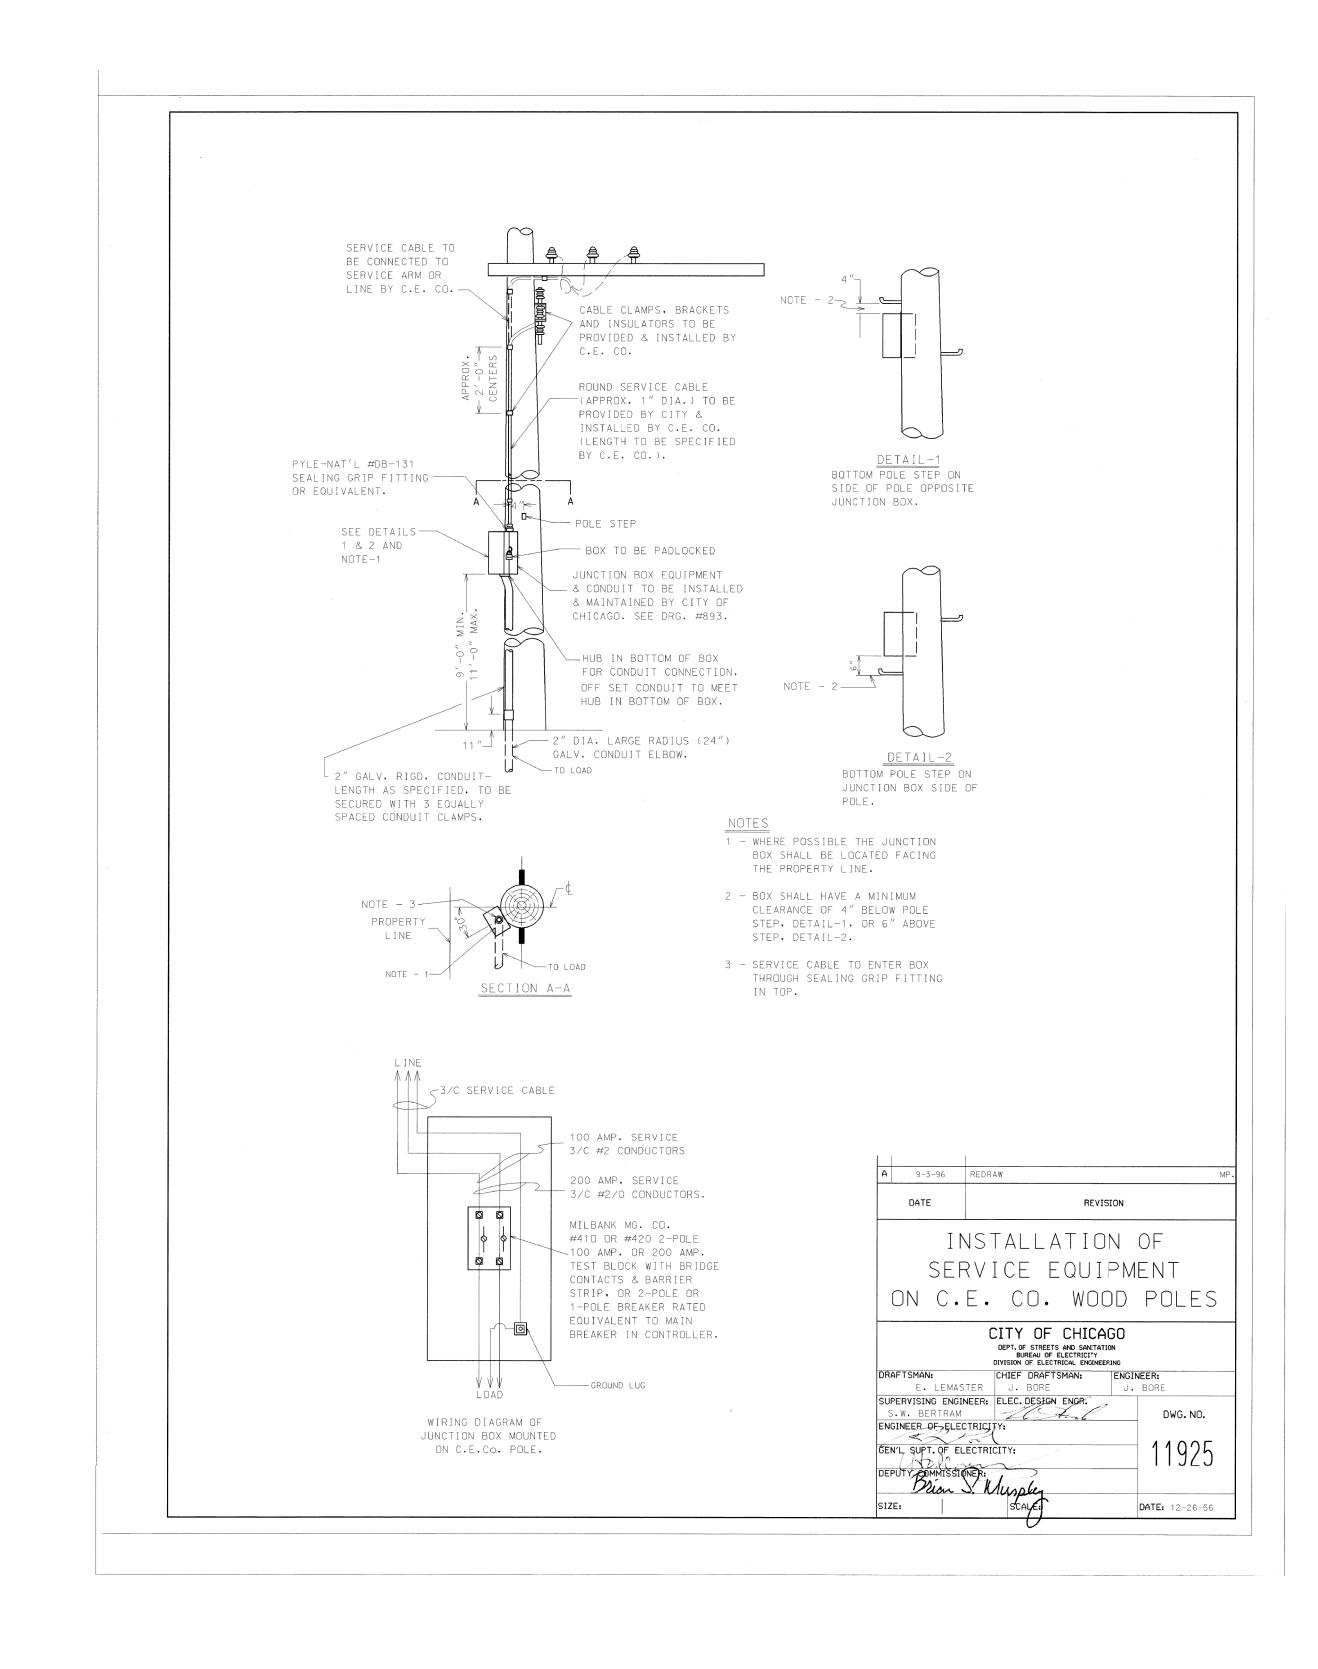





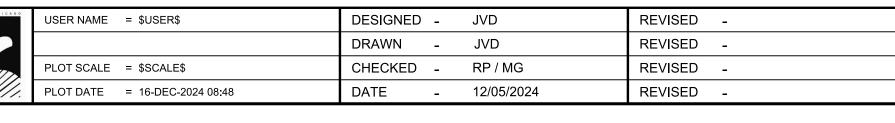

CITY OF CHICAGO
DEPARTMENT OF TRANSPORTATION

SCALE:

 CDOT ELECTRICAL

 STANDARD DETAILS
 F.A. RTE.
 SECTION
 COUNTY
 TOTAL SHEETS NO.

 SHEET 11
 OF 13
 SHEETS STA.
 TO STA.
 ILLINOIS FED. AID PROJECT



-1 1/8 " DIA.

-778 " DIA. HOLES * 3 HOLES 120°APART (3⁄4 " A.R.)

BASE PLATE 5 FOOT FOUNDATION 10" BOLT CIRCLE

BASE PLATE 5 FOOT FOUNDATION 13" BOLT CIRCLE

,, 9- , l

,, 9- , 7

"9- , l

HOLES IN BASE PLATE MAY BE RADIALLY SLOTTED













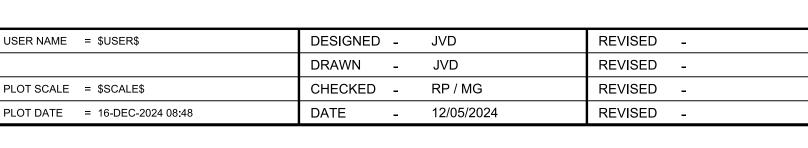

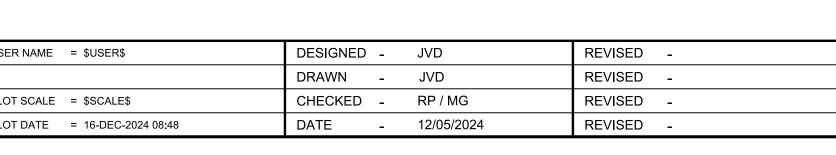



936

1. SHAFT MUST HAVE 1/4 " WALL AND HAVE 8 5/8 "OUTSIDE DIAMETER.

2. SHAFT MATERIAL MUST BE ASTM A53B STEEL PIPE OR LATEST REVISION.

3. HELIX MUST BE FORMED BY MATCHING METAL DIE.

4. HELIX MUST HAVE 3 INCH PITCH.

5. HELIX MUST HAVE 3 INCH PITCH.

6. PILOT POINT MATERIAL WILL BE ASTM A36 STEEL OR LATEST REVISION.

7. BASE PLATE MATERIAL WILL BE ASTM A36 STEEL.


8. ENTIRE STEEL FOUNDATION TO BE HOT DIP GALVANIZED PER ASTM A123

9. BASE PLATE MUST BE PERMANENTLY STAMPED WITH MANUFACTURER'S

NAME, MANUFACTURING DATE, AND PRODUCT IDENTIFICATION.

10. BASE PLATE MUST BE PERMANENTLY MARKED ON TOP INDICATING

CONDUIT OPENING ORIENTATION.

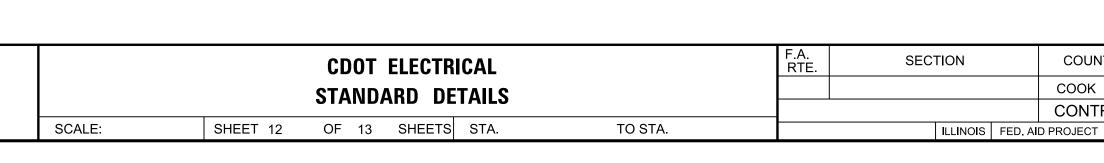



TOTAL SHEET NO.

49 26

COOK


CONTRACT NO.

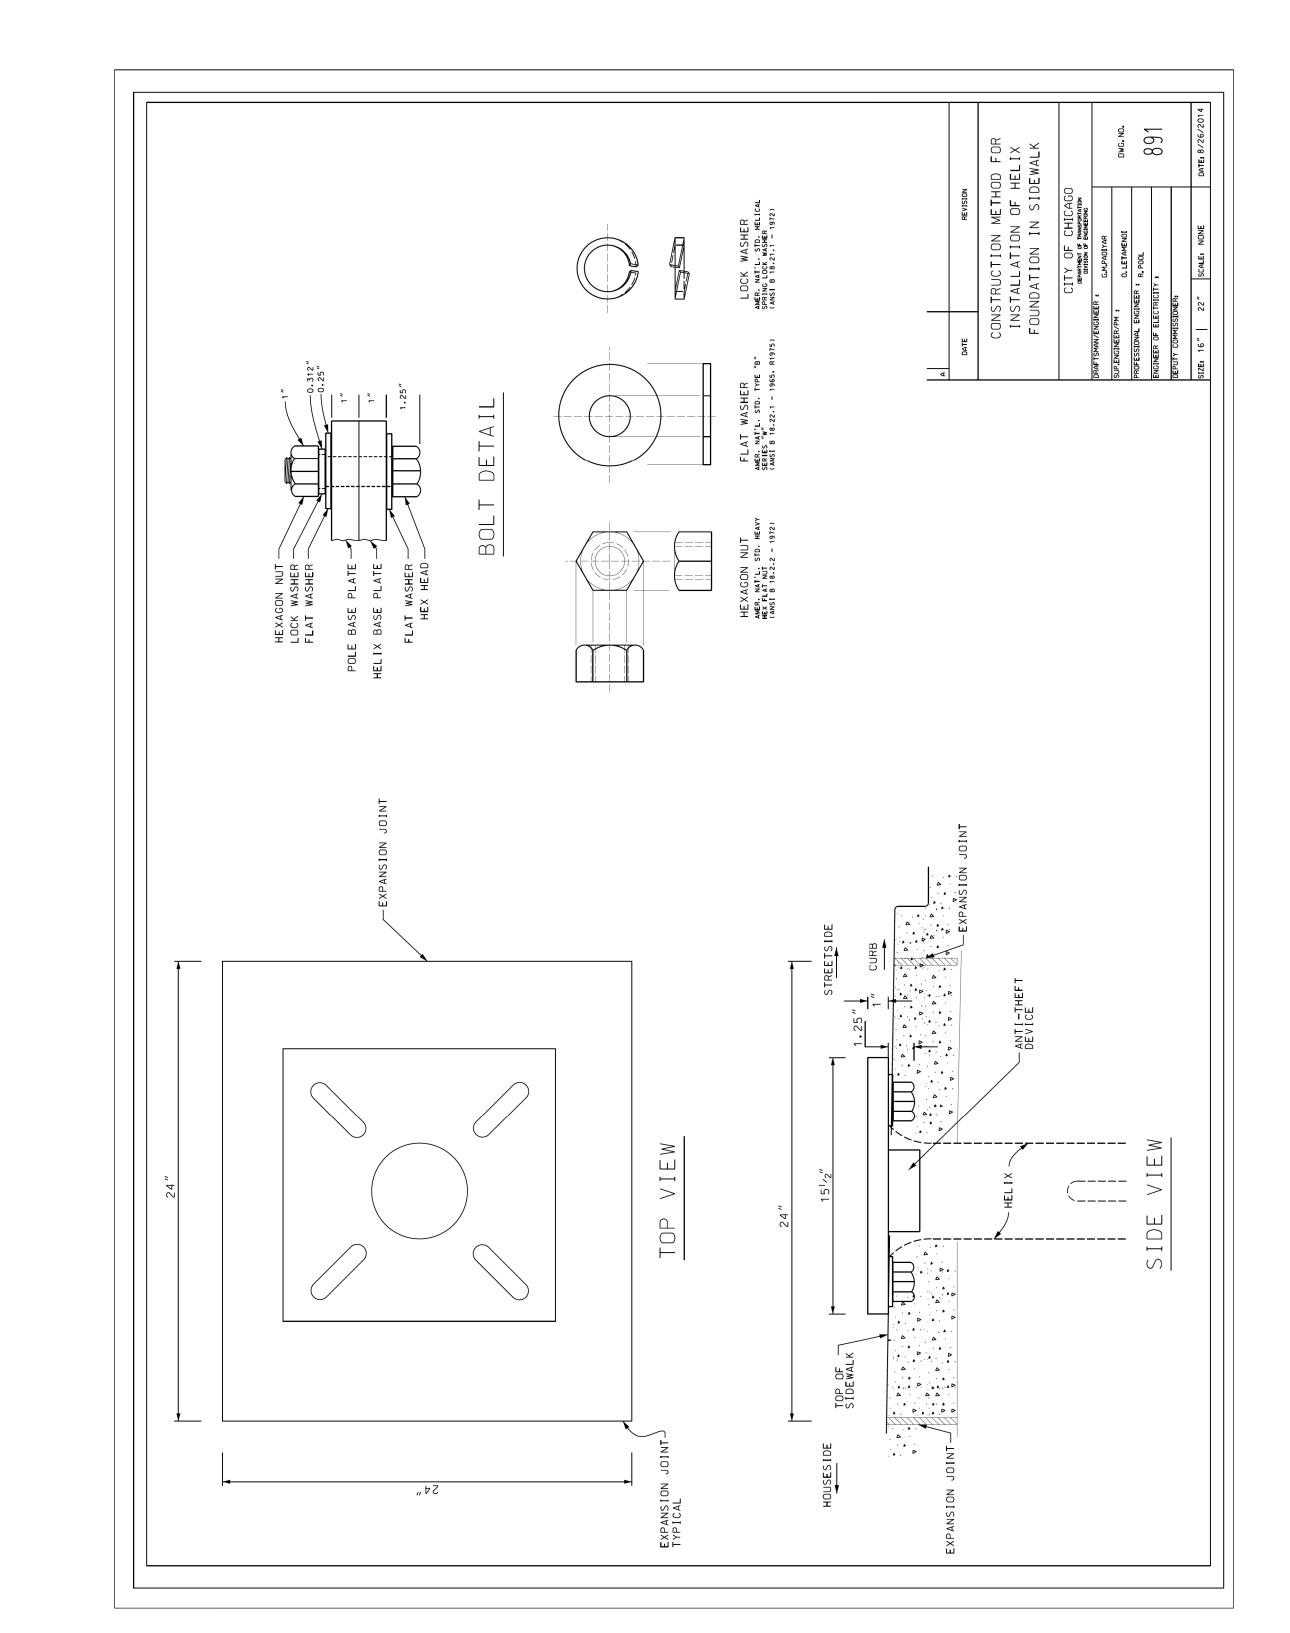

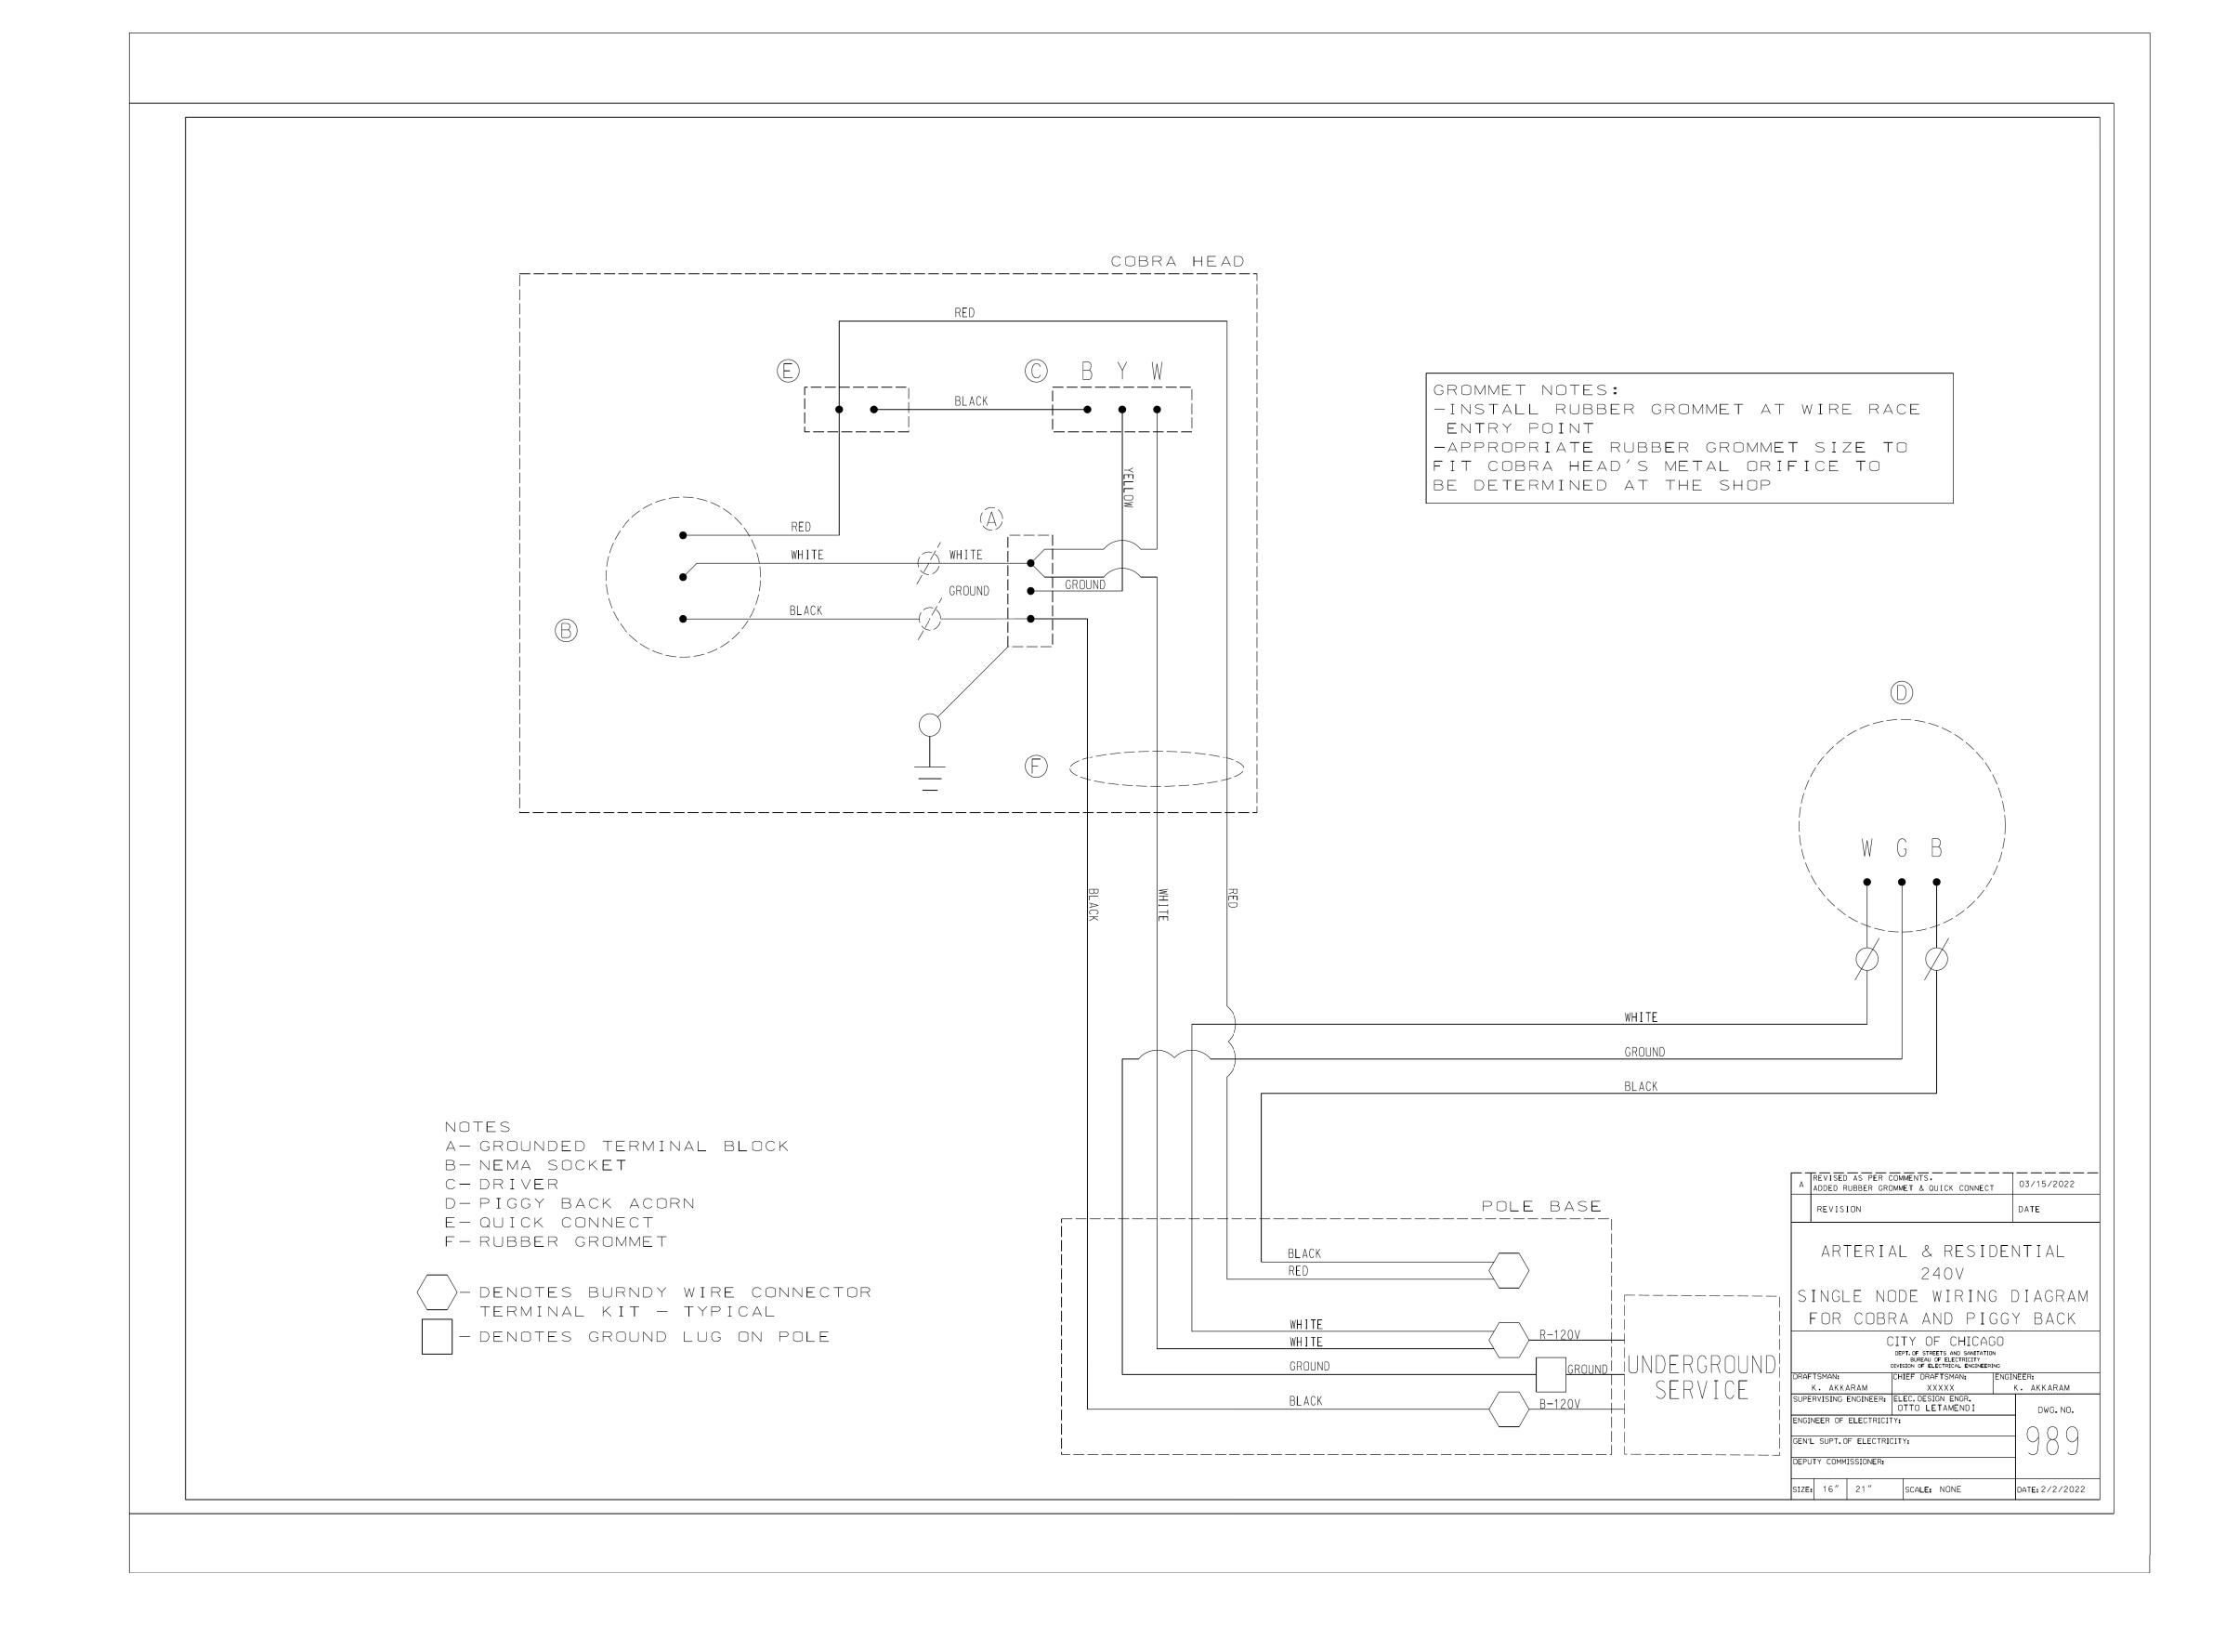





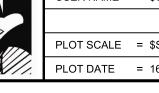


DESIGNED - JVD REVISED -USER NAME = \$USER\$ DRAWN - JVD REVISED -CHECKED - RP/MG REVISED -PLOT SCALE = \$SCALE\$ PLOT DATE = 16-DEC-2024 08:48 DATE - 12/05/2024 REVISED -

CITY OF CHICAGO **DEPARTMENT OF TRANSPORTATION**

CDOT ELECTRICAL STANDARD DETAILS SHEET 13 OF 13 SHEETS STA. SCALE: TO STA. SECTION COOK CONTRACT NO. ILLINOIS FED. AID PROJECT

TOTAL SHEET NO. 49 27

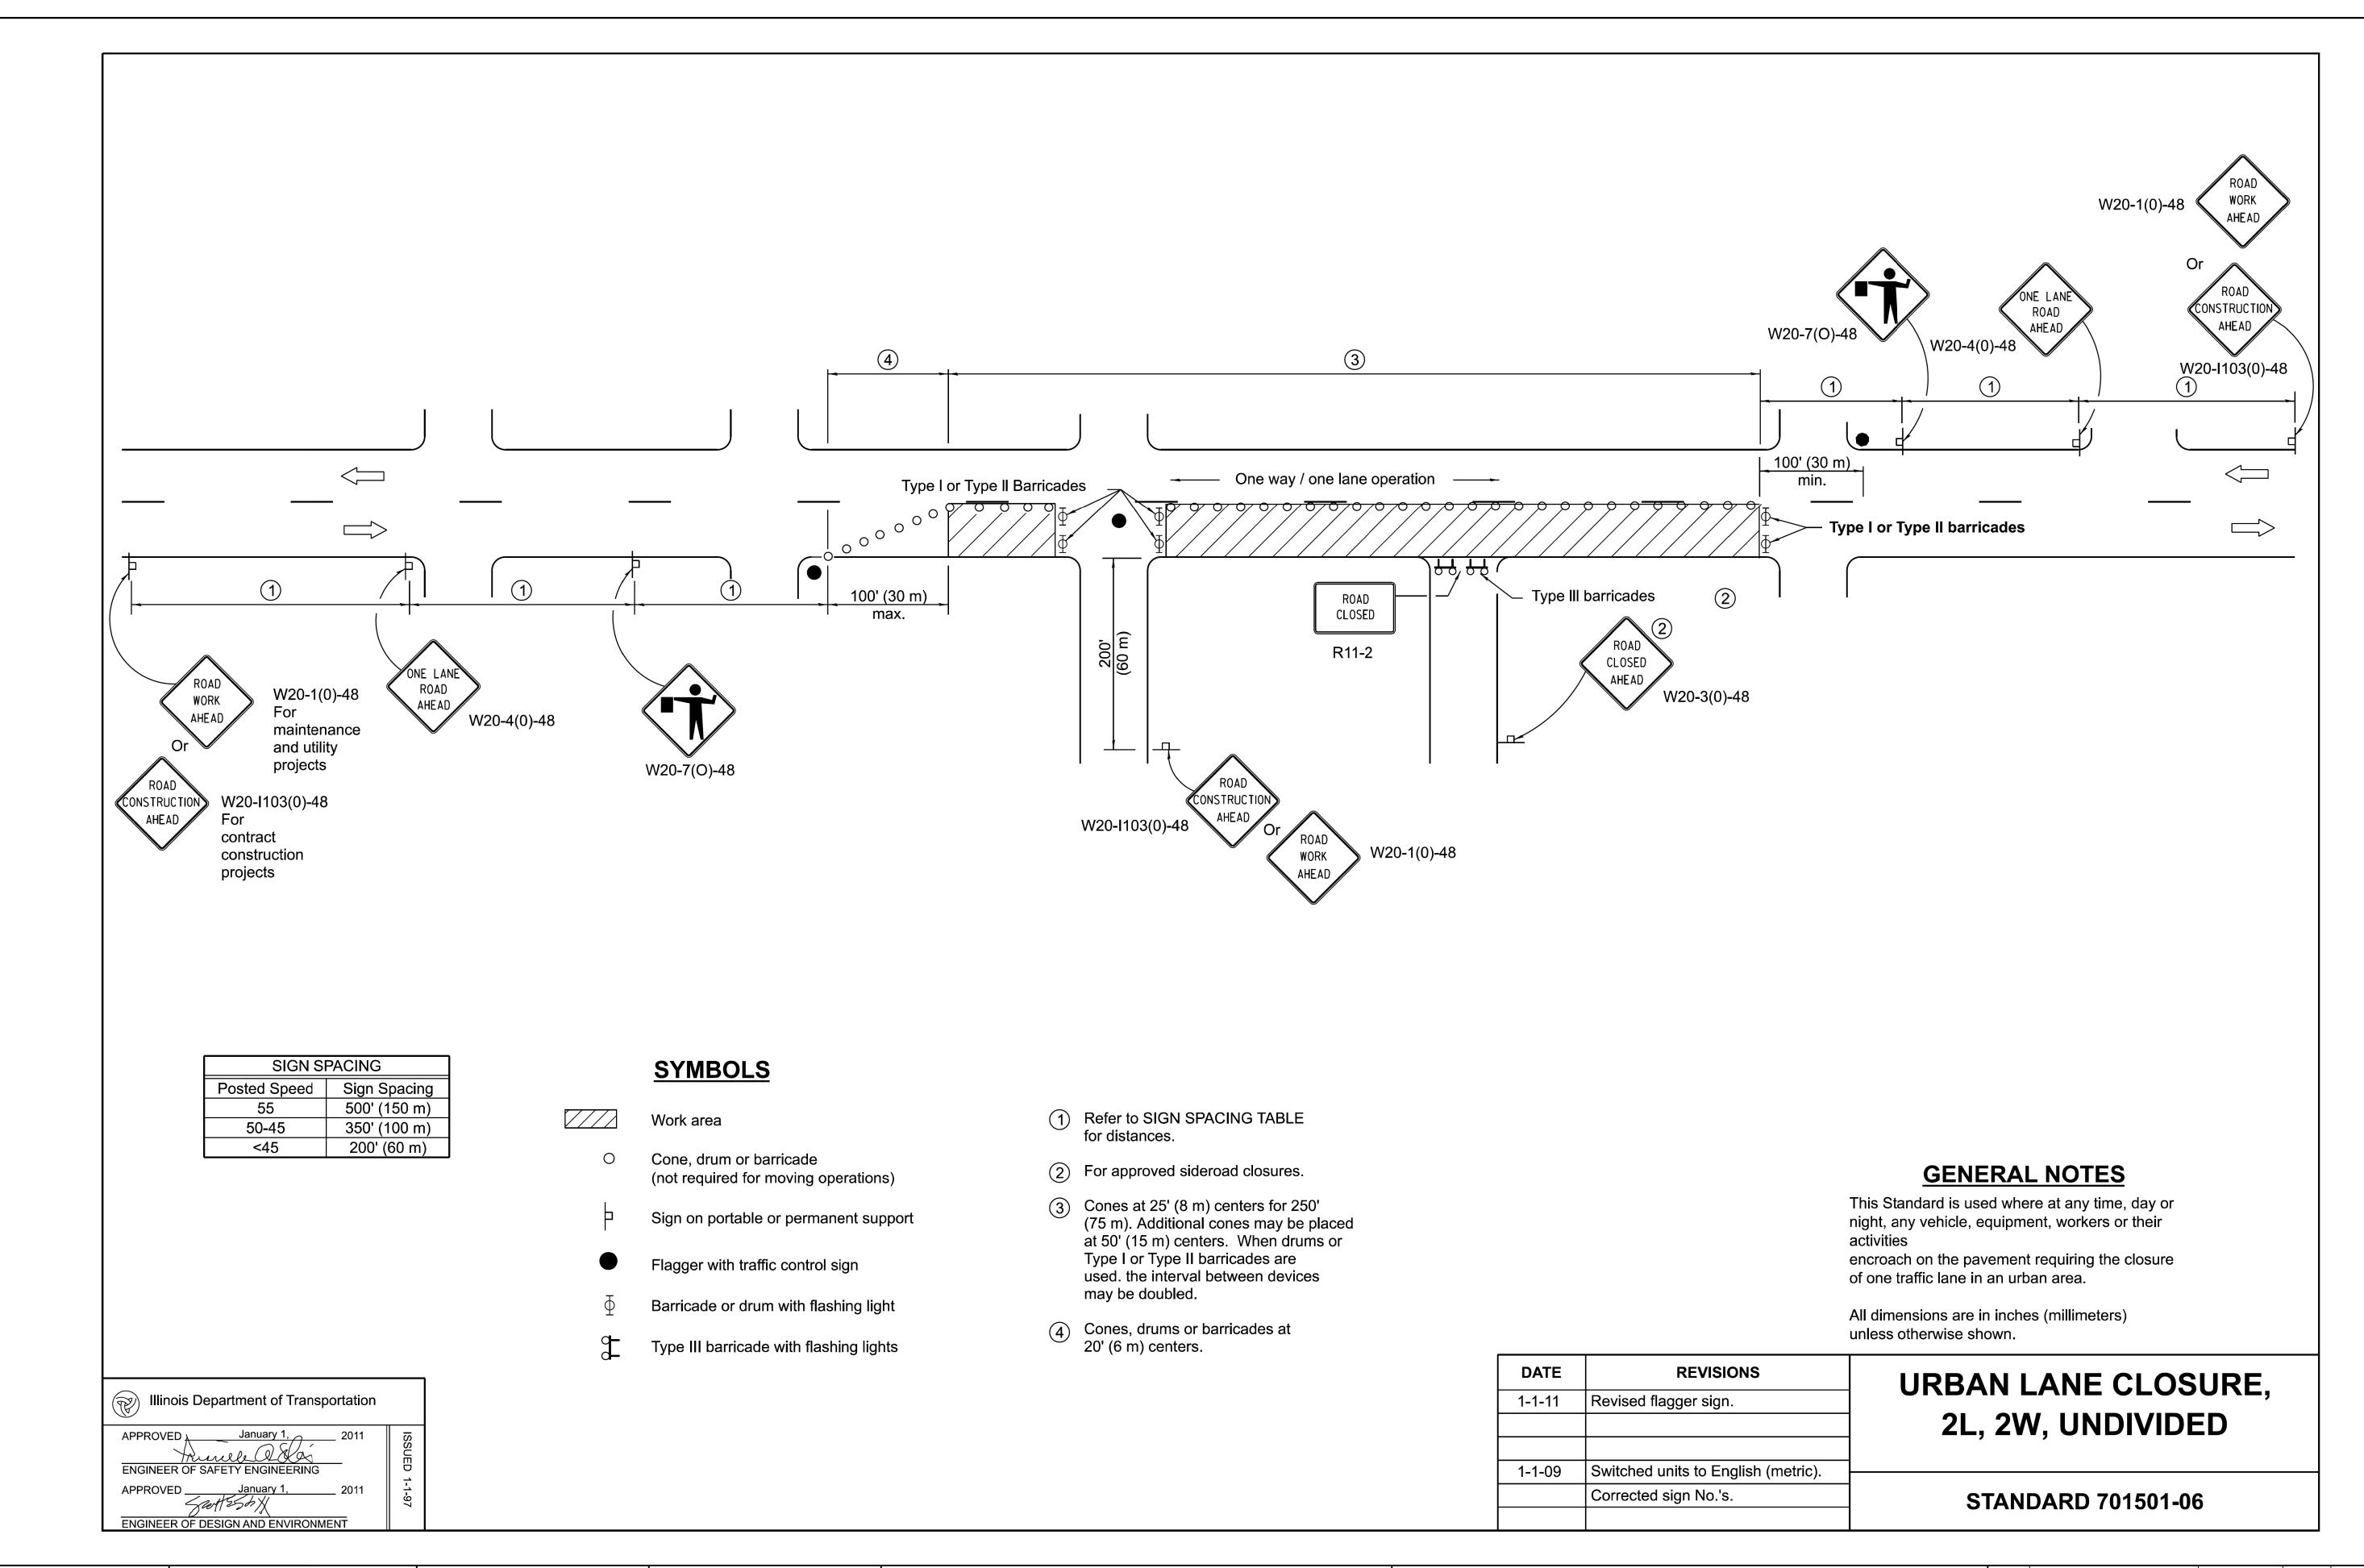

*CDOT

 USER NAME
 = mike.thon
 DESIGNED
 REVISED

 PLOT SCALE
 = 10.000 ' / in.
 CHECKED
 REVISED

 PLOT DATE
 = 12/13/2024
 DATE
 12/13/2024
 ISSUED FOR BID
 12/17/2024

CITY OF CHICAGO
DEPARTMENT OF TRANSPORTATION

SCALE:

IDOT HIGHWAY STANDARDS


SHEET 1 OF 22 SHEETS STA. TO STA.

F.A. SECTION COUNTY TOTAL SHEET NO.

COOK 49 28

CONTRACT NO. C1617

ILLINOIS FED. AID PROJECT

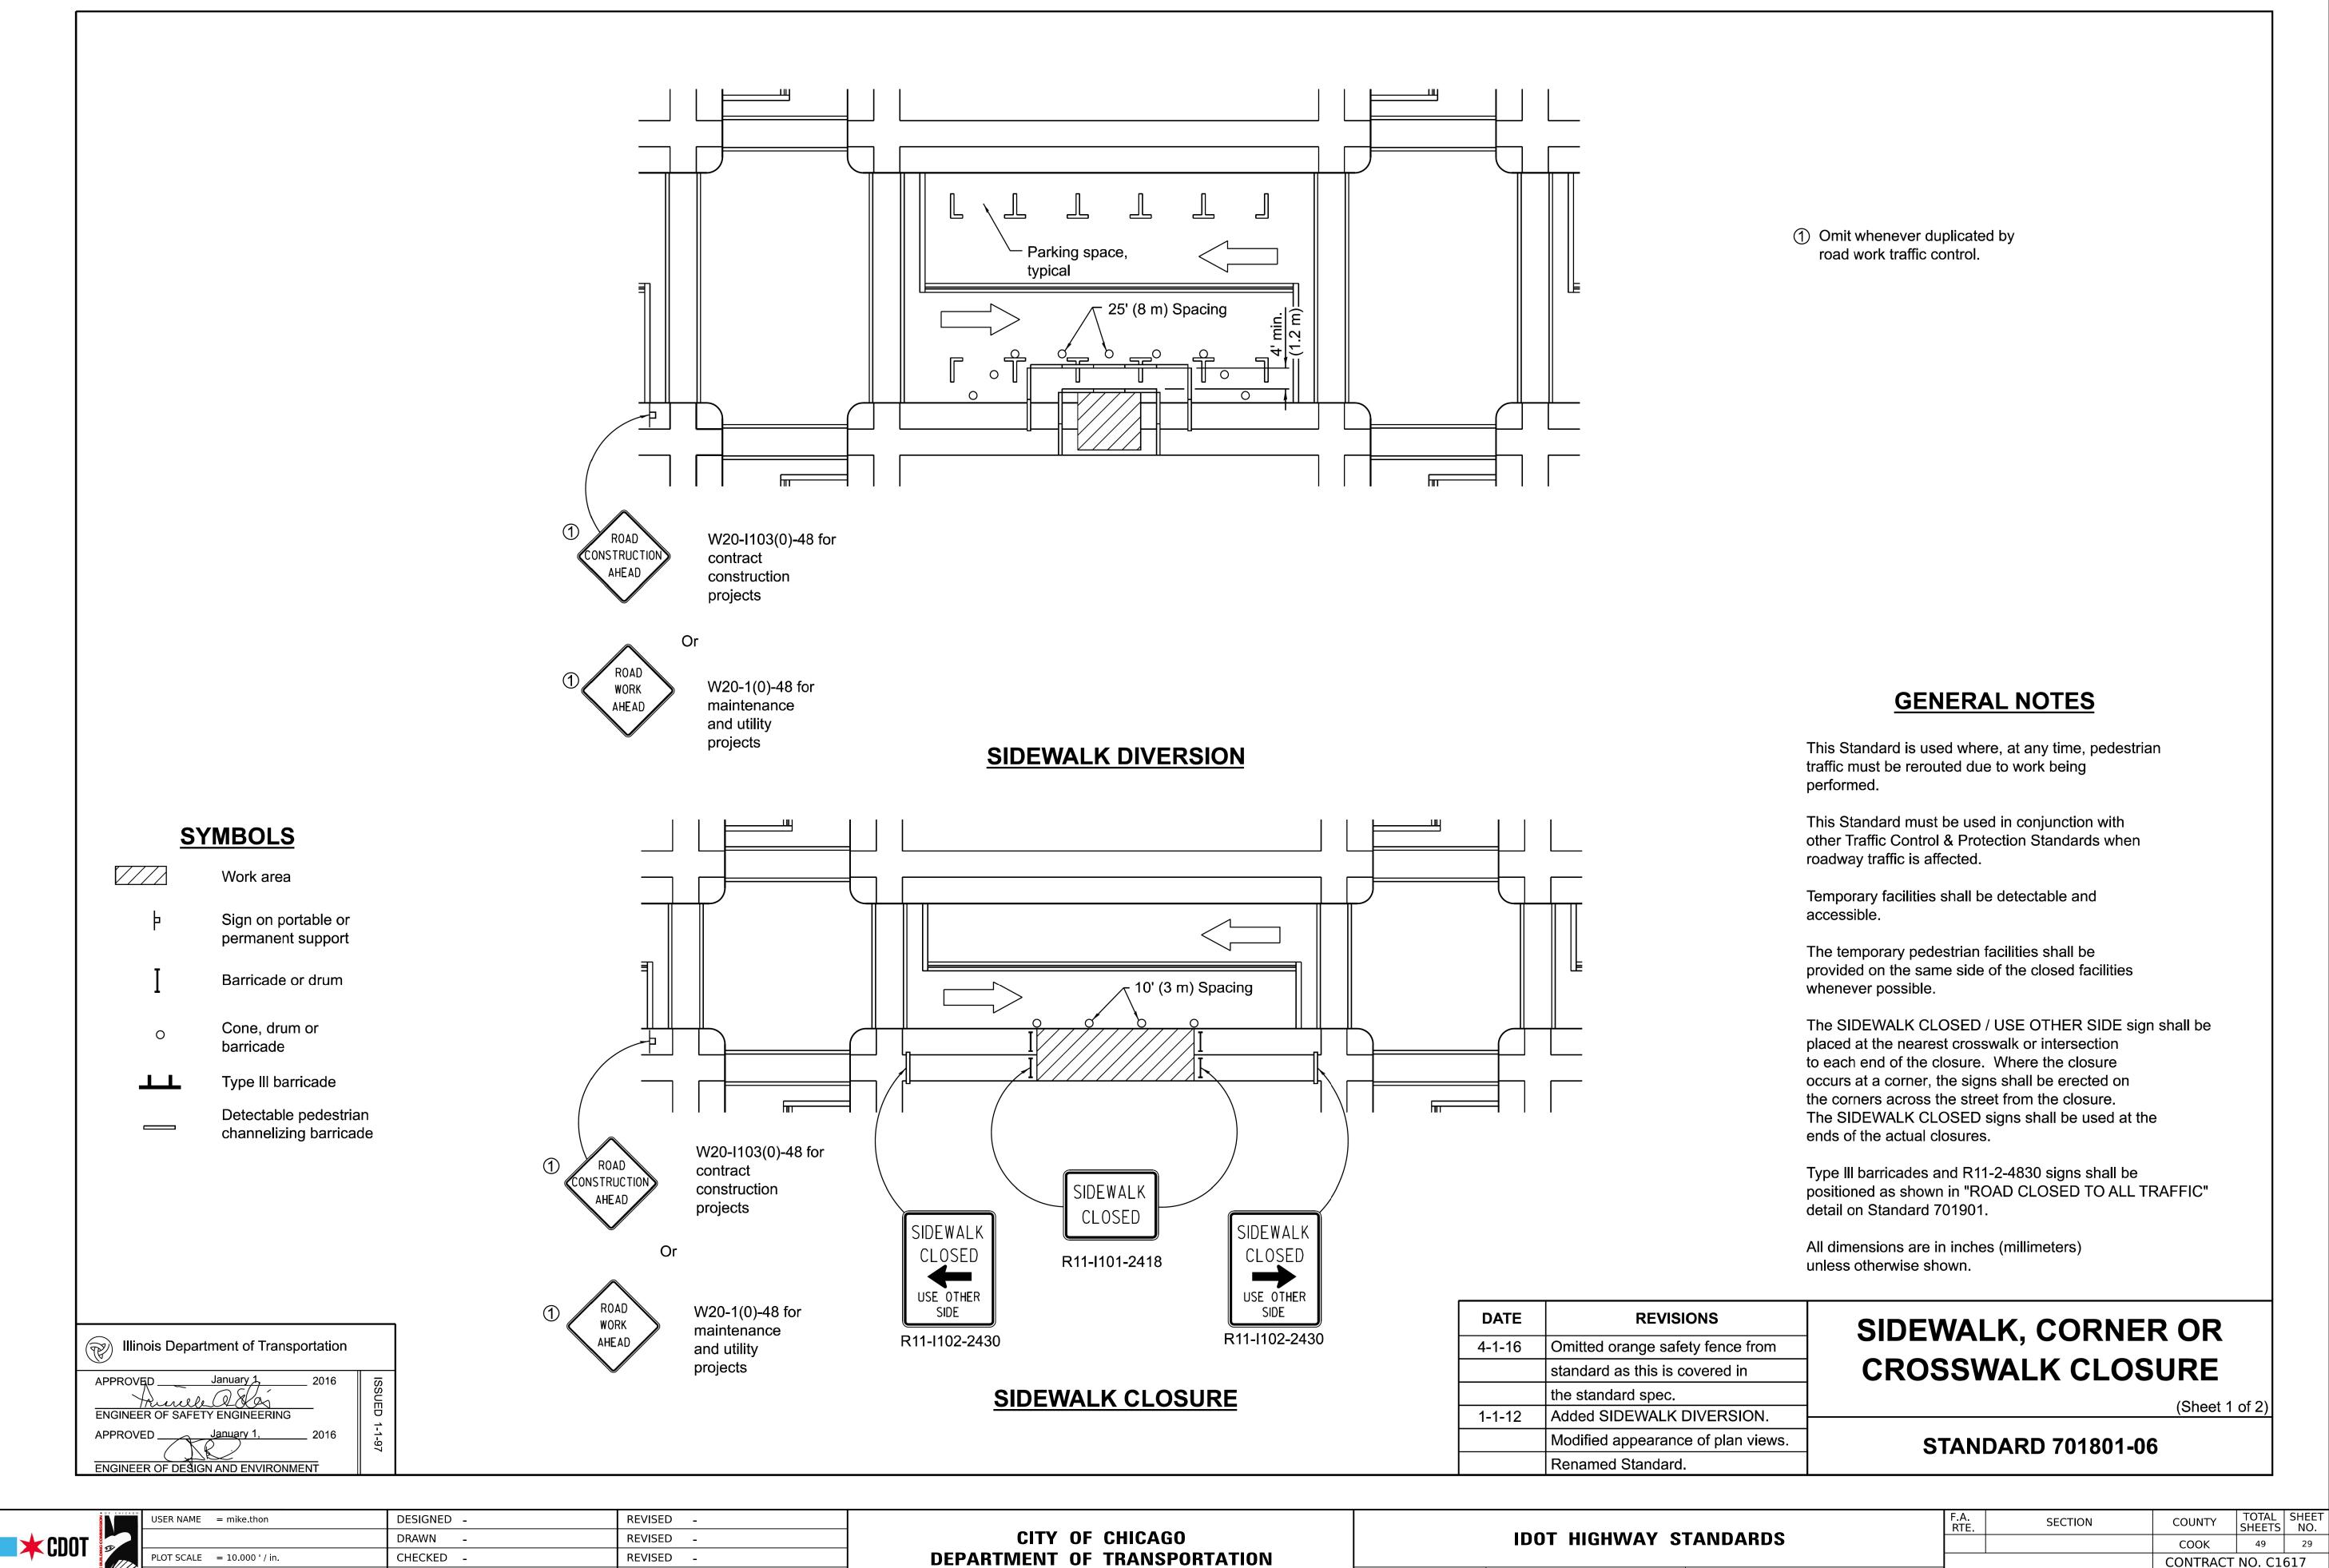

CONTRACT NO. C1617

ILLINOIS FED. AID PROJECT

OF 22 SHEETS STA.

TO STA.

SHEET 2

SCALE:

★CDOT

PLOT SCALE = 10.000 ' / in.


PLOT DATE = 12/13/2024

DATE

- 12/13/2024

ISSUED FOR BID

12/17/2024

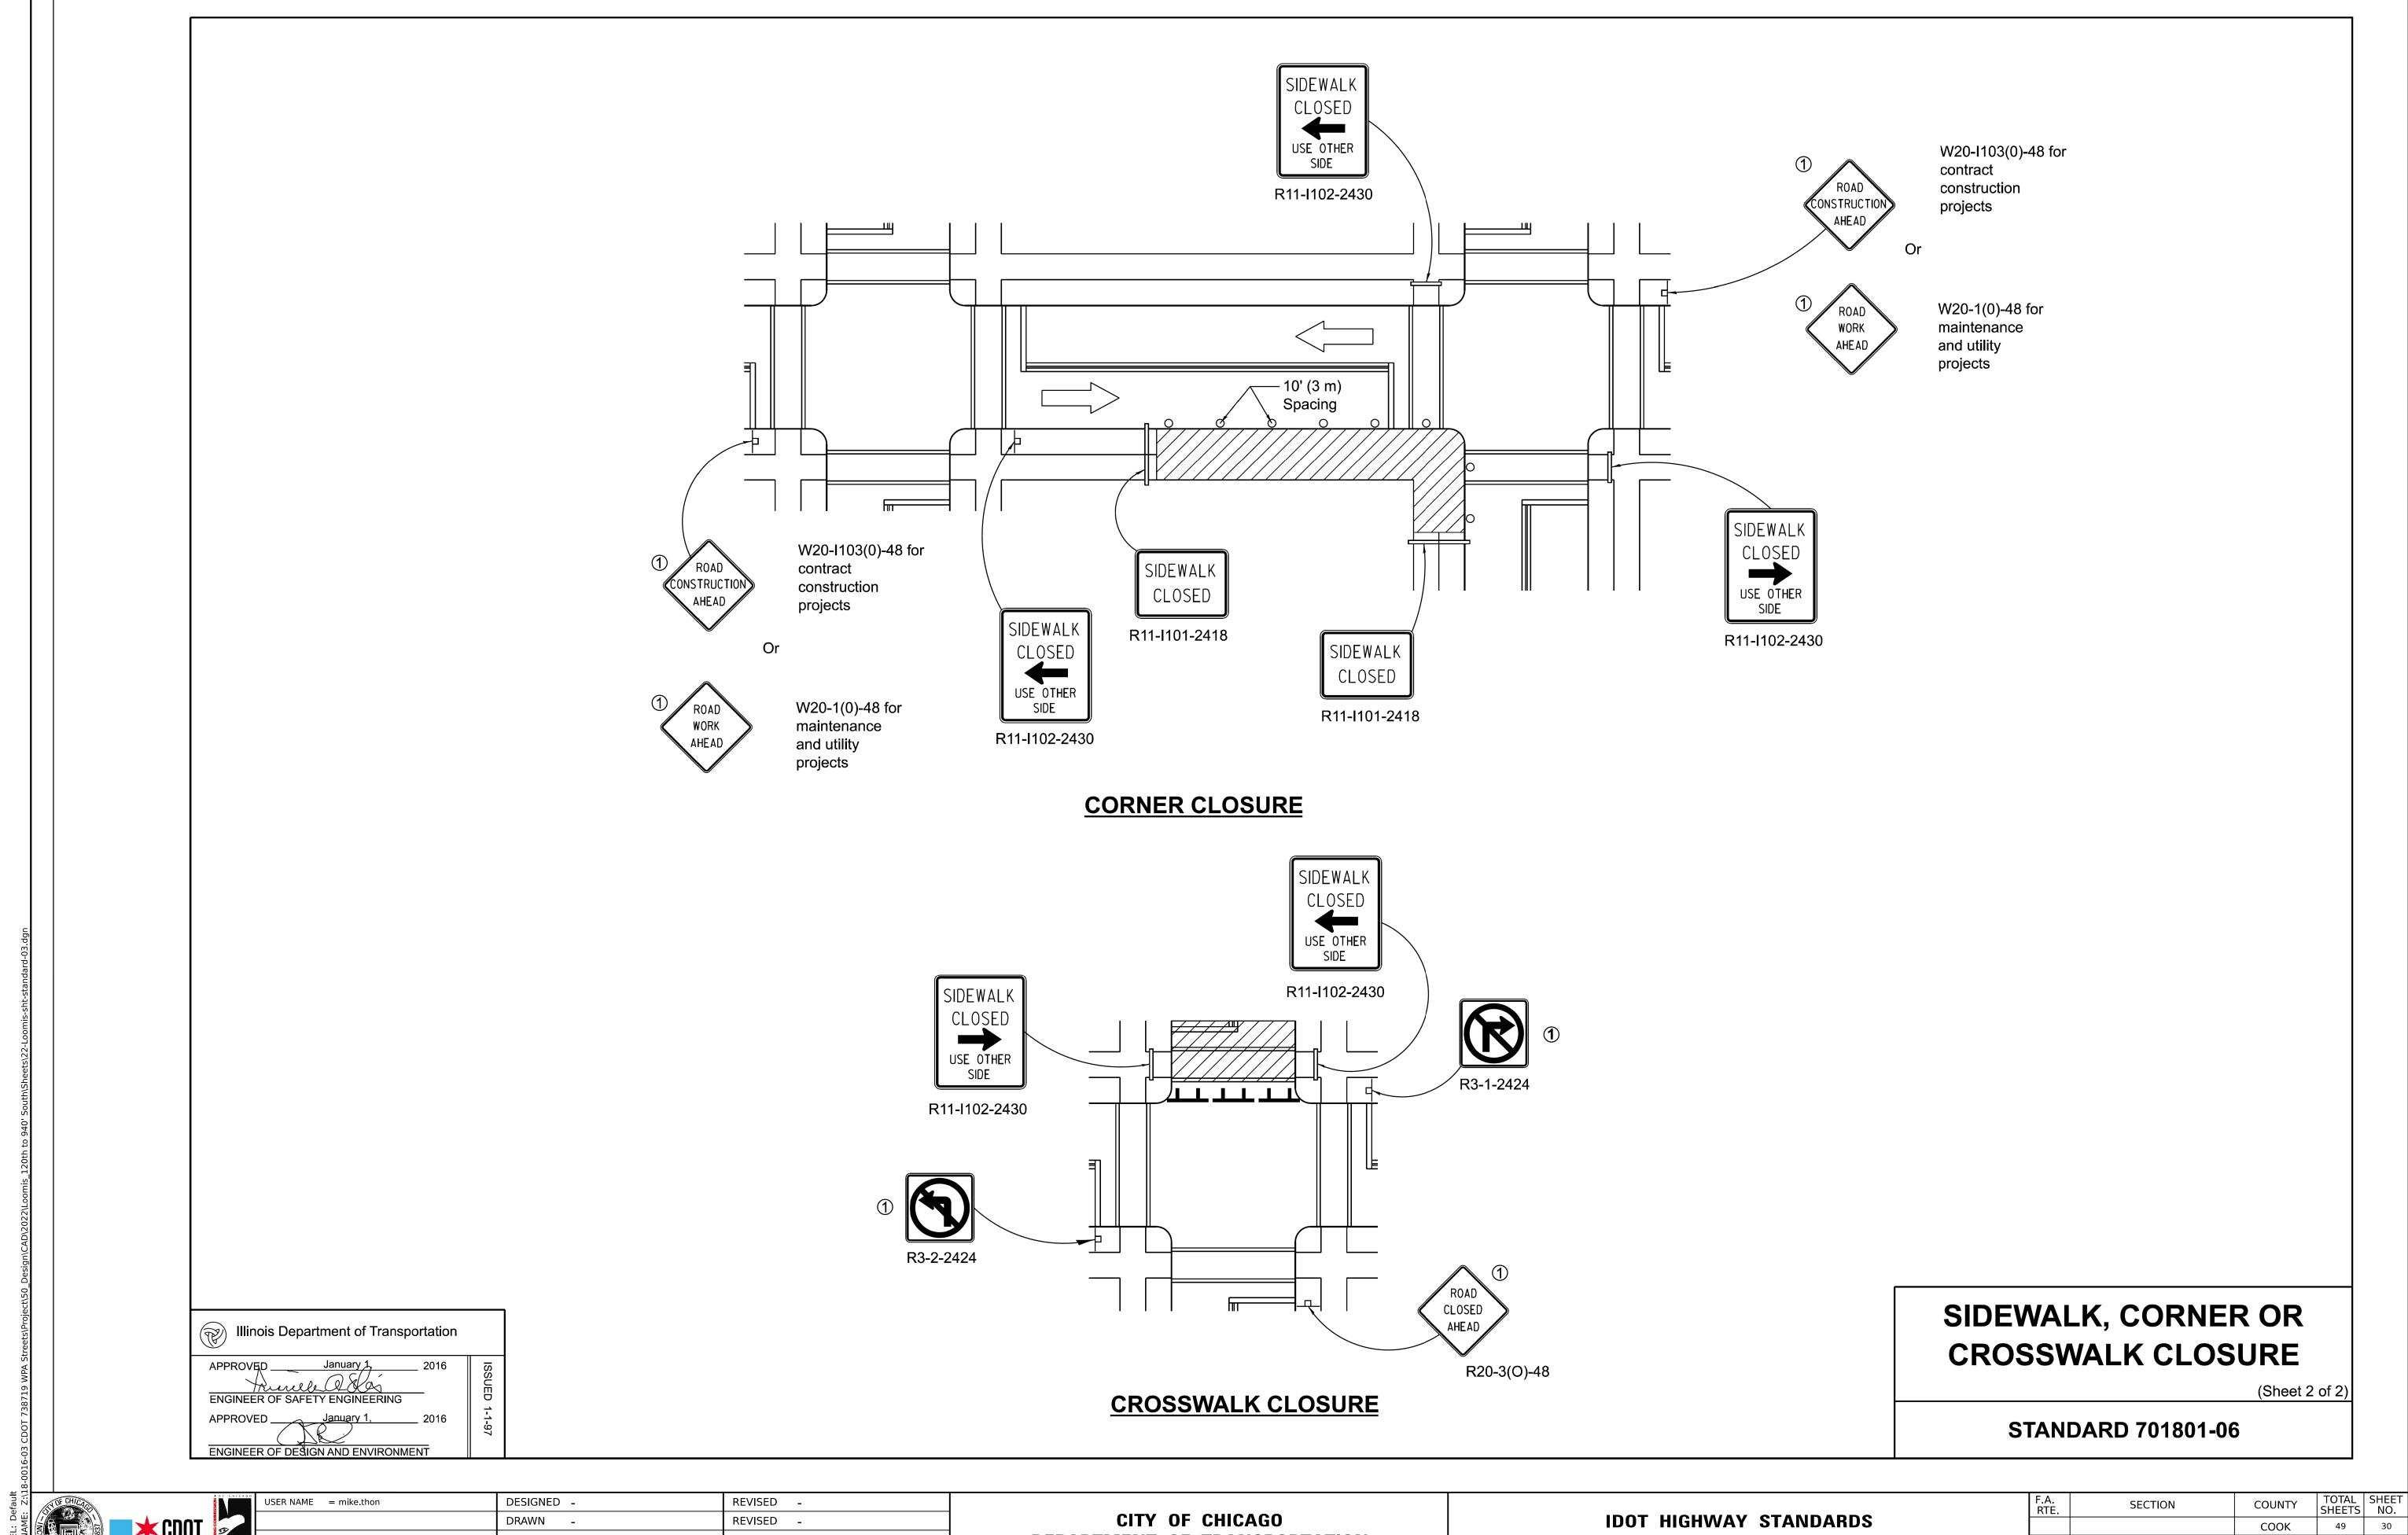


CHECKED REVISED PLOT SCALE = 10.000 ' / in. - 12/13/2024 12/17/2024 PLOT DATE = 12/13/2024 ISSUED FOR BID

DEPARTMENT OF TRANSPORTATION

SCALE:

COOK CONTRACT NO. C1617 OF 22 SHEETS STA. TO STA. ILLINOIS FED. AID PROJECT

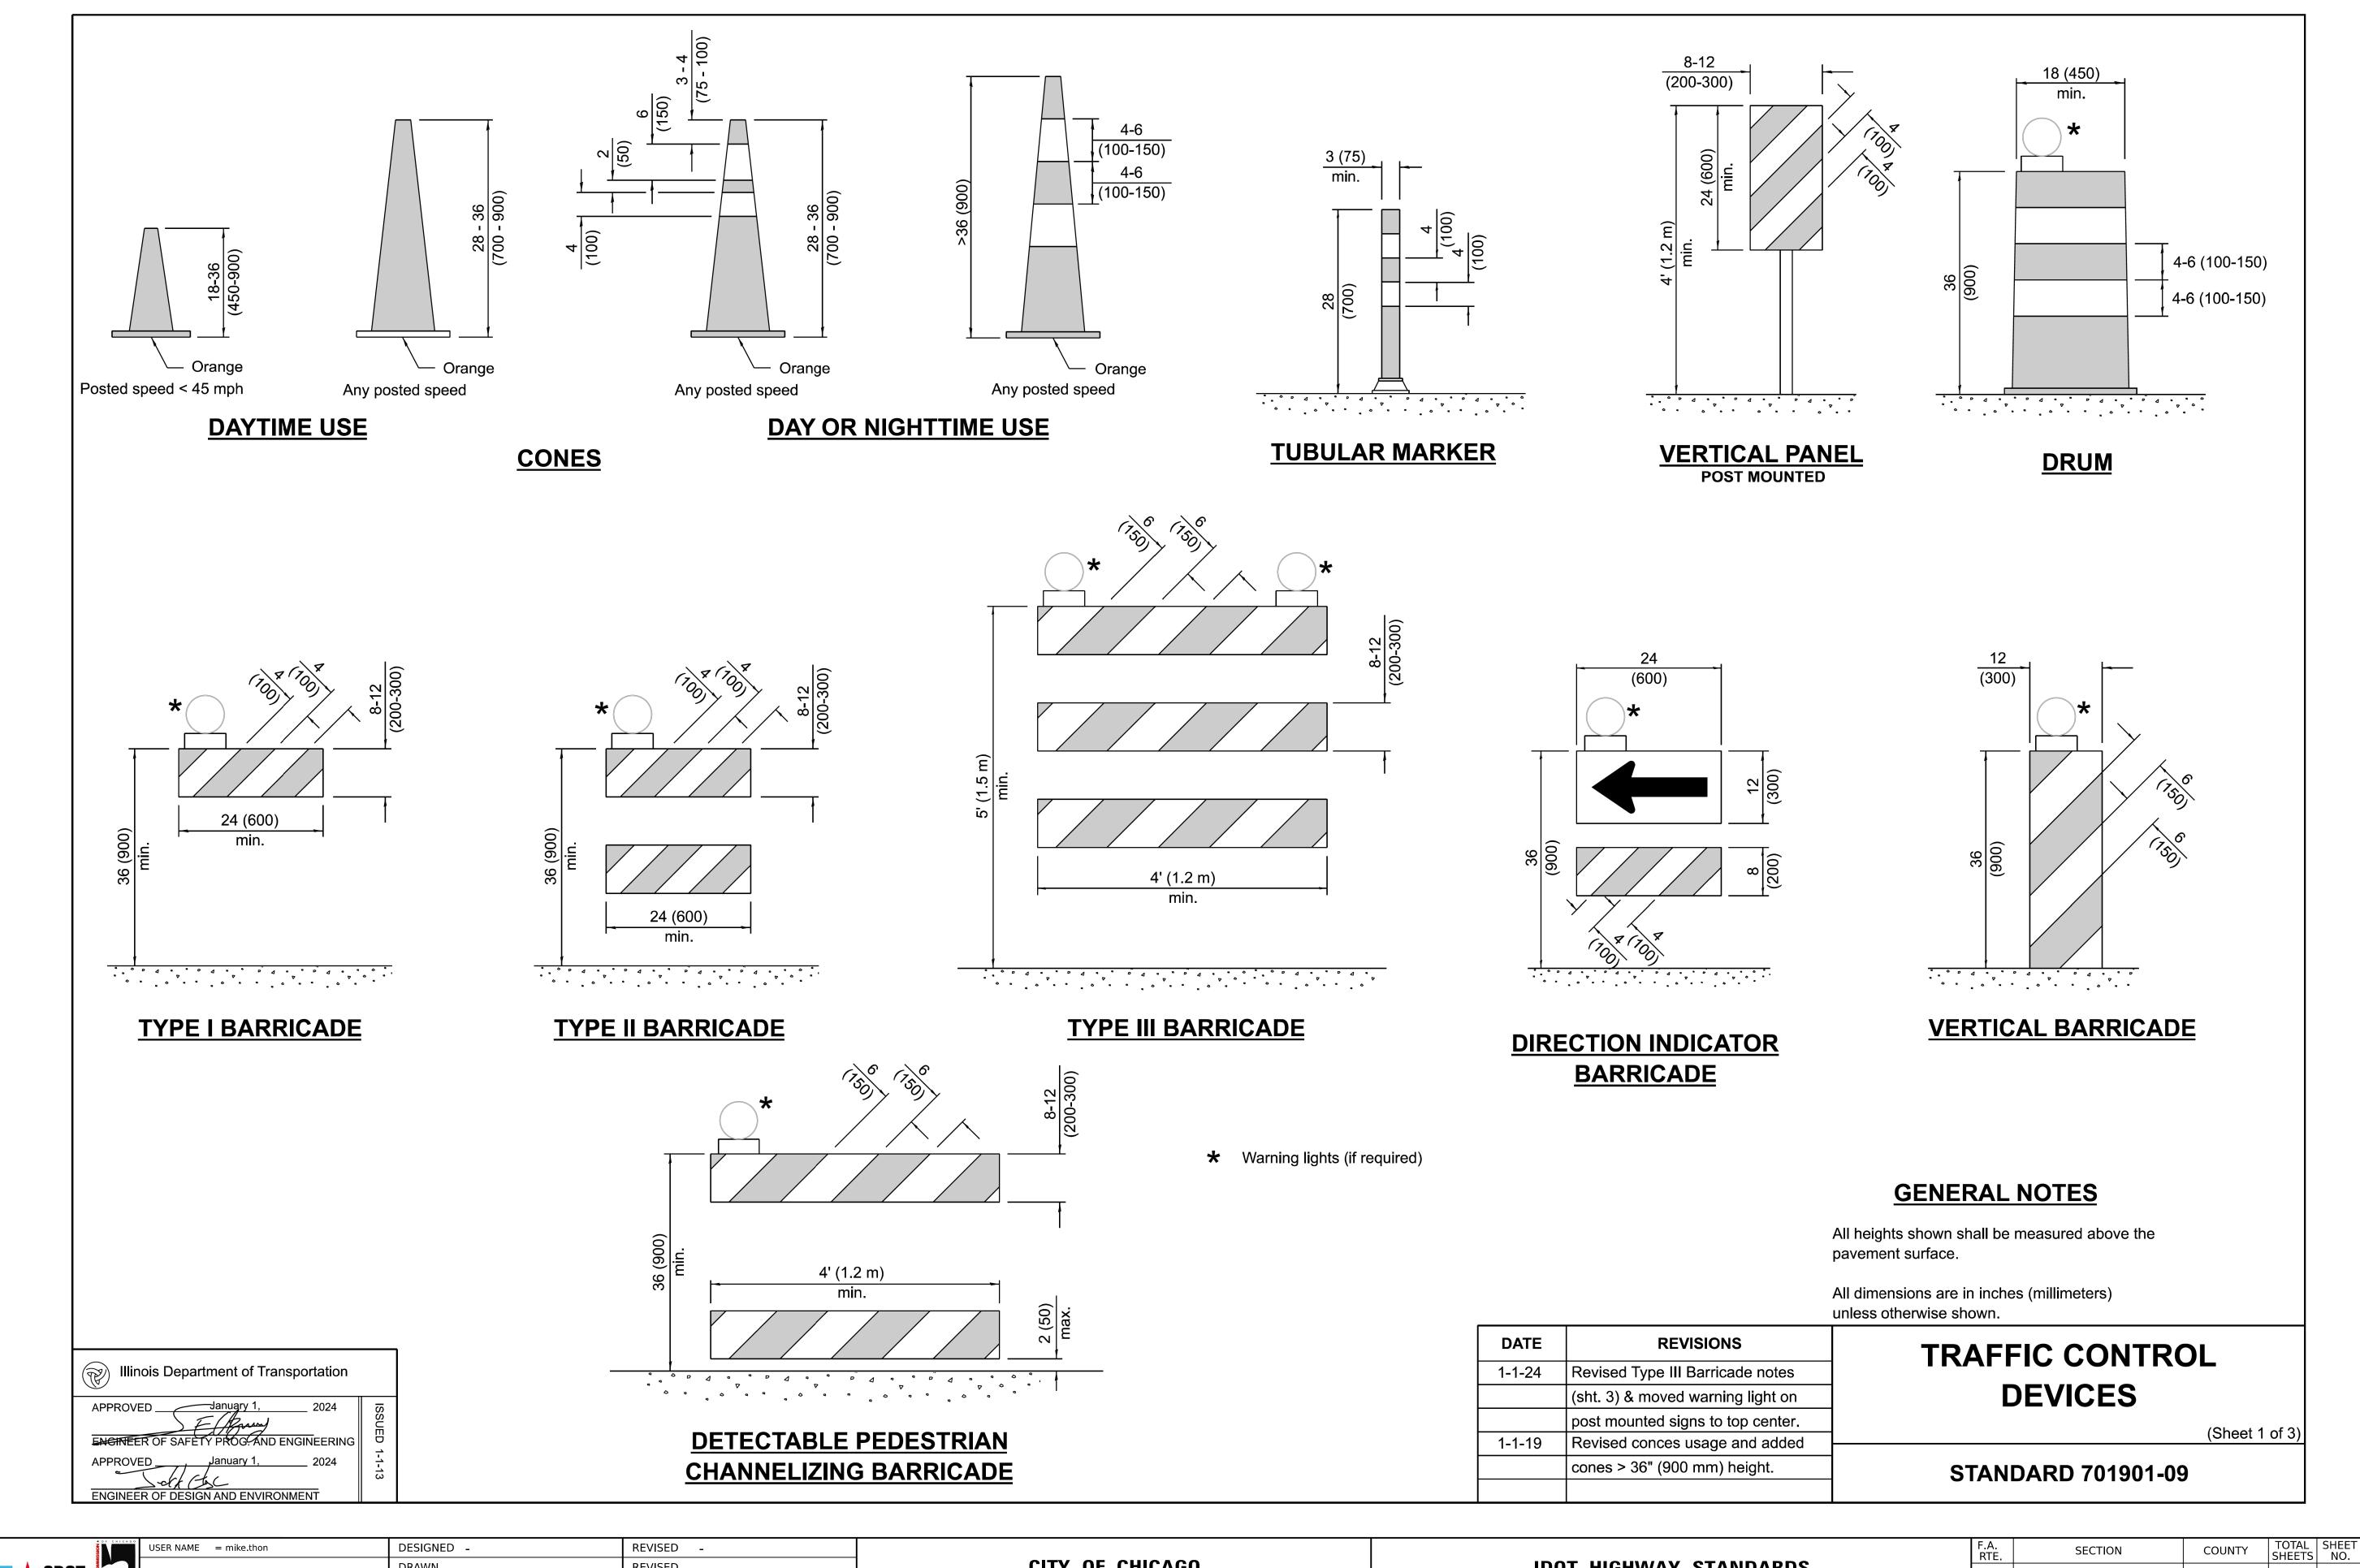

CDOT CHICAGO CONTROL C

 USER NAME
 = mike.thon
 DESIGNED
 REVISED

 PLOT SCALE
 = 10.000 ' / in.
 CHECKED
 REVISED

 PLOT DATE
 = 12/13/2024
 DATE
 12/13/2024
 ISSUED FOR BID
 12/17/2024

CITY OF CHICAGO
DEPARTMENT OF TRANSPORTATION

SCALE:


IDOT HIGHWAY STANDARDS

SHEET 4 OF 22 SHEETS STA. TO STA.

RTE. SECTION COUNTY SHEETS NO COOK 49 31


CONTRACT NO. C1617

ILLINOIS FED. AID PROJECT

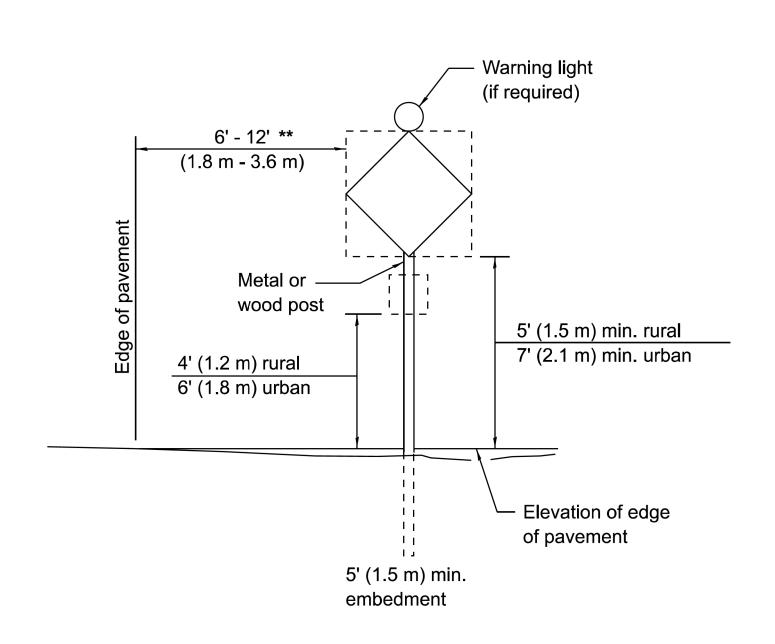


POST MOUNTED SIGNS

** When curb or paved shoulder are present this dimension shall be 24 (600) to the face of curb or 6' (1.8 m) to the outside edge of the paved shoulder.

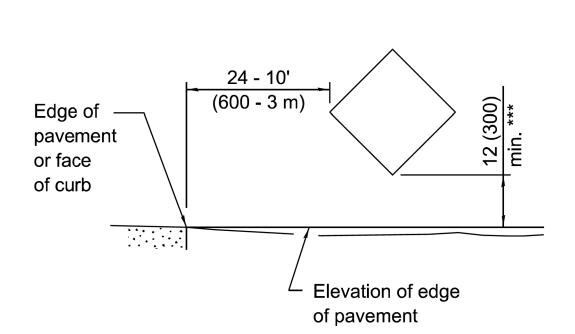


SIGNS ON TEMPORARY SUPPORTS

*** When work operations exceed four days, this dimension shall be 5' (1.5 m) min. If located behind other devices, the height shall be sufficient to be seen completely above the devices.

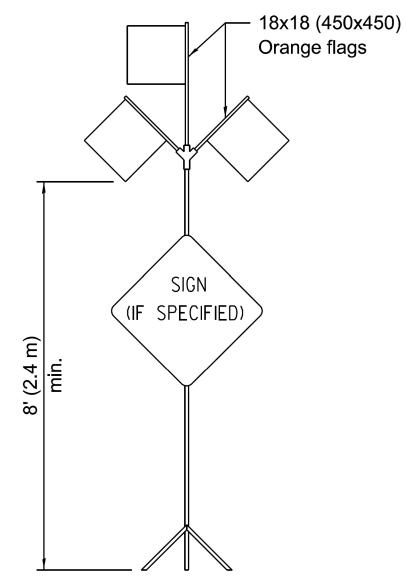

HIGH LEVEL WARNING DEVICE

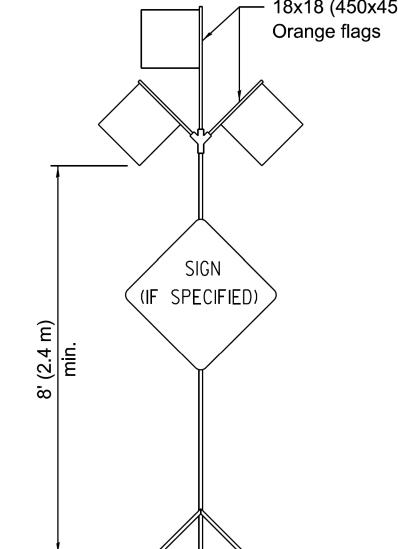

WORK LIMIT SIGNING

Dual sign displays shall be utilized on multi-

ROAD

CONSTRUCTION

NEXT X MILES

G20-I104(0)-6036

within 2 miles (3200 m).

lane highways.

ject limits.

This signing is required for all projects


be placed 500' (150 m) in advance of pro-

the end of the job unless another job is

ROAD CONSTRUCTION NEXT X MILES sign shall

END CONSTRUCTION sign shall be erected at

2 miles (3200 m) or more in length.

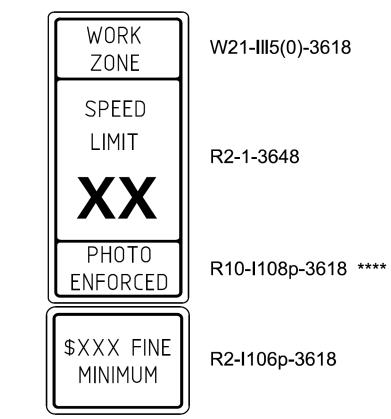

END

CONSTRUCTION

G20-I105(0)-6024

Sign assembly as shown on Standards or as allowed by District Operations.



G20-I103-6036

This sign shall be used when the above sign assembly is used.


HIGHWAY CONSTRUCTION **SPEED ZONE SIGNS**

**** R10-I108p shall only be used along roadways under the juristiction of the State.

TRAFFIC CONTROL **DEVICES**

(Sheet 2 of 3)


STANDARD 701901-09

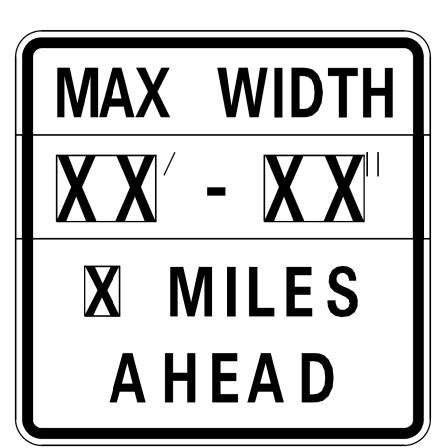


W12-I103-4848

WIDTH RESTRICTION SIGN

XX'-XX" width and X miles are variable.

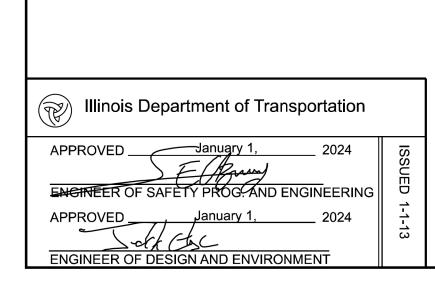

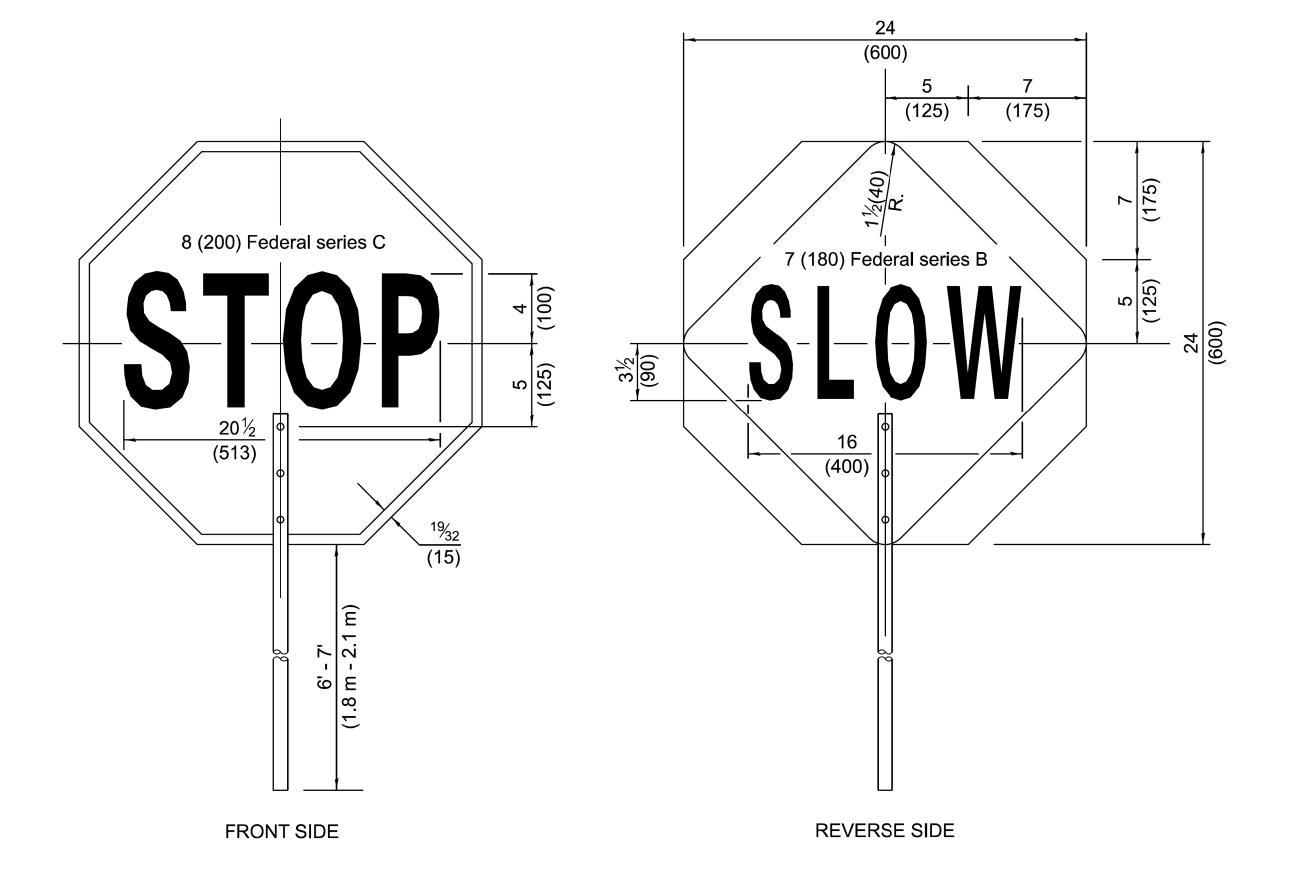

FLAGGER TRAFFIC CONTROL SIGN

CDOT CHICAGO

	USER NAME = mike.thon	DESIGNED	-		REVISED	-		
		DRAWN	-		REVISED	-		
	PLOT SCALE = 10.000 ' / in.	CHECKED	-		REVISED	-		
<i>–</i>	PLOT DATE = 12/13/2024	DATE	-	12/13/2024	ISSUED FO	R BID	-	12/17/2024


IDOT HIGHWAY STANDARDS

TO STA.

OF 22 SHEETS STA.

SECTION 49 32 COOK CONTRACT NO. C1617 ILLINOIS FED. AID PROJECT

CITY OF CHICAGO DEPARTMENT OF TRANSPORTATION

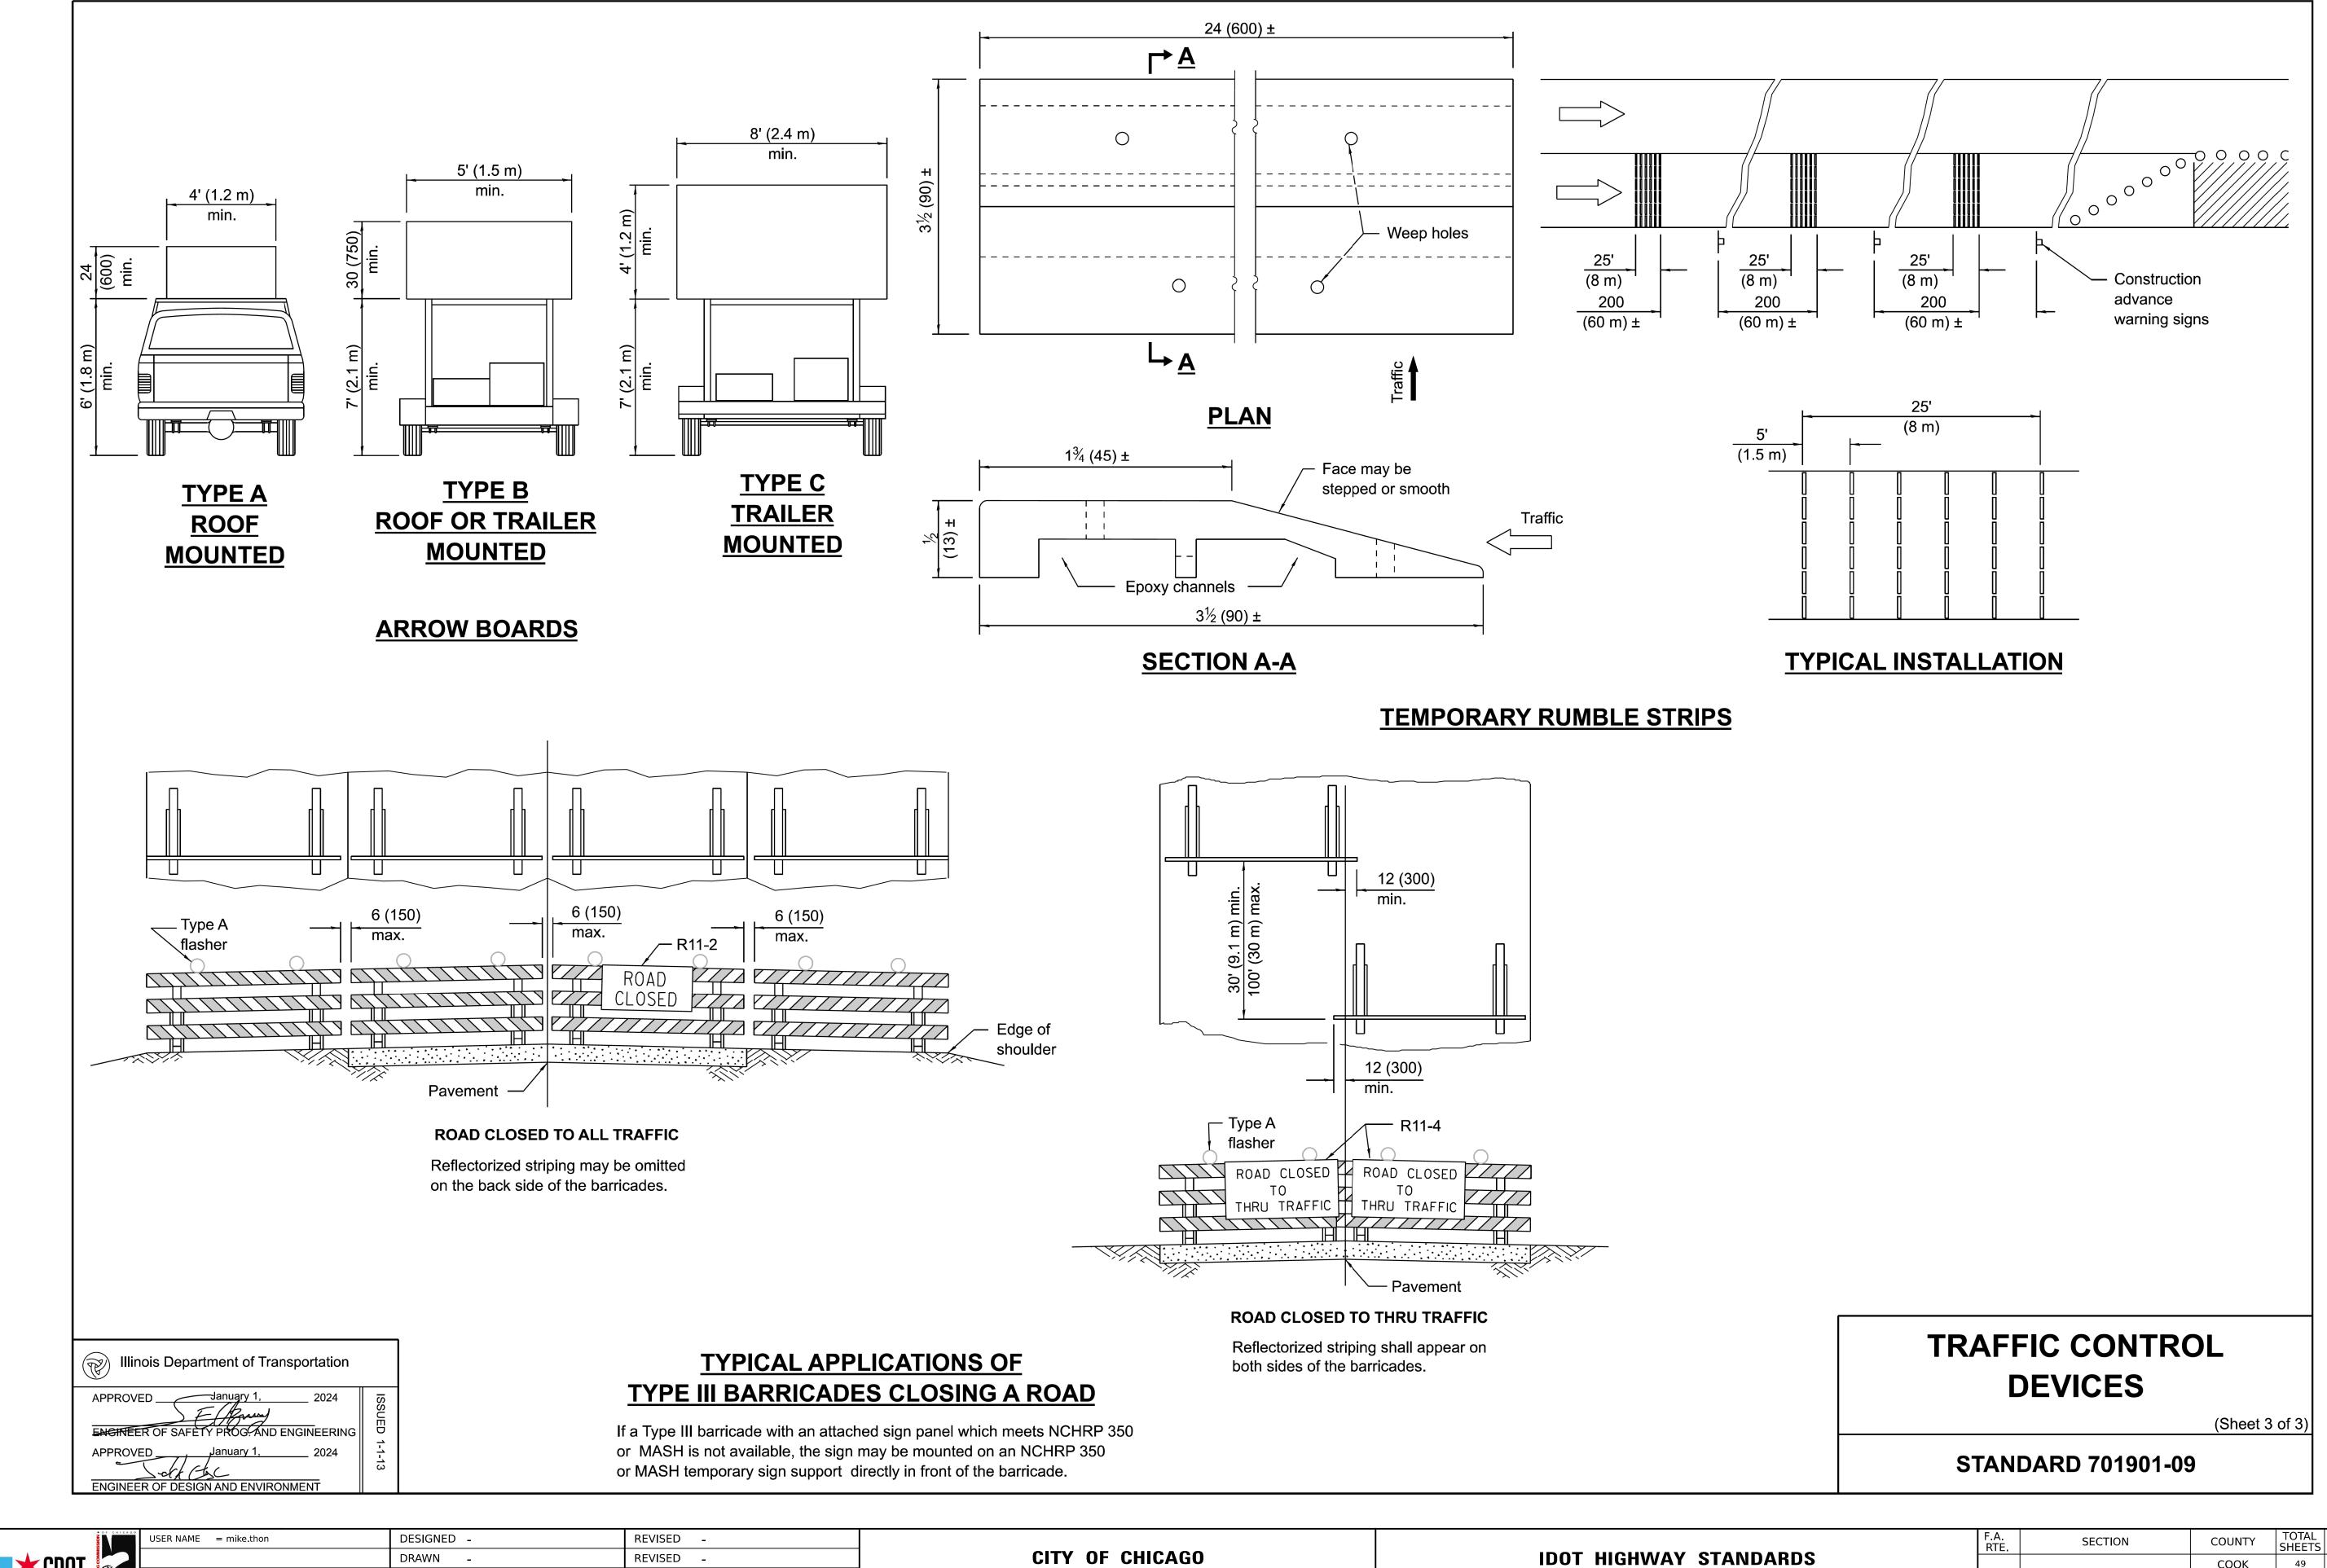

DEPARTMENT OF TRANSPORTATION

OF 22 SHEETS STA.

TO STA.

SCALE:

49 33

COOK

ILLINOIS FED. AID PROJECT

CONTRACT NO. C1617

CDOT CDOT

PLOT SCALE = 10.000 ' / in.

LOT DATE = 12/13/2024

CHECKED


- 12/13/2024

DATE

REVISED

ISSUED FOR BID

12/17/2024

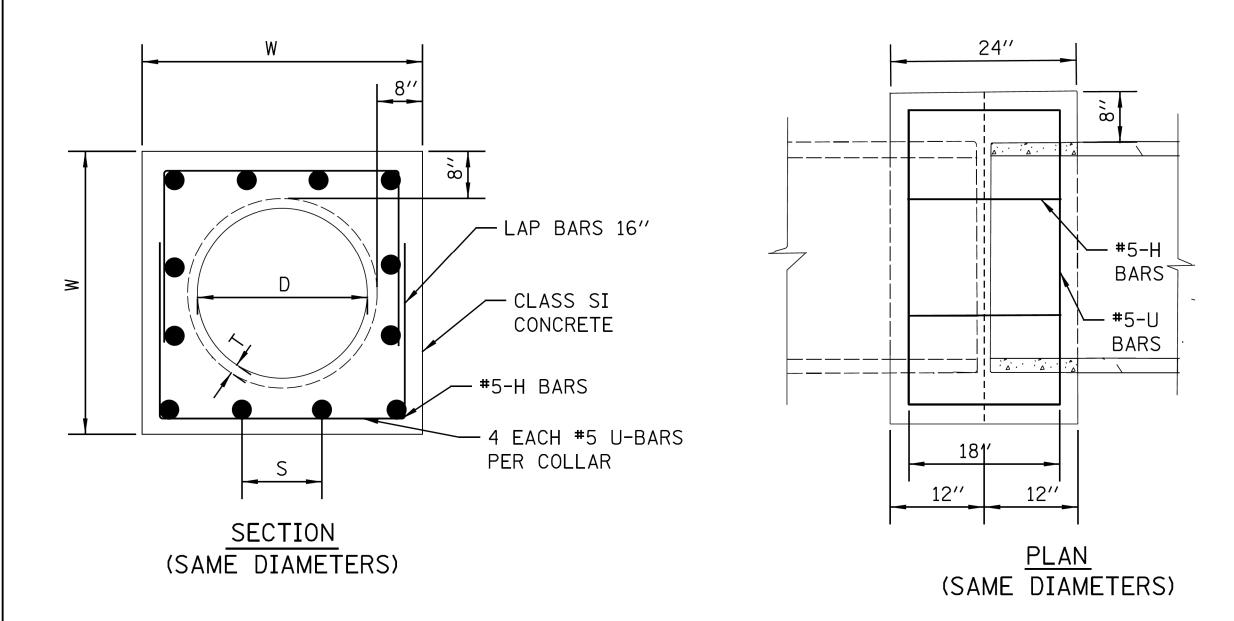



REINFORCED CONCRETE COLLAR CONNECTION BETWEEN SAME DIAMETER PIPES

SCALE: N.T.S.

					U E	BAR			H BAR			
	D	Т	W				TOTAL			TOTAL	CLASS SI	
	PIPE DIA.	PIPE THICKNESS	WIDTH	X	Y	QTY	LENGTH	S	QTY	LENGTH	CONCRETE	#5 EPOXY REBAR
	(IN)	(IN)	(IN)	(IN)	(IN)	(EACH)	(FT)	(IN)	(EACH)	(FT)	(CU YD)	(LBS)
	24	3.00	46.0	40.00	28.00	4	32.0	9 5/8	16.0	24.0	0.72	58.4
	27	3.25	49.5	43.50	29.75	4	34.3	10 1/2	16.0	24.0	0.81	60.8
	30	3.50	53.0	47.00	31.50	4	36.7	11 3/8	16.0	24.0	0.89	63.3
	33	3.75	56.5	50.50	33.25	4	39.0	9 4/5	20.0	30.0	0.98	72.0
Ī	36	4.00	60.0	54.00	35.00	4	41.3	10 1/2	20.0	30.0	1.07	74.4
	42	4.50	67.0	61.00	38.50	4	46.0	9 7/8	24.0	36.0	1.26	85.5
	48	5.00	74.0	68.00	42.00	4	50.7	11 1/8	24.0	36.0	1.46	90.4
	54	5.30	86.0	80.00	48.00	4	58.7	11 1/8	28.0	42.0	1.82	105.0
	60	6.00	92.0	85.00	51.00	4	62.7	10 1/2	32.0	48.0	2.02	115.5

NOTE: SPECIAL SE DESIGNED COLLAR REQUIRED FOR LARGER SIZES

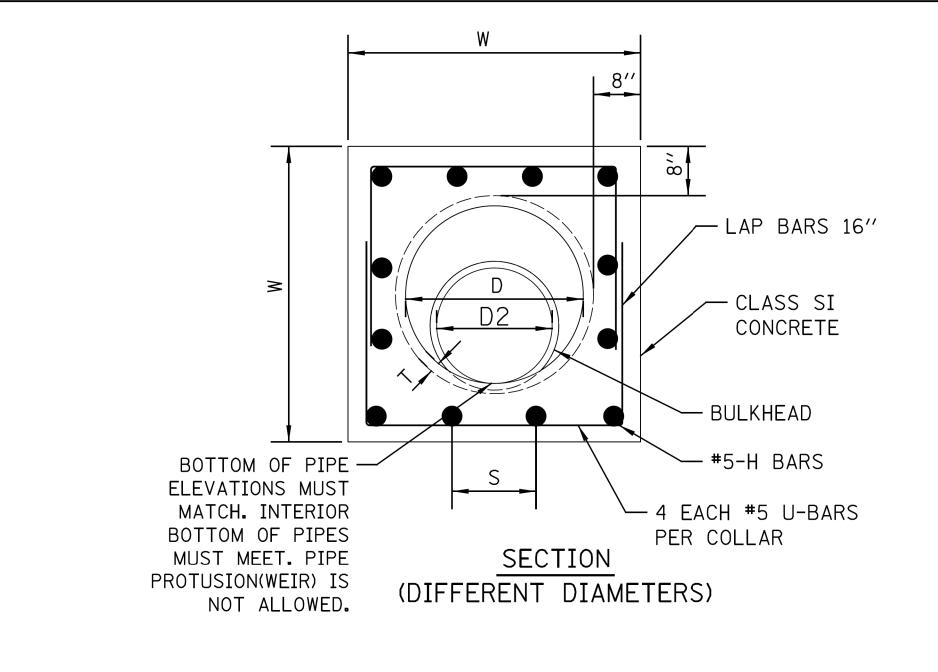

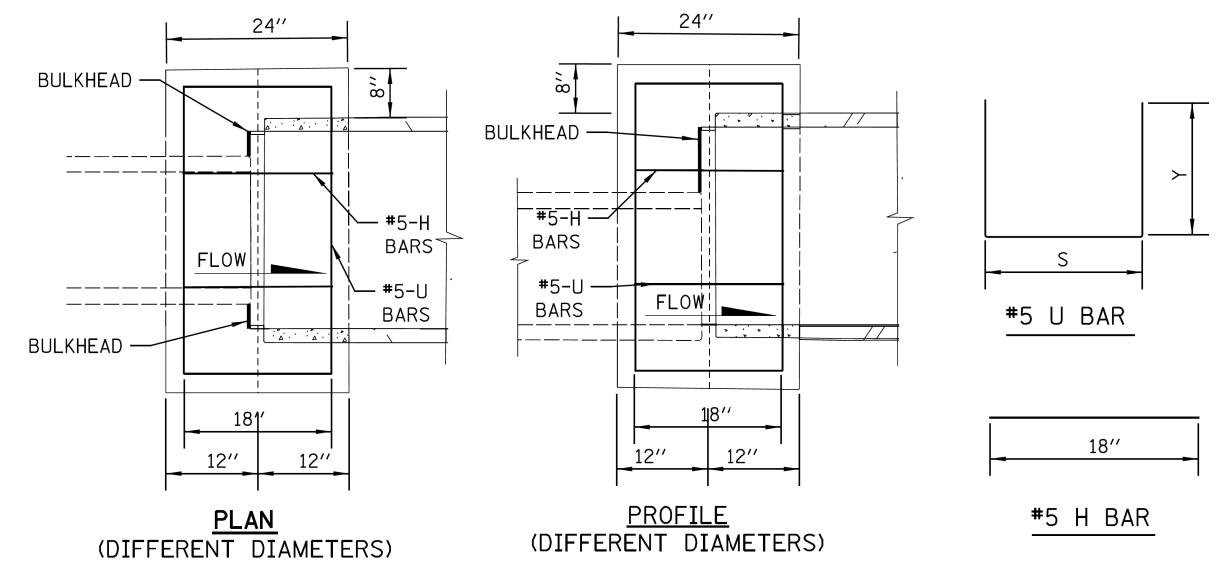

NOTES

- 1. IF DIFFERENT PIPE SIZES ARE BEING CONNECTED, STEEL REINFORCEMENT BARS SHALL BE SUPPLIED AS GIVEN IN TABLE BELOW FOR THE LARGER DIAMETER PIPE.
- 2. CONTRACTOR SHALL PROVIDE BULKHEAD TO KEEP CONCRETE FROM SPILLING INTO LARGER PIPE. BULKHEAD MUST BE REMOVED, OR LEFT IN PLACE, ONLY AS APPROVED BY THE COMMISSIONER.

REINFORCED CONCRETE COLLAR CONNECTION BETWEEN DIFFERENT DIAMETER PIPES

SCALE: N.T.S.

STANDA	ARD REVISIONS] [PERCENT COMPLETE	DATE	CITY OF CHICAGO	DRAWN: <u>SBW</u> DESIGNED:	, ,
DATE	DESCRIPTION		30		DEPARTMENT OF WATER MANAGEMENT BUREAU OF ENGINEERING SERVICES	CHECKED:	A.5
1/4/23	<u>APPROVED PLAN</u>] [60		CONCRETE COLLAR DETAILS	REVIEWED:	
			75			، ا) E
			90		BETWEEN DISSIMILAR		JF
			100		PIPE MATERIALS	l PN	
			BULLETIN] ' '' _	


SFILE\$ SDATE\$

CDOT CHICAGO CHICAGO CONTROL C

AGO	USER NAME = mike.thon	DESIGNED	_		REVISED -		
		DRAWN	-		REVISED -		
	PLOT SCALE = 10.000 ' / in.	CHECKED	-		REVISED -		
/	PLOT DATE = 12/13/2024	DATE	-	12/13/2024	ISSUED FOR BID	-	12/17/2024

CITY OF CHICAGO
DEPARTMENT OF TRANSPORTATION

						F.A. RTE.	SECTION		COUNTY	TOTAL SHEETS	SHEET NO.	
	CDWM SEWER DETAILS									соок	49	34
	Τ									CONTRACT	NO. C1	617
	SHEET 7	OF	22	SHEETS	STA.	TO STA.		ILLINO	S FED.	. AID PROJECT		

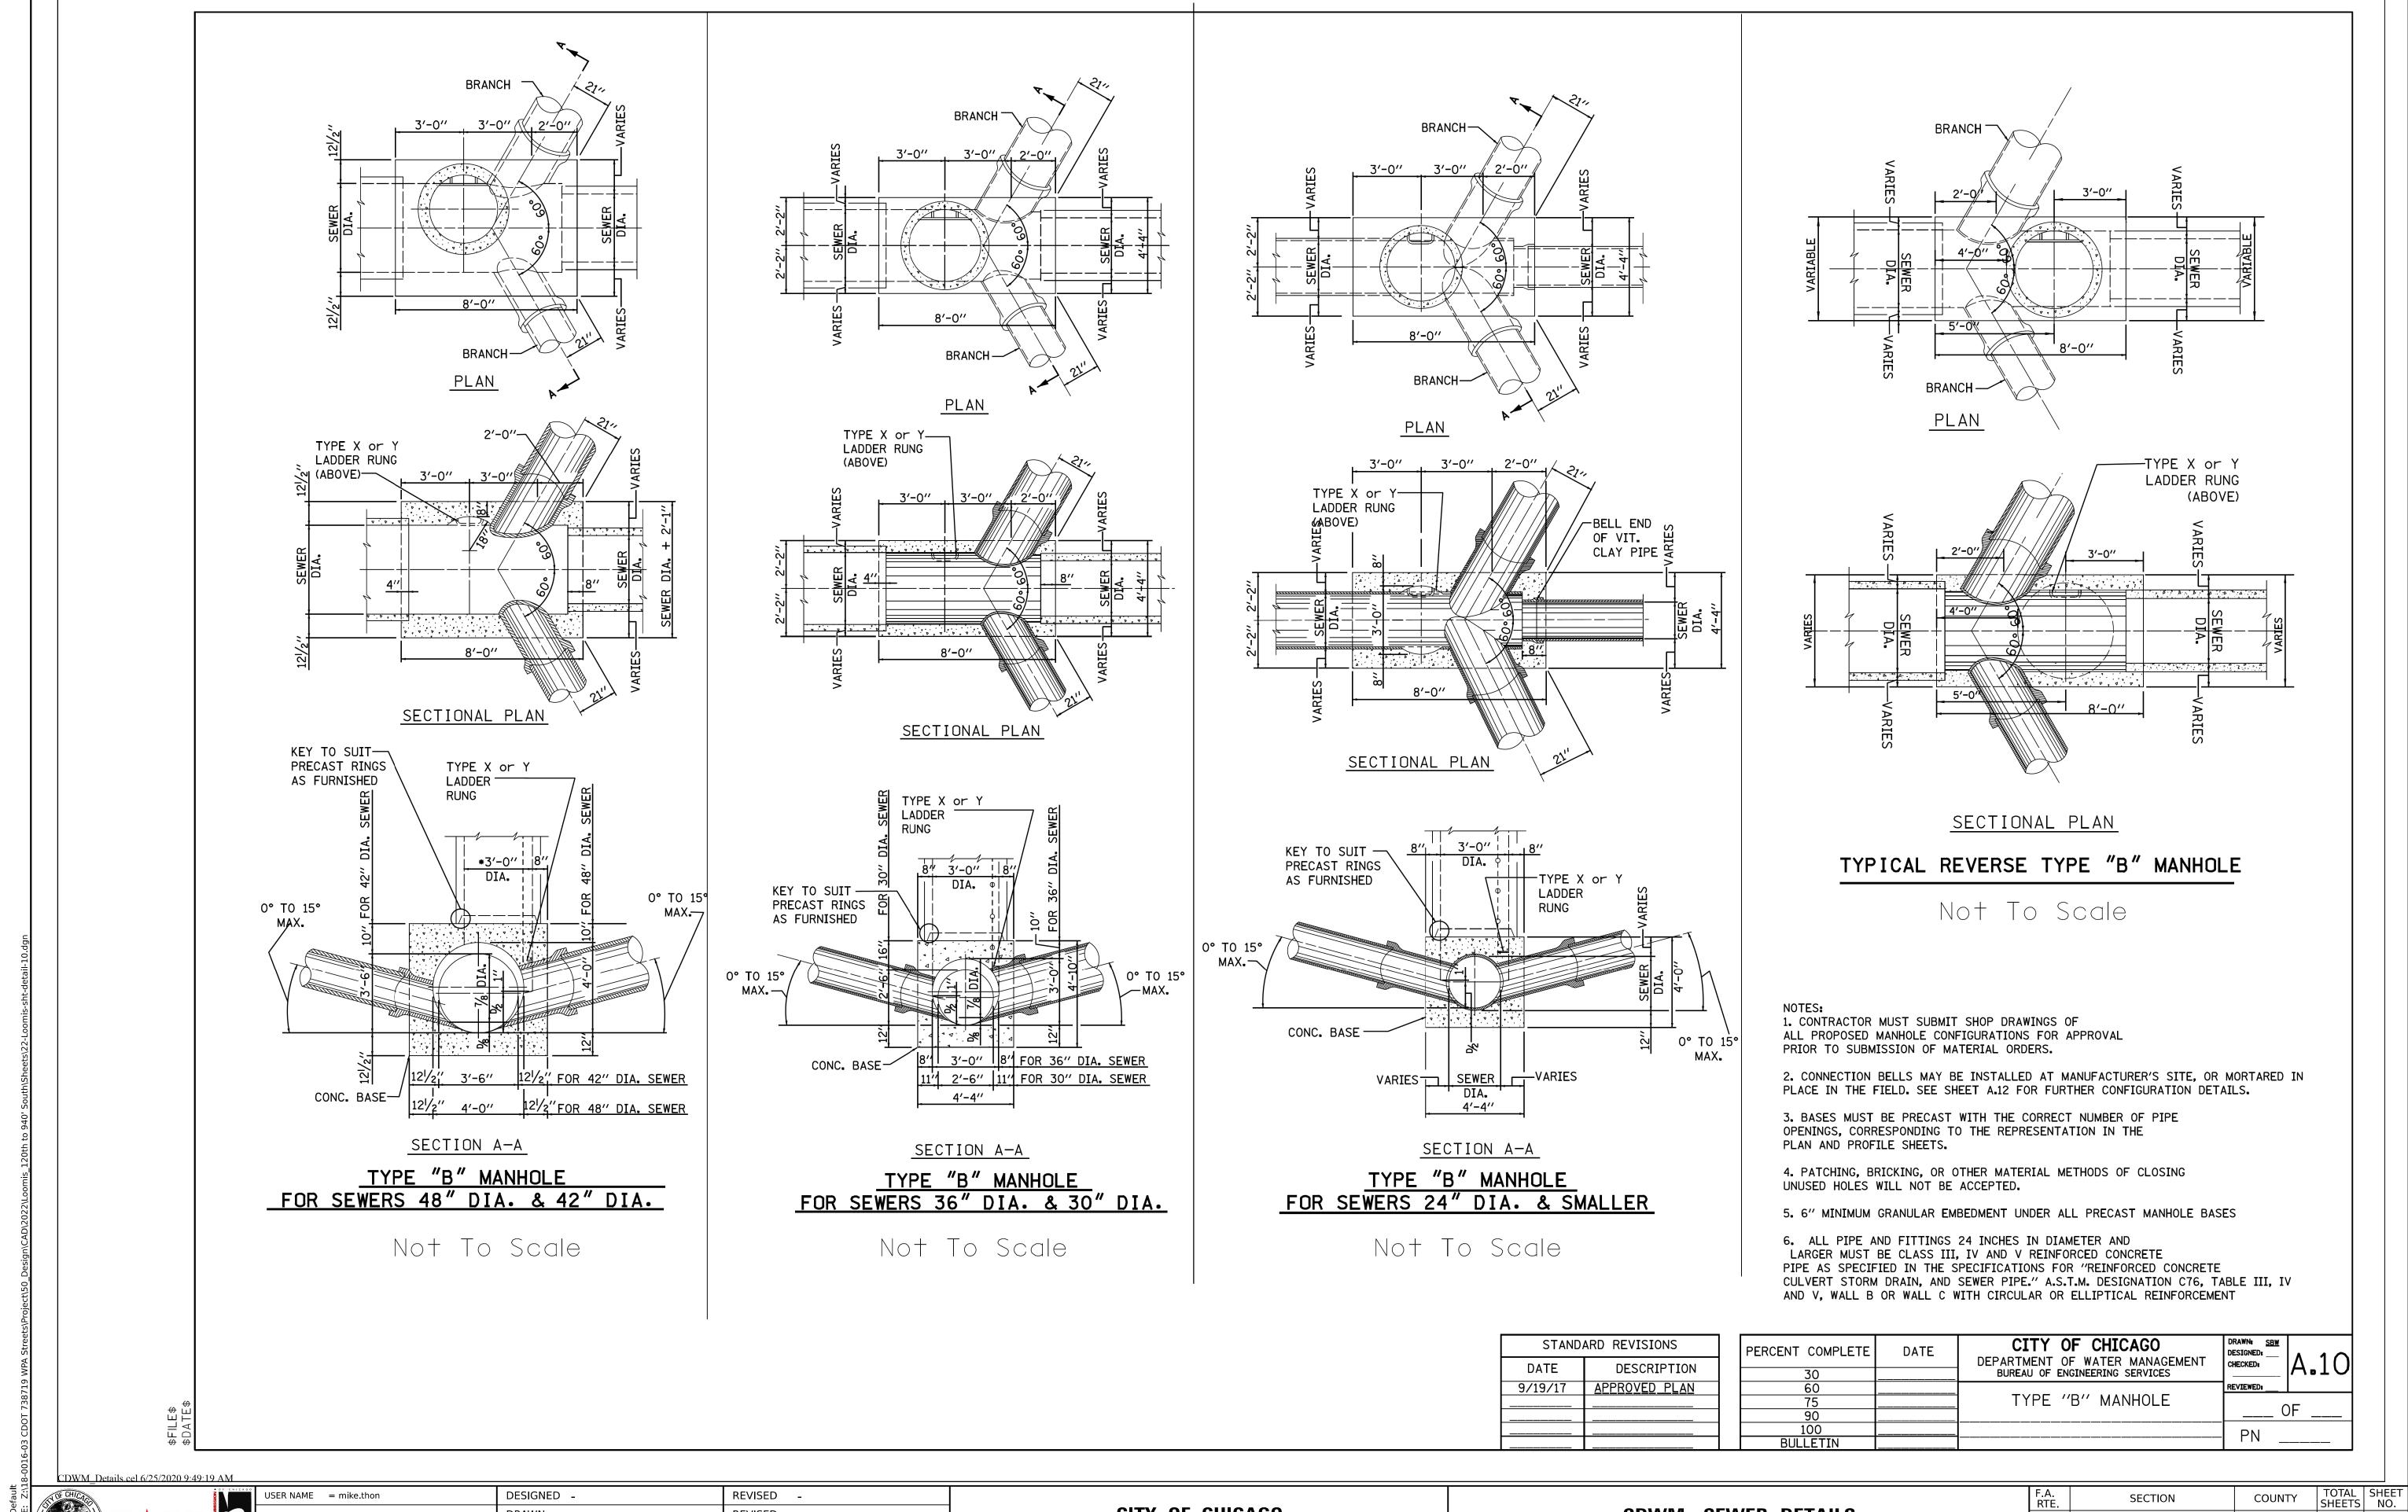

OF CHICAGO

CITY OF CHICAGO
DEPARTMENT OF TRANSPORTATION

SCALE:

CDWM SEWER DETAILS


SHEET 8 OF 22 SHEETS STA. TO STA.

SECTION COUNTY SHEETS NO.

COOK 49 35

CONTRACT NO. C1617

ILLINOIS FED. AID PROJECT

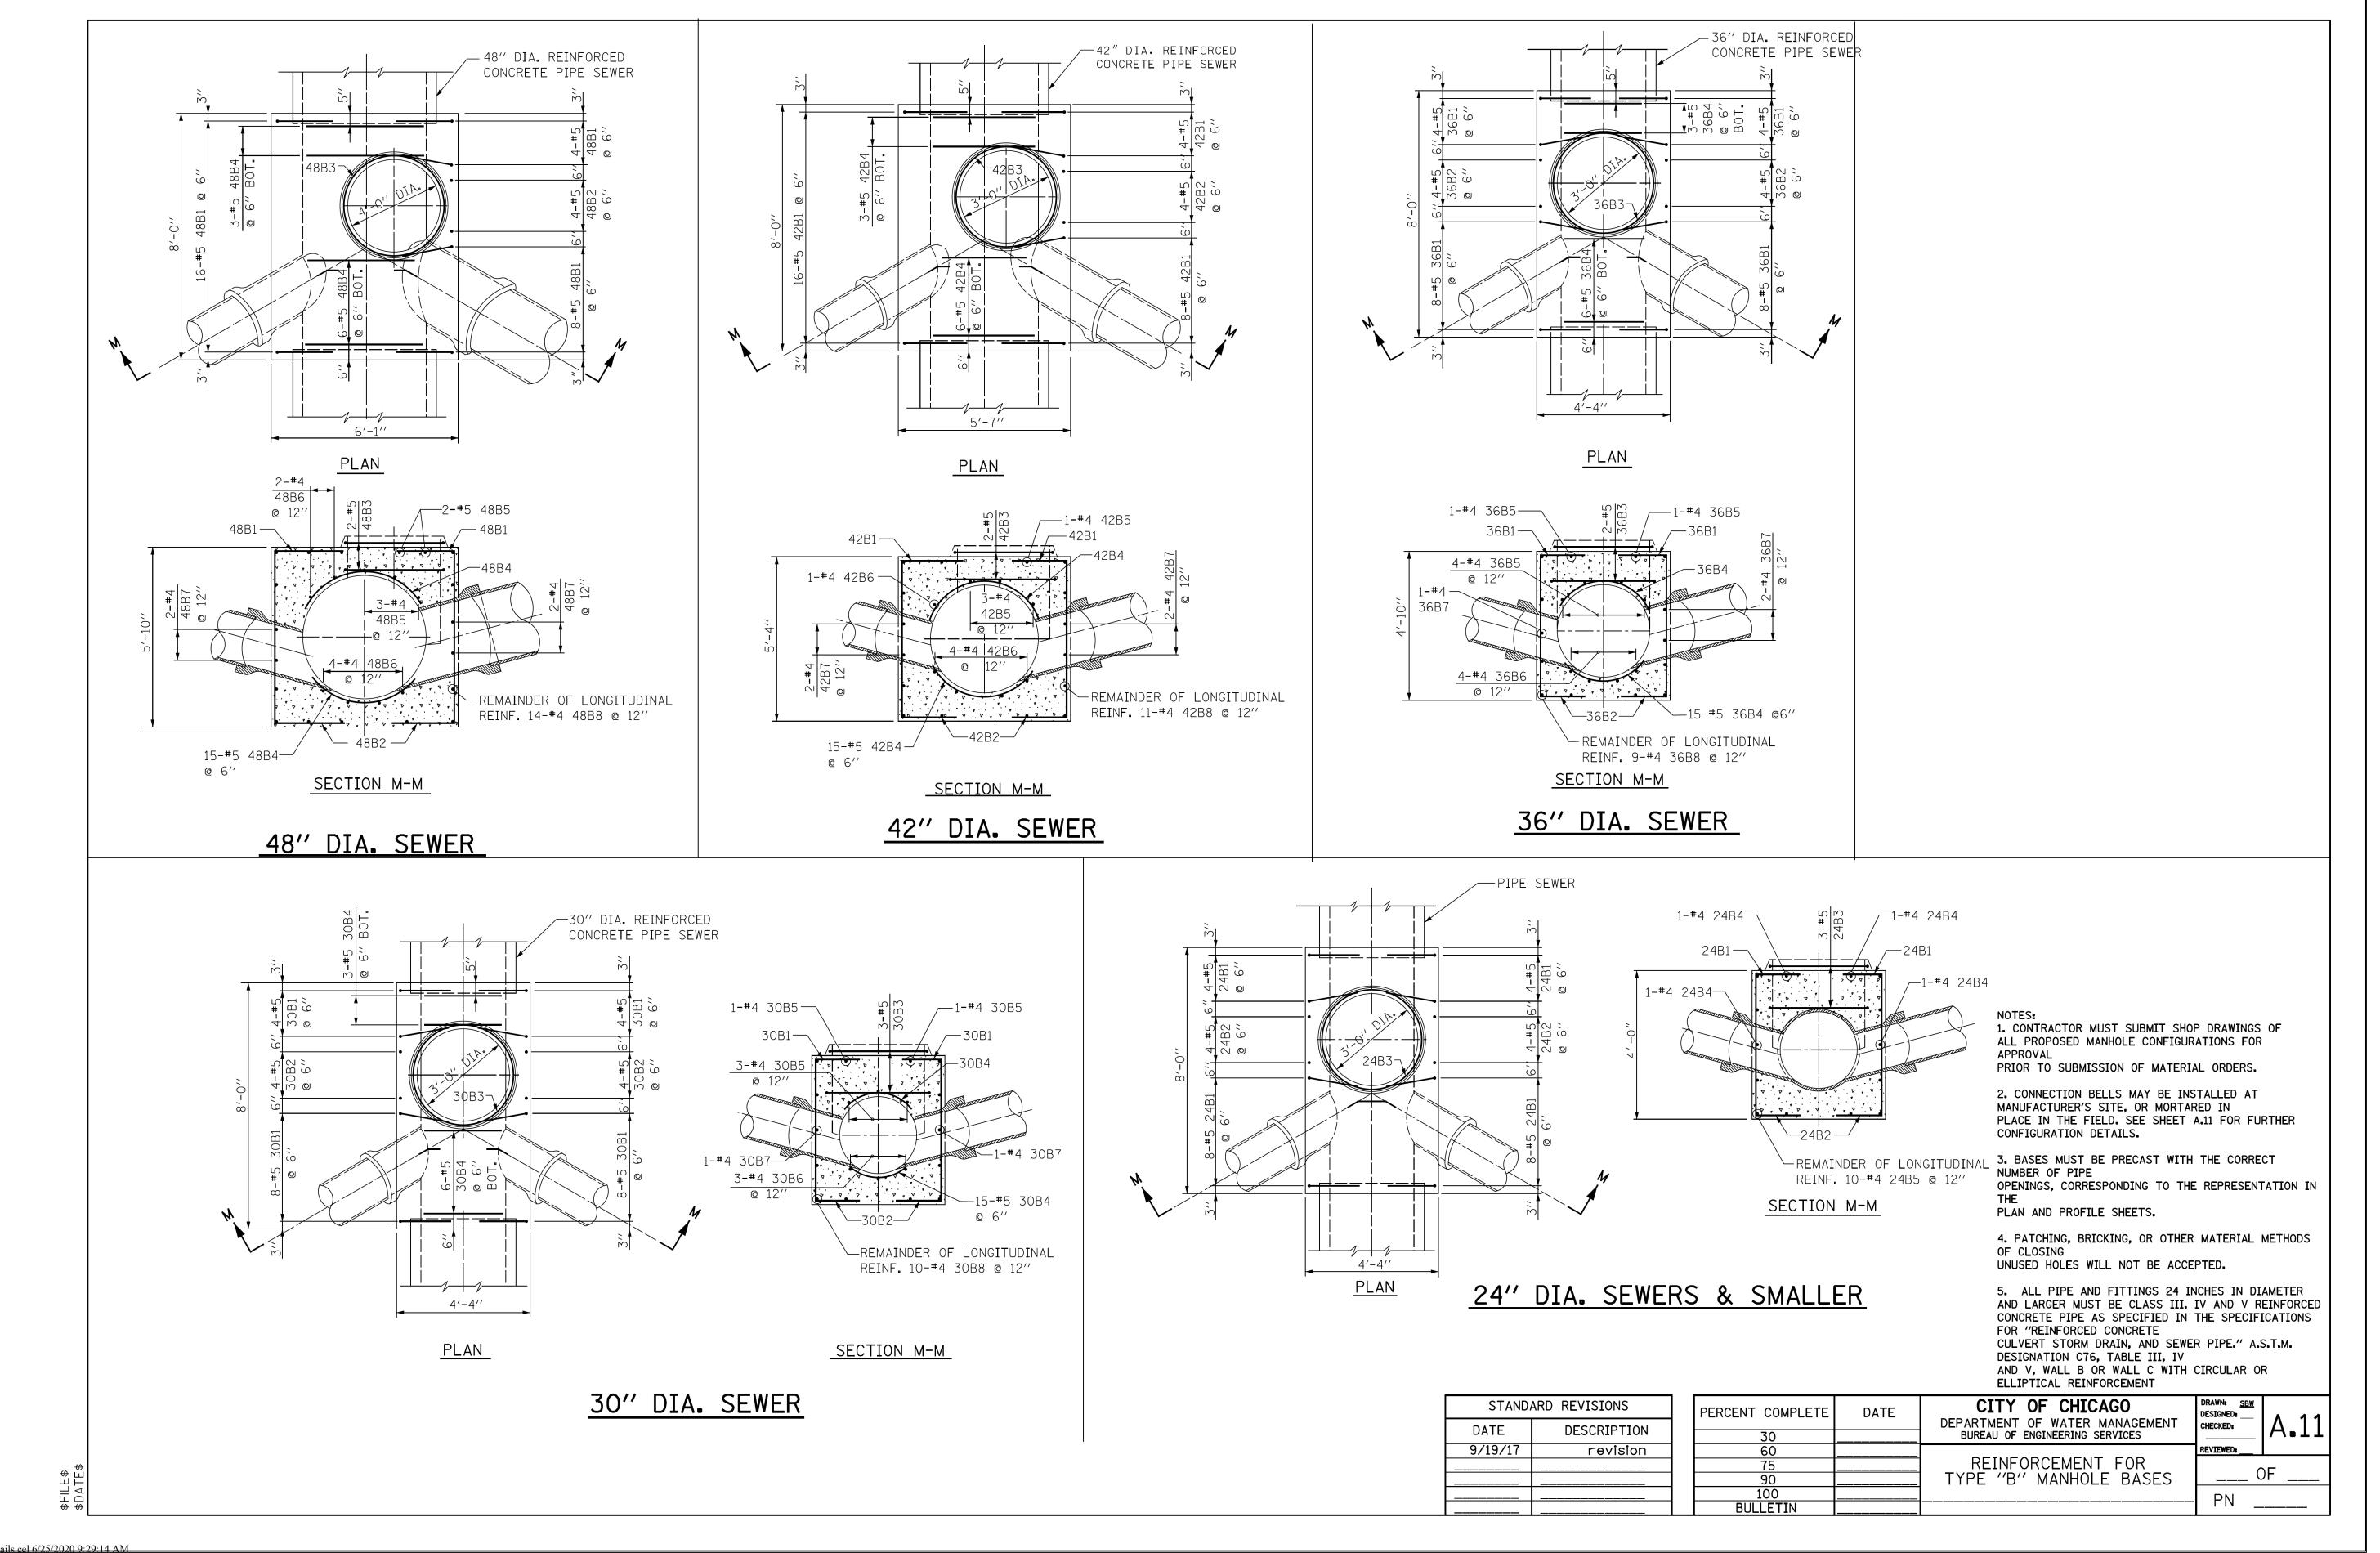

CDOT

 USER NAME
 = mike.thon
 DESIGNED
 REVISED


 PLOT SCALE
 = 10.000 ' / in.
 CHECKED
 REVISED

 PLOT DATE
 = 12/13/2024
 DATE
 12/13/2024
 ISSUED FOR BID
 12/17/2024

CITY OF CHICAGO
DEPARTMENT OF TRANSPORTATION

SCALE:

TYPICAL 4 OPENING TYPE B MANHOLE

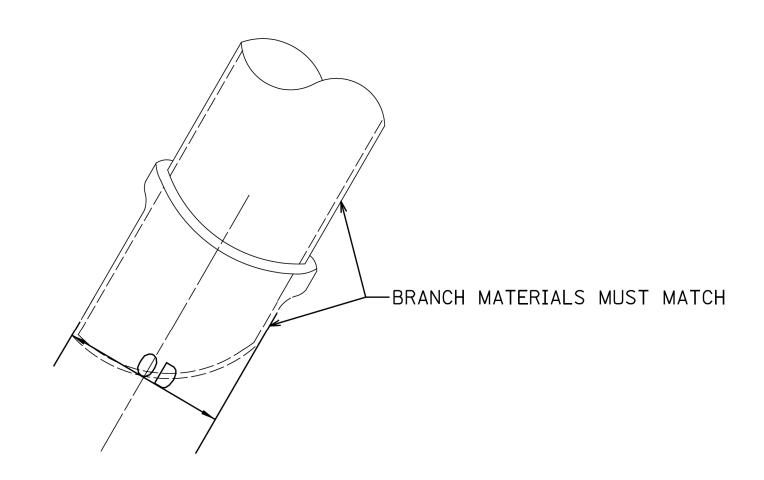

NOTES:

- 1. CONTRACTOR MUST SUBMIT SHOP DRAWINGS OF ALL PROPOSED MANHOLE CONFIGURATIONS FOR APPROVAL PRIOR TO SUBMISSION OF MATERIAL ORDERS.
- 2. CONNECTION BELLS MAY BE INSTALLED AT MANUFACTURER'S SITE, OR MORTARED IN PLACE IN THE FIELD.
- 3. BASES MUST BE PRECAST WITH THE CORRECT NUMBER OF PIPE OPENINGS, CORRESPONDING TO THE REPRESENTATION IN THE PLAN AND PROFILE SHEETS.
- 4. PATCHING, BRICKING, OR OTHER MATERIAL METHODS OF CLOSING UNUSED HOLES WILL NOT BE ACCEPTED.
- 5. ALL PIPE AND FITTINGS 24 INCHES IN DIAMETER AND LARGER MUST BE CLASS III, IV AND V REINFORCED CONCRETE PIPE AS SPECIFIED IN THE SPECIFICATIONS FOR "REINFORCED CONCRETE CULVERT STORM DRAIN, AND SEWER PIPE." A.S.T.M. DESIGNATION C76, TABLE III, IV AND V, WALL B OR WALL C WITH CIRCULAR OR ELLIPTICAL REINFORCEMENT

BRANCH SIZING CHART

ID PIPE (in.)	MATERIAL	OD PIPE (in.)	D max* (in.)
12	VCP	14.36	18.36
15	VCP	17.8	21.8
18	VCP	21.48	25.48
21	VCP	25.54	31.54
8	DIP	9.05	13.05
10	DIP	11.1	15.1
12	DIP	13.2	17.2
14	DIP	15.3	19.3
16	DIP	17.4	21.4
18	DIP	19.5	23.5
20	DIP	21.6	25.6
24	DIP	25.8	29.8
24	RCP III (Wall B)	30	34
27	RCP III (Wall B)	33.5	37.5
30	RCP III (Wall B)	37	41
33	RCP III (Wall B)	40.5	44.5
36	RCP III (Wall B)	44	48
42	RCP III (Wall B)	51	55
48	RCP III (Wall B)	58	62
Notes:			

- 1. If the pipe class and wall size is not shown on this table, then D max =OD pipe + 4"
- *2. Dmax indicates the maximum size of branch opening to be cast or cut into structure.

STANDARD REVISIONS						
DATE	DESCRIPTION					
9/19/17	APPROVED_PLAN					


SCALE:

TYPE ''B'' MANHOLE		PERCENT COMPLETE	DATE	CITY OF CHICAGO DEPARTMENT OF WATER MANAGEMENT BUREAU OF ENGINEERING SERVICES	DRAWN: <u>SBW</u> DESIGNED: CHECKED:	A.12
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				CONFIGURATIONS)F
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CDOT CHICAGO


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			DRAWN	-		REVISED	-		
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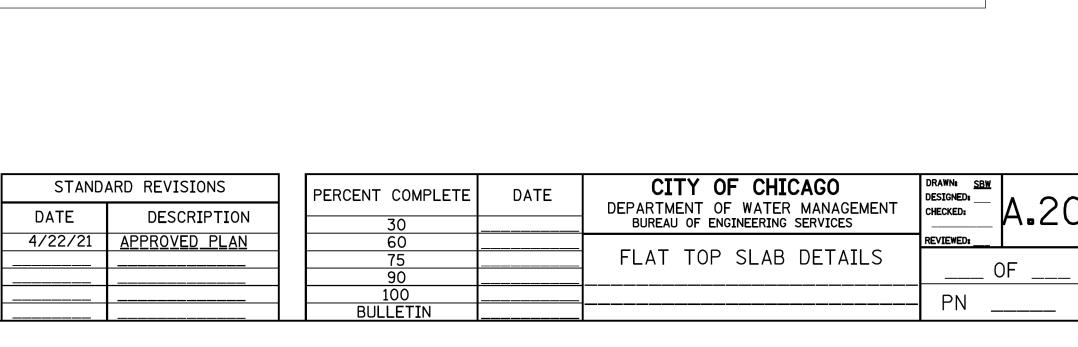
CITY OF CHICAGO
DEPARTMENT OF TRANSPORTATION



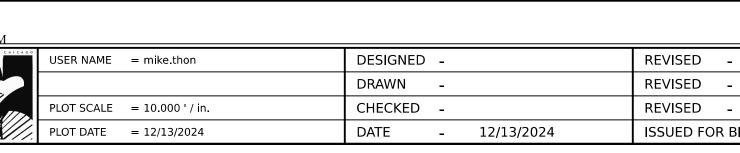


SCALE:



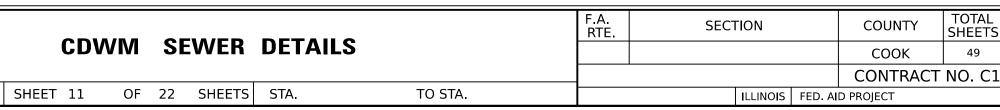

FLAT TOP SLAB AAPLICATION CAN ONLY BE USED WITH WRITTEN PERMISSION FROM CDWM. USE LATEST IDOT DETAIL, #602601-06, AS REFERENCED ON THE IDOT WEBSITE.

FLAT SLAB TOP JOINT CONFIGURATIONS FOR D = 36 (900) AND D = 4'-0" (1.22 m) (Shown at access hole)	See Top Slab Joint Configurations for D=36 (900) and D=4'-0" (1.22 m) T D (Riser)	Bar c #4 (#13), 5'-10" (1.78 m) length, 19½ (495) radius bottom PLAN - FLAT SLAB TOP FOR D = 36 (900)	Bar c #5 (#16), 6'-10" (2.08 m) length, 26 (660) radius bottom
FLAT SLAB TOP JOINT CONFIGURATIONS D = 5'-0" (1.52 m) (Shown at access hole)	See Top Slab Joint Configurations for D=5'-0" (1.52 m) See Top Slab Joint Configurations for D=5'-0" (1.52 m) SECTION THRU FLAT SLAB TOP FOR D = 5'-0" (1.52 m)	(Showing layout of reinforcement bars and c bars) Bar c #4 (#13), 5'-10" (1.78 m) length, 19½ (495) radius bottom #4 (#13) bars bottom. Bundle with closest WWR bar to the opening. PLAN - FLAT SLAB TOP FOR D = 36 (900) (Showing layout of welded wire reinforcement and c bars)	PLAN - FLAT SLAB TOP FOR D = 4'-0" (1.22 m) (Showing layout of reinforcement bars and c bars)
TAE D T 36 (900) 4-0" (1.2 m) 5-0" (1.5 m)		GENERAL NOTES The flat slab top may be used in lieu of the tapered tops shown on Standards 602001, 602016, or 602306 at the option of the Contractor or when field conditions prohibit the use of tapered tops. Lifting holes shall be located in the sections as per the manufacturer's recommendations. All dimensions are in inches (millimeters) unless otherwise shown. PRECAST REINFORCED CONCRETE FLAT SLAB TOP (Shee† 1 of 2) DETAIL	length, 26 (660) radius bottom #5 (#16) bars bottom. Bundle first bar with closest WWR bar to the opening and place second bar ±3 (75) away. PLAN - FLAT SLAB TOP FOR D = 4'-0" (1.22 m) (Showing layout of welded wire reinforcement and c bars) #4 (#13) bars bottom. Bi first bar with closest WW to the opening and place second bar ±3 (75) away.

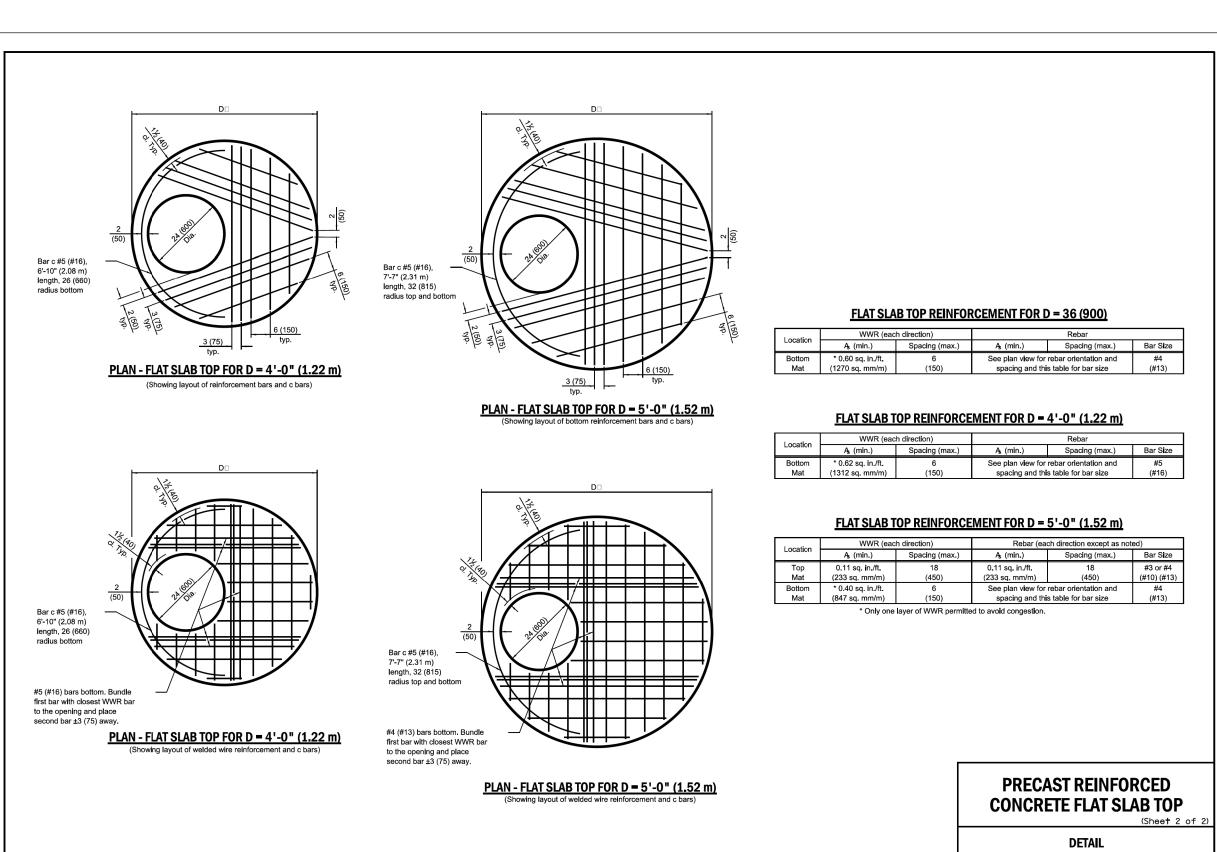

NOTE: ——

TWO DIFFERENT JOINT CONFIGURATIONS TO BE

8" MAX ∕2 RING MAXIMUM

D-See Table Below

STANDARD FLAT TOP SLAB
FOR CATCH BASINS

SEE STEEL DETAILS


USED WHEN COVER LIMITATIONS DICTATE

MODIFICATION

SEE STEEL DETAILS—

REVISED -REVISED -ISSUED FOR BID -12/17/2024

TOTAL SHEET SHEETS NO. 49 38 CONTRACT NO. C1617

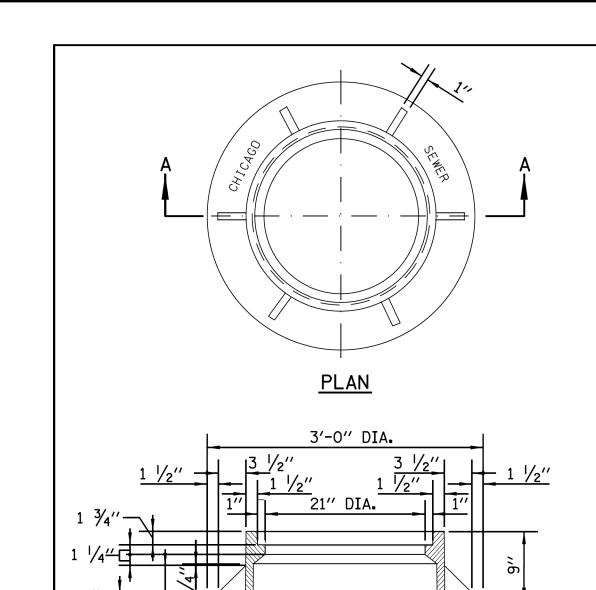


NOTE: METAL PLATES MUST BE FURNISHED FOR PERFORATED LIDS ON MANHOLES.

HEAVYWEIGHT MANHOLE FRAME

2'-0" DIA.

SECTION A-A


MATERIAL: CAST IRON

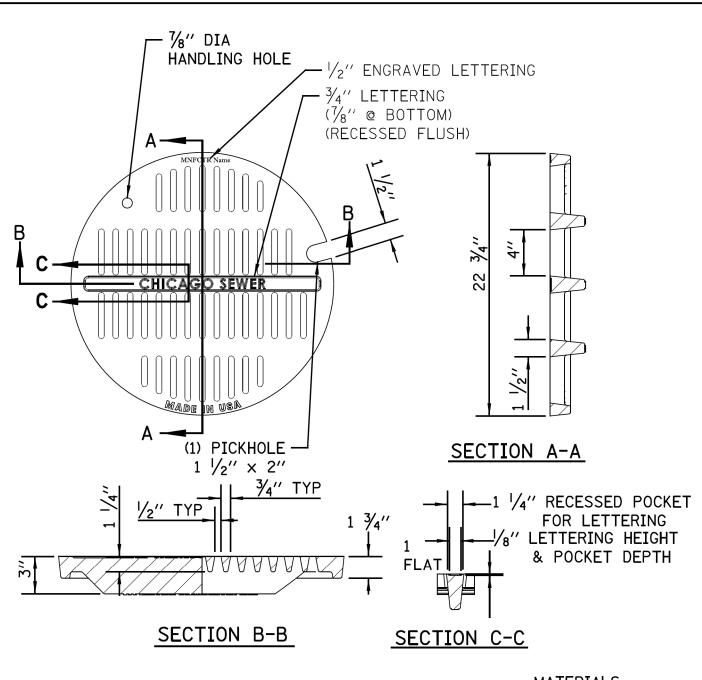

MATERIALS
GRATE-GRAY IRON
ASTM A48 CL35B
DESIGN LOAD
HEAVY DUTY
COATING
UNDIPPED

OPEN AREA 85.6 SQ. IN.

STANDARD CB/MH LID

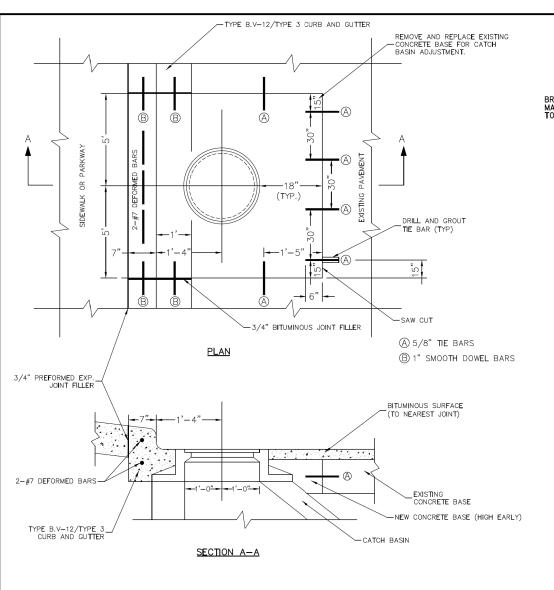


NOTES:

IF THE ADJUSTMENT EXCEEDS AN 8" HEIGHT, THE CONE MUST BE REMOVED AND THE BARREL SECTION MUST BE ADJUSTED.

THE CONTRACTOR IS REQUIRED TO REPLACE ANY BROKEN
FRAMES AND LIDS OF SEWER STRUCTURES WITH STANDARD
FRAMES AND LIDS OF THE DWM. IN ADJUSTMENT OR RECONSTRUCTION OF SEWER STRUCTURES, ANY
NON-STANDARD FRAMES AND LIDS MUST BE REPLACED WITH STANDARD FRAMES AND LIDS. IN
ADJUSTMENT OR RECONSTRUCTION OF INLETS, ANY NON-STANDARD INLETS (GUTTER BOXES) MUST BE
REPLACED WITH DWM STANDARD INLETS.

THE FRAMES AND LIDS OF SEWER STRUCTURES TO BE ABANDONED, REMOVED, OR FILLED MUST BE SALVAGED AND THE DWM NOTIFIED FOR PICK UP.


MANHOLES, CATCH BASINS AND INLETS MUST BE PROTECTED FROM THE ENTRY OF ASPHALT/DEBRIS INTO THE SEWER SYSTEM DURING CONSTRUCTION. THE CONTRACTOR MUST MARK LOCATIONS OF ALL SEWER STRUCTURES ON THE SIDEWALK BEFORE STARTING PAVEMENT REMOVAL/REPLACEMENT. ADJUSTMENT OF FRAMES AND LIDS OF SEWER STRUCTURES MUST BE COMPLETED PRIOR TO STREET RESURFACING.

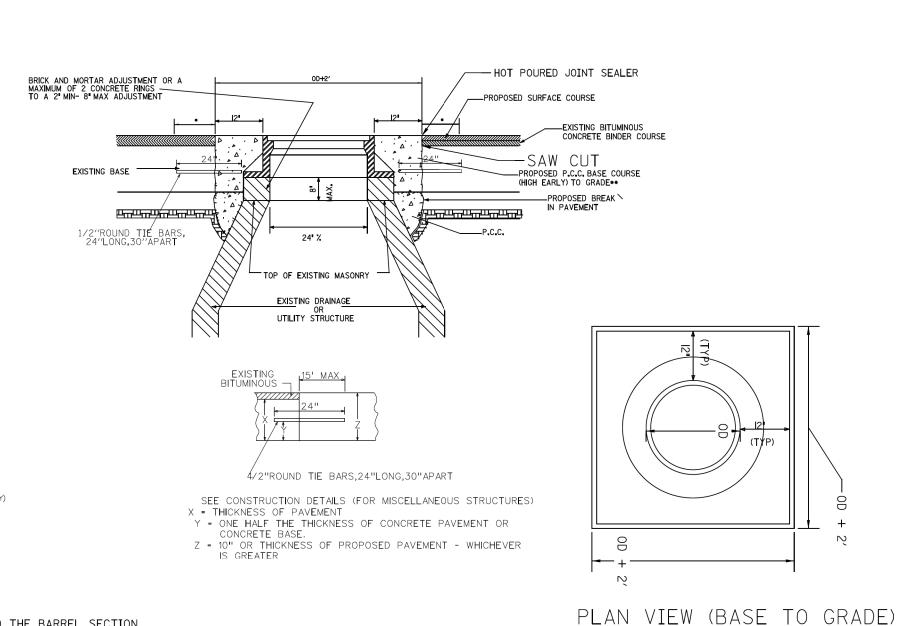


*REFER TO CDOT FOR ASPHALT RESTORATION REQUIREMENTS & CRACK SEALING.

** ON NON-MORATORIUM STREETS, FULL-DEPTH
PCC BASE COURSE MAY BE UTILIZED. ON
MORATORIUM
STREETS, PAVEMENT RESTORATION SHALL ADHERE T
CDOT REQUIREMENTS.

DETAIL OF FRAME ADJUSTMENT

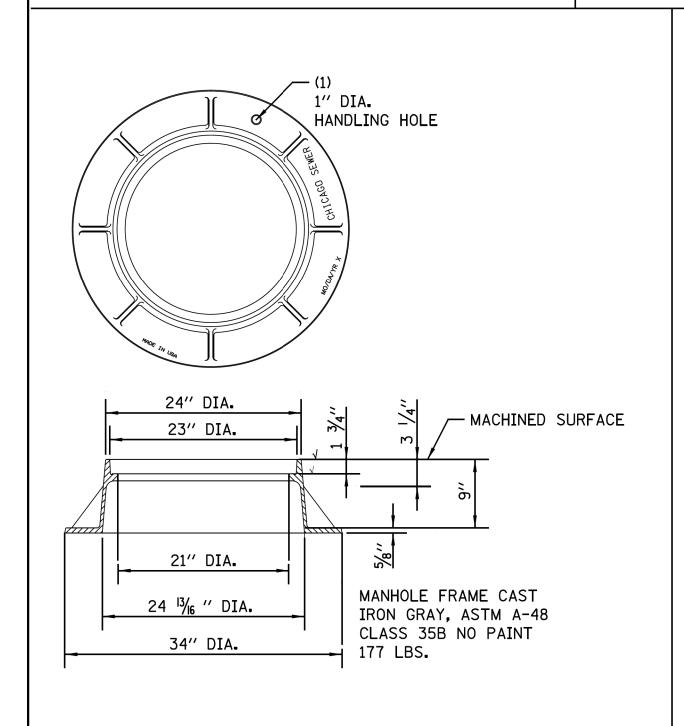




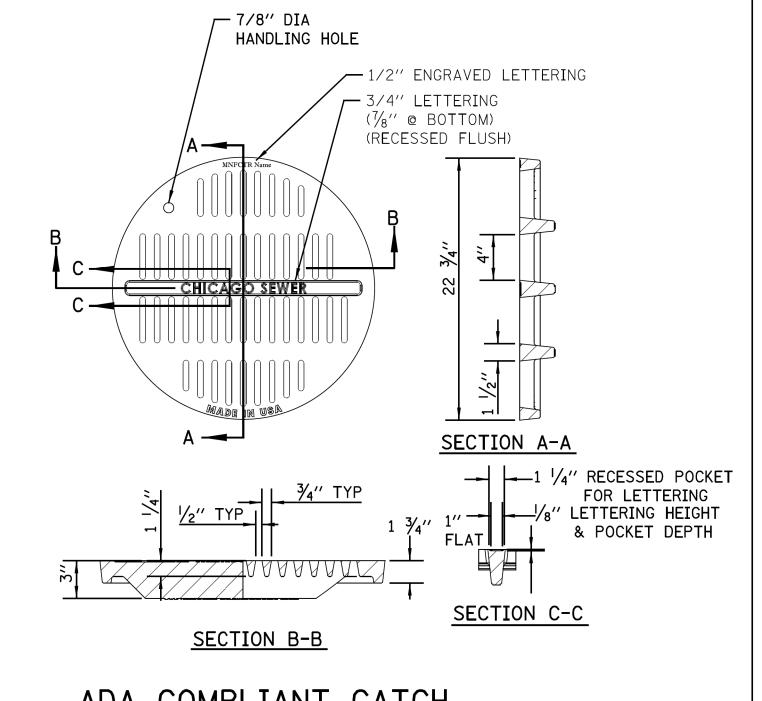

ADA COMPLIANT CATCH
BASIN/MANHOLF LID

NOTE: NOT TO BE USED WITHOUT PRIOR APPROVAL OF CDWM MATERIALS
GRATE-GRAY IRON
ASTM A48 CL35B
DESIGN LOAD
HEAVY DUTY
COATING
UNDIPPED
OPEN AREA
85.6 SQ. IN.

SOLID LID FOR MANHOLES

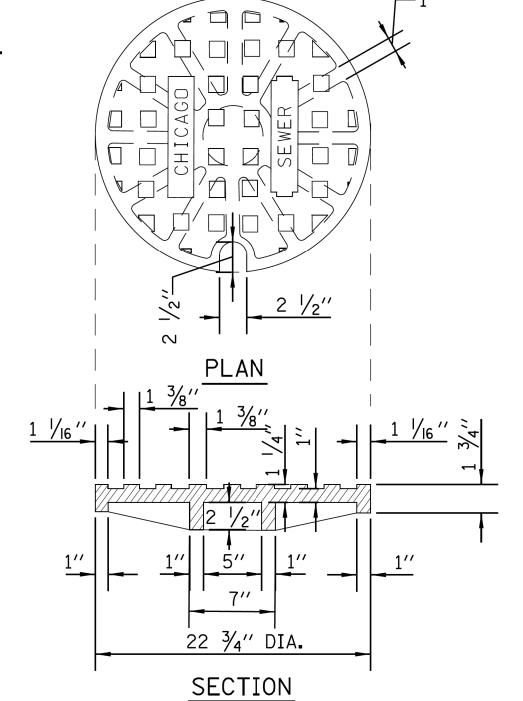

STANDARD REVISIONS						
DATE	DESCRIPTION		_			
2/5/21	Approved					

SCALE:

PERCENT COMPLETE	DATE	CITY OF CHICAGO DEPARTMENT OF WATER MANAGEMENT	DRAWN: SBW DESIGNED: CHECKED:	Δ 21
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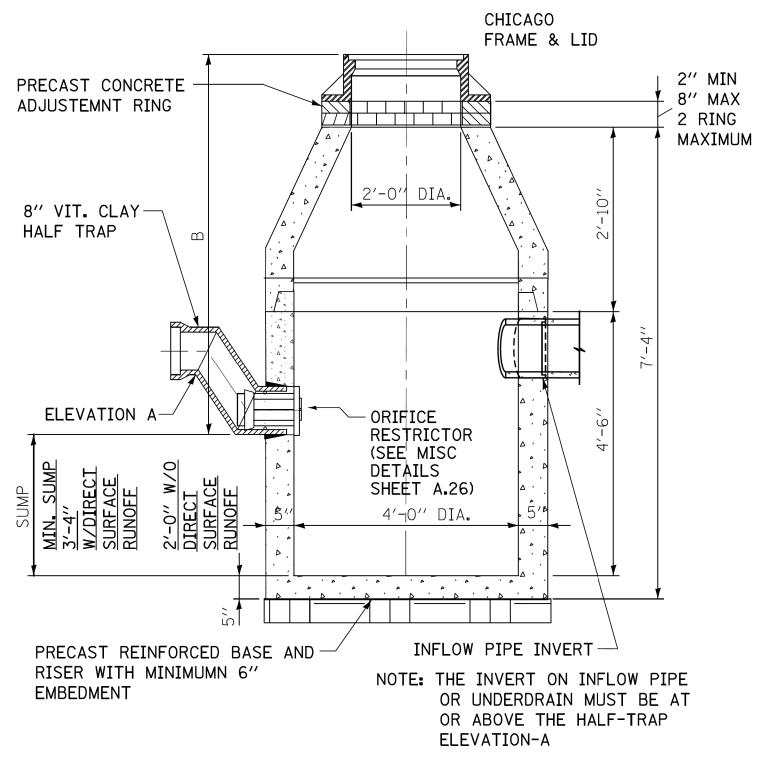
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	PLOT DATE	= 12/13/2024	DATE	-	12/13/2024	ISSUED FOR	BID .	-	12/17/2024

						F.A. RTE.	SEC	ΓΙΟΝ		COUNTY	TOTAL SHEETS	SHEET NO.
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STANDARD DRAINAGE STRUCTURES FOR PUBLIC STREETS #5 DOWEL BAR @ -/- TYPE B CURB & GUTTER CONSTRUCTION JOINT TYPE B-V.12 Per CDOT Details CURB AND GUTTER_ Note: Positive Summit — Per CDOT Details /— 1/2" ROUND TIE BARS for Drainage 30" LONG, 30" C/C CHICAGO 4" MAXIMUM (TYP) Note: Positive Summit — FRAME & LID CHICAGO for Drainage FRAME & LID —4" MAXIMUM(TYP)− 2" MIN PRECAST 8" MAX CONCRETE 2 RING MAXIMUM PRECAST-8" VIT. CLAY, ADJUSTEMNT CONCRETE ADJUSTEMNT 1' VERTICAL HALF TRAP 2" MIN RING 8" MAX 2'-0" DIA. 2 RING 8" VIT. CLAY,— 2'-0" DIA. MAXIMUM PRECAST 1' VERTICAL REINF. CONC. HALF TRAP OFFSET CONE REINF. CONC. OFFSET CONE -SWIRL CHAMBER VORTEX or ORIFICE VORTEX or ORIFICE RESTRICTOR RESTRICTOR (SEE MISC DETAILS (SEE MISC DETAILS SHEET A.26) SHEET A.26) 4'-0" DIA. 3'-0" DIA. PRECAST REINFORCED BASE AND — PRECAST REINFORCED BASE AND— RISER WITH MINIMUMN 6" EMBEDMENT RISER WITH MINIMUMN 6" EMBEDMENT STANDARD CATCH BASIN-4' DIA. STANDARD CATCH BASIN-3' DIA.

STANDARD DRAINAGE STRUCTURES FOR PUBLIC ALLEYS



CATCH BASIN-ORIFICE RESTRICTOR

N.T.S.

GENERAL NOTES:

1. CATCH BASIN TO CATCH BASIN CONNECTIONS ARE ALLOWED IN PRIVATE SITES & ALLEYS. ONLY THE DOWNSTREAM CATCH BASIN IS REQUIRED TO HAVE A HALF-TRAP.

2. IF B < 4 FEET, THEN USE A FLAT TOP SLAB CATCH BASIN AS NECESSARY.

3. FOR TRENCH BACKFILL, REFER TO IDOT SSRBC, ARTICLE 1003.04.

4. FOR GRANULAR EMBEDMENT, USE CA-11, CRUSHED GRAVEL, CRUSHED STONE, OR CRUSHED CONCRETE.

5. FOR STABILIZATION STONE, 12" OF CA-1 STONE IS ONLY REQUIRED WHEN UNSTABLE MATERIAL IS ENCOUNTERED AT TRENCH BOTTOM.

6. INLETS AND 3' DIAMETER CATCH BASINS ARE TO BE USED ONLY WITH PRIOR APPROVAL OF THE DEPT OF WATER MANAGEMENT- ENGINEERING SERVICES, SEWER SECTION, AND THE DEPT. OF BUILDINGS STORMWATER REVIEWER.

7. IF COVER OVER VCP IS LESS THAN 3', USE 45 DEGREE DIP BENDS WITH 1 FOOT DROP AS HALF TRAPS AS NEEDED FOR IEPA CLEARANCE REQUIREMENTS

SCALE:

STANDARD REVISIONS						
DATE	DESCRIPTION					
2/5/21	APPROVED					

PERCENT COMPLETE	DATE	CITY OF CHICAGO DEPARTMENT OF WATER MANAGEMENT	DRAWN: <u>SBW</u> DESIGNED: CHECKED:	Δ 22
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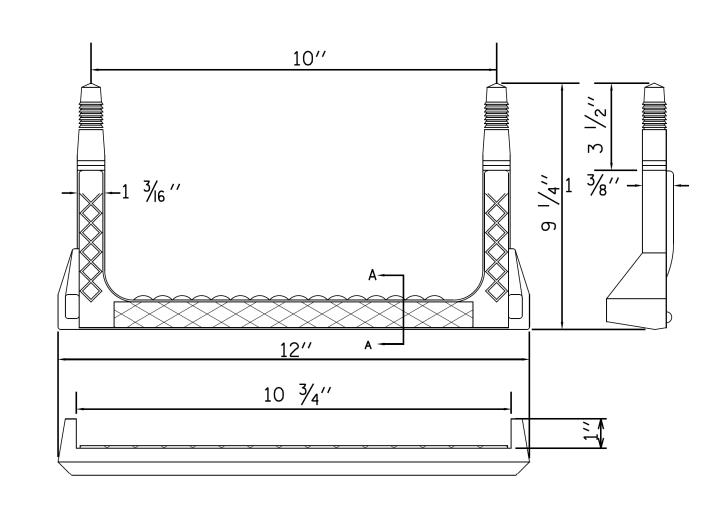
CHICAGO STANDARD MANHOLE FRAME AND PERFORATED LID CURB & GUTTER 3" MAXIMUM* (TYPICAL) *⊢*2′′ R 24" DIA. -MORTAR **PRECAST** 2'-0'' DIA. CONCRETE A RING DUCTILE #5 @¬ IRON PIPE <u>PLAN</u> -8" DUCTILE IRON (FRAME & LID NOT SHOWN) PIPE MUST BE 6" MIN. GRANULAR-USED FOR EMBEDMENT UNDER CONNECTION TO ALL INLETS REINFORCED CONCRETE — CATCH BASIN. PIPE TO BE LAID BASE CAST AS INTEGRAL STANDARD INLET-2' DIA. PART OF 24" DIA. ON A MINIMUM PRECAST CONCRETE RING GRADE OF 1%

SFILE\$ SDATF\$


*CDOT

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	PLOT DATE = 12/13/2024	DATE	-	12/13/2024	ISSUED FO	R BID	-	12/17/2024

					D== 4.11.6		F.A. RTE.	SEC	TION		COUNTY	TOTAL SHEETS	SHEET NO.
CDWM SEWER DETAILS						COOK	49	40					
	Г										CONTRACT	NO. C1	617
	SHEET 13	OF	22	SHEETS	STA.	TO STA.			ILLINOIS	FED. All	D PROJECT		





COPOLYMER POLYPROPYLENE PLASTIC

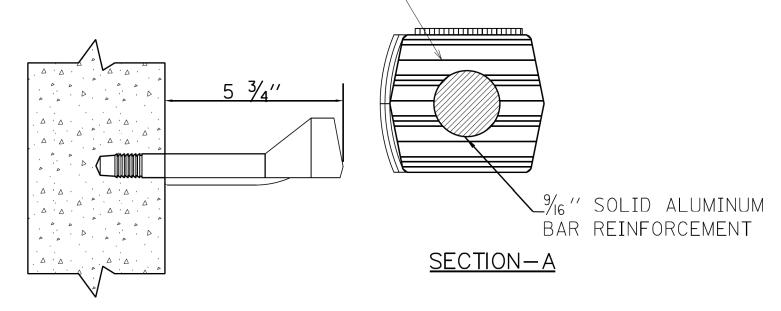


RECTANGULAR STEP LADDER RUNG

FOR USE ONLY IN 48" DIAMETER AND LARGER MANHOLES.

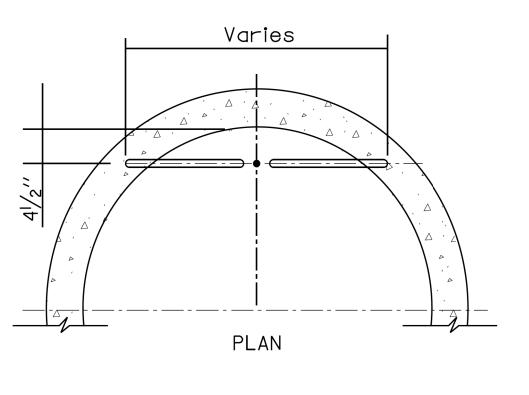

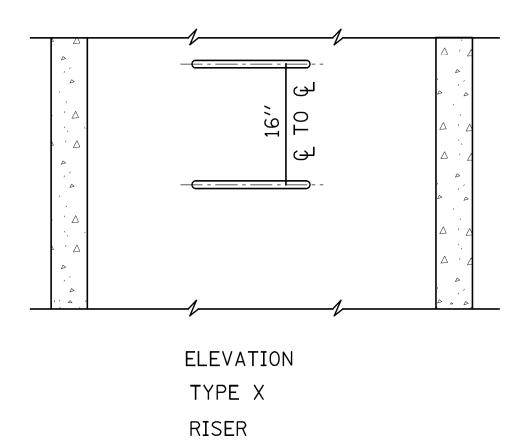

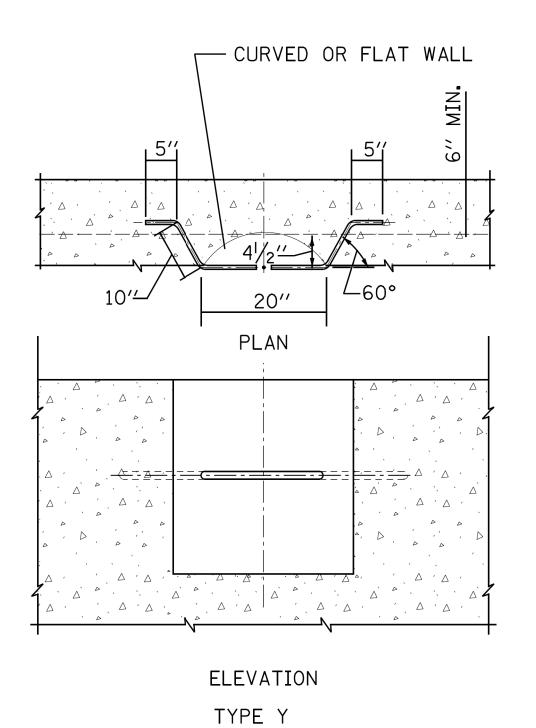

NOTES:

1. VERTICAL SPACING = 16" O.C., ON VERTICAL WALL ONLY.

BASE

- 2. STEPS SHALL MEET THE REQUIREMENTS OF ASTM C478 IN ADDITION TO A HORIZONTAL PULL-OUT LOAD OF 1000 LBS. WHEN INSTALLED.
- 3. ALL STEPS SHALL BE VERTICALLY ALIGNED IN A STRAIGHT LINE.
- 4. MINIMUM CONCRETE STRENGTH MUST BE 3000 PSI
- 5. HOLES- PREFORMED/DRILLED

 A. HOLES MUST BE PARALLEL

 B. HOLES MUST BE 10" CENTERED, 1" DIAMETER

 C. MINIMUM DEPTH- 3 1/2" TO 3 3/4"

STAND	ARD REVISIONS
DATE	DESCRIPTION
5/8/17	APPROVED_PLAN

SCALE:


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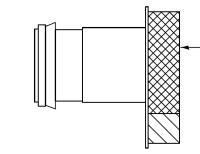
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DRAINAGE STRUCTURES RESTRICTORS



—ORIFICE RESTRICTOR

INSERT THE RESTRICTOR INTO THE HALF-TRAP. UPON TIGHTENING OF THE CENTER NUT ON THE FACE OF THE RESTRICTOR, THE RUBBER O-RINGS WILL EXPAND INSIDE THE HALF TRAP, PROVIDING A WATER- TIGHT SEAL. PULL ON RESTRICTOR TO VERIFY THAT A TIGHT FIT IS MADE.

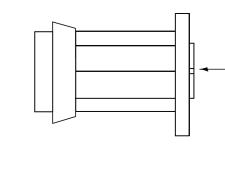

-- VORTEX RESTRICTOR

PULL ON RESTRICTOR TO VERIFY THAT A TIGHT FIT IS MADE.

INSERT THE RESTRICTOR WITH THE OPENING DOWN. UPON TIGHTENING OF THE 2 BOLTS ON THE FACE OF THE RESTRICTOR, THE RUBBER O-RINGS WILL PROVIDE A WATER- TIGHT SEAL.

GENERAL NOTES:

1. CATCH BASIN TO CATCH BASIN CONNECTIONS ARE ALLOWED IN PRIVATE SITES & ALLEYS. ONLY THE DOWNSTREAM CATCH BASIN IS REQUIRED TO HAVE A HALF-TRAP.

2. IF B < 4 FEET, THEN USE A DUCTILE IRON PIPE HALF TRAP AND FLAT TOP SLAB CATCH BASIN AS NECESSARY.

3. INLETS AND 3' DIAMETER CATCH BASINS ARE TO BE USED ONLY

RESTRICTOR NOTES:

THE DWM'S RAIN BLOCKER RESTRICTOR PROGRAM MUST BE MAINTAINED WITH ANY ROADWAY IMPROVEMENT.


WITH PRIOR APPROVAL OF DWM FIELD INSPECTOR.

THE DESIGN OF ANY ROADWAY IMPROVEMENT MUST CONSIDER LIMITING THE NUMBER OF CATCH BASINS TO THE EXTENT PRACTICAL. THE NUMBER OF EXISTING STRUCTURES SHOULD NOT BE INCREASED.

THE RESTRICTORS CAN BE OBTAINED FROM DWM CENTRAL DISTRICT AT 3901 S. ASHLAND AVE. THE CONTRACTOR SHOULD ARRANGE FOR PICK UP BY CONTACTING 312-747-8736 (7AM TO 3PM, M-F). CONTRACTOR MUST CALL 48 HOURS IN ADVANCE OF PICK UP DATE AND TIME.

FLOW RESTRICTORS MUST BE INSTALLED IN ALL CATCH BASINS OUTSIDE OF THE CENTRAL BUSINESS DISTRICT(LIMITS: NORTH AVE, CERMAK AVE, HALSTED AVE, LAKE MICHIGAN). RESTRICTORS MUST NOT BE INSTALLED IN CATCH BASINS IN CLOSE PROXIMITY TO VIADUCT AREAS, BUS STOPS, OR EMERGENCY ENTRANCES. THE DWM MUST APPROVE THE NON-INSTALLATION OR REMOVAL OF ANY RESTRICTOR. REQUIREMENTS FOR RESTRICTOR INSTALLATION ARE AS FOLLOWS:

*ARTERIAL STREETS: 3-INCH ORIFICE RESTRICTOR
*BUS ROUTES: 3-INCH ORIFICE RESTRICTOR
*RESIDENTIAL STREETS: 3-INCH VORTEX RESTRICTOR
*ALLEYS: 3-INCH ORIFICE RESTRICTOR IN THE LAST CB.
*CLOSED LIDS ARE REQUIRED ON ALL MANHOLES EXCEPT
AT INTERSECTIONS WHERE A PERFORATED LID SHALL BE

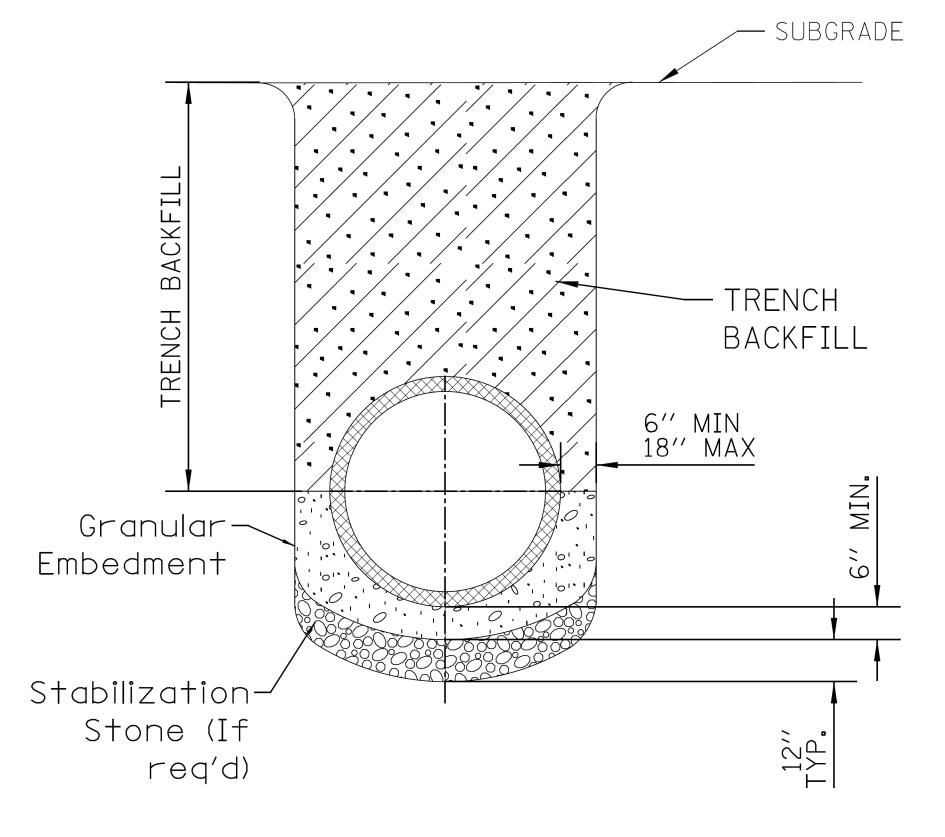


NOTE:
1. FOR TRENCH BACKFILL, REFER TO IDOT SSRBC, ARTICLE
1003.04.

- 2. FOR GRANULAR EMBEDMENT, USE CA-11, CRUSHED GRAVEL, CRUSHED STONE, OR CRUSHED CONCRETE.
- 3. FOR STABILIZATION STONE, 12" OF CA-1 STONE IS ONLY REQUIRED WHEN UNSTABLE MATERIAL IS ENCOUNTERED AT TRENCH BOTTOM.
- 4. AGGREGATE PLACED FOR TEMPORARY SURFACE RESTORATION WILL NOT BE PAID SEPARATELY AND SHALL BE INCIDENTAL TO THE CONTRACT.

SEWER TRENCH DETAIL

NOTE:
PLUG TO BE COATED WITH MORTAR AND
DRIVEN INTO PLACE WITH A WOODEN
MALLET AND THEN SEALED WITH MORTAR.

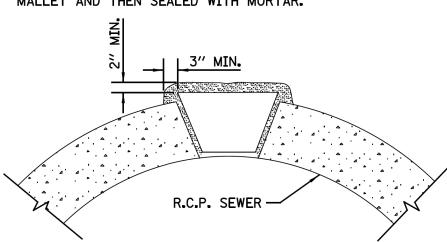

LIFTING HOLE PLUG DETAIL FOR CONCRETE PIPE

NOTE:

1. ALL PLUG MATERIALS MUST COMPLY WITH

1042.16 OF THE IDOT SSRBC.

2. LIFT HOLES ON COMBINED SEWERS ARE PROHIBITED WHEN THE WATER TABLE IS WITHIN 2 FEET OF THE PIPE INVERT, OR IF THE PIPE IS FULLY SUBMERGED UNDER NORMAL CONDITIONS.

TO STA.

	<u> </u>							
STANDARD REVISIONS								
DATE	DESCRIPTION							
2/5/21	APPROVED PLAN							

SCALE:

	PERCENT COMPLETE	DATE	CITY OF CHICAGO DEPARTMENT OF WATER MANAGEMENT BUREAU OF ENGINEERING SERVICES DRAWN: DESIGNEI CHECKED: GD. GC.		A ₋ 26
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CITY OF CHICAGO
DEPARTMENT OF TRANSPORTATION

CDWM	SEWER	DETAILS	


SHEET 15 OF 22 SHEETS STA.


SECTION


COUNTY
TOTAL SHEETS NO.

COOK 49 42


CONTRACT NO. C1617

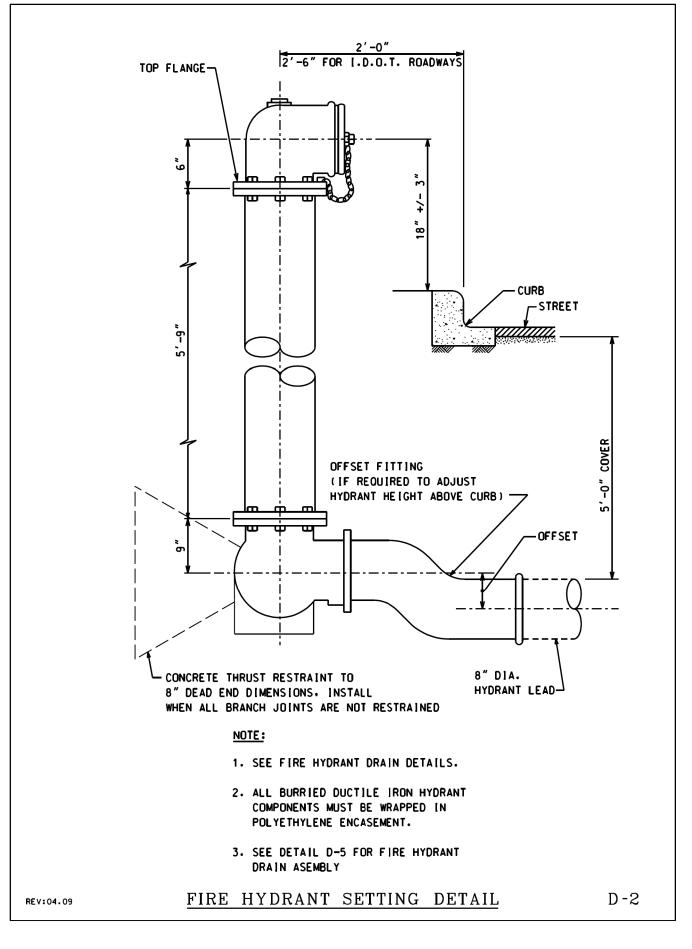


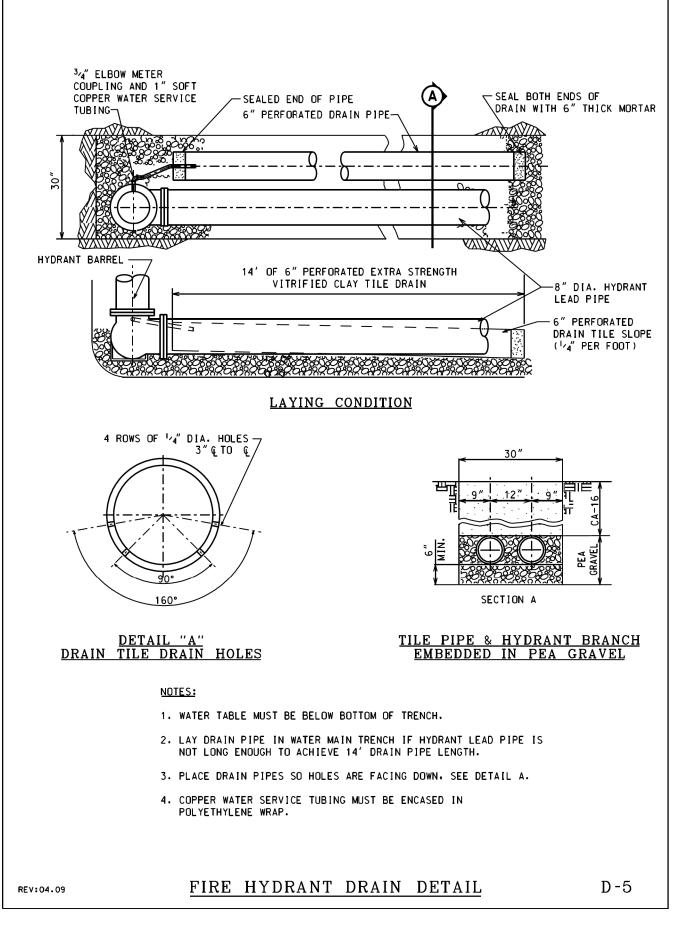


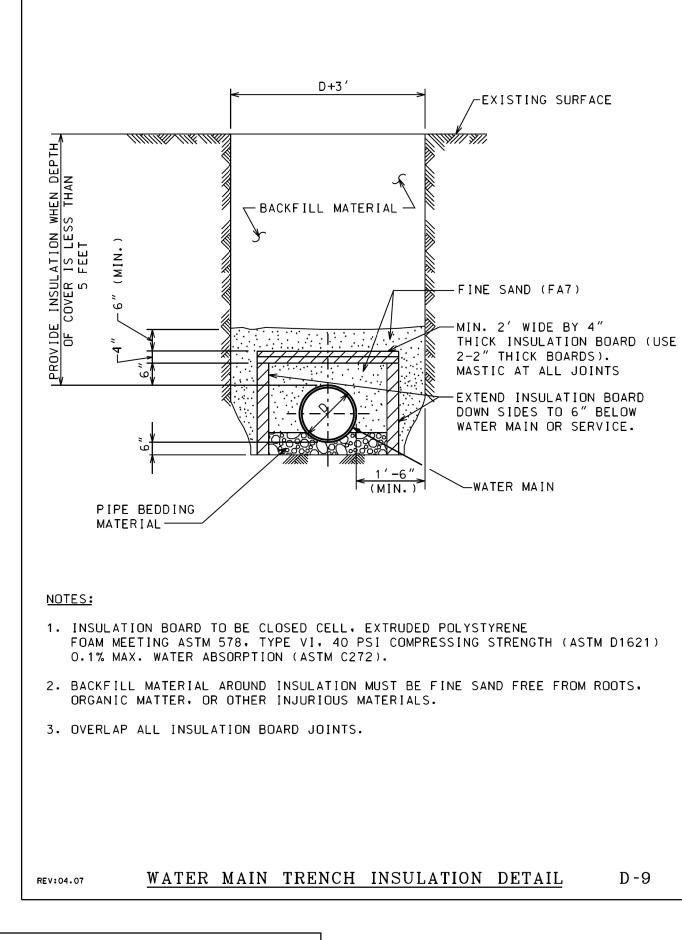


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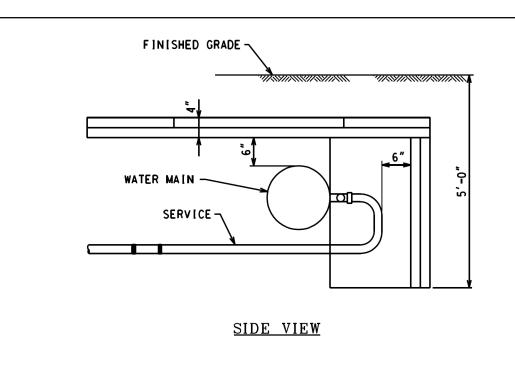


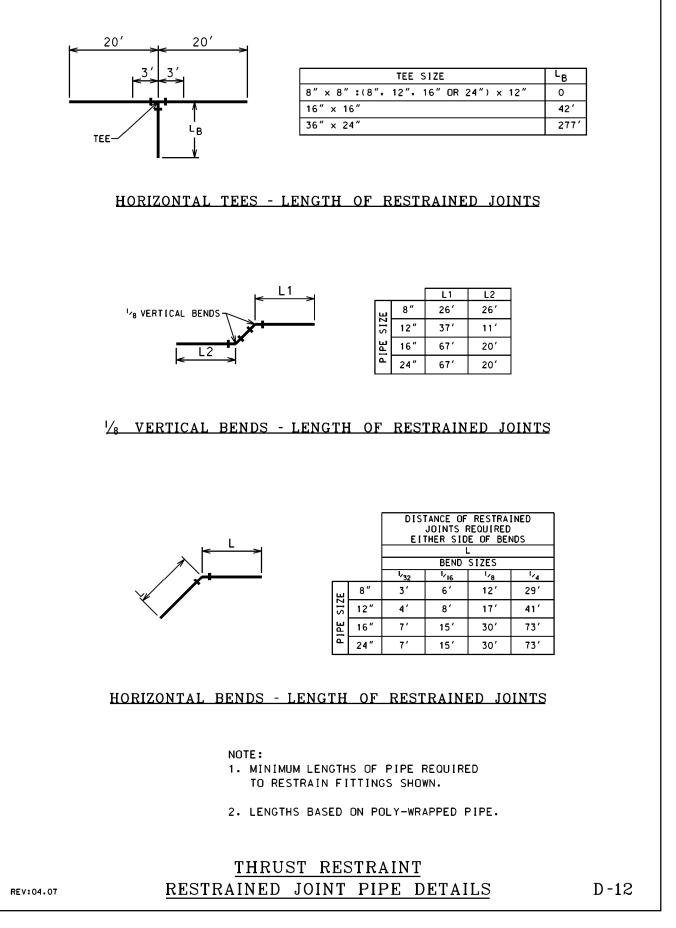


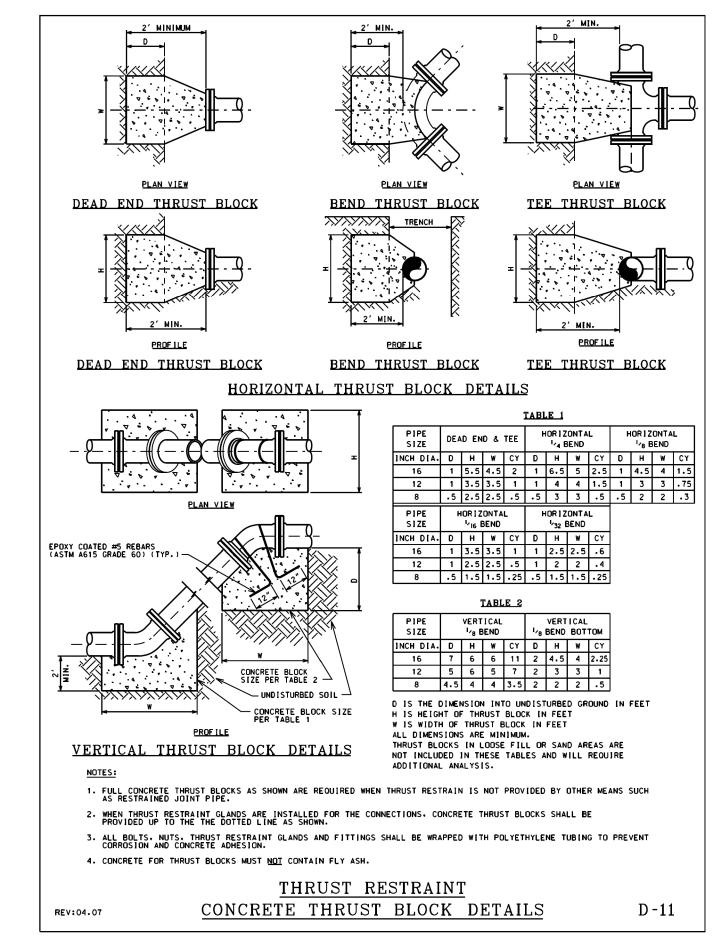
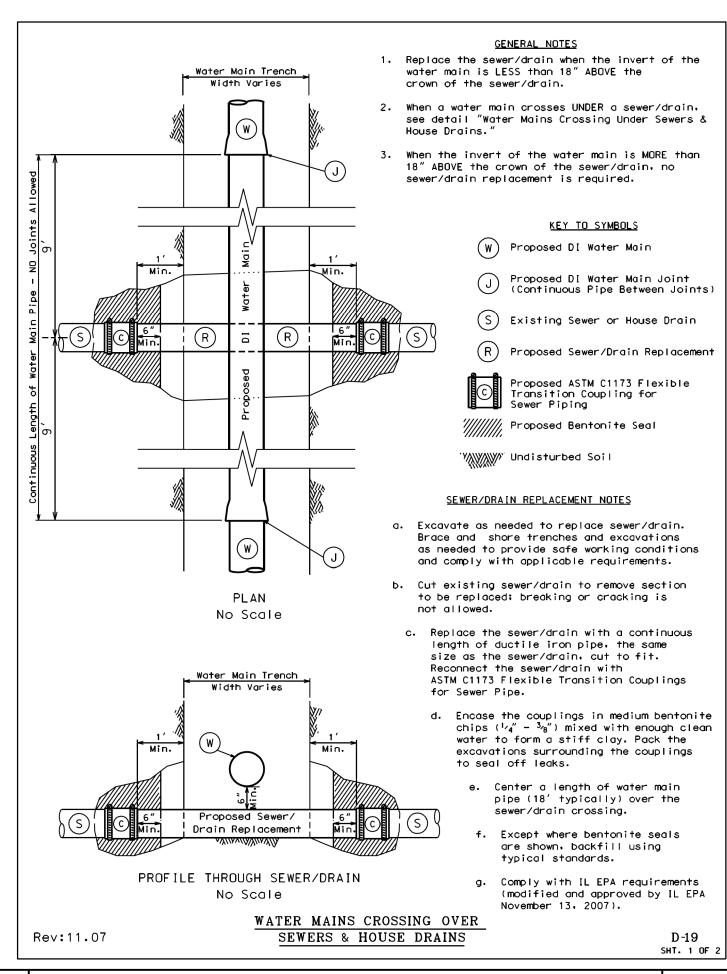
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	PLOT DATE = 12/13/2024	DATE -	12/13/2024	ISSUED FOR BID -	12/17/2024	
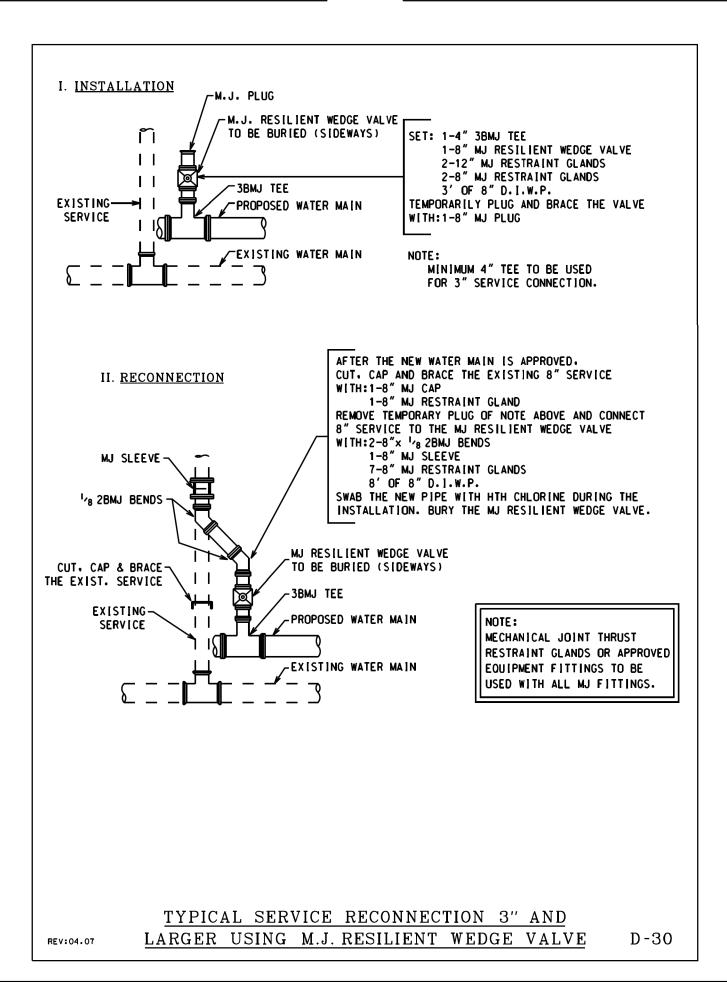
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CDWM		WATER MAIN DETAILS						COOK	49	43
	T							CONTRACT	NO. C1	617
	SHEET 16	OF 22 SHEETS STA.	TO STA.			ILLINOIS	FED. AII	O PROJECT		




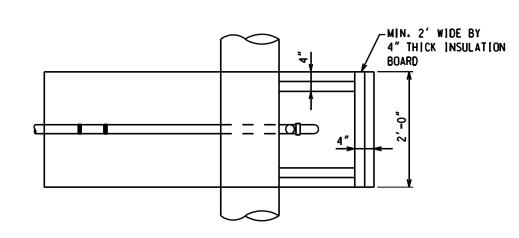



TOP VIEW SERVICE PIPE INSULATION DETAILS


- 1. BACK FILL MATERIAL AROUND INSULATION SHALL BE FINE SAND (FA7). FREE FROM ROOTS. ORGANIC MATTER, LEAVES OR OTHER INJURIOUS MATERIALS.
- 2. OVERLAP ALL INSULATION BOARD JOINTS.
- 3. INSULATION BOARD TO BE CLOSED CELL, EXTRUDED POLYSTYRENE FOAM MEETING ASTM 578. TYPE VI. 40 PSI COMPRESSING STRENGTH (ASTM D1621) 0.1% MAX. WATER ABSORPTION (ASTM C272).


SERVICE PIPE INSULATION DETAILS D-31 REV:04.07

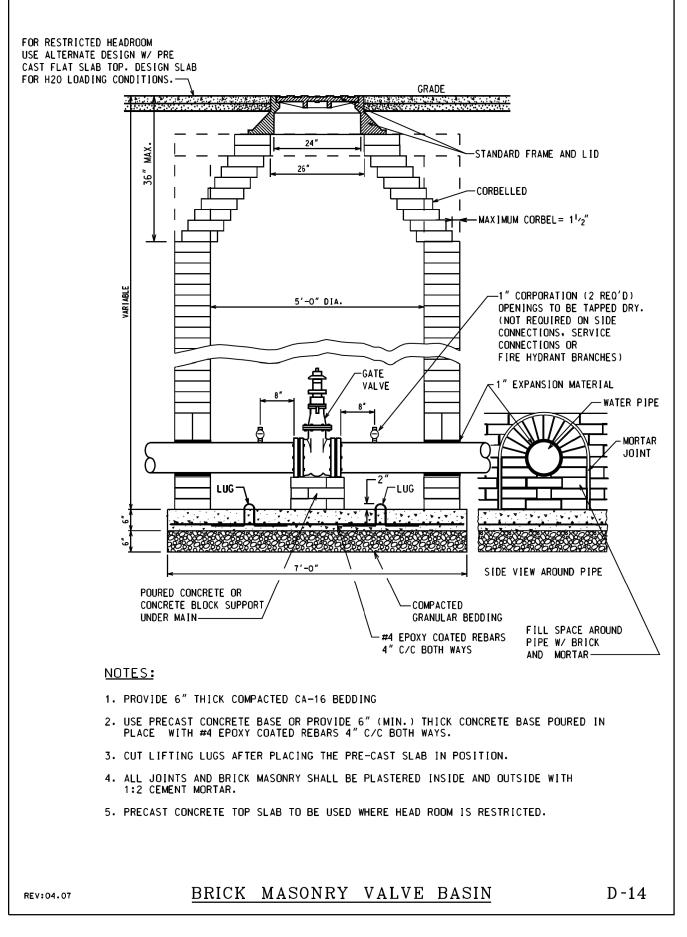

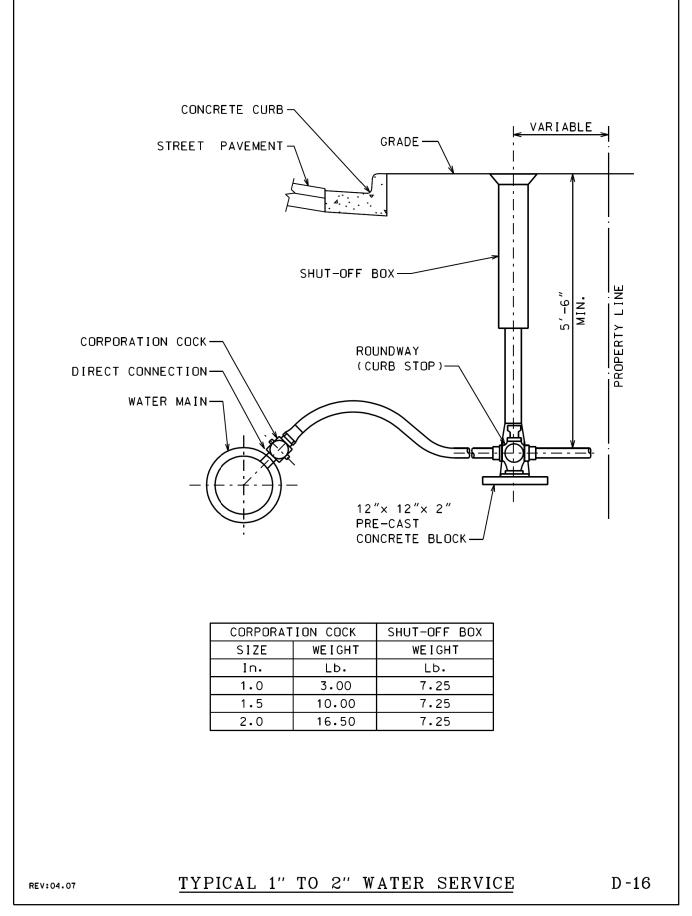

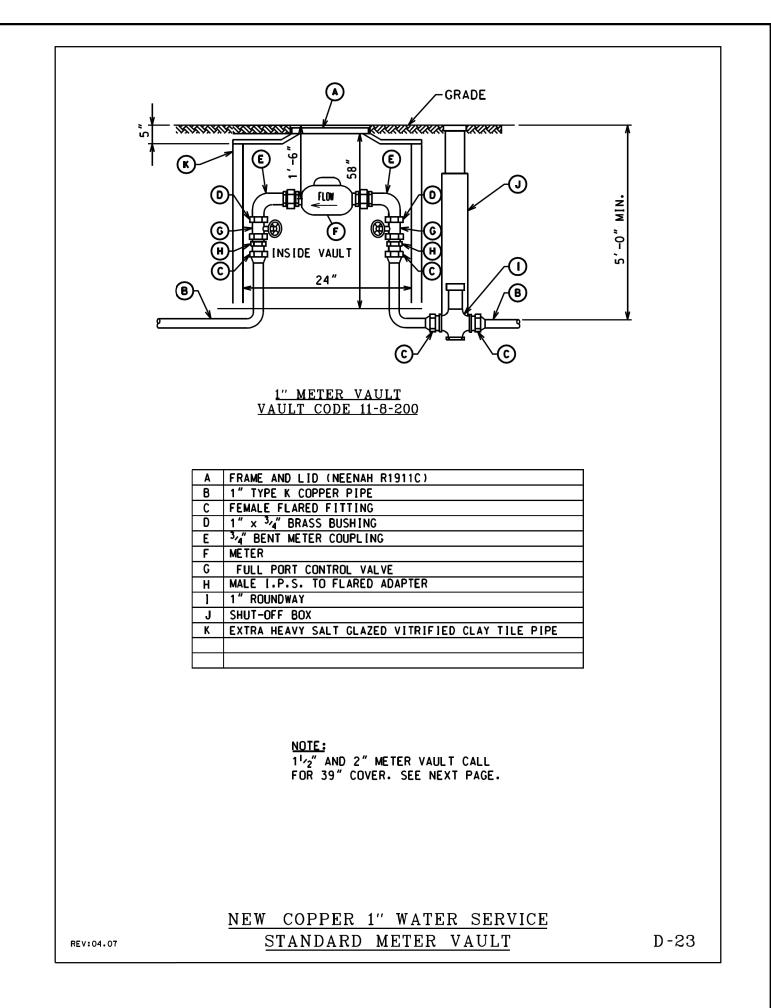

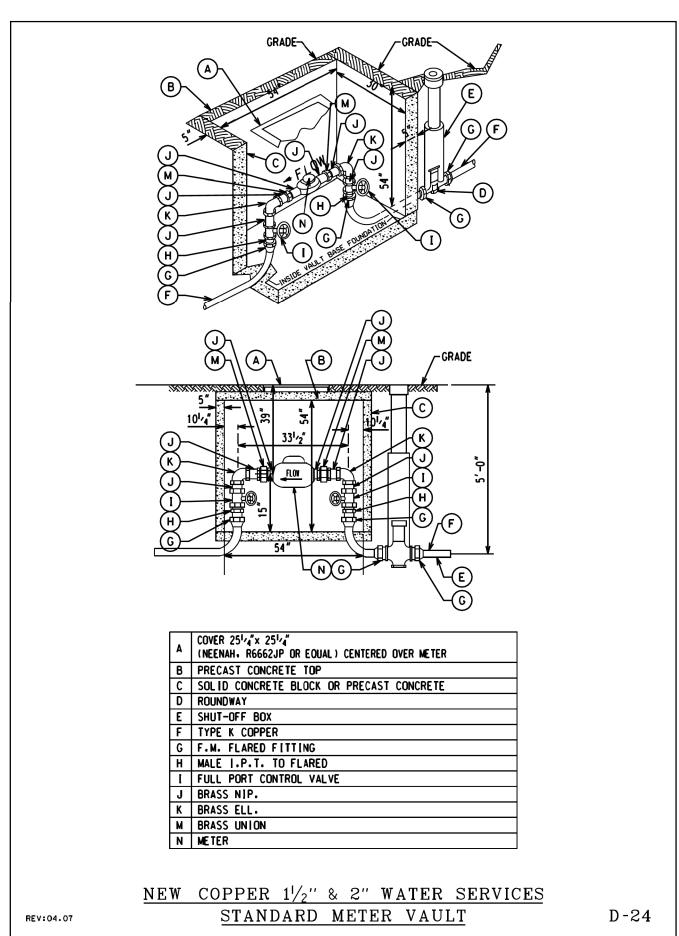

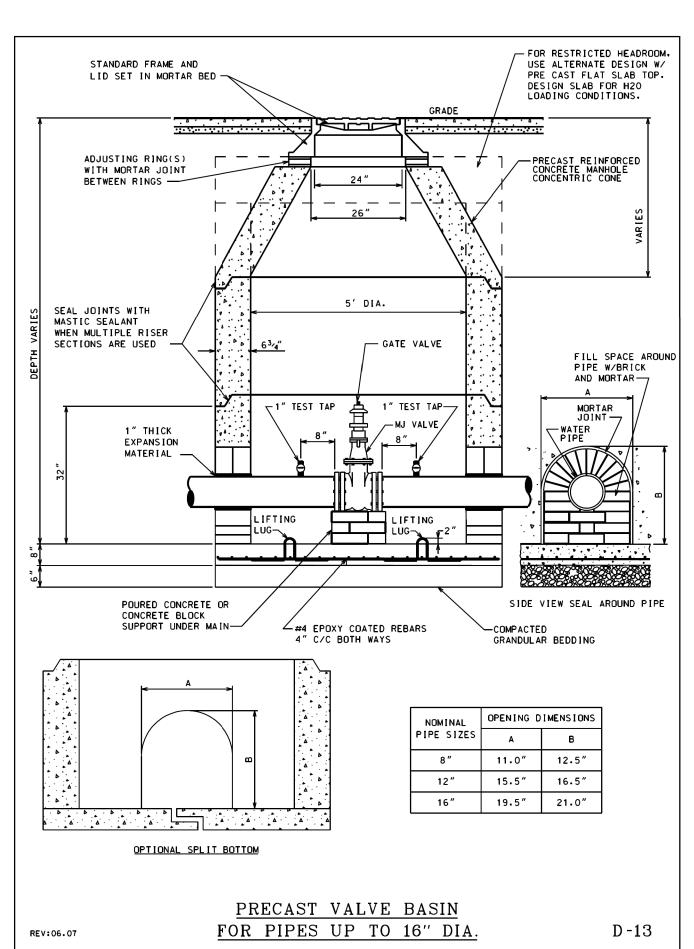


SCALE:



CAGO	USER NAME = mike.thon	DESIGNED -		REVISED -		
		DRAWN -		REVISED -		
	PLOT SCALE = 10.000 ' / in.	CHECKED -		REVISED -		
	PLOT DATE = 12/13/2024	DATE -	12/13/2024	ISSUED FOR BID	_	12/17/2024
//.	PLOT DATE = 12/13/2024	DATE -	12/13/2024	ISSUED FOR BID	-	12/17/2024


					F.A RTE	SECT	TON	COUNTY	TOTAL SHEETS	SHEE NO
DWW	DWM WATER MAIN DETAILS						соок	49	44	
								CONTRACT	NO. C1	617
HEET 17	OF 22 SI	HEETS	STA.	TO STA.			ILLINOIS FED	AID PROIECT		

SEWER CROSSING DETAIL A.O Water Main 1.5' Above Sewer

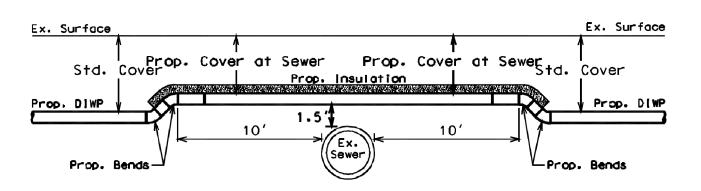


Profile View Along Water Main Centerline

<u>SEWER CROSSING DETAIL A.1</u> Water Main 6" Above Sewer - Case Water Main

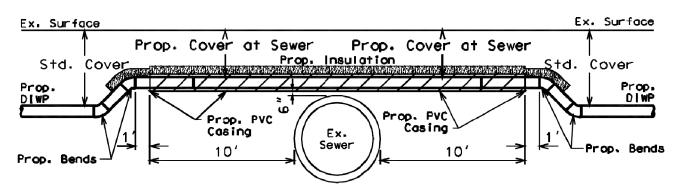

Profile View Along Water Main Centerline

<u>SEWER CROSSING DETAIL B.1</u> Water Main 1.5' Below Sewer – Case Water Main

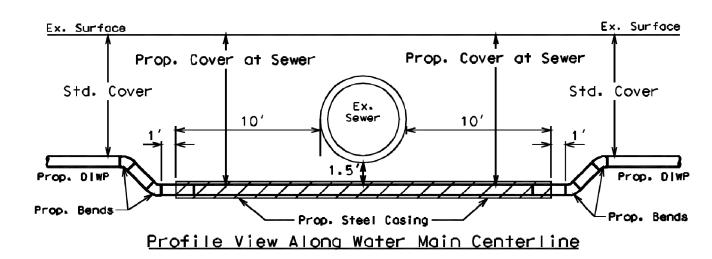

HIE NAME: 2:3


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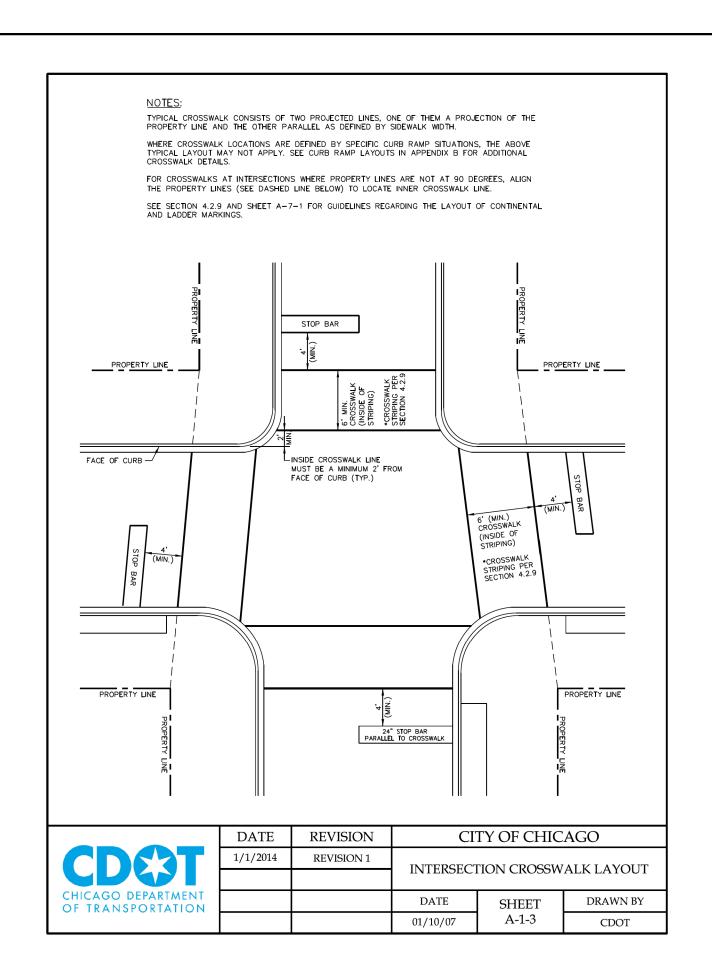
 PLOT SCALE
 = 10.000 ' / in.
 CHECKED
 REVISED


 PLOT DATE
 = 12/13/2024
 DATE
 12/13/2024
 ISSUED FOR BID
 12/17/2024


CITY OF CHICAGO
DEPARTMENT OF TRANSPORTATION


SCALE:




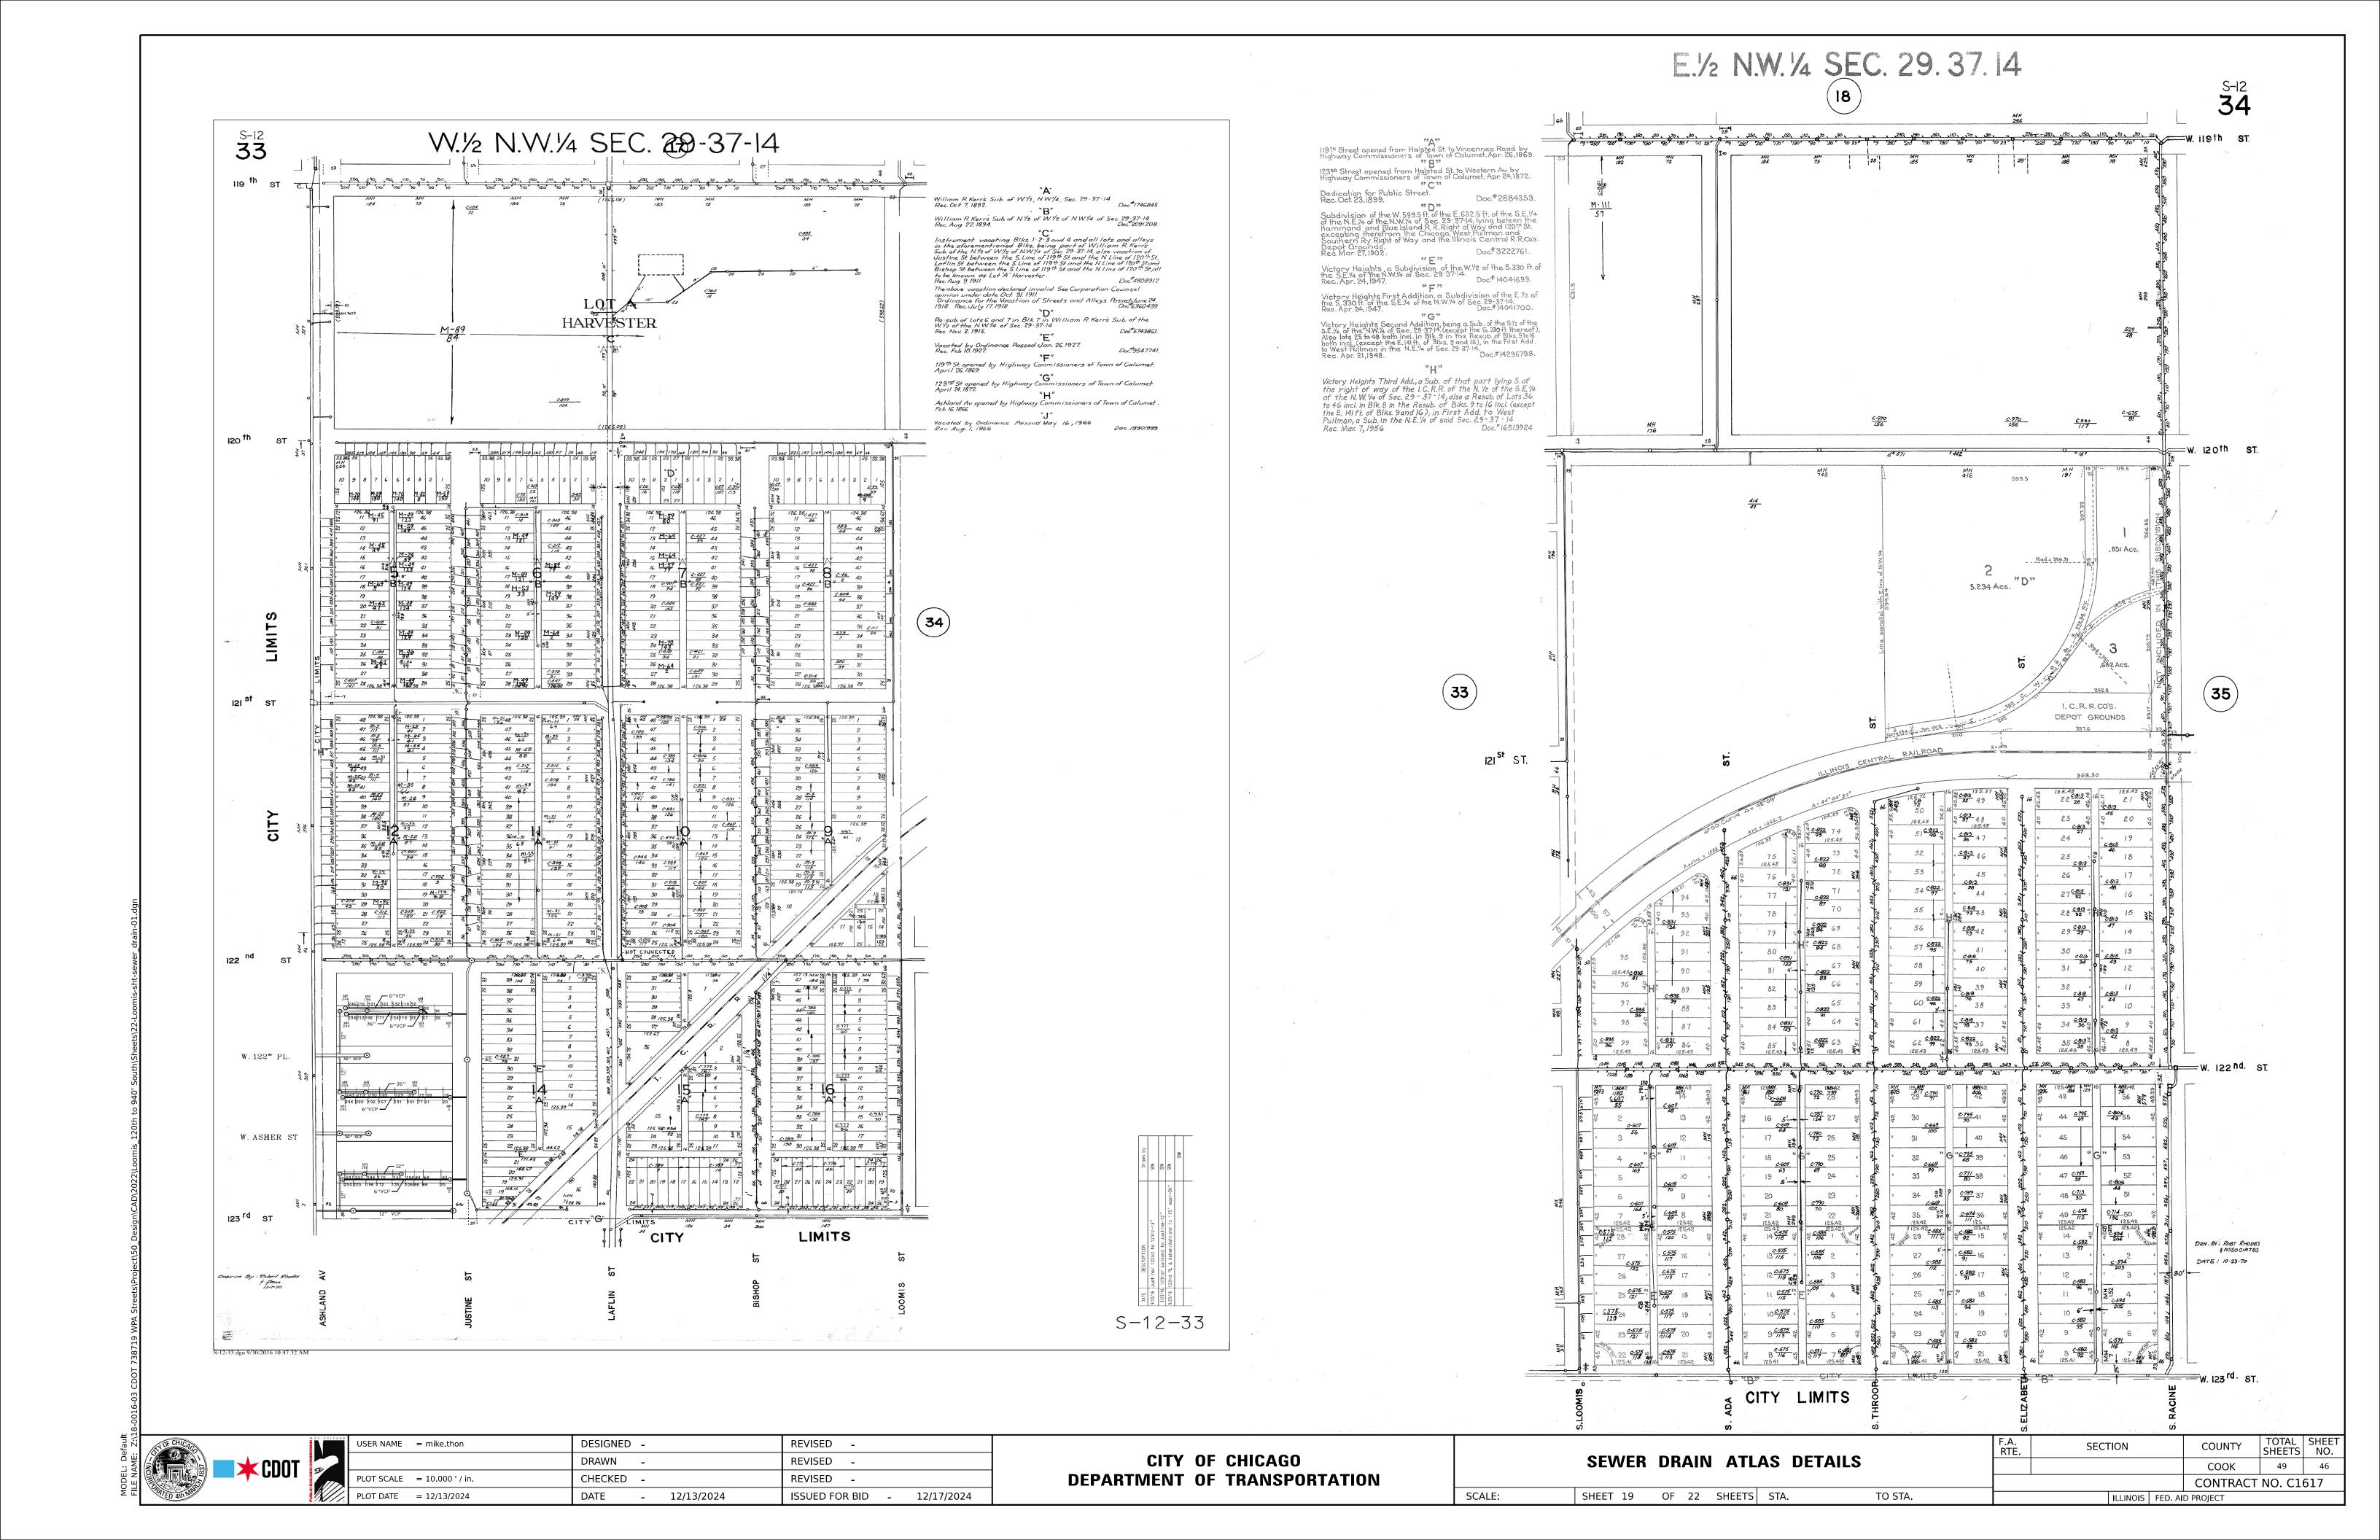


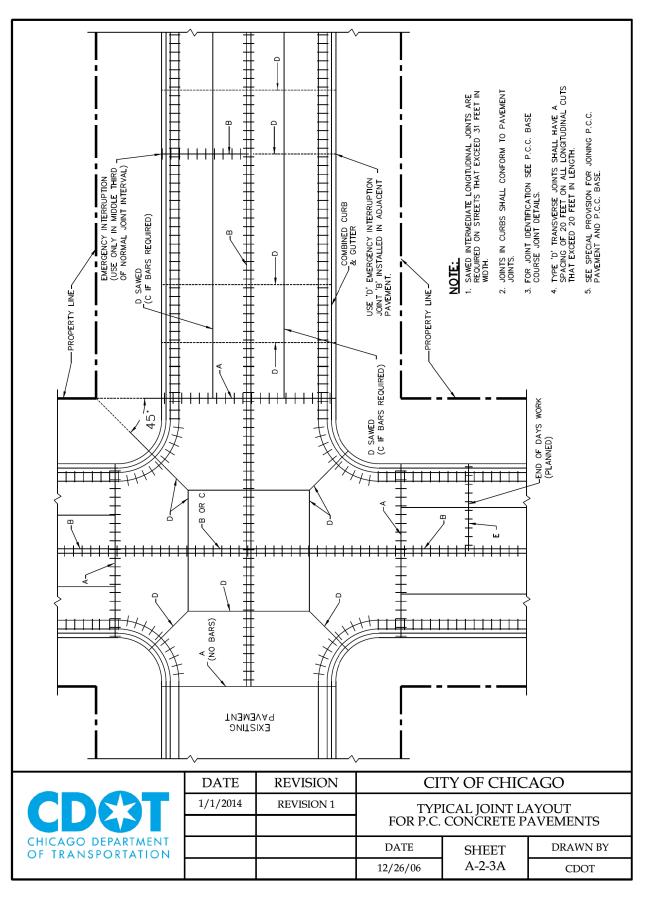


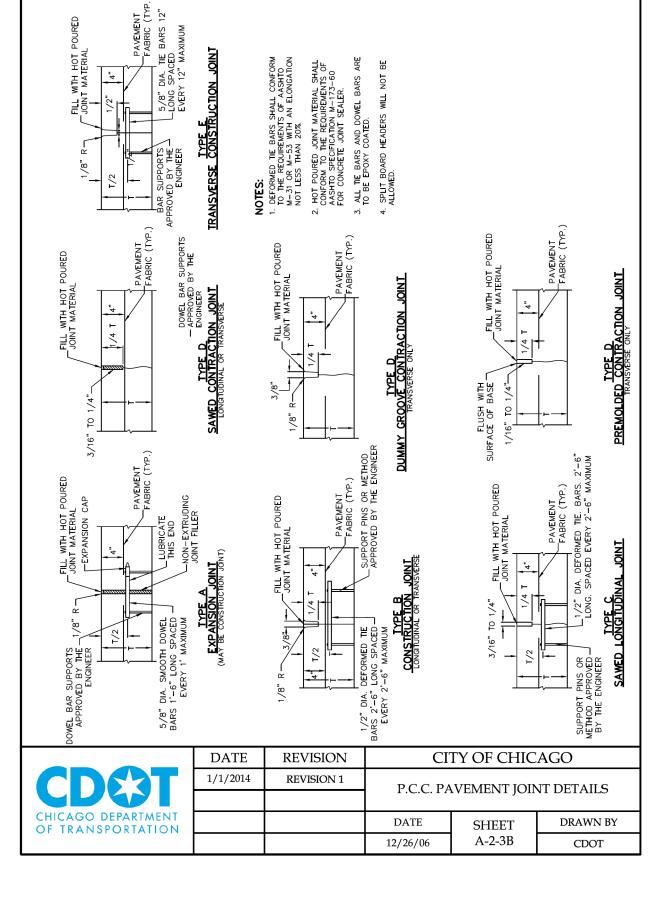

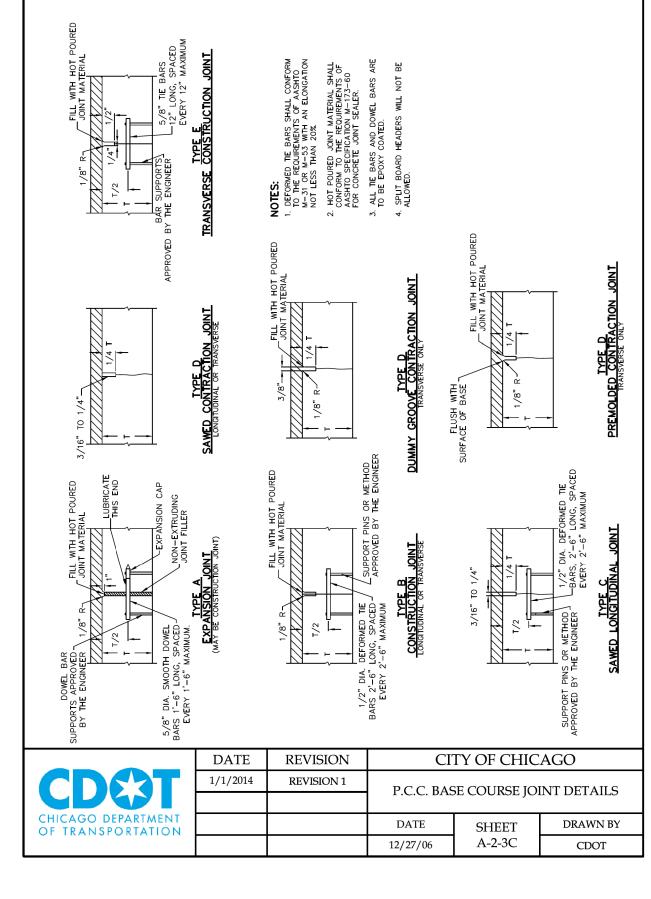


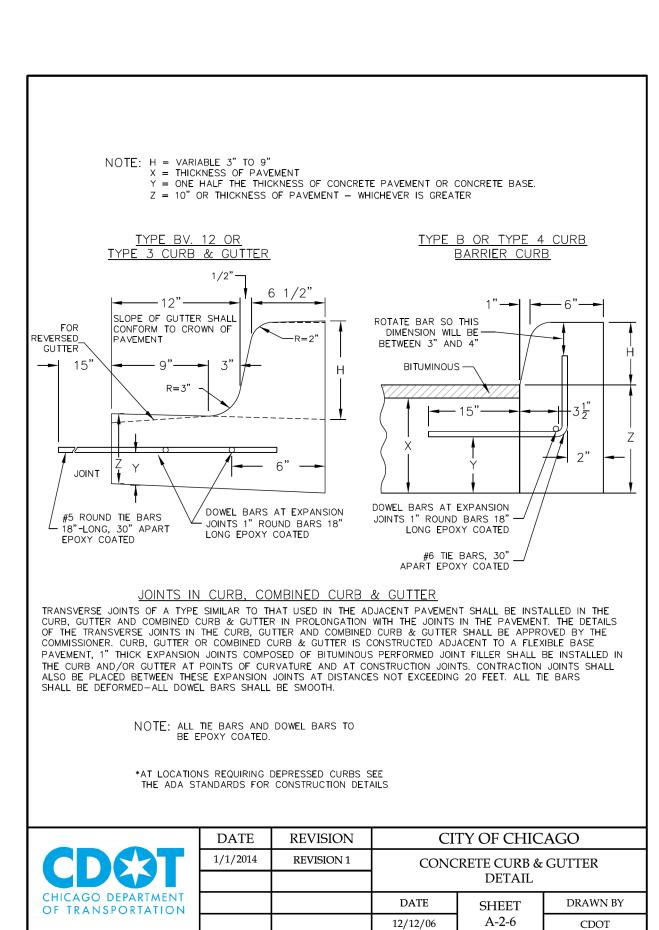

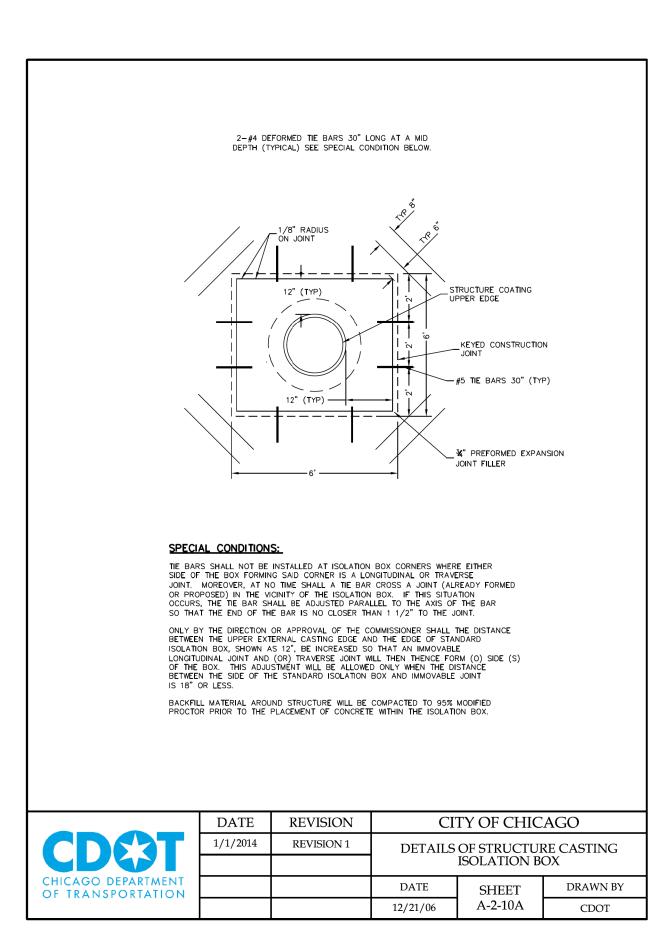

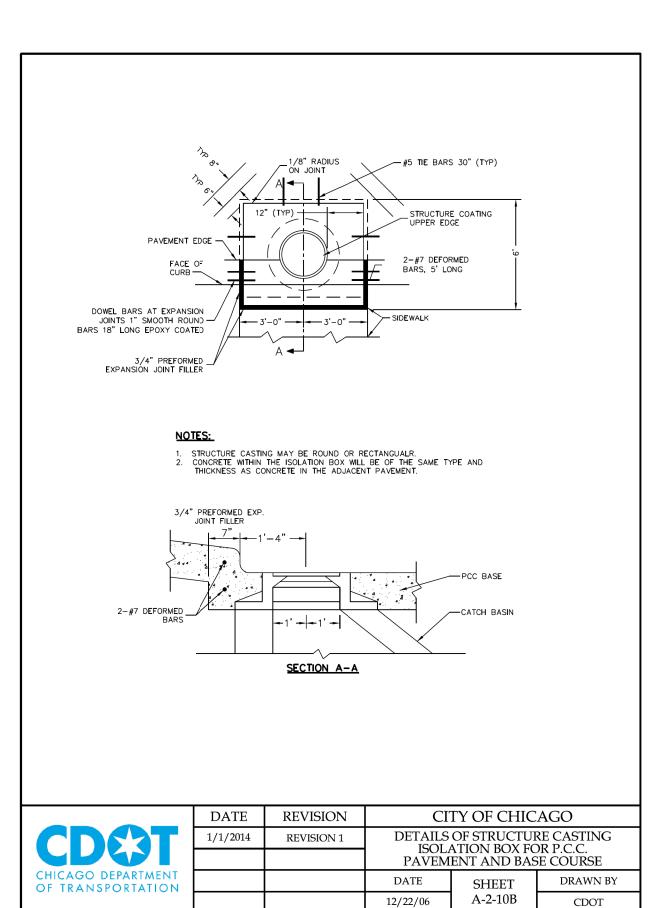

SCALE

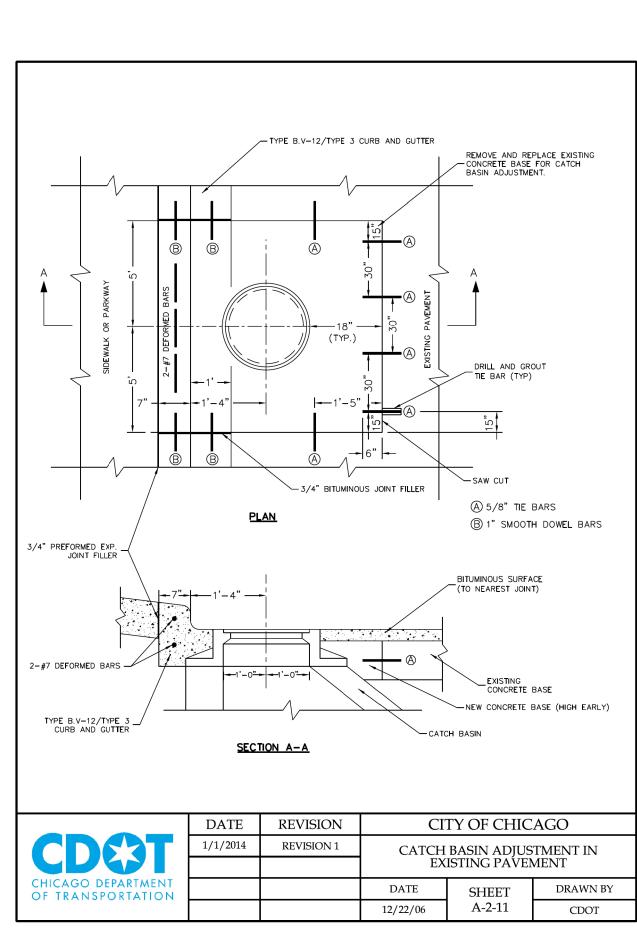



ICAGO	USER NAME = mike.thon	DESIGNED -		REVISED -	
2		DRAWN -		REVISED -	
	PLOT SCALE = 10.000 ' / in.	CHECKED -		REVISED -	
	PLOT DATE = 12/13/2024	DATE -	12/13/2024	ISSUED FOR BID -	12/17/2024

CITY	OF	CHICAGO
DEPARTMENT	OF	TRANSPORTATION


I F								F.A. SECTION			COUNTY TOTAL SHEETS		SHEET NO.
CDOT DETAILS											COOK	49	47
	.										CONTRACT	NO. C16	617
	SHEET 20	OF 2	22	SHEETS	STA.	TO STA.			ILLINOIS	FED. AIC	O PROJECT		

TREE PROTECTION AREA ENTIRELY WITHIN CONSTRUCTION AREA


GENERAL NOTES:

TREE PROTECTION FENCE SHALL REMAIN IN PLACE THROUGHOUT THE DURATION OF CONSTRUCTION AND SHALL BE REMOVED ONLY BY PERMISSION OF THE COMMISSIONER. THE CONTRACTOR SHALL NOT STORE ANY MATERIALS OR EQUIPMENT WITHIN THE TREE PROTECTION ZONE.

ROOT PRUNING ON MORE THAN ONE SIDE OF AN EXISTING TREE MUST HAVE PRIOR APPROVAL BY THE BUREAU OF FORESTRY.

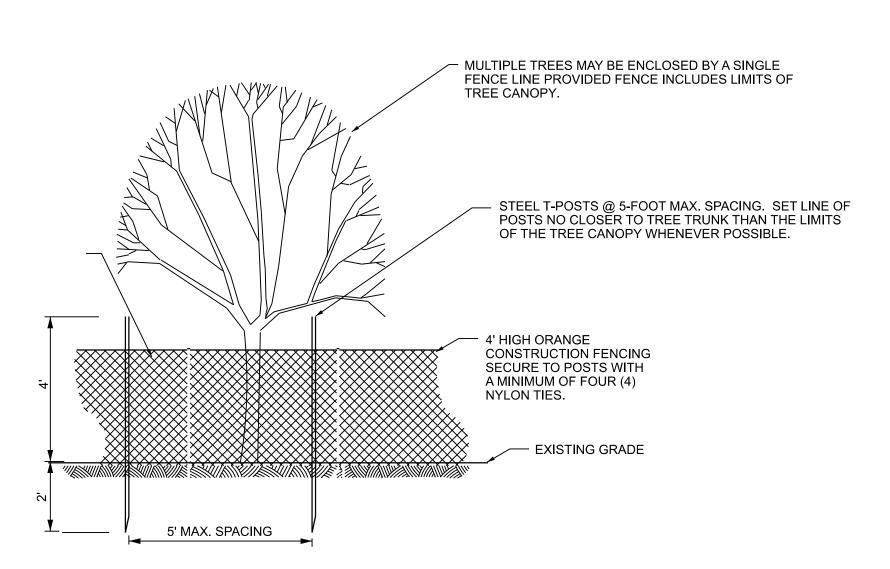


TREE PROTECTION FENCE

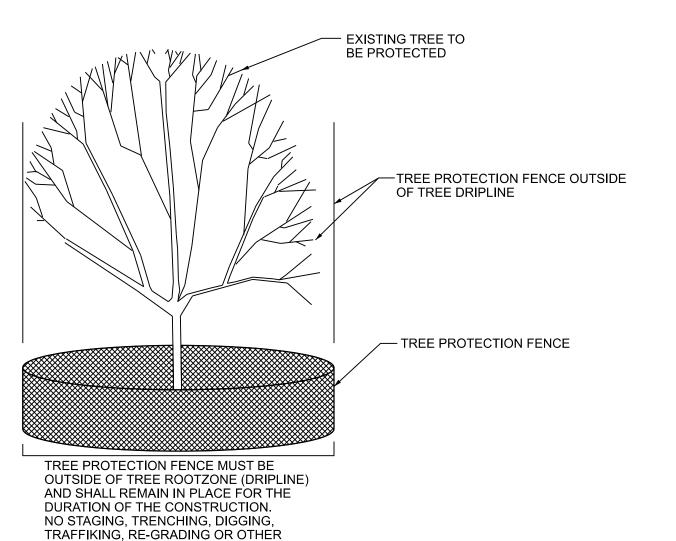

TYPICAL TREE PROTECTION
ENTIRELY WITHIN CONSTRUCTION AREA

SCALE:

IMPACT IN TREE PROTECTION AREA

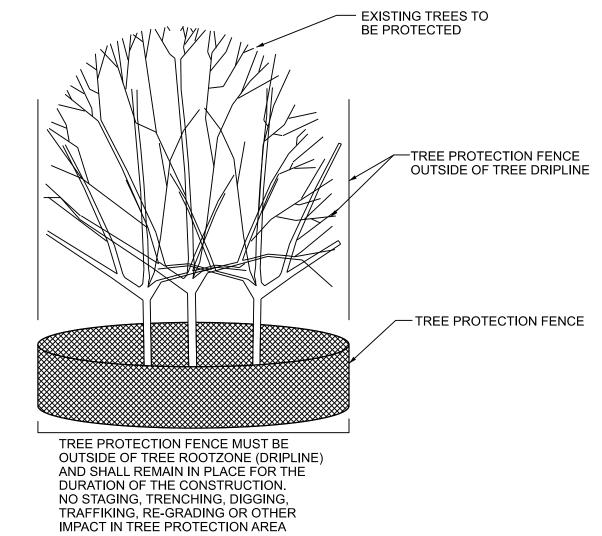


TYPICAL GROUP TREE PROTECTION ENTIRELY WITHIN CONSTRUCTION AREA

→ CDOT

CHICAGO	USER NAME =	= mike.thon	DESIGNED	-		REVISED	-		
			DRAWN	-		REVISED	-		
	PLOT SCALE =	= 10.000 ' / in.	CHECKED	-		REVISED	-		
	PLOT DATE =	= 12/13/2024	DATE	-	12/13/2024	ISSUED FO	R BID	-	12/17/2024

TOFF DOOTFOTION DETAILS						SEC	ΓΙΟΝ		COUNTY	TOTAL SHEETS	SHEET NO.
TREE PROTECTION DETAILS									COOK	49	48
T									CONTRACT	NO. C1	617
SHEET 21	OF 22	SHEETS	STA.	TO STA.			ILLINOIS	FED. AII	D PROJECT		

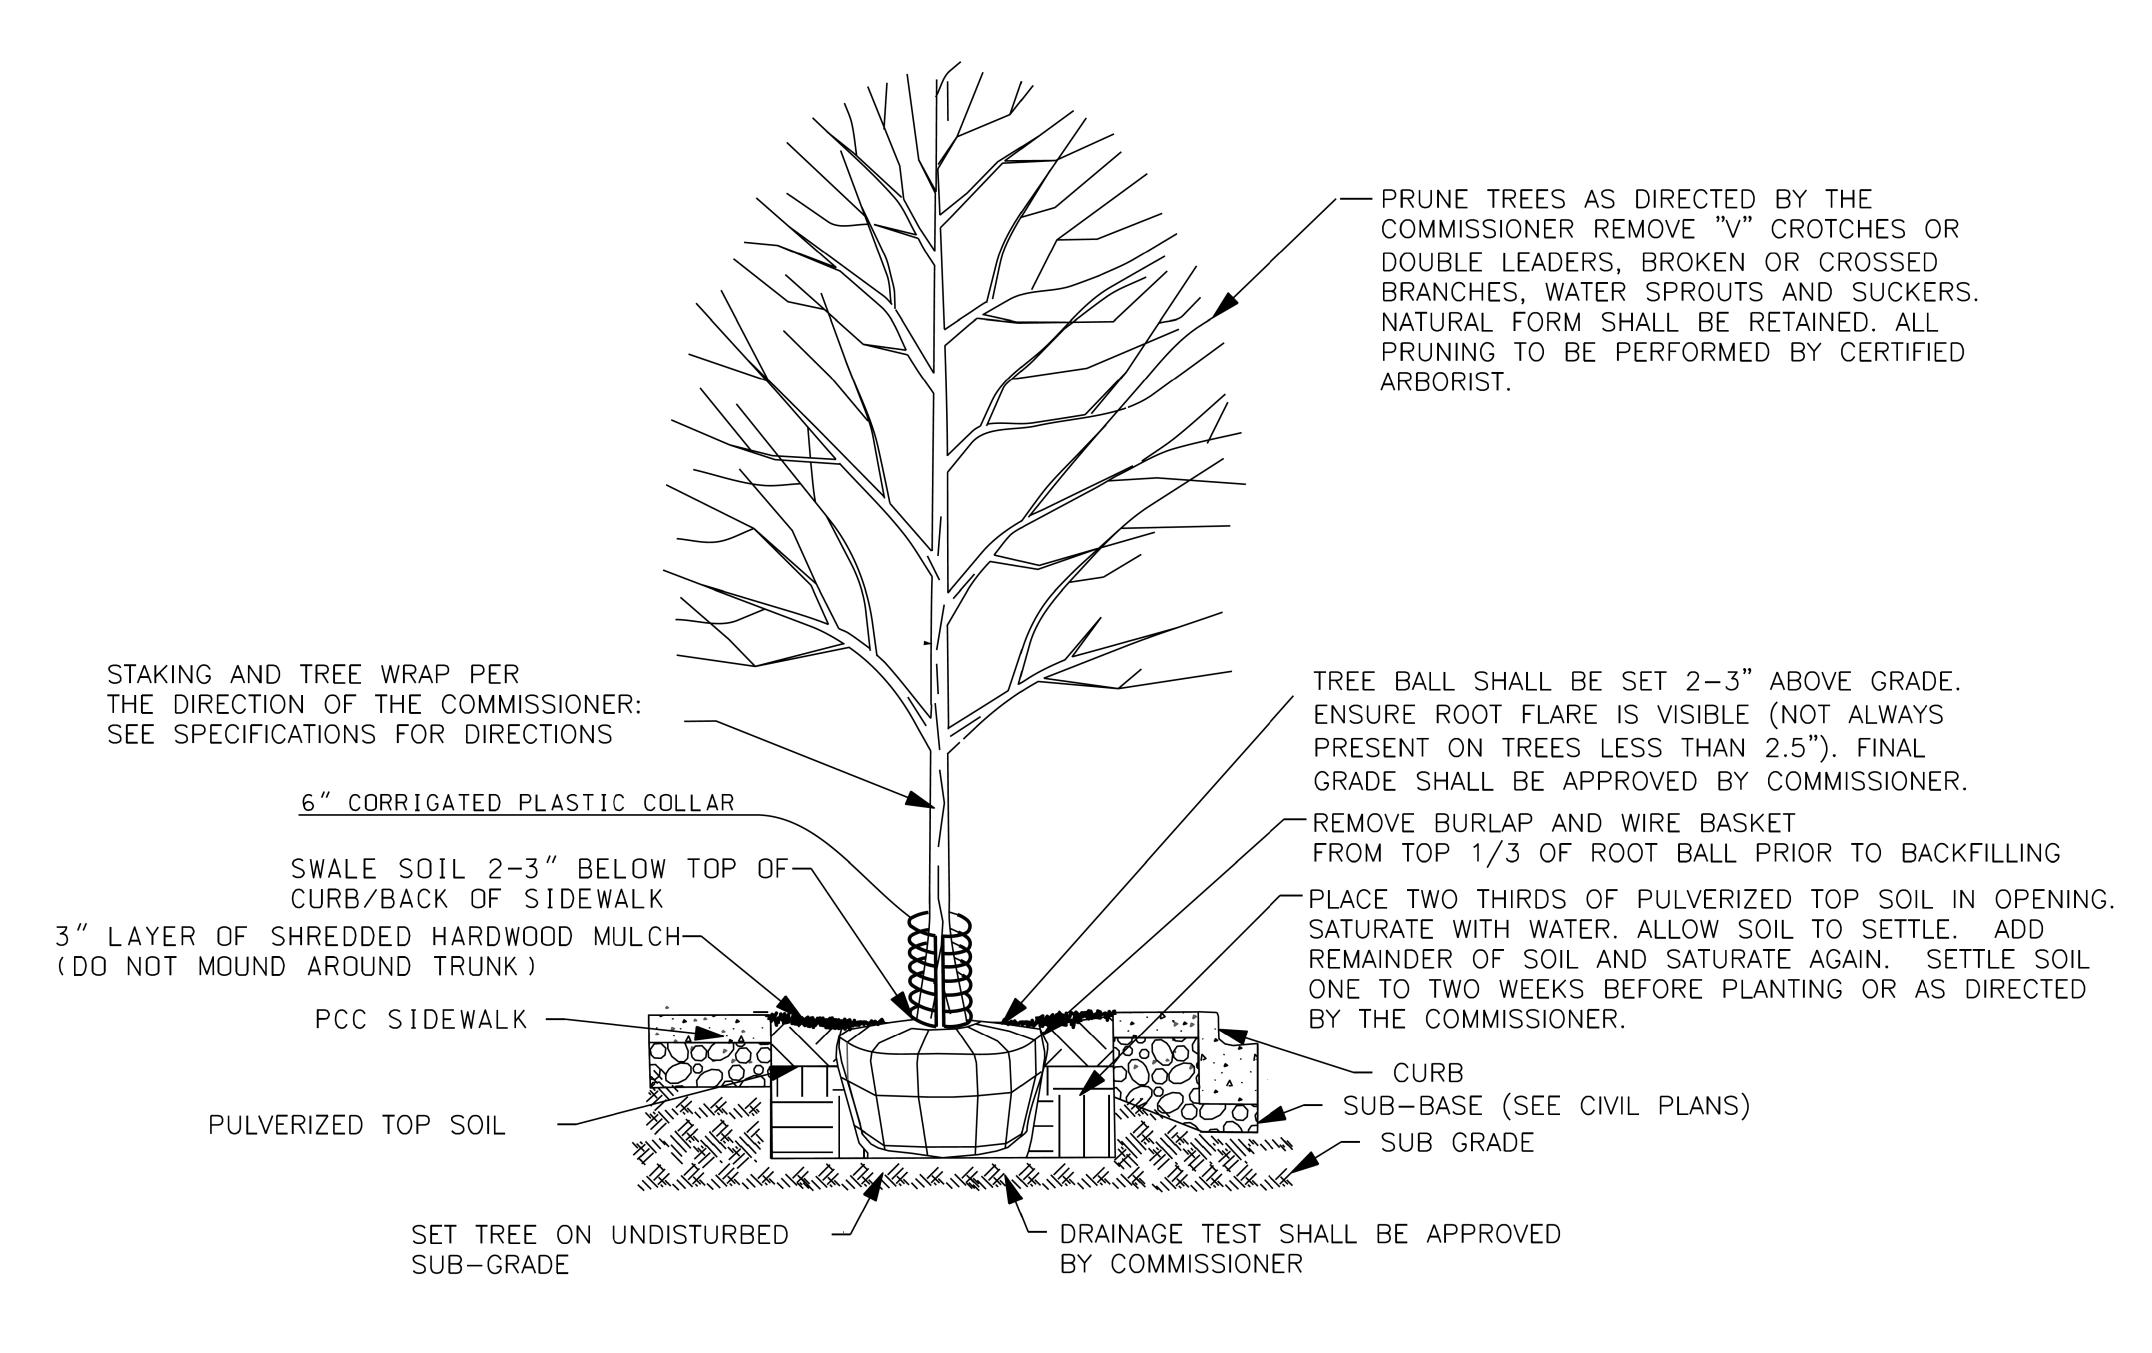

1) <u>tree planting detail (new sidewalk opening or new parkway)</u> NTS

SCALE:

N	TOF CHICAGO		NOIS
FILE NAME:		CDOT	SIIC BUILDING COMMISS

FCHICAGO	USER NAME = mike.thon	DESIGNED -	REVISED -
D.		DRAWN -	REVISED -
	PLOT SCALE = 10.000 ' / in.	CHECKED -	REVISED -
	PLOT DATE = 12/13/2024	DATE - 12/13/2024	ISSUED FOR BID - 12/17/2024

CITY	OF	CHICAGO
DEPARTMENT	OF	TRANSPORTATION

TREE DIANITINO RETAIL					F.A. RTE.	SECT	ΓΙΟΝ		COUNTY	TOTAL SHEETS	SHE NC		
TREE PLANTING				MIING	DETAIL						COOK	49	49
											CONTRACT	NO. C1	617
EET	22	OF	22	SHEETS	STA.	TO STA.	ILLINOIS FED. AID PROJECT						