STANDARD SYMBOLS

LIGHT STANDARD BUFFALO BOX, WATER BUFFALO BOX, WATER, TO BE ADJUSTED BUFFALO BOX. GAS GAS REGULATOR GAS VALVE AT&T MANHOLE COM ED MANHOLE POWER POLE TRAFFIC SIGNAL TRAFFIC SIGNAL CONTROL BOX $A \square$ INLET TO BE ADJUSTED F ★ INLET TO BE FILLED $R \square$ INLET TO BE RECONSTRUCTED INLET TO BE REMOVED CATCH BASIN CATCH BASIN TO BE ADJUSTED CATCH BASIN TO BE FILLED CATCH BASIN TO BE RECONSTRUCTED CATCH BASIN TO BE REMOVED SEWER MANHOLE SEWER MANHOLE TO BE ADJUSTED SEWER MANHOLE TO BE RECONSTRUCTED WATER VAULT WATER VAULT TO BE ADJUSTED WATER METER CITY ELECTRIC MANHOLE A C CITY ELECTRIC MANHOLE TO BE ADJUSTED NEWSPAPER STAND GARBAGE CAN TREES, EXISTING, WITH DIAMETER TREES TO BE REMOVED SOIL BORING SIGN POST PARKING METER BUILDING FACE FENCE DIRECTION OF FLOW (#"##) ELEVATION T/S TOP OF STEP B/S BOTTOM OF STEP BENCHMARK

> IR-108810 EFP-128829

DEVON

LAWRENCE

IRVING PK

BELMONT

FULLERTON

NORTH


CHICAGO

MADISON

ROOSEVELT CERMAK

PERSHING

111TH

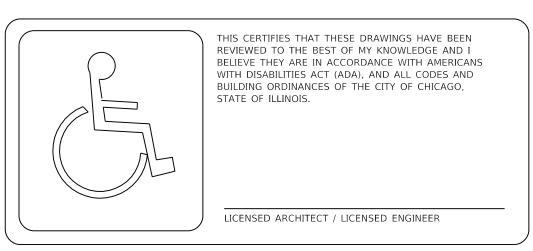

""."

PRIOR TO CONSTRUCTION, THE CONTRACTOR IS REQUIRED TO CALL D.I.G.G.E.R. AT 312-744-7000 FOR UNDERGROUND UTILITY LOCATIONS.

CONTROL POINT

ORDINANCE GRADE

CITY OF CHICAGO

BRANDON JOHNSON, MAYOR

PUBLIC BUILDING COMMISSION OF CHICAGO

RAY GIDEROF, EXECUTIVE DIRECTOR

CHICAGO DEPARTMENT OF TRANSPORTATION

TOM CARNEY, COMMISSIONER ANNE ZHANG, P.E., ACTING MANAGING DEPUTY COMMISSIONER

CONTRACT PLANS

FOR

WORKS PROGRESS ADMINISTRATION ("WPA") STREET RECONSTRUCTION (89TH STREET) W. 89TH STREET FROM SOUTH PRINCETON AVENUE TO SOUTH HOLLAND ROAD **CHICAGO, IL 60620**

> PBC CONTRACT NO.: C1624 22811 PBC PROJECT NO.: C.D.O.T. PROJECT NO.: B-5-275

> > 6400 N

5600 N

4800 N

4000 N


3200 [

1600 N

2200 5

WARD 21

PROJECT LOCATION

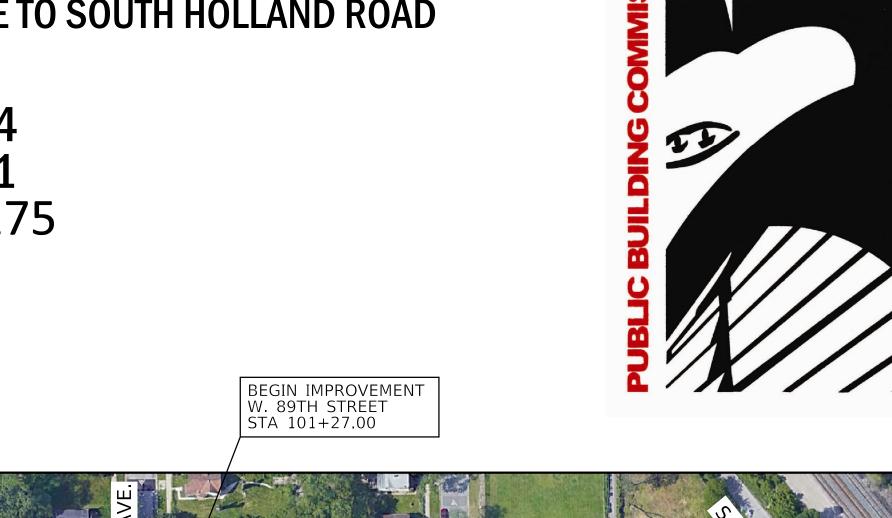

INDEX OF DRAWINGS

DESCRIPTION TITLE SHEET GENERAL NOTES SUMMARY OF QUANTITIES ALIGNMENT, TIES, AND BENCHMARKS TYPICAL SECTIONS PLAN AND PROFILE ADA GRADING DETAILS 11-12 SEWER CONNECTIONS 13-14 WATER MAIN PLAN AND PROFILE 15 PAVEMENT MARKING AND SIGNAGE 16-18 PROPOSED LIGHTING IMPROVEMENTS 19 SOIL BORING LOGS 20-25 IDOT HIGHWAY STANDARDS 26-40 CDWM SEWER DETAILS 41-43 CDWM WATER DETAILS CDOT CURB & GUTTER DETAIL SEWER DRAIN ATLAS DETAIL WATER MAIN SUPPORT DETAIL MOT PLAN DETOUR PLAN



END IMPROVEMENT W. 89TH STREET STA 109+25.28



INDEX MAP NOT TO SCALE

LOCATION MAP NOT TO SCALE

LENGTH OF IMPROVEMENT = 798.28 L.F. (0.15 MILES)

GENERAL NOTES

- 1. ANY REFERENCE TO 'STANDARD SPECIFICATIONS' THROUGHOUT THE PLANS OR SPECIAL PROVISIONS WILL BE INTERPRETED TO BE THE ILLINOIS DEPARTMENT OF TRANSPORTATION (IDOT) 'STANDARD SPECIFICATIONS FOR ROAD AND BRIDGE CONSTRUCTION' (SSRBC), ADOPTED APRIL 1, 2016, AND THE IDOT SUPPLEMENTAL SPECIFICATIONS', ADOPTED JANUARY 1, 2021.
- 2. ALL DIMENSIONS SHOWN ON THE PLANS ARE TO THE FACE OF THE CURB, UNLESS OTHERWISE SPECIFIED.
- 3. THE CONTRACTOR MUST TAKE ALL NECESSARY SAFETY PRECAUTIONS TO PROTECT ABUTTING PROPERTY, UTILITIES, PEDESTRIANS, AND VEHICULAR TRAFFIC.
- 4. IT IS CALLED TO THE CONTRACTOR'S ATTENTION THAT CERTAIN PERMITS AND FEES WILL BE REQUIRED BY VARIOUS DEPARTMENTS OF THE CITY OF CHICAGO. ALL PERMITS ARE INCIDENTAL.
- 5. PARKING METER AND PARKING PAY BOX WORK REQUIRED DUE TO CONSTRUCTION MUST BE PERFORMED BY THE CITY OF CHICAGO DEPARTMENT OF REVENUE ONLY. THE CONTRACTOR SHALL PAY ALL FEES REQUIRED BY SECTION 9-68-050 OF THE MUNICIPAL CODE OF CHICAGO. REFER TO ARTICLE 10, SECTION E OF THE PROJECT SPECIFICATIONS FOR FURTHER INFORMATION. THIS INCLUDES ANY AND ALL PARKING METERS AND PARKING PAY BOXES TO BE INSTALLED, REMOVED OR RELOCATED AT THE PROJECT LOCATION OR AT ANY AND ALL LOCATIONS DIRECTLY OR INDIRECTLY INVOLVED WITH THE PROJECT.
- 6. THE CTA SHALL REMOVE/REPLACE ALL CTA BUS STOP SIGNS AND BUS SHELTERS WITHIN THE PROJECT LIMITS. THE CONTRACTOR MUST CONTACT THE CTA AT TRAFFIC.PLANNING@TRANSITCHICAGO.COM AT LEAST TWO WEEKS PRIOR TO SIDEWALK REMOVAL OPERATIONS TO COORDINATE THIS WORK.
- 7. PRIOR TO THE START OF CONSTRUCTION, THE CONTRACTOR MUST SUBMIT A PROPOSED CONSTRUCTION SCHEDULE IN A FORMAT APPROVED BY THE COMMISSIONER. NO WORK WILL BE PERMITTED TO PROCEED UNTIL THE PROPOSED SCHEDULE IS REVIEWED AND APPROVED BY THE COMMISSIONER.
- THE CITY RESERVE THE RIGHT TO ORDER, IN WRITING, CHANGES IN THE WORK OR THE CONTRACT TIME. THESE CHANGES MAY CONSIST OF ADDITIONS, DELETIONS OR OTHER REVISIONS, AT THE DISCRETION OF THE CITY.
- 9. WHEN UNSEEN CIRCUMSTANCES IMPACT THE CONTRACTORS APPROVED CONSTRUCTION SCHEDULE, IT MAY BE NECESSARY TO ADJUST OR REVISE THE SCHEDULE IN ORDER TO MAINTAIN PROGRESS AND PROVIDE FOR PEDESTRIAN AND VEHICULAR SAFETY, THE CONTRACTOR SHALL COOPERATE FULLY WITH THE CITY IN THIS REGARD.
- 10. LANE CLOSURES, WORK ZONE RESTRICTIONS, REVISED WORK DAY HOURS AND WEEKEND OR HOLIDAY WORK SCHEDULES ARE SUBJECT TO THE APPROVAL OF THE COMMISSIONER, THE CONTRACTOR MUST RECEIVE WRITTEN AUTHORIZATION, EITHER BY PERMIT OR NOTIFICATION BY THE COMMISSIONER, BEFORE PROCEEDING WITH WORK UNDER THESE CIRCUMSTANCES.
- 11. THE CONTRACTOR MUST NOTIFY THE DEPARTMENT OF STREETS AND SANITATION AT (312) 746-4524 72 HOURS PRIOR TO THE NEED FOR TOWING RELOCATION OF VEHICLES, THE CITY OF CHICAGO WILL BE RESPONSIBLE FOR REMOVING PARKED VEHICLES LOCATED IN THE SCHEDULED WORK AREA. SIGNS PREVENTING PARKING WILL BE POSTED BY THE COMMISSIONER OR HIS STAFF 72 HOURS BEFORE THE WORK IS SCHEDULED. PRIOR TO POSTING SIGNS THE COMMISSIONER SHALL NOTIFY THE ALDERMAN'S OFFICE OF THE RESURFACING SCHEDULE. THE POLICE ARE TO BE PRESENT TO ISSUE TICKETS AND SUPERVISE TOWING PRIOR TO THE RELOCATION OF VEHICLES.
- 12. THE CONTRACTOR SHALL FURNISH THE NAME(S) OF THE QC MANAGER LEVEL II TECHNICIAN ASSIGNED TO THE PROJECT AT THE TIME OF THE PRE-CONSTRUCTION MEETING.
- 13. 10 FEET TRANSITIONS SHALL BE USED TO MATCH PROPOSED CURB AND GUTTER AND MEDIAN ITEMS OF WORK TO EXISTING CURB AND GUTTER AND MEDIAN IN THE FIELD, UNLESS OTHERWISE SHOWN. THE TRANSITIONS SHALL BE PAID FOR AT THE CONTRACT UNIT PRICE FOR THE PROPOSED ITEMS OF WORK SPECIFIED IN THIS CONTRACT.
- 14. THE CONTRACTORS SHALL COORDINATE ACTIVITIES WITH UTILITY COMPANIES AND THE CITY OF CHICAGO.
- 15. BUTT JOINTS SHALL BE INSTALLED AT THE ENDS OF ALL RESURFACING (WHERE RESURFACING MEETS THE EXISTING PAVEMENT), IN ACCORDANCE WITH THE "BUTT JOINT DETAILS AT INTERSECTIONS".
- 16. THREE QUARTER INCH (3/4") THICK EXPANSION JOINT SHALL BE PLACED BETWEEN THE SIDEWALK AND ALL STRUCTURES SUCH AS ADJACENT BUILDINGS, CURBS, LIGHT STANDARDS, TRAFFIC LIGHT STANDARDS AND MANHOLES WHICH EXTEND THROUGH THE SIDEWALK. THIS WORK SHALL BE CONSIDERED INCIDENTAL TO THE COST OF PCC SIDEWALK.
- 17. CONTRACTOR IS TO RESTORE ALL UNPAVED AREAS DAMAGED DURING CONSTRUCTION OPERATIONS TO THEIR ORGINAL CONDITION INCLUDING THE FINE GRADING AND SODDING BEYOND THE AREA OF THE PROPOSED SEEDING AND SODDING, AS SHOWN ON THE STANDARD DETAILS, AT NO ADDITIONAL COST TO THE CITY.
- 18. IT SHALL BE THE CONTRACTOR'S RESPONSIBILITY TO VERIFY ALL DIMENSIONS AND CONDITIONS EXISTING IN THE FIELD PRIOR TO ORDERING MATERIALS AND BEGINNING OF CONSTRUCTION.
- 19. PAY ITEMS IN THE SUMMARY OF QUANTITIES HAVE BEEN ESTIMATED. IF, IN THE ENGINEER'S OPINION, THE WORK IS NOT REQUIRED, THE ITEM WILL BE DEDUCTED FROM THE CONTRACT AND NO ADDITIONAL COMPENSATION TO THE CONTRACTOR WILL BE ALLOWED.
- 20. BUS PAD STANDARD DIMENSION SHALL BE 10' X 80' AND SHALL BE INSTALLED AFTER THE PLACEMENT OF THE FINAL SURFACE COURSE. THE FINAL LOCATION OF ALL BUS STOPS PADS MUST BE VERIFIED IN THE FIELD AND APPROVED BY THE COMMISSIONER PRIOR TO CONSTRUCTION.

- 21. THE CONTRACTOR SHALL IMMEDIATELY NOTIFY THE DEPARTMENT OF TRANSPORTATION OF ANY DAMAGE TO CITY OWNED AND MAINTANED TRAFFIC SIGNS, SIGNALS, GUARDRAILS, FENCES, ETC.
- 22. THE ENTIRE AREA WHICH IS TO RECEIVE BITUMINOUS MATERIAL (TACK COAT) SHALL BE SWEPT CLEAN BEFORE THE MATERIAL APPLICATION. SWEEPINGS SHALL NOT BE DEPOSITED IN THE GUTTER OR ON THE CURB, PARKWAY, OR SIDEWALK, BUT SHALL BE PICKED UP AND DISPOSED OF PROPERLY.

MAINTENANCE OF TRAFFIC NOTES

- 1. TRAFFIC WILL BE MAINTAINED ON ALL STREETS AND PARKING WILL BE PROHIBITED WITHIN 50 FEET OF THE CONSTRUCTION AREA AT ALL TIMES. THE CONTRACTOR IS REQUIRED TO NOTIFY THE DIVISION OF ENGINEERING-TRAFFIC SECTION 48 HOURS BEFORE COMMENCING CONSTRUCTION.
- 2. WHEN THE PAVEMENT CONSTRUCTED IS PORTLAND CEMENT CONCRETE BASE COURSE OR PORTLAND CEMENT CONCRETE PAVEMENT, IT SHALL NOT BE OPENED TO TRAFFIC, INCLUDING CONSTRUCTION TRAFFIC, UNTIL AFTER THE SPECIFIED CURING PERIOD AS DEFINED IN ARTICLE 701.17(c)(5) OF THE 'STANDARD SPECIFICATIONS' AND UNTIL THE JOINTS HAVE BEEN SEALED.
- 3. THE CONTRACTOR'S VEHICLES SHALL ALWAYS MOVE WITH AND NOT AGAINST OR ACROSS THE FLOW OF TRAFFIC. THESE VEHICLES SHALL ENTER OR LEAVE THE WORK AREA IN A MANNER WHICH WILL NOT BE HAZARDOUS TO OR INTERFERE WITH NORMAL TRAFFIC AND SHALL NOT PARK OR STOP EXCEPT WITHIN DESIGNATED WORK AREAS. PERSONAL VEHICLES WILL NOT BE PERMITTED TO PARK WITHIN THE RIGHT-OF-WAY EXCEPT IN SPECIFIC AREAS DESIGNATED BY THE COMMISSIONER.
- . ACCESS TO EXISTING CROSS ROADS AND DRIVES MUST BE MAINTAINED AT ALL TIMES DURING CONSTRUCTION.
- 5. ADEQUATE PROVISIONS FOR PEDESTRIAN TRAFFIC MUST BE PROVIDED AT ALL TIMES.
- 6. FOR ADDITIONAL REQUIREMENTS, SEE CDOT SPECIAL PROVISION FOR TRAFFIC CONTROL AND PROTECTION IN BOOK 3.
- 7. IN AREAS WHERE MULTIPLE LOCATIONS ARE PROPOSED TO BE CONSTRUCTED, THE CONTRACTOR WILL BE REQUIRED TO STAGE WORK SO AS NOT TO ADVERSELY AFFECT THE FLOW OF PEDESTRIAN AND VEHICULAR TRAFFIC WITHIN THE GENERAL AREA. THE PROPOSED CONSTRUCTION SCHEDULE SHOULD REFLECT A PROGRESSION OF WORK THAT WILL MAINTAIN TRAFFIC TO THE SATISFACTION OF THE COMMISSIONER.
- 8. STOCKPILING OF EXCAVATED MATERIALS AND/OR CONSTRUCTION DEBRIS ON THE JOBSITE WILL NOT BE PERMITTED AND SHALL BE REMOVED FROM THE JOBSITE EACH AND EVERY DAY AND DISPOSED OF IN ACCORDANCE WITH ARTICLE 202.03 OF THE STANDARD SPECIFICATIONS. FAILURE TO COMPLY WITH THIS REQUIREMENT SHALL BE CONSIDERED A TRAFFIC CONTROL DEFICIENCY WILL BE SUBJECT TO THE CHARGES IN ACCORDANCE WITH THE ITEM TRAFFIC CONTROL COMPLETE.
- 9. "FRESH OIL" SIGNS MUST BE POSTED AT ALL INGRESSES TO PRIMED SURFACES. FAILURE TO INSTALL AND MAINTAIN THESE SIGNS WILL BE CONSIDERED A TRAFFIC CONTROL DEFICIENCY AND THE CONTRACTOR SHALL BE SUBJECT TO CHARGES IN ACCORDANCE WITH THE ITEM TRAFFIC CONTROL COMPLETE.
- 10. THE CONTRACTOR SHALL PROTECT ALL SECTIONS OF NEWLY COMPACTED HMA SURFACE COURSES FROM PEDESTRIAN AND VEHICULAR TRAFFIC UNTIL THEY COOL DOWN TO THE SATISFACTION OF THE COMMISSIONER. DAMAGES TO THE MAT SHALL BE FIXED IMMEDIATELY TO THE SATISFACTION OF THE COMMISSIONER.
- 11. IN THE EVENT THAT THE CONTRACTOR CANNOT FINISH THE MILLING AND/OR PAVING OPERATION DUE TO DELAYS CAUSED BY THE CITY OR PRIVATE UTILITY WORK OR ADJACENT CONSTRUCTION AND MOVES TO ANOTHER LOCATION, OR TERMINATES HIS OPERATION, THE CONTRACTOR MUST FINISH THE MILLING AND/OR PAVING OPERATION AS SOON AS SAID LOCATION IS CLEARED OF ALL CONFLICTING WORK AT NO ADDITIONAL COST TO THE CITY.

CIVIL NOTES

- 1. THE ENTIRE AREA WHICH IS TO RECEIVE 'BITUMINOUS MATERIALS (PRIME COAT)' MUST BE SWEPT CLEAN BEFORE THE MATERIAL IS APPLIED. THE SWEEPINGS WILL NOT BE DEPOSITED IN THE GUTTER OR ON THE CURB, PARKWAY, OR SIDEWALK, BUT ARE TO BE PICKED UP AND DISPOSED OF PROPERLY BEYOND THE LIMITS OF THE PROJECT ON THE SAME DAY THAT THE SWEEPING IS DONE. THE WORK WILL NOT BE PAID FOR SEPARATELY, BUT WILL BE CONSIDERED INCIDENTAL TO 'BITUMINOUS MATERIALS (PRIME COAT)'.
- 2. IF AN EXISTING MAILBOX MUST BE REMOVED OR RELOCATED TO COMPLETE THE WORK, THE CONTRACTOR MUST NOTIFY THE POST OFFICE. THE COST OF ANY COORDINATION WITH THE POST OFFICE WILL BE CONSIDERED INCIDENTAL TO 'SIDEWALK REMOVAL'.
- 3. THE CONTRACTOR SHALL INFORM THE COMMISSIONER 72 HOURS PRIOR TO REMOVING ANY STREET CAR TRACKS. THE COMMISSIONER WILL VERIFY THAT THE TRACKS AND/OR THE BURIED NEGATIVE GROUND CABLE IS NOT BEING USED FOR ELECTROLYSIS.
- 4. THE EXISTING PAVEMENT IS REQUIRED TO BE SAWCUT IN ORDER TO PROVIDE FOR A STRAIGHT EDGE BUTT JOINT WHERE COMBINATION CONCRETE CURB AND GUTTER IS TO BE REPLACED, WHERE FULL DEPTH PATCHES ARE TO BE CONSTRUCTED, WHERE TRENCHES FOR PROPOSED DRAINAGE STRUCTURES ARE TO BE EXCAVATED, AS SHOWN ON THE PLANS, AND AS DIRECTED BY THE COMMISSIONER. FOR COMBINATION CONCRETE CURB AND GUTTER, THE SAWCUT IS REQUIRED TO BE DEEP ENOUGH TO PENETRATE THE EXISTING BASE COURSE WHERE NECESSARY TO ASSURE A STRAIGHT EDGE FOR THE FULL DEPTH OF COMBINATION CONCRETE CURB AND GUTTER. FOR PATCHES AND DRAINAGE STRUCTURES, THE SAWCUT SHALL BE FULL DEPTH. ALL OTHER SAWCUTTING WILL BE TO THE DEPTHS SHOWN ON THE PLANS OR GIVEN IN THE SPECIFICATIONS. ALL SAWCUTTING SHOWN ON THE PLANS OR OTHERWISE REQUIRED FOR THIS WORK WILL BE CONSIDERED INCIDENTAL TO THE CONTRACT.


- 5. ALL ELEVATIONS SHOWN ON THE PLANS ARE BASED ON CHICAGO CITY DATUM WHICH IS 579.88 FEET ABOVE MEAN SEA LEVEL, 1935 ADJUSTMENT.
- 6. THREE QUARTER INCH (3/4") THICK EXPANSION JOINT SHALL BE PLACED BETWEEN THE SIDEWALK AND ALL STRUCTURES SUCH AS ADJACENT BUILDINGS, CURBS, LIGHT STANDARDS, TRAFFIC LIGHT STANDARDS AND MANHOLES WHICH EXTEND THROUGH THE SIDEWALK. THIS WORK SHALL BE CONSIDERED INCIDENTAL TO THE COST OF PCC SIDEWALK.
- 7. THE GENARAL CONTRACTOR IS REQUIRED TO HIRE AN ENVIRONMENTAL FIRM TO CONTINUOUSLY MONITOR THE WORKER SAFETY AND SOIL CONRAMINATION AT SEVERAL LOCATIONS. SEE SPECIAL PROVISION AND SUPPLMENTAL SPECIFICATIONS FOR DETAILS.
- 8. CURB AND GUTTER CONSTRUCTION SHALL PROVIDE A MINIMUM CURB HEIGHT OF 3 INCHES AND A MAXIMUM HEIGHT OF 9 INCHES.
- 9. THE COST OF REMOVING BRICKS WITHIN SIDEWALK REMOVAL LIMITS SHALL BE CONSIDERED INCLUDED IN THE COST OF SIDEWALK REMOVAL. REMOVAL OF EXISTING BENCHES, BICYCLE RACKS, AND TRASH RECEPTACLES WILL BE CONSIDERED INCLUDED IN THE COST OF SIDEWALK REMOVAL.
- 11. THE CONTRACTOR SHALL CHECK THE ELEVATION AT THE PROPERTY LINE BEFORE SETTING THE TOP OF CURB ELEVATION AND, IF NECESSARY, SHALL ALTER THE CURB EXPOSED AND/OR GUTTER ELEVATION TO MEET THE ADJACENT PROPERTY LINE ELEVATION TO THE SATISFACTION OF THE COMMISSIONER.
- 12. ALL WORK MUST CONFORM TO THE MOST CURRENT CHICAGO DEPARTMENT OF TRANSPORTATION RULES AND REGULATIONS FOR WORK IN THE PUBLIC WAY IN COMPLIANCE WITH THE AMERICANS WITH DISABILITY ACT, AVAILABLE ON THE CITY OF CHICAGO WEBSITE.

UTILITY NOTES

- 1. PLAN DIMENSIONS AND DETAILS RELATIVE TO EXISTING STRUCTURES HAVE BEEN TAKEN FROM EXISTING PLANS AND ARE SUBJECT TO NOMINAL CONSTRUCTION VARIATIONS. IT SHALL BE THE CONTRACTOR'S RESPONSIBILITY TO VERIFY SUCH DIMENSIONS AND DETAILS IN THE FIELD AND MAKE THE NECESSARY APPROVED ADJUSTMENTS PRIOR TO CONSTRUCTION OR ORDERING MATERIALS. SUCH VARIATIONS WILL NOT BE CAUSE FOR ADDITIONAL COMPENSATION FOR A CHANGE IN THE SCOPE OF THE WORK; HOWEVER, THE CONTRACTOR WILL BE PAID AT THE CONTRACT UNIT PRICE FOR THE WORK.
- 2. THE CONTRACTOR IS RESPONSIBLE FOR CONTACTING THE CHICAGO UTILITY ALERT NETWORK AT (312) 744-7000 OR J.U.L.I.E. AT (800) 892-0123 SO THAT UTILITIES AND THEIR APPURTENANCES MAY BE LOCATED AND ADJUSTED OR MOVED, IF NECESSARY, AT LEAST 48 HOURS PRIOR TO THE START OF CONSTRUCTION OPERATIONS. THE CONTRACTOR MUST COOPERATE WITH ALL UTILITY OWNERS AS PROVIDED FOR IN THE 'STANDARD SPECIFICATIONS'.
- 3. THE CITY DOES NOT GUARANTEE THE COMPLETENESS OR ACCURACY OF THE INFORMATION SHOWN ON THE PLANS REGARDING UTILITIES, EITHER PUBLIC OR PRIVATE, SUCH AS SEWERS, MANHOLES, CATCH BASINS, GAS AND WATER MAIN, TELEPHONE AND ELECTRICAL DUCT LINES, AND SIMILAR STRUCTURES. THE CONTRACTOR MUST VERIFY THE EXACT LOCATION OF ALL UTILITIES THAT MAY INTERFERE WITH THE CONSTRUCTION OPERATIONS AND MUST REPORT TO THE COMMISSIONER ANY OMISSIONS AND DIFFERENCES FROM LOCATIONS SHOWN ON THE PLANS. THE COST OF THIS WORK WILL BE CONSIDERED INCIDENTAL TO THE CONTRACT.
- 4. THE CONTRACTOR IS REQUIRED TO PROTECT ANY EXISTING AND NEW UTILITIES WHEN CONSIDERED NECESSARY BY THE COMMISSIONER, USING METHODS APPROVED BY THE COMMISSIONER. THE CONTRACTOR WILL BRACE AND SUPPORT THE UTILITIES PROPERLY TO PREVENT SETTLEMENT, DISPLACEMENT, OR CHANGE TO THE UTILITIES. THE COST OF UTILITY PROTECTION AS SPECIFIED IN HEREIN WILL BE CONSIDERED INCIDENTAL TO THE CONTRACT.
- 5. ANY UTILITY THAT IS DAMAGED DURING CONSTRUCTION WILL BE REPAIRED OR REPLACED BY THE CONTRACTOR AT HIS/HER OWN EXPENSE.
- 6. EXCEPT AS NOTED ON THE PLANS, IN THE GENERAL NOTES, AND IN THE SPECIFICATIONS, UTILITY RELOCATION OR ADJUSTMENT WILL BE PERFORMED BY THE RESPECTIVE UTILITY OWNERS AT THEIR OWN EXPENSE AND WILL NOT BE CONSIDERED PART OF THIS CONTRACT. THE CONTRACTOR WILL NOTIFY THE AFFECTED UTILITY OWNERS AND SCHEDULE HIS/HERWORK ACCORDINGLY. THE COST OF THIS COORDINATION WILL BE CONSIDERED INCIDENTAL TO THE CONTRACT.
- 7. ANY PAVEMENT REMOVAL AND REPLACEMENT OPERATION TO BE DIRECTLY ABOVE A COMMONWEALTH EDISON (COMED) COMPANY LINE WILL BE CLOSELY COORDINATED WITH COMED. REPRESENTATIVES FROM THE CITY OF CHICAGO DEPARTMENT OF TRANSPORTATION AND COMED MUST BE PRESENT DURING PERFORMANCE OF THIS WORK, AS ARRANGED BY THE CONTRACTOR.
- 8. PEOPLES GAS FACILITIES ARE PRESENT WITHIN AREA OF CONSTRUCTION. SERVICE IS AFFECTED. USE EXTREME CAUTION NEAR ALL GAS FACILITIES DURING CONSTRUCTION AND RELATED EXCAVATION ACTIVITIES. HAND DIGGING OR NON-INVASIVE EXCAVATION IS REQUIRED TO FIELD VERIFY THE HORIZONTAL AND VERTICAL LOCATION OF GAS FACILITIES PRIOR TO CROSSING AND WORKING WITHIN 3' OF ALL GAS FACILITIES. A MINIMUM OF 3' HORIZONTAL EDGE-TO-EDGE CLEARANCE IS REQUIRED FOR GAS FACILITIES WITH DIAMETERS OF 16" OR SMALLER, AND 5' EDGE-TO-EDGE CLEARANCE FOR GAS FACILITIES WITH DIAMETERS 18" AND LARGER. MAINTAIN A MINIMUM OF 18" EDGE TO EDGE VERTICAL CLEARANCE WHEN CROSSING GAS FACILITIES 16" OR LESS IN DIAMETER, AND 24" EDGE-TO-EDGE VERTICAL CLEARANCE WHEN CROSSING 18" AND LARGER DIAMETER GAS FACILITIES. CONTACT 811 CHICAGO/DIGGER 312-744-7000 FOR LOCATES 48 HOURS PRIOR TO START OF CONSTRUCTION.





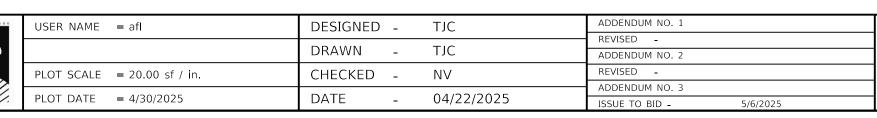

CITY OF CHICAGO
DEPARTMENT OF TRANSPORTATION

GENERAL	NOTES

SHEET 1

SCALE

OF 3 SHEETS STA.

F.A. RTE. SECTION COUNTY TOTAL SHEET NO.

COOK 50 2

TO STA. ILLINOIS FED. AID PROJECT

UTILITY NOTES (CONT.)

- 9. THE USE OF CONCRETE, FLOW FILL, OR THE LIKE IS PROHIBITED WITHIN 24 INCHES OF ALL GAS FACILITIES, NOR SHALL IT ENCASE ANY GAS FACILITY. A BUFFER OF 24" SAND IS TO BE USED BETWEEN FLOW FILL AND ALL GAS FACILITIES. A MINIMUM OF 6" FA-02 OR FM-02 SAND SHALL BE USED WHEN BACKFILLING OTHER MATERIALS AROUND ANY EXPOSED GAS FACILITY. CONTRACTOR EXPOSING GAS FACILITY IS RESPONSIBLE FOR PROVIDING THE SAND. ANY DAMAGES TO PEOPLES GAS FACILITIES SHALL BE THE RESPONSIBILITY OF THE INSTALLING UTILITY AND THEIR CONTRACTOR(S). CALL 866-556-6002 IMMEDIATELY FOR ANY DAMAGES TO THE GAS FACILITIES. VERTICAL ADJUSTMENTS REQUIRED FOR VALVE BASIN FRAMES, COVERS, GAS SHUT-OFF VALVES, ROADWAY BOXES SHALL BE COMMUNICATED TO JACIE SPUDIC, PLANNING-PERMIT GROUP, JACIE.SPUDIC@PEOPLESGASDELIVERY.COM, 4 WEEKS PRIOR TO THE START OF RESTORATION FOR PLANNING & SCHEDULING. ALL GAS FACILITIES ARE TO BE MAINTAINED.
- 10. PEOPLES GAS CAST IRON AND DUCTILE IRON GAS MAINS MAY REQUIRE SUPPORT DURING CONSTRUCTION AND RELATED EXCAVATION ACTIVITIES. ANY EXPOSED JOINTS MUST BE SUPPORTED AND CAST IRON JOINTS SEALED BY GAS COMPANY PERSONNEL. CONTACT THE LOCAL PGL SHOP ENGINEERING SUPERVISOR, A MINIMUM OF 5 BUSINESS DAYS PRIOR TO EXCAVATION TO SET UP ON-SITE INSPECTION. INSPECTION BY PEOPLES GAS IS REQUIRED PRIOR TO BACKFILL. INSPECT GAS MAIN AND COATING INTEGRITY PRIOR TO BACKFILL.
- 11. ANY ISSUES OR WORK NEEDED WHEN CROSSING OR ADJACENT TO ANY COMED ASSETS, PLEASE CONTACT JENNIFER MABERTO @ 779.231.2246 OR VIA EMAIL @JENNIFER,MABERTO@COMED,COM AT LEAST SIX WEEKS PRIOR TO CONSTRUCTION START.

ADA NOTES

1. FOR THE LATEST CITY OF CHICAGO ADA REQUIREMENTS FOR THE PLANS GO TO WWW.CITYOFCHICAGO.ORG.

LANDSCAPING NOTES

- 1. THE CONTRACTOR IS REQUIRED TO OBTAIN A PERMIT TO REMOVE, PLANT, SPRAY, OR IN ANY WAY AFFECT THE GENERAL HEALTH OR STRUCTURE OF TREES IN THE PUBLIC WAY. THIS PERMIT MAY BE OBTAINED FROM THE DEPUTY COMMISSIONER OF CITY OF CHICAGO BUREAU OF FORESTRY.
- 2. TREES MUST BE TAGGED BY C.D.O.T. CONTACT JEFF BRINK AT (312) 744-7844.

DEPT. OF WATER MANAGEMENT NOTES

- 1. THE CONTRACTOR IS RESPONSIBLE FOR THE ADEQUATE PROTECTION OF THE EXITING SEWERS, DRAIN CONNECTIONS, SEWER STRUCTURES, AND BENCH MONUMENTS DURING CONSTRUCTION OPERATIONS, AND THE USE OF HEAVY EQUIPMENT WITHIN THE LIMITS OF THE PROJECT.
- 2. IT IS THE RESPONSIBILITY OF THE UTILITY COMPANY/GOVERNMENT AGENCY AND ITS CONSULTANTS/CONTRACTORS TO OBTAIN THE NECESSARY BACKGROUND INFORMATION FROM THE DRAWINGS/CONTRACT PLANS AND FOR EXISTING FACILITIES PROTECTION DURING THE CONSTRUCTION STAGE. RECORDS FROM THE DEPARTMENT OF BUILDINGS, SEWER UNIT INCLUDE: EXISTING SEWERS, DRAIN CONNECTIONS, SEWER STRUCTURES, BENCH MONUMENT LOCATIONS, ORDINANCE GRADES, AGE OF SEWER, AND PIPE MATERIAL. COPIES OF SEWER RECORDS CAN BE OBTAINED ON PAYMENT TO THE DEPARTMENT OF BUILDINGS, SEWER UNIT, LOCATED AT CITY HALL, 121 N. LASALLE ST. ROOM 900, CHICAGO. IL 60602.
- 3. A PERMIT IS REQUIRED FROM THE DEPARTMENT OF BUILDINGS, SEWER UNIT PRIOR TO THE CONSTRUCTION OF, OR REPAIRS TO, UNDERGROUND SEWERS, DRAIN CONNECTIONS, OR SEWER STRUCTURES, INCLUDING THE ADJUSTMENT OF SEWER STRUCTURES AND THE REMOVAL/REPLACEMENT OF FRAMES AND LIDS. THE PERMIT MUST BE OBTAINED BY A DRAINLAYER CURRENTLY LICENSED FROM THE DEPARTMENT OF BUILDINGS, SEWER UNIT.
- IN ORDER TO PROTECT THE CITY'S BENCH MONUMENTS, ALL BENCH MONUMENT LOCATIONS WITHIN THE LIMITS OF THE PROJECT SHOULD BE LISTED ON THE PLAN SHEETS. IF ANY BENCH MONUMENTS ARE NOT LOCATED OR IF DAMAGE TO ANY BENCH MONUMENTS IS ENCOUNTERED, PLEASE CONTACT THE DEPARTMENT OF WATER MANAGEMENT IMMEDIATELY AT (312) 747-7892 OR (312) 747-7893. THE CONTRACTOR IS RESPONSIBLE FOR THE COST OF REPLACEMENT OF ANY BENCH MONUMENT DAMAGED OR DESTROYED DURING CONSTRUCTION.
- 5. IN THE RELOCATION OR CONSTRUCTION OF PRIVATE OR PUBLIC UTILITIES, INCLUDING PIPE UNDERDRAINS AND/OR SUBDRAINS, THE UTILITY SHOULD BE LOCATED AS FAR AWAY AS POSSIBLE FROM THE DEPARTMENT OF WATER MANAGEMENT FACILITY. A MINIMUM DISTANCE OF THE OUTSIDE DIAMETER OF THE SEWER (O.D.) PLUS 4 FEET MUST BE MAINTAINED BETWEEN THE SEWER AND THE UTILITY CENTER LINES. IF THE OUTSIDE DIAMETER/WIDTH OF UTILITY CONDUIT IS MORE THAN THE SEWER O.D., A MINIMUM OF 4 FEET HORIZONTAL CLEARANCE MUST BE OBTAINED FROM THE OUTSIDE FACE TO OUTSIDE FACE. FOUR FEET HORIZONTAL CLEARANCE IS ALSO REQUIRED FROM ALL SEWER STRUCTURES. A MINIMUM OF 10 FEET HORIZONTAL CLEARANCE AND 18 INCHES VERTICAL CLEARANCE IS DESIRABLE BETWEEN THE SEWER AND A WATER MAIN.
- 6. MANHOLES, CATCH BASINS, AND INLETS MUST BE PROTECTED FROM THE ENTRY OF ASPHALT/DEBRIS INTO THE SEWER SYSTEM DURING CONSTRUCTION. THE CONTRACTOR WILL MARK LOCATIONS OF ALL SEWER STRUCTURES ON THE SIDEWALK BEFORE STARTING PAVEMENT REMOVAL/REPLACEMENT. ADJUSTMENT OF FRAMES AND LIDS OF SEWER STRUCTURES MUST BE COMPLETED PRIOR TO STREET RESURFACING.
- 7. THE UTILITY COMPANY/GOVERNMENT AGENCY OR ITS REPRESENTING CONTRACTOR MUST MAINTAIN ACCESS TO THE EXISTING SEWER FACILITIES, INCLUDING SEWER STRUCTURES, AT ALL TIMES AND COORDINATE THE PROPOSED IMPROVEMENTS WITH THE DEPARTMENT OF WATER MANAGEMENT ENGINEER/INSPECTOR TO AVOID ANY INTERRUPTION OF THE SEWER FACILITIES' MAINTENANCE OR SERVICES. THE SEWER FLOW MUST BE MAINTAINED AT ALL TIMES.

- 8. THE CONTRACTOR MUST LOCATE AND PROMPTLY AND PROPERLY CONNECT TO THE NEW SEWERS ALL LIVE HOUSE DRAINS, CATCH BASIN DRAINS, AND OTHER EXISTING LATERALS, DRAINS, AND SEWERS OF WHATEVER NATURE WHICH ARE CONNECTED TO THE EXISTING SEWERS BEING REPAIRED OR REPLACED.
- 9. EXISTING CATCH BASIN LATERALS TO BE REUSED MUST BE RODDED AND FLUSHED IN THE PRESENCE OF THE DEPARTMENT OF WATER MANAGEMENT INSPECTOR. A NEW CONNECTION TO THE MAIN SEWER IS REQUIRED IF THE EXISTING CATCH BASIN LATERAL IS NOT APPROVED BY THE SEWER INSPECTOR.
- 10. WHEN A SEWER STRUCTURE IS ABANDONED, ALL PIPE OPENINGS MUST BE PLUGGED, STRUCTURES FILLED WITH TRENCH BACKFILL, LIDS AND FRAMES REMOVED, AND SURFACE RESTORED AS PER THE DEPARTMENT OF WATER MANAGEMENT STANDARDS AND SPECIFICATIONS.
- 11. WHEN DIRECTED BY THE COMMISSIONER, THE CONTRACTOR IS REQUIRED TO REPLACE ANY BROKEN FRAMES AND LIDS OF SEWER STRUCTURES WITH THE DEPARTMENT OF WATER MANAGEMENT STANDARD FRAMES AND LIDS.
- 12. THE FRAMES AND LIDS OF SEWER STRUCTURES TO BE ABANDONED, REMOVED, OR FILLED SHOULD BE SALVAGED, AND THE CONTRACTOR MUST NOTIFY THE DEPARTMENT OF WATER MANAGEMENT FOR PICK UP.
- 13. IN ARTERIAL STREETS, PERFORATED LIDS MUST BE PLACED ON ALL SEWER STRUCTURES UNLESS OTHERWISE APPROVED BY THE COMMISSIONER. IN RESIDENTIAL STREETS, MANHOLES MAY REQUIRE CLOSED LIDS. CONTRACTOR TO COORDINATE WITH THE DEPARTMENT OF WATER MANAGEMENT INSPECTOR.
- 14. DURING CONSTRUCTION OF THIS PROJECT, THE CONTRACTOR SHALL MAINTAIN THE SURFACE DRAINAGE OF THE ROAD AT ALL TIMES.
- 15. IF THE CONDITION OF EXISTING CATCH BASINS OR INLETS IS SUCH THAT THEIR ADJUSTMENT IS NOT FEASIBLE AT THE TIME OF CONSTRUCTION, THE CONTRACTOR MUST FURNISH AND INSTALL NEW CATCH BASINS OR INLETS AND THEIR APPURTENANCES AS DIRECTED BY THE COMMISSIONER AND WITH THE CONCURRENCE OF THE DEPARTMENT OF WATER MANAGEMENT THIS WORK WILL BE PAID FOR AT THE CONTRACT UNIT PRICE EACH FOR 'CATCH BASINS, TYPE A, 4 FT DIAMETER, TYPE 1 FRAME, OPEN LID (CITY OF CHICAGO)' OR FOR 'INLETS, TYPE A, TYPE 1 FRAME, OPEN LID (CITY OF CHICAGO)'.
- 16. THE LOCATION OF PROPOSED WATER LINES, METER VAULTS, VALVES AND RPZ'S SHOWN ON THE PLANS ARE APPROXIMATE. THE CONTRACTOR SHALL MARK THE LAYOUT AND LOCATION OF THE WATER LINES, METER VAULTS, VALVES, AND RPZ'S FOR REVIEW BY COMMISSIONER PRIOR TO ANY EXCAVATION.
- 17. THE CONTRACTOR SHALL VERIFY THE LOCATION OF ALL PROPOSED WATER SERVICE CONNECTIONS PRIOR THE INSTALLATION OF THE IRRIGATION SYSTEM. THE CITY OF CHICAGO, DEPARTMENT OF WATER MANAGEMENT WILL PERFORM THE WATER SERVICE CONNECTION TO THE EXISTING WATER MAIN. IT SHALL BE THE CONTRACTOR'S RESPONSIBILITY TO OBTAIN ALL NECESSARY PERMITS AND PAY THE ASSOCIATED FEES. ALL PERMIT FEES WILL BE CONSIDERED INCIDENTAL TO THE CONTRACT.
- 18. IN CASE OF DAMAGE TO THE CITY'S SEWER SYSTEM, PRIVATE AND PUBLIC DRAIN CONNECTIONS, AND/OR BENCH MONUMENTS, THE CONTRACTOR MUST CONTACT THE DEPARTMENT OF BUILDINGS, SEWER UNIT, IMMEDIATELY AT PHONE NUMBER (312) 744-3351. THE CONTRACTOR MUST, AT HIS/HER OWN COST, REPLACE THE AFFECTED SEWERS, DRAIN CONNECTIONS, SEWER STRUCTURES AND/OR BENCH MONUMENTS AS NECESSARY. THE SEWER FLOWS MUST BE MAINTAINED AT ALL TIMES.
- 19. FLOW RESTRICTORS MUST BE INSTALLED IN ALL CATCH BASINS, OUTSIDE OF THE CENTRAL BUSINESS DISTRICT. FLOW RESTRICTORS MUST NOT BE INSTALLED IN CLOSE PROXIMITY TO VIADUCT AREAS, BUS STOPS, OR EMERGENCY ENTRANCES. FLOW RESTRICTORS ARE AVAILABLE FOR PICK-UP AT THE DWM'S CENTRAL DISTRICT, LOCATED AT 3901 S. ASHLAND AVENUE, BY CALLING (312) 747-1777, BETWEEN 7:00 AM 3:00 PM, 48 HOURS IN ADVANCE.
- 20. AS-BUILT PLANS MUST BE SUBMITTED SOON AFTER WORK COMPLETION. FINAL PAYMENT WILL NOT BE MADE TO THE CONTRACTOR UNTIL THE SEWER UNIT OF THE DWM ACKNOWLEDGES RECEIPT OF "AS-BUILT PLANS".
- 21. IN CASE OF DAMAGE TO THE CITY OF CHICAGO SEWERS, PRIVATE AND PUBLIC DRAINS, SEWER STRUCTURES AND/OR BENCH MONUMENTS, THE CONTRACTOR SHALL IMMEDIATELY CONTACT THE DEPARTMENT OF WATER MANAGEMENT AT (312) 747-7892 OR (312) 747-7893.
- 22. PERFORATED LIDS SHALL BE PLACED ON ALL MANHOLES AND CATCH BASINS.
- 23. CITY OF CHICAGO WATER VALVE VAULTS AND SEWER STRUCTURES SHALL NOT BE CLOSED, COVERED OR OTHERWISE OBSTRUCTED DURING CONSTRUCTION WITHOUT WRITTEN PERMISSION FROM THE CITY OF CHICAGO DEPARTMENT OF WATER MANAGEMENT.
- 24. WHENEVER, DURING CONSTRUCTION OPERATIONS, ANY LOOSE MATERIAL IS DEPOSITED IN THE FLOW LINE OF DRAINAGE STRUCTURES SUCH THAT THE NATURAL FLOW OF WATER IS OBSTRUCTED, IT SHALL BE REMOVED AT THE CLOSE OF EACH WORKING DAY. AT THE CONCLUSION OF CONSTRUCTION OPERATIONS, ALL UTILITY STRICTURES SHALL BE FREE FROM DIRT AND DEBRIS. THE WORK SPECIFIED ABOVE WILL NOT BE PAID FOR SEPARATELY BUT SHALL BE INCLUDED IN THE COST FOR CATCH BASINS AND MANHOLES TO BE ADJUSTED IN THIS CONTRACT.
- 25. ANY EXISTING STORM SEWER DAMAGED BY THE CONTRACTOR DURING CONSTRUCTION SHALL BE REPLACED BY THE CONTRACTOR AT NO COST TO THE CITY.
- 26. THE CONTRACTOR SHALL MAINTAIN THE SURFACE DRAINAGE OF THE ROAD DURING CONSTRUCTION UNTIL THE CITY ACCEPTS MAINTENANCE OF THE IMPROVED STREET.
- 27. FOR FULL DEPTH CONSTRUCTION OF THE STREET, PLEASE MAKE A NOTE IN THE PLAN ALL THE SEWER(S) IN THE PROJECT AREA WILL BE TELEVISED BEFORE AND AFTER CONSTRUCTION. CONTACT DEPARTMENT OF WATER MANAGEMENT AT (312) 747-4680.
- 28. THE CONTRACTOR IS REQUIRED TO CONDUCT A PRE-CONSTRUCTION VIDEOTAPED INSPECTION PRIOR TO THE ISSUANCE OF A SEWER PERMIT AND A POST-CONSTRUCTION VIDEOTAPED INSPECTION PRIOR TO ACCEPTANCE OF THE SEWER. THE VIDEOTAPE MUST BE SUBMITTED TO THE SEWER UNIT OF THE DWM FOR REVIEW AND APPROVAL. SHOULD PRE-CONSTRUCTION TELEVISING INDICATE CONDITIONAL ISSUES WITH THE SEWER, IT SHALL BE REPLACED OR REHABILITATED PRIOR TO CONSTRUCTION AS PART OF THE PROJECT IMPROVEMENT.
- 29. PLEASE SEE CDWM-SEWER SECTION'S REQUIREMENTS FOR EXISTING FACILITY CONSTRUCTION.

PUBLIC BUILDING COMISSION NOTES


CONTRACTOR WILL BE REQUIRED TO PREPARE A PHASING AND LOGISTICS PLAN WITHIN THIRTY (30) DAYS OF ISSUANCE OF THE NOTICE TO PROCEED ('NTP') FOR REVIEW AND APPROVAL BY CDOT AND PBC, PRIOR TO THE MOBILIZATION AND COMMENCEMENT OF ANY WORK. THE CONTRACTOR SHALL ALSO BE RESPONSIBLE FOR PROVIDING CRITICAL SUBMITTALS, AS DETERMINED BY THE PBC, WITHIN THIRTY (30) DAYS OF ISSUANCE OF THE NTP.

TREE PLANTING SCHEDULE

SYMBOL	NAME	COMMON NAME	QUANTITY
SR	SYRINGA RETICULATA	IVORY SILK	4 EACH
		TOTALS	4 EACH
	• SPRING PLANTING		





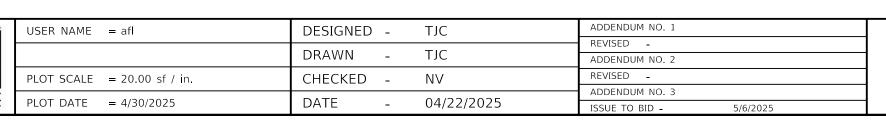


CITY OF CHICAGO
DEPARTMENT OF TRANSPORTATION


		OFNE				F.A. RTE.	SEC	TION	C	OUNTY	TOTAL SHEETS	SHEE NO.
GENERAL NOTES									(COOK	50	3
						_						
	SHEET 2	OF 3	SHEETS	$ST\Delta$	TO STA			TILINOIC FE	D AID DDC	VICCT		

SUMMARY OF QUANTITIES

T⊟M#	DESCRIPTION	UNIT	QUANTITY
1	TREE REMOVAL (1 TO 6 UNITS DIAMETER)	UNIT	0
2	TREE REMOVAL (6 TO 15 UNITS DIAMETER)	UNIT	16
3	TREE REMOVAL (OVER 15 UNITS DIAMETER)	UNIT	144
4	TREE PROTECTION	EACH	4
5 6	ROOTPRUNING EARTH EXCAVATION	FOOT	0
7	TRENCH BACKFILL	CUYD	814 1121
8	TRENCH BACKFILL, WATERMAIN	CUYD	435
9	TOPSOIL FURNISH AND PLACE, 4-INCH	SQYD	395
10	SHREDDED HARDWOOD BARKMULCH	SQYD	18
11	SODDING, SALTTOLERANT	SQYD	395
12	TREE, ORNAMENTAL, 2.5" - 3.0" CALIPER, BALLED AND BURLAPPED (OPEN AREAS)	EACH	4
13	TREE, SHADE, 2.0"- 3.0" CALIPER, BALLED AND BURLAPPED (OPEN AREAS)	EACH	0
14	INLET FILTERS	EACH	7
15	SUBBASE GRANULAR MATERIAL, TYPEB, 6-INCH	CUYD	340
16	PORTLAND CEMENT CONCRETE BASE COURSE, 7-INCH	SQYD	0
17	PORTLAND CEMENT CONCRETE BASE COURSE, 9-INCH	SQYD	1944
18	BITUMINOUSMATERIALS(TACKCOAT)	POUND	1394
19	LEVELING BINDER (HAND METHOD), N50	TON	3
20	LEVELING BINDER (MACHINEMETHOD), N50 1-1/2 INCH	TON	167
21	HOT-MIXASPHALTSURFACECOURSE, IL-19, MIX"D", N50, 2 INCH	TON	227
22	HOT-MIXASPHALT SPEED HUMPS	EACH	0
23	HIGH EARLY STRENGTH PORTLAND CEMENT CONCRETE PAVEMENT 10 INCH	CUYD	0
24	PORTLAND CEMENT CONCRETE DRIVEWAY AND ALLEY PAVEMENTS, 8-INCH	SQYD	69
25	PORTLAND CEMENT CONCRETE SIDEWALK 5 INCH	SQFT	3588
26	PORTLAND CEMENT CONCRETE ADA RAMP 5 INCH	SQFT	345
27	PORTLAND CEMENT CONCRETE SIDEWALKS INCH	SQFT	300
28	PORTLAND CEMENT CONCRETE ADA RAMP 8 INCH	SQFT	250
29	LINEAR DETECTABLE WARNING TILES (CASTIRON)	SQFT	40
30	HOT-MIXASPHALTSURFACEREMOVAL, VARIABLE DEPTH	SQYD	21
31	PAVEMENTREMOVAL	SQYD	2463
32	CURB REMOVAL	FOOT	0
33	COMBINATION CURB AND GUTTER REMOVAL	FOOT	197
34	SIDEWALKREMOVAL	SQFT	3427
35	SAW CUTTING PAVEMENT	FOOT	787
36	CONCRETE COLLAR	CUYD	0
37	HOUSEDRAIN, "PRIVATEDRAIN", EXTRA STRENGTH VITRIFIED CLAY PIPE, TYPE 1, 6 INCH	FOOT	0
38	HOUSEDRAIN, DUCTILEIRON PIPE, TYPE1, 6 INCH	FOOT	0
39 40	STORM SEWER, EXTRA STRENGTH VITRIFIED CLAY PIPE, TYPE 2, 8 INCH STORM SEWER, EXTRA STRENGTH VITRIFIED CLAY PIPE, TYPE 2, 12 INCH	FOOT FOOT	0
41	STORM SEWER, DUCTILE IRON PIPE, TYPE 2, 8 INCH	FOOT	80
42	STORM SEWER, DUCTILE IRON PIPE, TYPE 2, 10 INCH	FOOT	0
43	STORM SEWER, DUCTILE IRON PIPE, TYPE2, 12 INCH	FOOT	0
44	STORM SEWER, DUCTILE IRON PIPE, TYPE2, 24 INCH	FOOT	110
45	STORM SEWER, DUCTILE IRON PIPE, TYPE2, 48-INCH	FOOT	0
46	STORM SEWER, DUCTILE IRON PIPE, TYPE2, 36-INCH	FOOT	345
47	STORM SEWER, REINFORCED CONCRETE PIPE, TYPE 2, 36-INCH	FOOT	390
48	STORM SEWER, REINFORCED CONCRETE PIPE, TYPE 2, 42-INCH	FOOT	0
49	STORM SEWER, REINFORCED CONCRETE PIPE, TYPE 2, 48 INCH	FOOT	0
50	EXISTING SEWER TO BE REMOVED	FOOT	105
51	SEWER CLEANING AND TELEVISING	FOOT	2173
52	DUCTILE IRON WATERMAIN TEE, 8" X6"	EACH	0
53	DUCTILE IRON WATERMAIN TEE, 8" X8"	EACH	4
54	DUCTILE IRON WATERMAIN TEE, 12" X 8"	EACH	0
55	DUCTILE IRON WATERMAIN TEE, 12" x 12"	EACH	0
56	DUCTILE IRON WATERMAIN 6"	FOOT	0
57	WATERMAIN INSALLED IN OPEN CUT, 8"	FOOT	915
58	WATERMAIN INSALLED IN OPEN CUT, 12"	FOOT	0
59	WATERVALVE, 8"	EACH	3
60	WATERVALVE, 12"	EACH	0
61	DUCTILE IRON WATERMAIN FITTINGS 6" 45 DEGREE BEND	EACH	3
62	DUCTILE IRON WATERMAIN FITTINGS 8" 11.25 DEGREE BEND	EACH	0
63	DUCTILE IRON WATERMAIN FITTINGS 8" 22.5 DEGREE BEND	EACH	0
64	DUCTILE IRON WATERMAIN FITTINGS 8" 45 DEGREE BEND	EACH	10
	DUCTILE IRON WATERMAIN FITTINGS 12" 45 DEGREE BEND	EACH	0
65	WATER SERVICE LINE 1"	FOOT	0
65 66	REMOVE EXISTING FIRE HYDRANT	EACH	2
65 66 67	LIN ADDANTINICALLIA TONI		2
65 66 67 68	HYDRANT INSTALLATION	EACH	
65 66 67 68 69	FIREHYDRANTS (SPECIAL - FLUSHING HYDRANT)	EACH	1
65 66 67 68 69 70	FIREHYDRANTS (SPECIAL - FLUSHING HYDRANT) REMOVE EXISTING VALVE AND VAULT	EACH EACH	1 3
65 66 67 68 69 70 71	FIREHYDRANTS (SPECIAL - FLUSHING HYDRANT) REMOVE EXISTING VALVE AND VAULT TRANSITION SLEEVE, 6"	EACH EACH EACH	1 3 0
65 66 67 68 69 70 71 72	FIREHYDRANTS (SPECIAL - FLUSHING HYDRANT) REMOVE EXISTING VALVE AND VAULT TRANSITION SLEEVE, 6" TRANSITION SLEEVE, 8"	EACH EACH EACH	1 3 0 4
65 66 67 68 69 70 71	FIREHYDRANTS (SPECIAL - FLUSHING HYDRANT) REMOVE EXISTING VALVE AND VAULT TRANSITION SLEEVE, 6"	EACH EACH EACH	1 3 0


ITEM#	DESCRIPTION DUCTU FURCALIA CONTROLLO DE CON	UNIT	QUANTITY
76 77	DUCTILE IRON MJSLEEVE, 8" RESILIENTWEDGE VALVE 6"	EACH EACH	0
77 78	RESILENTWEDGE VALVE8"	EACH	0
79 79	WATER SERVICE SHUT OFF BOX REMOVAL AND REPLACEMENT	EACH	0
80	12" PVC ENCASEMENT	FOOT	0
81	VALVEBOXREMOVAL	EACH	0
82	CATCH BASINS, TYPEA, 4'-DIAMETER, TYPE 1 FRAME, OPEN LID (CITY OF CHICAGO)	EACH	7
83	CATCH BASINS, TYPEA, 4'-DIAMETER, TYPE 1 FRAME, CLOSED LID (CITY OF CHICAGO)	EACH	0
84	MANHOLES, TYPEA, 4'-DIAMETER, TYPE 1 FRAME, CLOSED LID (CITY OF CHICAGO)	EACH	0
85	MANHOLE, 5 FT DIAMETER, TYPEA, FRAMEAND CLOSED LID (CITY OF CHICAGO)	EACH	3
86	INLETS, TYPEA, TYPE1 FRAME, OPEN LID (CITY OF CHICAGO)	EACH	0
87	CATCH BASINS TO BE ADJUSTED	EACH	0
88	MANHOLESTO BE ADJUSTED WITH NEW TYPE 1 FRAME, CLOSED LID	EACH	6
89	CATCH BASINS, TYPEA, 3'-DIAMETER, TYPE 1 FRAME, CLOSED LID (CITY OF CHICAGO)	EACH	0
90	MANHOLES, TYPEA, 3'-DIAMETER, TYPE 1 FRAME, CLOSED LID (CITY OF CHICAGO)	EACH	6
91	MANHOLES, TYPEB, 3'-DIAMETER, TYPE1 FRAME, CLOSED LID (CITY OF CHICAGO)	EACH	1
92	MANHOLES, TYPE C SINGLE-DROP, 3'-DIAMETER, TYPE 1 FRAME, CLOSED LID (CITY OF CHICAGO)	EACH	0
93	TUMBLING BASIN, TYPEA, 4 FT DIAMETER, TYPE 1 FRAME, CLOSELID (CITY OF CHICAGO)	EACH	0
94	TUMBLING BASIN, TYPEA, 5 FT DIAMETER, TYPE 1 FRAME, CLOSED LID (CITY OF CHICAGO)	EACH	1
95	TUMBLING BASIN, TYPEA, 6 FT DIAMETER, TYPE 1 FRAME, CLOSED LID (CITY OF CHICAGO)	EACH	0
96	ADDITIONAL MASONRY	FOOT	2
97	VORTEX RESTRICTOR	EACH	0
98	FRAMES	EACH	1
99	LIDS PERMONANTIAL DE LES	EACH	1
100	REMOVING MANHOLES	EACH	1
101	REMOVING CATCH BASINS	EACH	4
102 103	REMOVING INLETS	EACH FOOT	0 115
103	CONCRETE CURB, TYPEB COMBINATION CONCRETE CURB AND GUTTER, TYPEB-V12	FOOT	1611
104	CONSTRUCTION SIGN	EACH	2
105	CHAIN LINKFENCE, 6	FOOT	0
100	REMOVAL, CHAIN LINKFENCE	FOOT	0
107	ENGINEERSFIELDOFFICE	CALMONTH	0
100	NON-SPECIAL WASTE DISPOSAL	CUYD	628
110	SOIL DISPOSAL ANALYSIS	EACH	1
111	REGULATED SUBSTANCES PRE-CONSTRUCTION PLAN	LSUM	<u>'</u> 1
112	REGULATED SUBSTANCES FINAL CONSTRUCTION REPORT	LSUM	<u>·</u> 1
113	REGULATED SUBSTANCES MONITORING	CALDAY	20
114	TRAFFIC CONTROL COMPLETE	LSUM	1
115	AGGREGATE FOR TEMPORARY ACCESS	TON	70
116	SIGN PANEL, TYPE 1, RETROREFLECTIVE	SQFT	21
117	REMOVE AND SALVAGESIGN PANEL	EACH	5
118	REMOVE AND SALVAGESIGN PANEL AND POLE ASSEMBLY	EACH	2
119	SIGN SUPPORT POST, DIG METHOD	EACH	0
120	SIGN SUPPORT POST, DRILL METHOD	EACH	0
121	THERMOPLASTIC PAVEMENT MARKING, LINE 6 IN	FOOT	123
122	THERMOPLASTIC PAVEMENT MARKING, LINE 12 IN	FOOT	0
123	THERMOPLASTIC PAVEMENT MARKING, LINE 24 IN	FOOT	0
124	DETOUR AND ROAD CLOSURE	ALLOWANCE	1
125	CONDUITIN TRENCH, PVC (SCHEDULE 80), 2" DIA.	FOOT	26
126	CONDUITIN TRENCH, PVC (SCHEDULE 80), 3" DIA.	FOOT	0
127	CONDUIT, DIRECTIONAL BORED, COILABLE NONMETALLIC CONDUIT, SCHEDULE 80, 1 1/4" DIA	FOOT	795
128	CONDUIT, DIRECTIONAL BORED, COILABLE NONMETALLIC CONDUIT, SCHEDULE 80, 2" DIA	FOOT	96
129	TRENCH AND BACKFILL WITH SCREENINGS	FOOT	26
130	INTERCEPT EXISTING CONDUIT	EACH	1
131	HANDHOLE, ELECTRIC, WITH 24" FRAMEAND COVER	EACH	1
132	CLEAN EXISTING CITY MANHOLE OR HANDHOLE	EACH	0
133 134	DRILL EXISTING ELECTRIC HANDHOLE OR MANHOLE ELECTRIC CABLE IN CONDUIT, TRIPLEX, 2-1/C NO. 6, 1-1/C NO. 8 GROUND	EACH FOOT	0 1067
134	LUMINAIRE, LED, ACORN, ARTERIAL, RESIDENTIAL	FACH	9
136	LUMINAIRE, LED, COBRA HEAD, RESIDENTIAL	EACH	9
137	CONTROLLER, STREET LIGHTING, POLE MOUNTED, CONSTANT POWER, 1-PHASE, 120/240V, 60A	EACH	1
138	LIGHTPOLE, ALUMINUM, DAVIT, 18 FT. M.H., 8 FTDAVITARM	EACH	8
139	LIGHTPOLE, ALUMINUM, DAVIT, 18 FT. M.H., 12 FTDAVITARM	EACH	1
140	LIGHT POLE FOUNDATION, METAL, 10" BOLT CIRCLE, 85/8" X5'	EACH	9
141	REMOVE EXISTING STREET LIGHTING EQUIPMENT	LSUM	1
142	BREAKDOWN CONCRETE FOUNDATION, LIGHT POLE	EACH	4
143	RELOCATE POLE COMPLETE	FOOT	0
144	DRILLAND GROUTTIEBARS, No.5, EPOXY COATED	EACH	44
145	PROTECTIVE COAT	SQYD	69
146	INSTALL CONDUIT INTO EXISTING HELIX FOUNDATION	EACH	0
147	GUARD POST	EACH	0
148	TYPE II TEMPORARY WATER MAIN SUPPORT	EACH	2
149	TYPE III TEMPORARY WATER MAIN SUPPORT	EACH	0
150	CATCH BASINSTO BELINED	EACH	0
	RAILROAD PROTECTIVE LIABILITY INSURANCE	LSUM	0

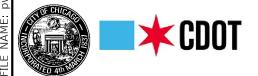


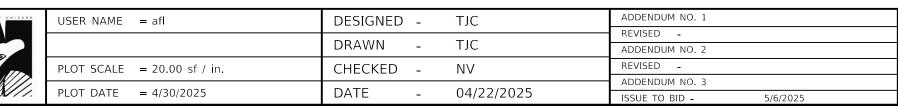




SUMMARY OF QUANTITIES				F.A. RTE.	SECTION	COUNTY	TOTAL SHEETS	SHEI NO	
						COOK	50	4	
		T							
SHEET 3	OF 3	SHEETS	STA.	TO STA.		ILLINOIS FED	AID PROJECT		

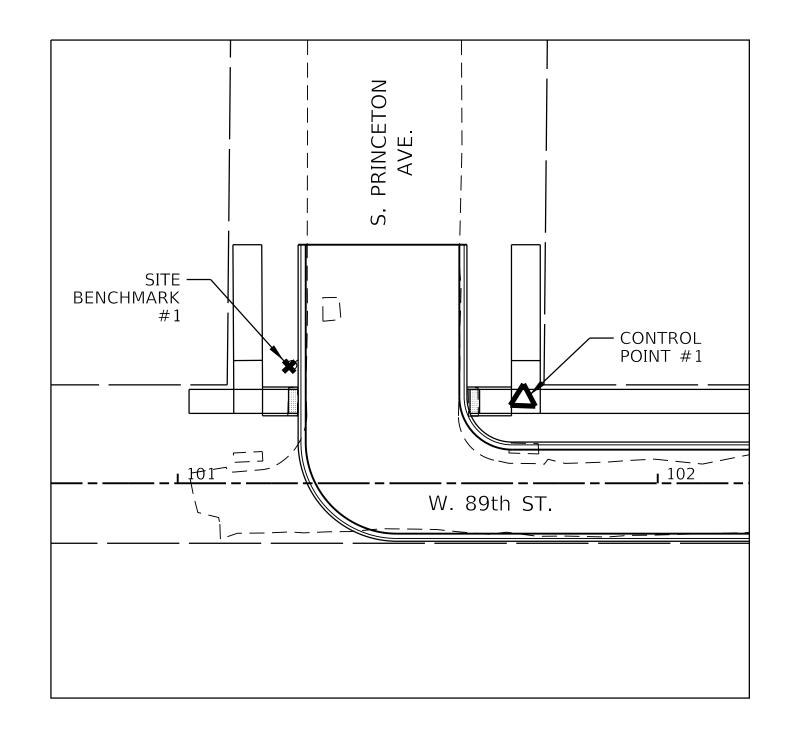

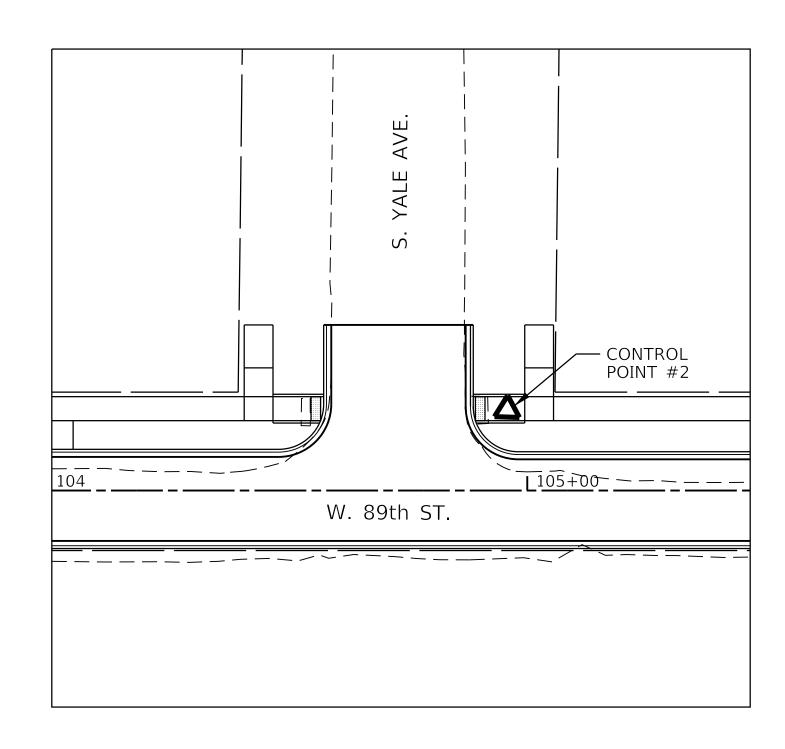

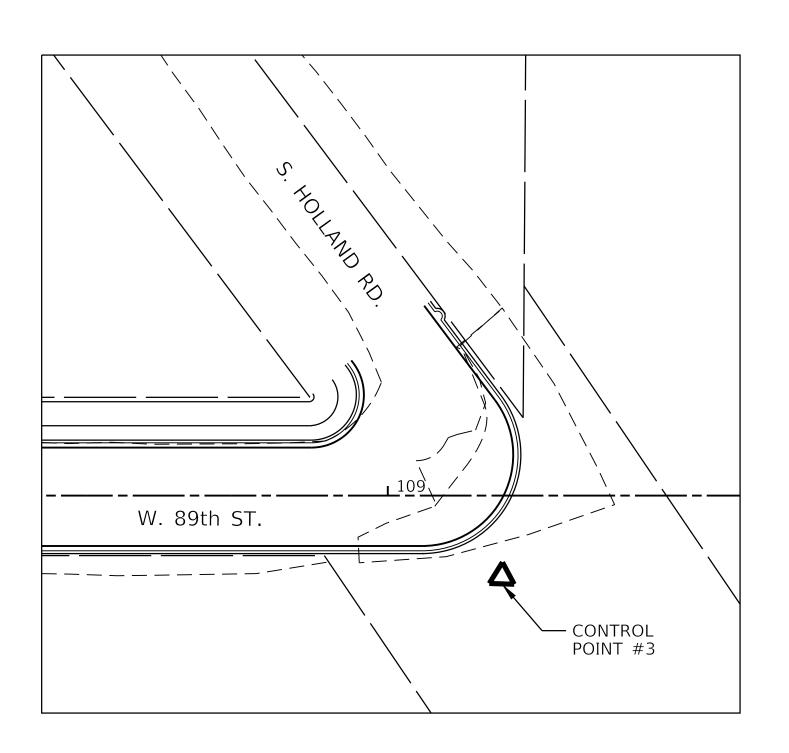

ALIGNMENT TIES AND BENCHMARKS W. 89TH ST.

CONTROL POINT	DESCRIPTION	NORTHING	EASTING	ELEVATION	STATION	OFFSET
CITY BENCHMARK #331	13.3' S. OF N. LINE OF W. 90TH ST. 13.7' W. OF W. LINE OF EGGLESTON AVE.	1845303.276	1174827.981	16.71	SEE NOTE	SEE NOTE
CITY BENCHMARK #375	15.9' W. OF E. LINE OF S. WABASH AVE. 2.0' S. OF S. LINE OF THE FIRST ALLEY SOUTH OF EAST 87TH ST.	1847154.405	1178268.238	8.09	SEE NOTE	SEE NOTE
BM #1	CHAIN BOLT ON FIRE HYDRANT AT THE NORTHWEST CORNER OF W. 89TH ST AND S. PRINCETON AVE	1845930.909	1175698.852	19.44	101+23.23	24.33' LT
CP #1	ADA RAMP LANDING AT NORTHEAST CORNER OF W. 89TH ST AND S. PRINCETON AVE	1845925.948	1175747.782	17.58	101+71.95	17.66' LT
CP #2	ADA RAMP AT NORTHEAST CORNER OF W. 89TH ST AND S. YALE AVE	1845936.409	1176071.474	21.69	104+95.81	16.82' LT
CP #3	WEST SIDE OF DRIVEWAY ENTRANCE ON SOUTHEAST CORNER OF W. 89TH ST AND S. HOLLAND RD	1845917.673	1176500.389	15.78	109+23.81	16.88' RT

NOTE: BENCHMARK/CONTROL POINTS LOCATED OUTSIDE OF PROJECT BOUNDARIES. NOT SHOWN ON SHEET.




ž	OF CHICAGO
PUBLIC BUILDING COMMISSION	
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CBUIL	
1802	<i>M</i> ///.

0	USER NAME = afl	DESIGNED - TJC		ADDENDUM NO. 1
		5541441	TIC	REVISED -
		DRAWN -	TJC	ADDENDUM NO. 2
	PLOT SCALE = 20.0000 ' / in.	CHECKED -	NV	REVISED -
,				ADDENDUM NO. 3
:	PLOT DATE = $4/30/2025$	DATE -	04/22/2025	ISSUE TO BID - 5/6/2025


CITY	OF	CHICAGO
DEPARTMENT	OF	TRANSPORTATION

ALLONINAENIT TIEC AND DENICURAADIC			F.A. RTE.	SECT	ΓΙΟΝ		COUNTY	TOTAL SHEETS			
ALIGNMENT, TIES, AND BENCHMARKS								COOK	50		
	Γ		T								
	SHFFT 1	OF 1	SHEETS	STA 101+27	TO STA 109+25			THIMOIS	EED AI	ID PROJECT	

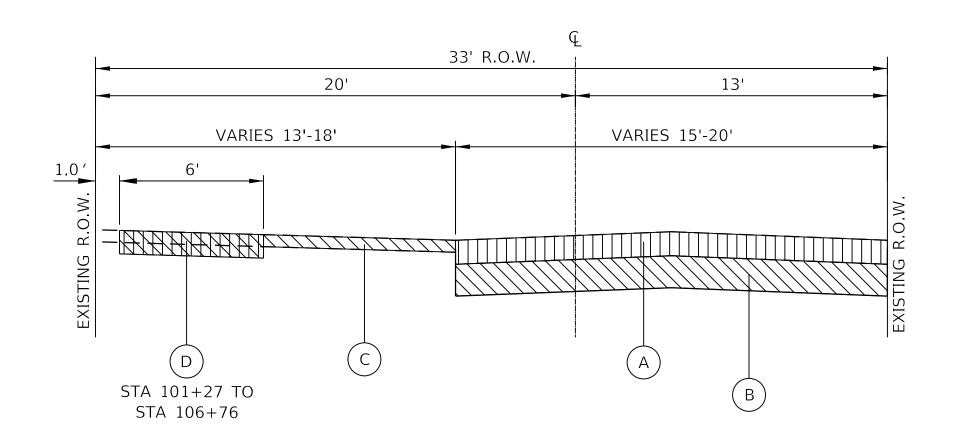

EXISTING TYPICAL SECTION

W. 89TH ST. STA. 101+27 TO 109+25 (NTS)

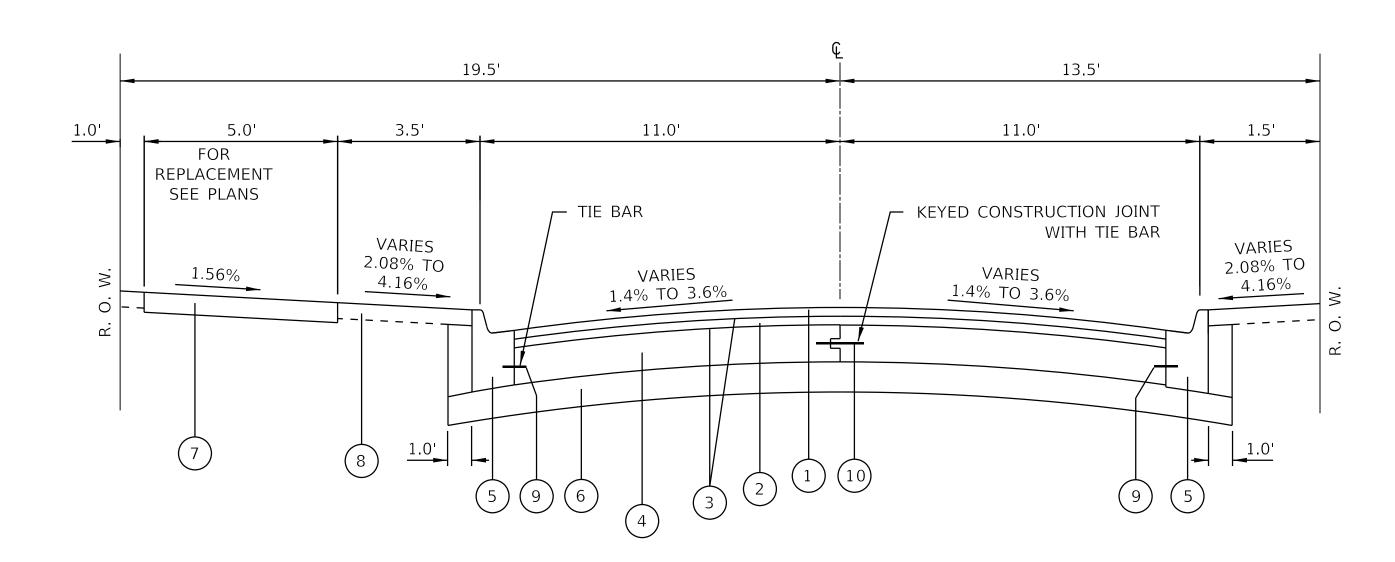

PROPOSED TYPICAL SECTION

W. 89TH ST. STA. 101+27 TO 109+25 (NTS)

EXISTING LEGEND

- A EXISTING PAVEMENT (TO BE REMOVED, VARIES 5½" TO 7")
- (B) EXISTING GRANULAR SUBBASE (TO BE REMOVED, VARIES 4"TO 12"
- © EXISTING PARKWAY
- (D) EXISTING CONCRETE SIDEWALK (SEE NOTE 2)

REMOVAL LEGEND



EARTH EXCAVATION



HOT-MIX ASPHALT SURFACE REMOVAL, VARIABLE DEPTH



SIDEWALK REMOVAL (SPECIAL)



PAVEMENT REMOVAL

PROPOSED LEGEND

- 1 HOT MIX ASPHALT SURFACE COURSE, MIX D, N50, 2"
- 2 LEVELING BINDER COURSE, (MACHINE METHOD), N50, 1½"
- (3) BITUMINOUS MATERIALS (TACK COAT)
- 4 P.C.C. BASE COURSE, 9"
- (5) COMBINATION CONCRETE CURB AND GUTTER, TYPE B-V.12
- 6 SUB-BASE GRANULAR MATERIAL, TYPE B, 6"
- 7) P.C.C. SIDEWALK, 5" (SEE NOTES 1 & 2)
- (8) TOPSOIL, 4" AND SODDING
- 9 TIE BARS # 5, 30" LONG SPACED @ 30" C-C (EPOXY COATED)
- (10) TIE BARS, DEFORMED 1/2" DIA., SPACED @ 30" C-C (MAX.)


NOTES:


- 1. NEW SIDEWALK SHALL BE CONSTRUCTED AT LOCATIONS AS NOTED ON THE PLANS.
- 2. SIDEWALK SHALL BE REPLACED AT LOCATIONS NOTED ON THE PLANS OR AS DIRECTED BY THE COMMISSIONER.
- 3. BITUMINOUS PRIME COAT MUST BE APPLIED AT THE RATE OF 0.05 TO 0.10 GALLONS PER SQUARE YARD. AGGREGATE PRIME COAT MUST BE APPLIED WHEN SO DIRECTED BY THE COMMISSIONER.
- 4. THE SUBBASE MATERIAL MUST BE CRUSHED STONE HAVING A CA-6 GRADATION WHICH MUST BE FURNISHED, PLACED TO A 6 INCH DEPTH, AND COMPACTED IN ACCORDANCE WITH THE REQUIREMENTS FOR SUBBASE GRANULAR MATERIAL, TYPE B, AS STATED IN APPLICABLE PORTIONS OF SECTION 311 OF THE STANDARD SPECIFICATIONS FOR ROAD AND BRIDGE CONSTRUCTION.
- 5. PAVEMENT REMOVAL MUST BE PRECEDED BY FULL DEPTH SAW CUTTING TO SEPARATE THE PORTION TO BE REMOVED FROM THE PORTION TO REMAIN. ANY PAVEMENT BEYOND THE LIMITS MARKED FOR REMOVAL THAT IS DAMAGED BY THE CONSTRUCTION MUST BE CUT FULL DEPTH WITH A CONCRETE SAW AND REPLACED AT NO ADDITIONAL COST TO THE CONTRACT.
- 6. FOR PORTLAND CEMENT CONCRETE PAVEMENT JOINTING AND COMBINATION CONCRETE CURB AND GUTTER JOINTING DETAILS, REFER TO THE LATEST DETAIL CONSTRUCTION STANDARDS OF THE DIVISION OF ENGINEERING, CHICAGO DEPARTMENT OF TRANSPORTATION.
- 7. PROPOSED SIDEWALK VARIES IN LOCATIONS, TYPICAL AT INTERSECTION, DRIVEWAYS AND ALLEYS. SEE PLANS.
- 8. ALL SOIL AND OTHER EXCAVATED MATERIAL TO BE PAID FOR AT THE CONTRACT UNIT PRICE PER CUBIC YARD FOR "EARTH EXCAVATION" UNLESS OTHERWISE STATED. THE TRANSPORTATION AND DISPOSAL OF SOIL AND OTHER MATERIALS FROM AN EXCAVATION DETERMINED TO BE CONTAMINATED WILL BE PAID FOR AT THE CONTRACT UNIT PRICE PRICE PER CUBIC YARD FOR "NON-SPECIAL WASTE DISPOSAL."






USER NAME = afl	DESIGNED - TJC		ADDENDUM NO. 1	
		TIC	REVISED -	
	DRAWN -	TJC	ADDENDUM NO. 2	
PLOT SCALE = 20.0000 ' / in.	CHECKED -	NV	REVISED -	
	D.4.T.E.	0.4.10.0.10.00.5	ADDENDUM NO. 3	
PLOT DATE = $4/30/2025$	DATE -	04/22/2025	ISSUE TO BID - 5/6/2025	

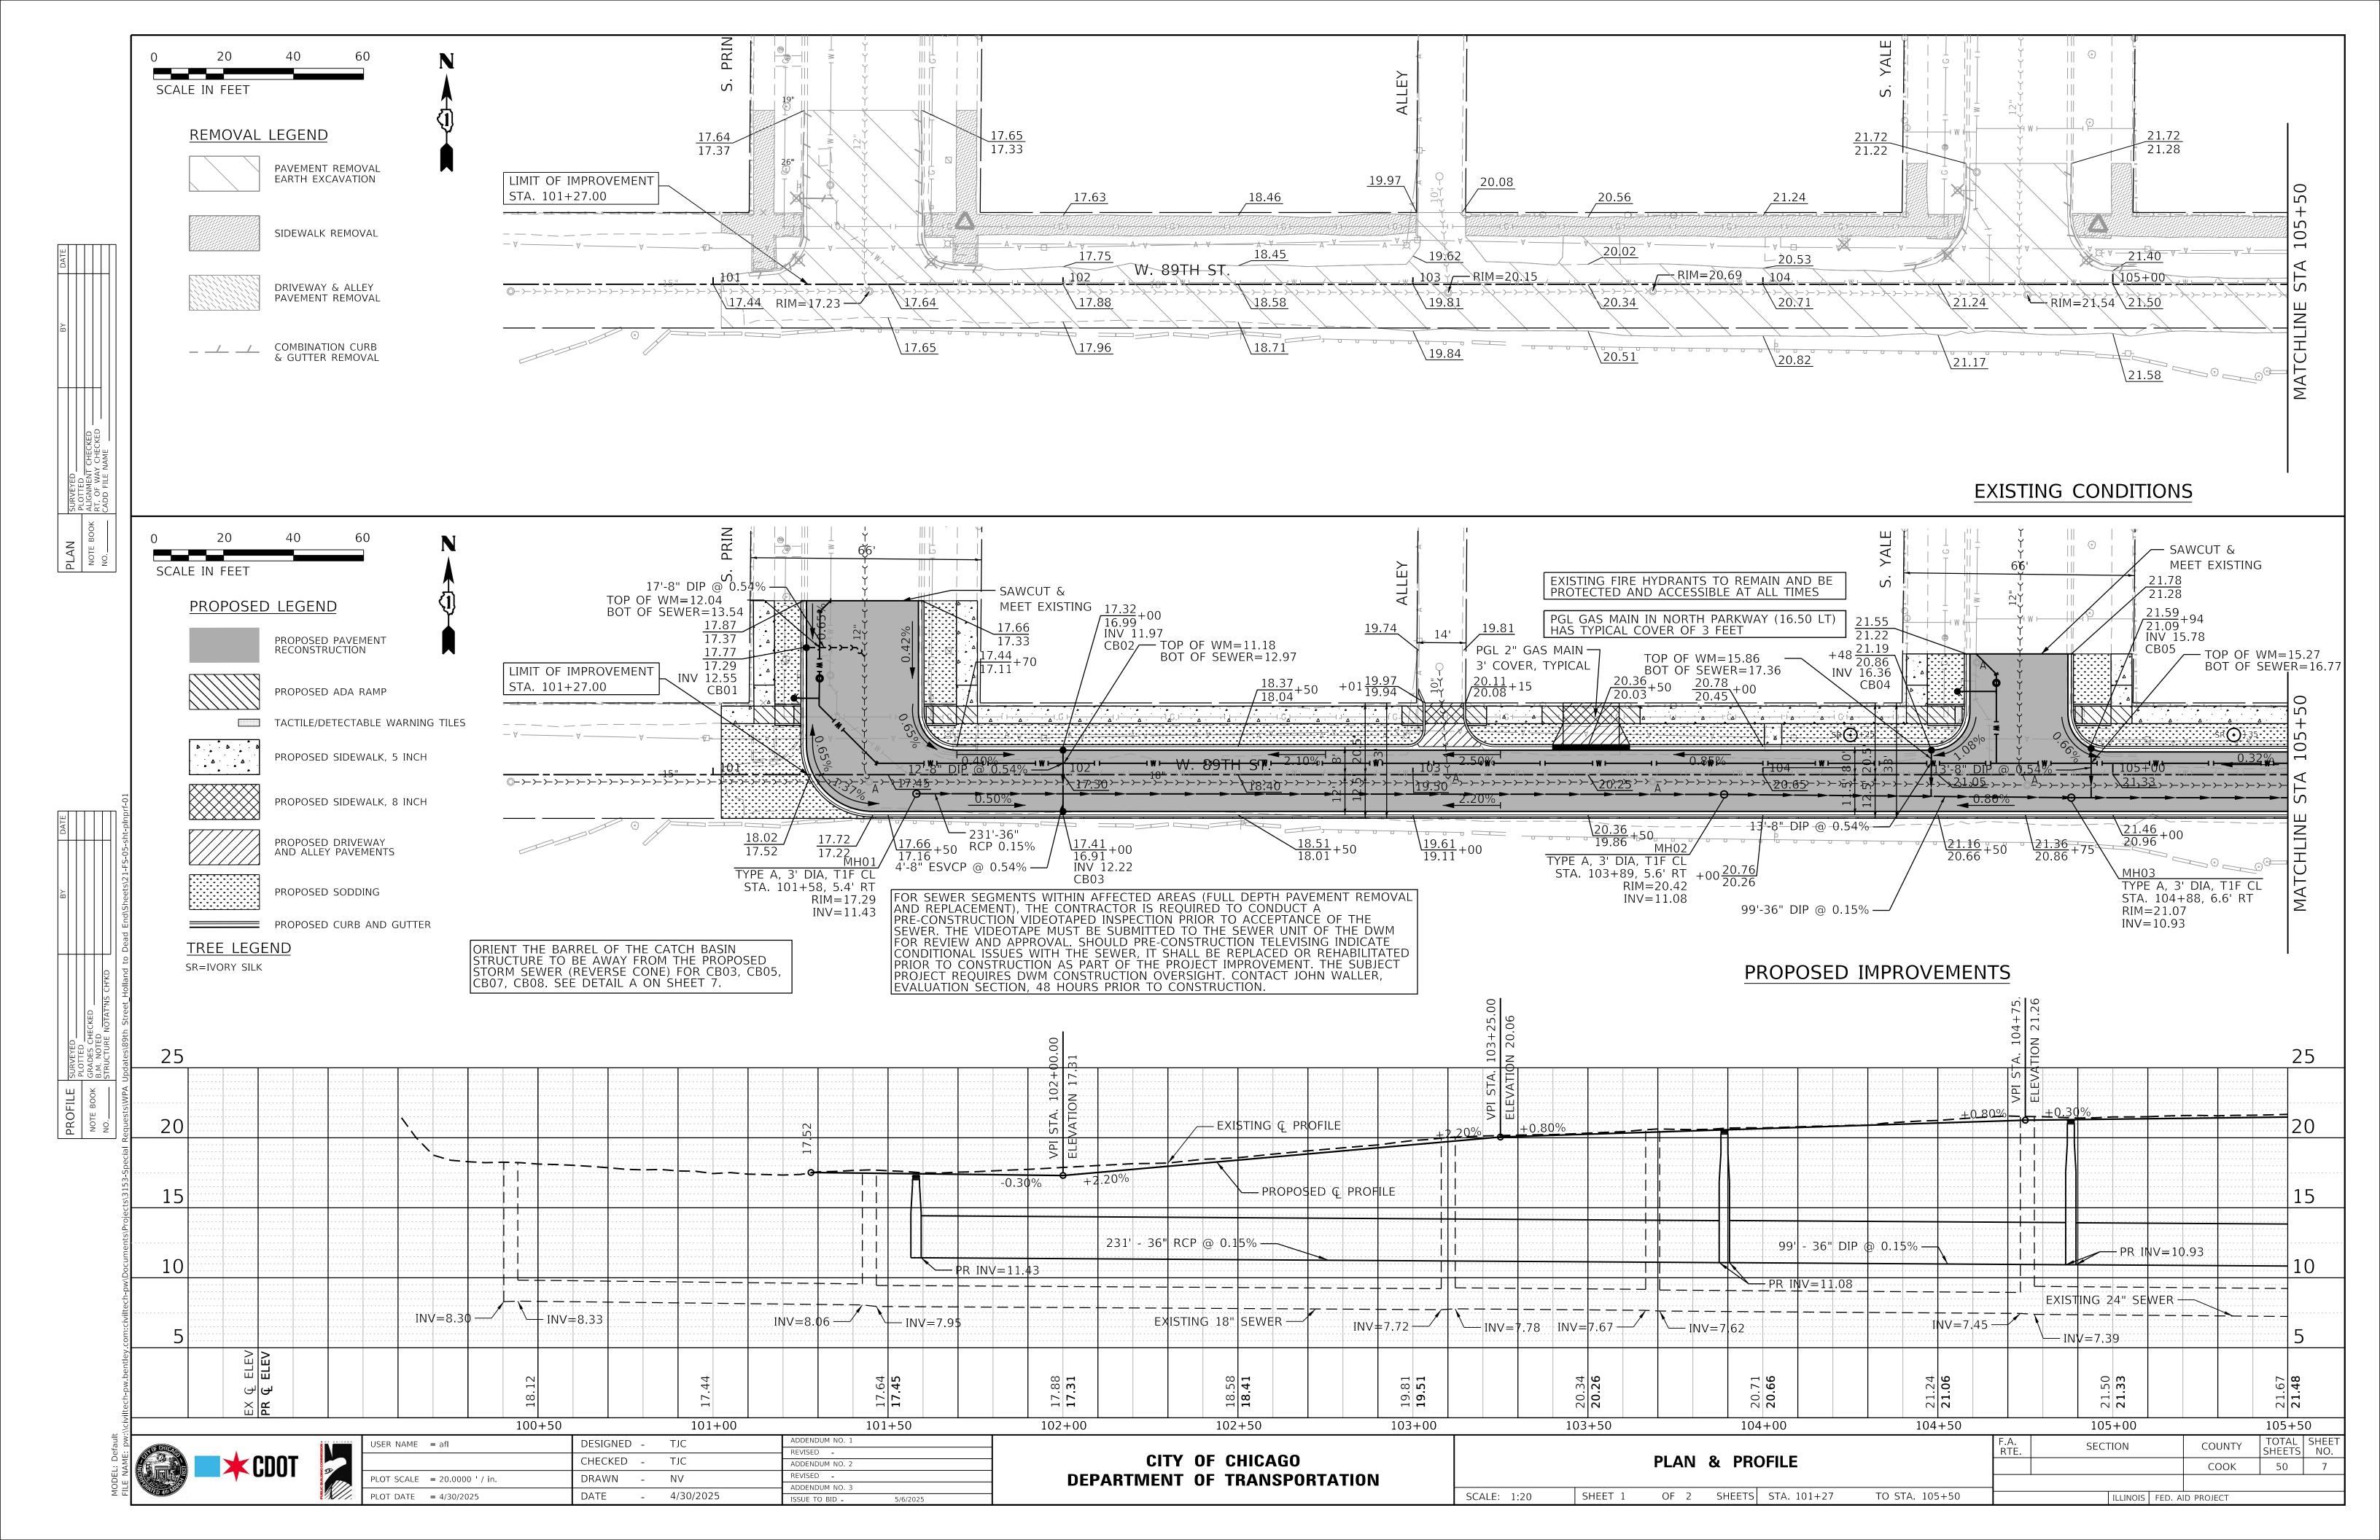


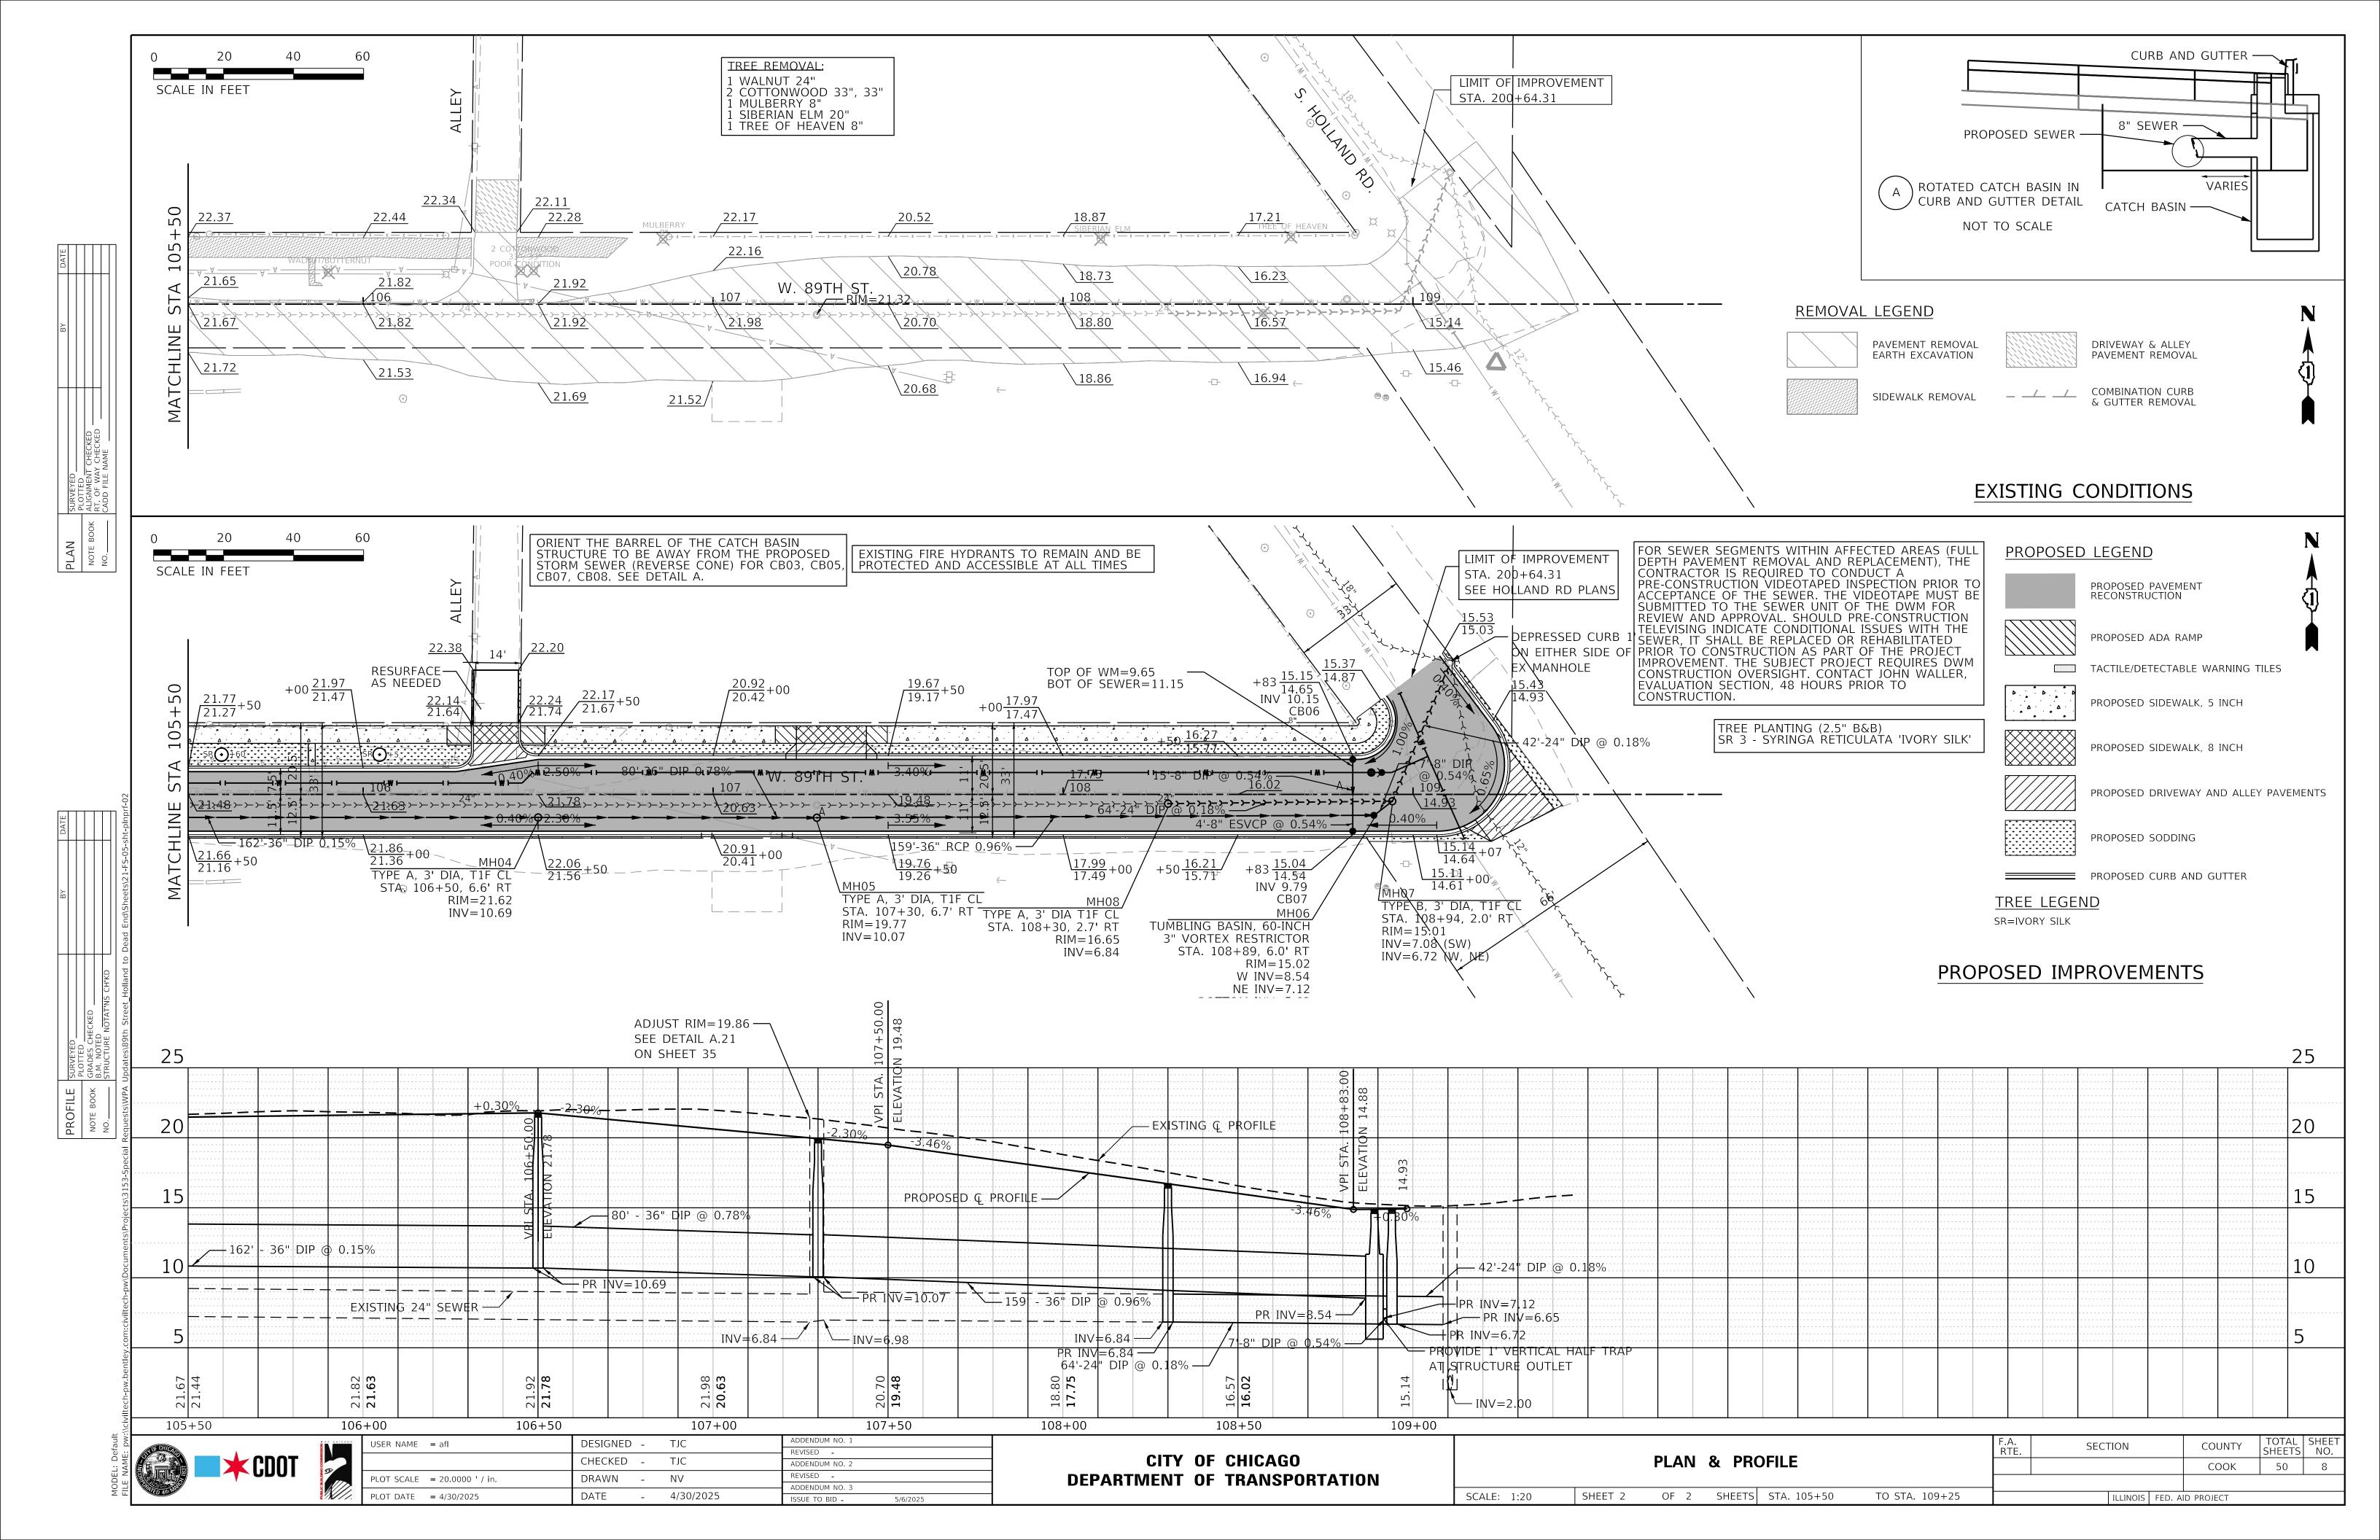

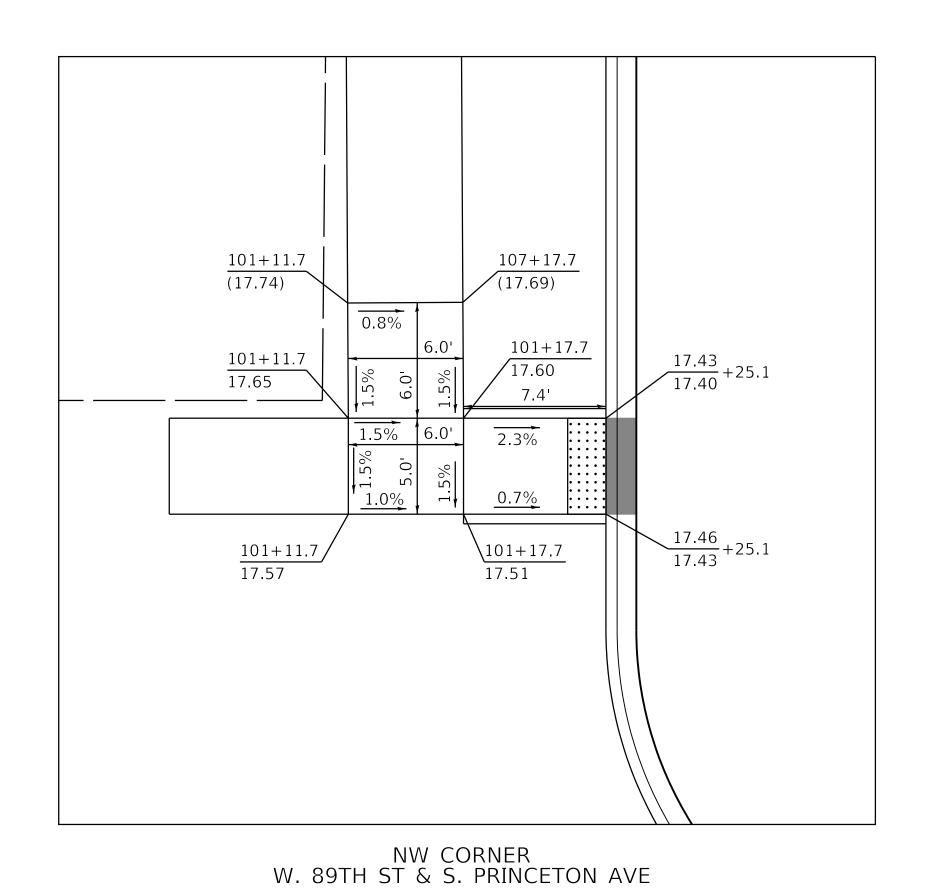


101+69.5 101 + 75.5(17.62) (17.65) 0.5% 101+69.5 17.53 101+75.5 17.56 $+60.4 \frac{17.53}{17.20}$ 9.2 3.3% 6.0' 0.5% 4.2% MAX <u>0.8%</u> 4.2% MAX $+60.9 \frac{17.50}{17.17}$ 101+75.5\101+69.5 17.45 17.50

NE CORNER W. 89TH ST & S. PRINCETON AVE

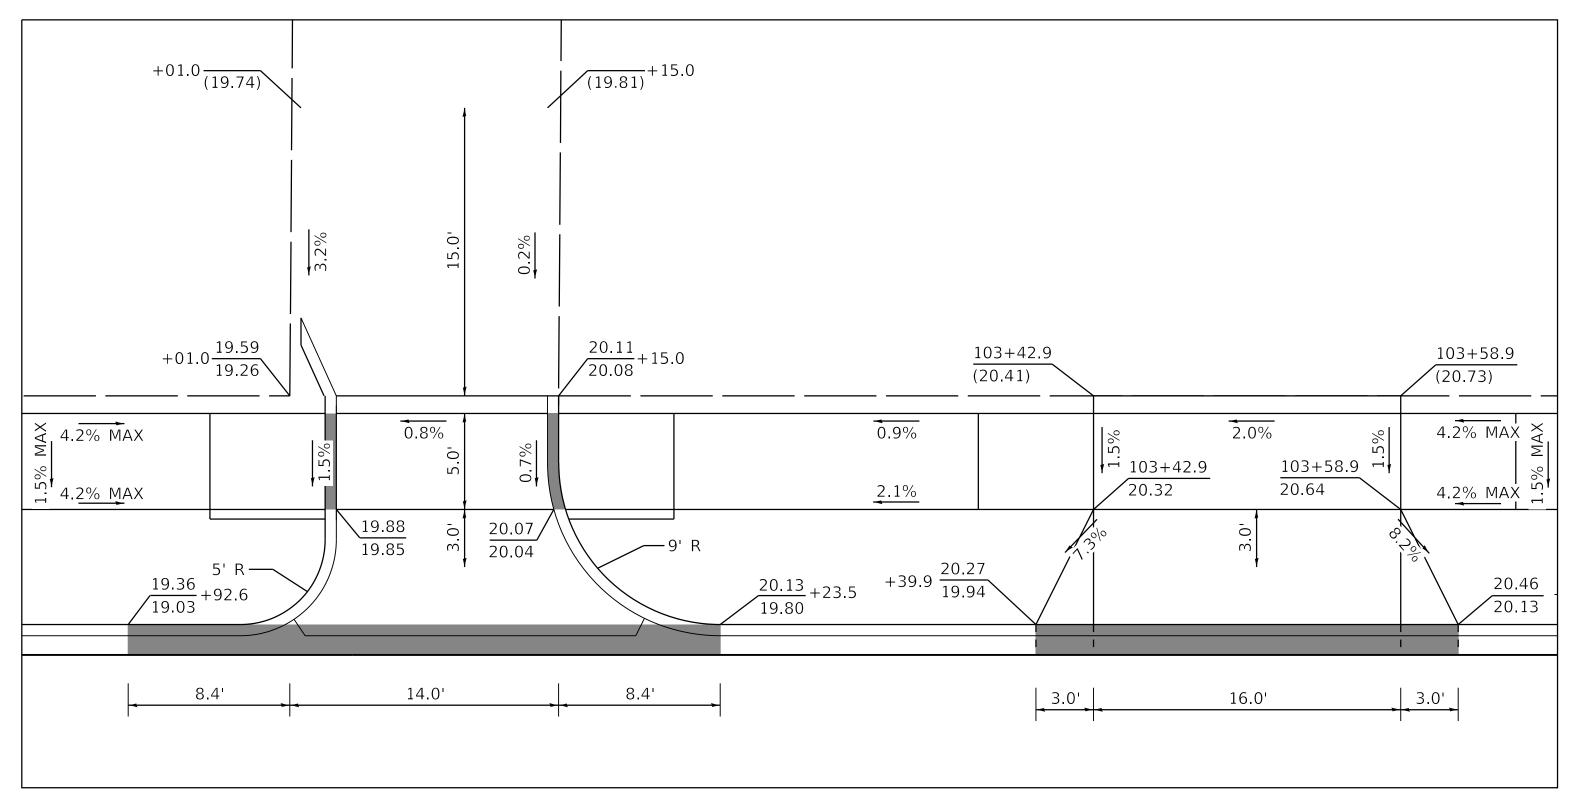

W. 89TH ST - WESTBOUND STA. 103+08

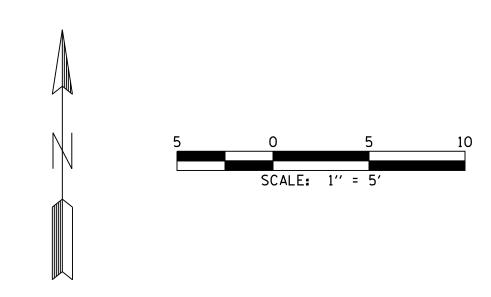

<u>NOTES</u>

X.XX - PROPOSED ELEVATION (X.XX) - EXISTING ELEVATION

XX.XX - TOP OF CURB ELEVATION XX.XX - FLOWLINE ELEVATION

HP - HIGH POINT

VARY CURB HEIGHT AS NEEDED TO ACHIEVE ELEVATIONS AS SHOWN. (MINIMUM CURB HEIGHT = 3")

SC = TOP OF SIDE CURB


- DEPRESSED CURB




ż	OF CHICAGO
PUBLIC BUILDING COMMISSION	
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PUBL	<i>YX///</i> .

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		DRAWN -		TJC	ADDENDUM NO. 2		
	PLOT SCALE = 5.0000 ' / in.	CHECKED -		NV	REVISED -		
	<u> </u>			2.1/2.2/2.2.7	ADDENDUM NO. 3		
<i>'</i> .	PLOT DATE = $4/30/2025$	DATE - 04/22/2025		04/22/2025	ISSUE TO BID -	5/6/2025	


						RTE.	SECTION		COUNTY	SHEETS	NO.
ADA GRADIN				DETAILS					СООК	50	9
								С	CONTRACT	NO.	
SCALE: 1:5	E: 1:5 SHEET 1 OF 2 SHEETS STA. TO STA.			TO STA.		ILLINOIS	FED. AID PF	ROJECT			

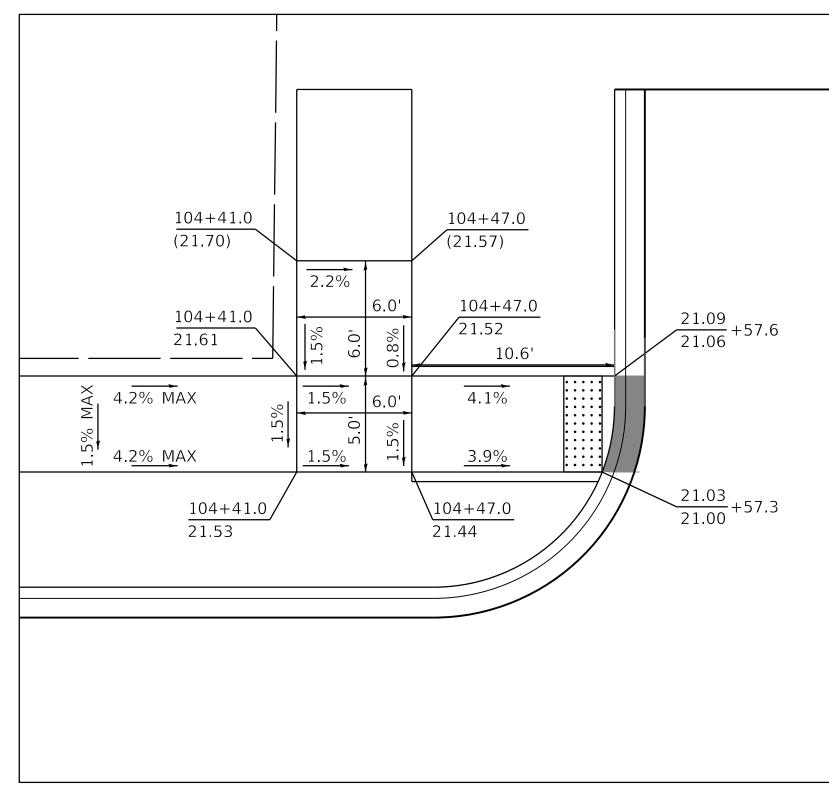


NW CORNER W. 89TH ST & S. YALE AVE

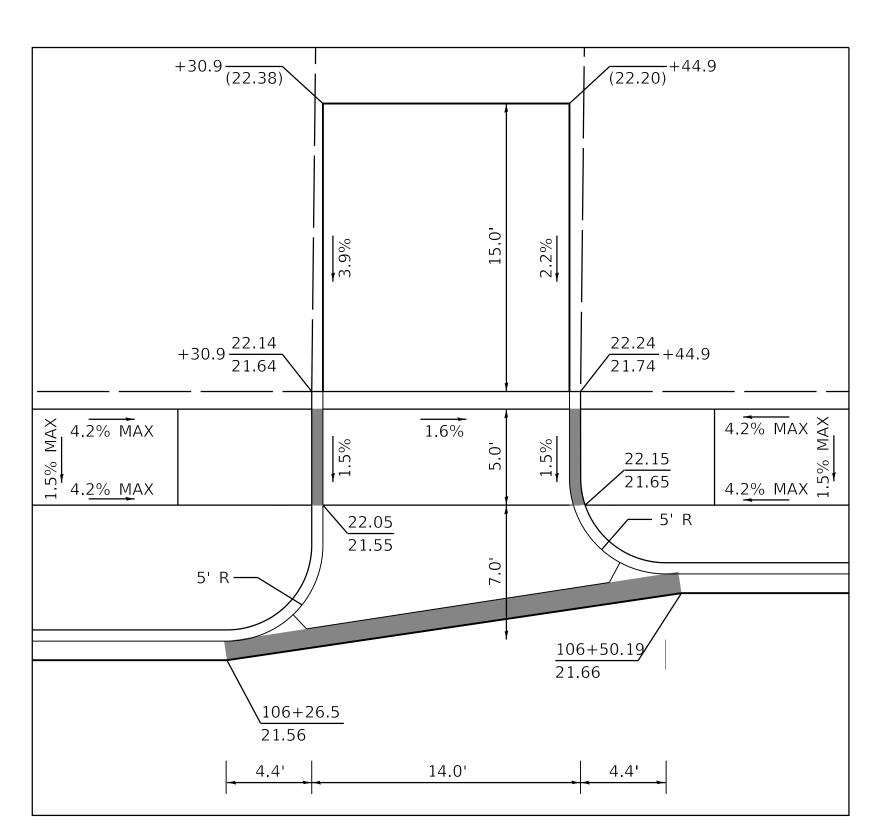

W. 89TH ST - WESTBOUND STA. 106+38

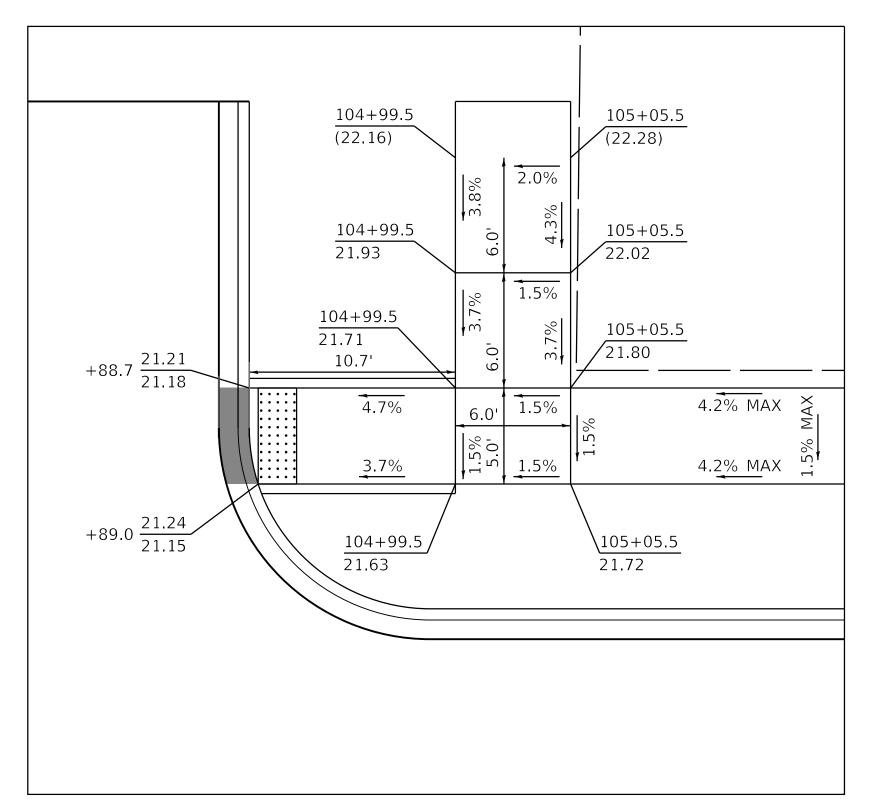


NE CORNER W. 89TH ST & S. YALE AVE

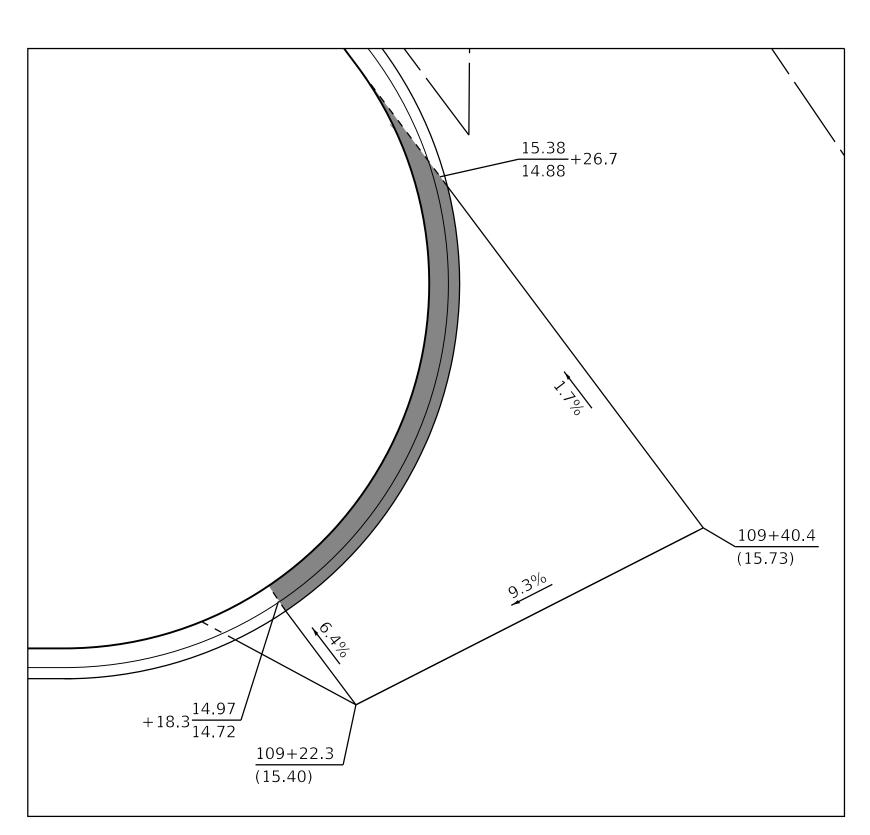

SE CORNER - DRIVEWAY W. 89TH ST & S. HOLLAND RD

SCALE: 1:5

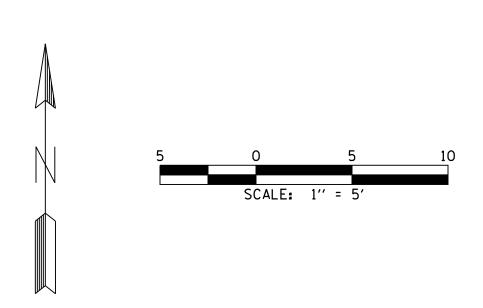

<u>NOTES</u>

X.XX - PROPOSED ELEVATION (X.XX) - EXISTING ELEVATION

XX.XX - TOP OF CURB ELEVATION XX.XX - FLOWLINE ELEVATION

HP - HIGH POINT

VARY CURB HEIGHT AS NEEDED TO ACHIEVE ELEVATIONS AS SHOWN. (MINIMUM CURB HEIGHT = 3")

SC = TOP OF SIDE CURB





- DEPRESSED CURB







٥	USER NAME = afl	DESIGNED - IJC		ADDENDUM NO. 1			
		55414/11			REVISED -		
		DRAWN -		TJC	ADDENDUM NO. 2		
	PLOT SCALE = 5.0000 ' / in.	CHECKED -		NV	REVISED -		
•					ADDENDUM NO. 3		
•	PLOT DATE = $4/30/2025$	DATE - 04/22/2025		04/22/2025	ISSUE TO BID -	5/6/2025	

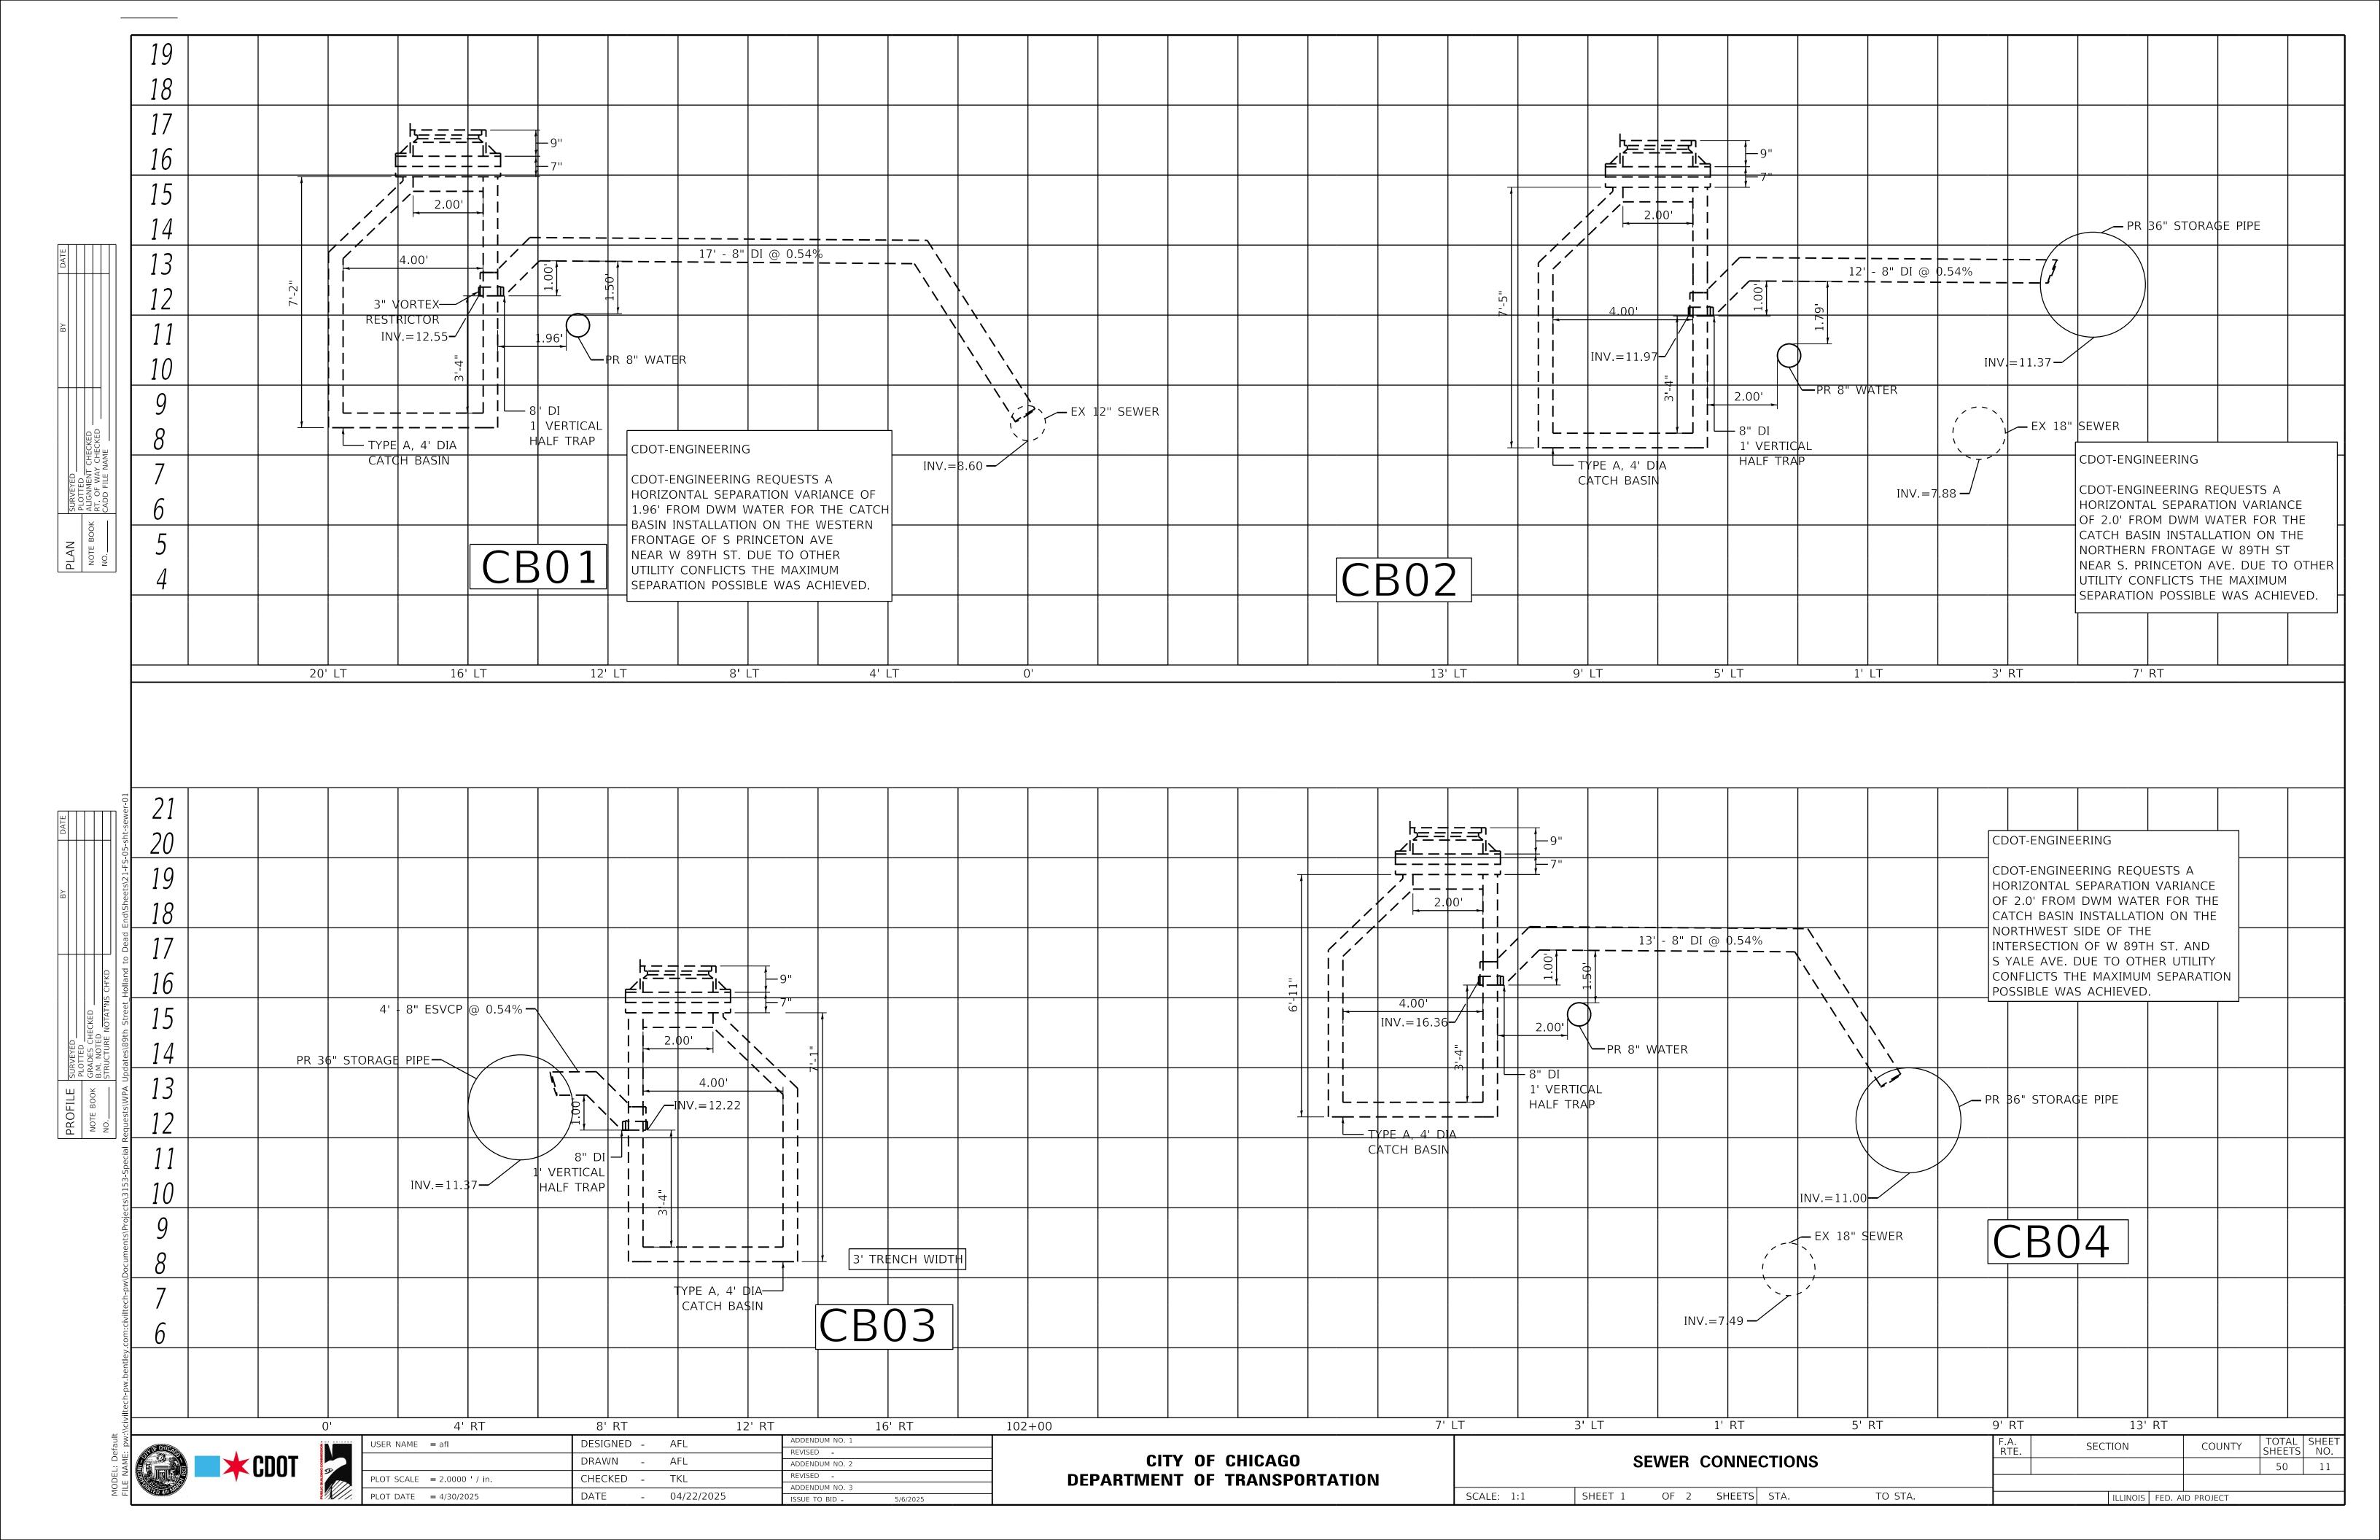


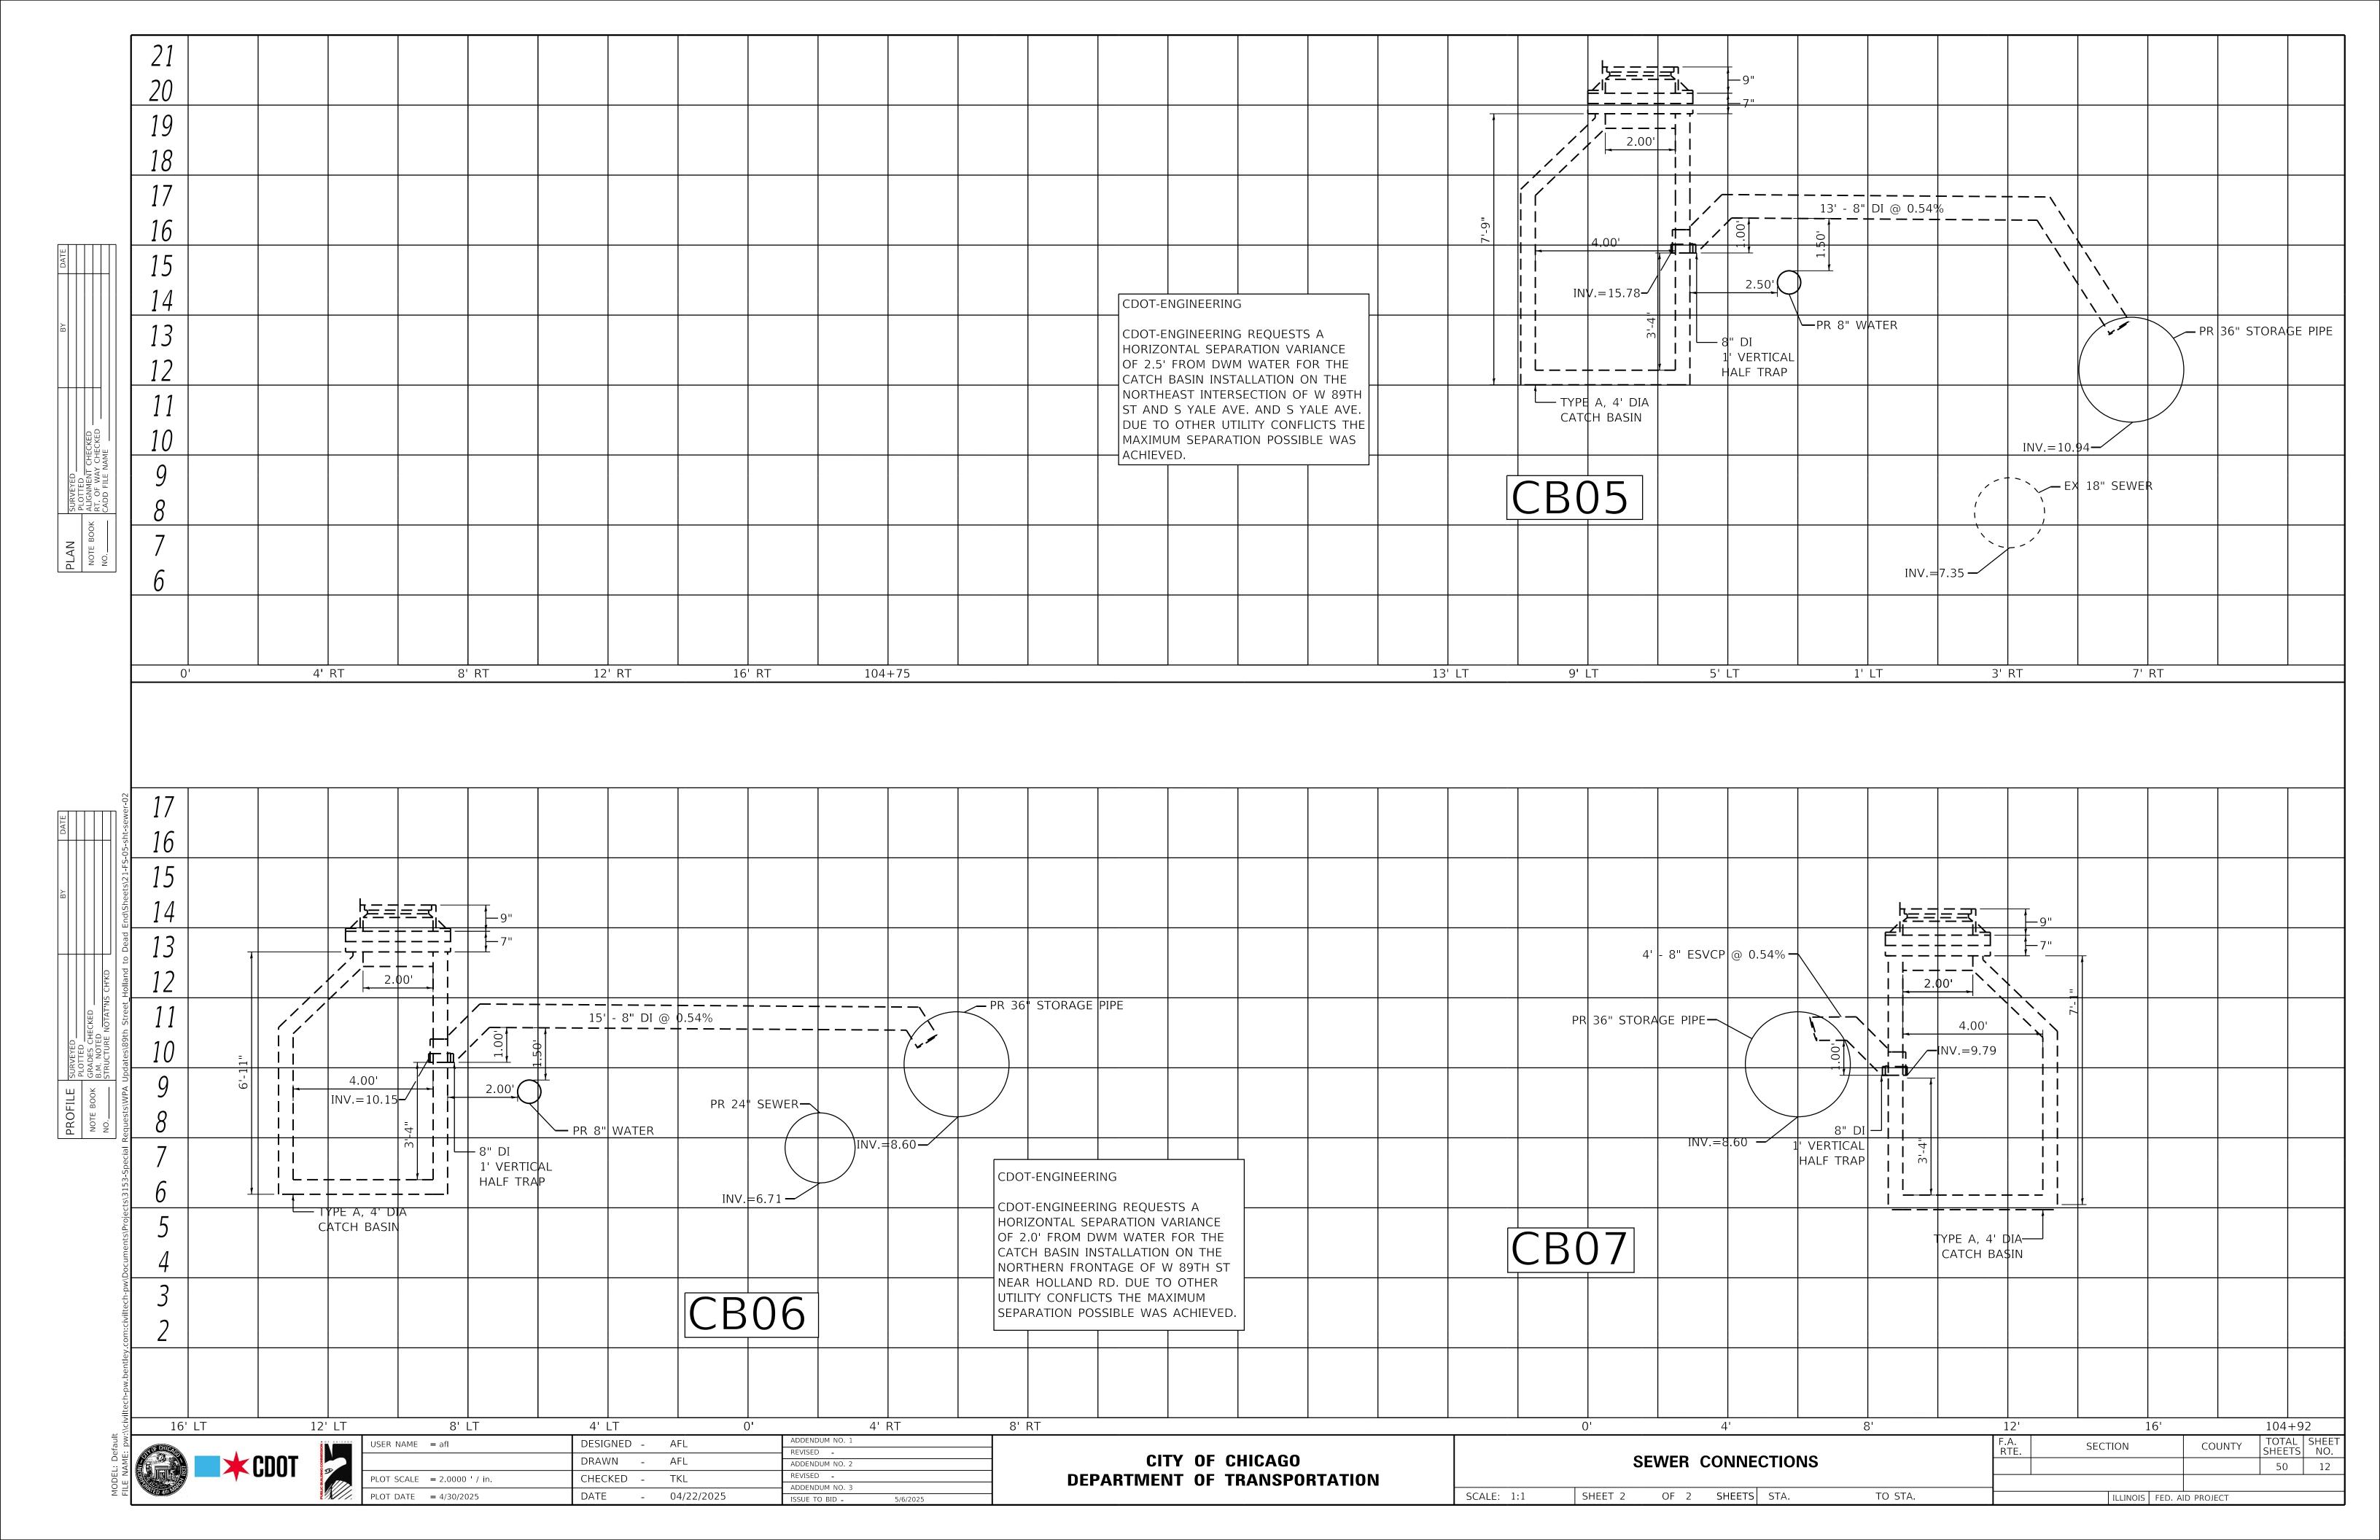

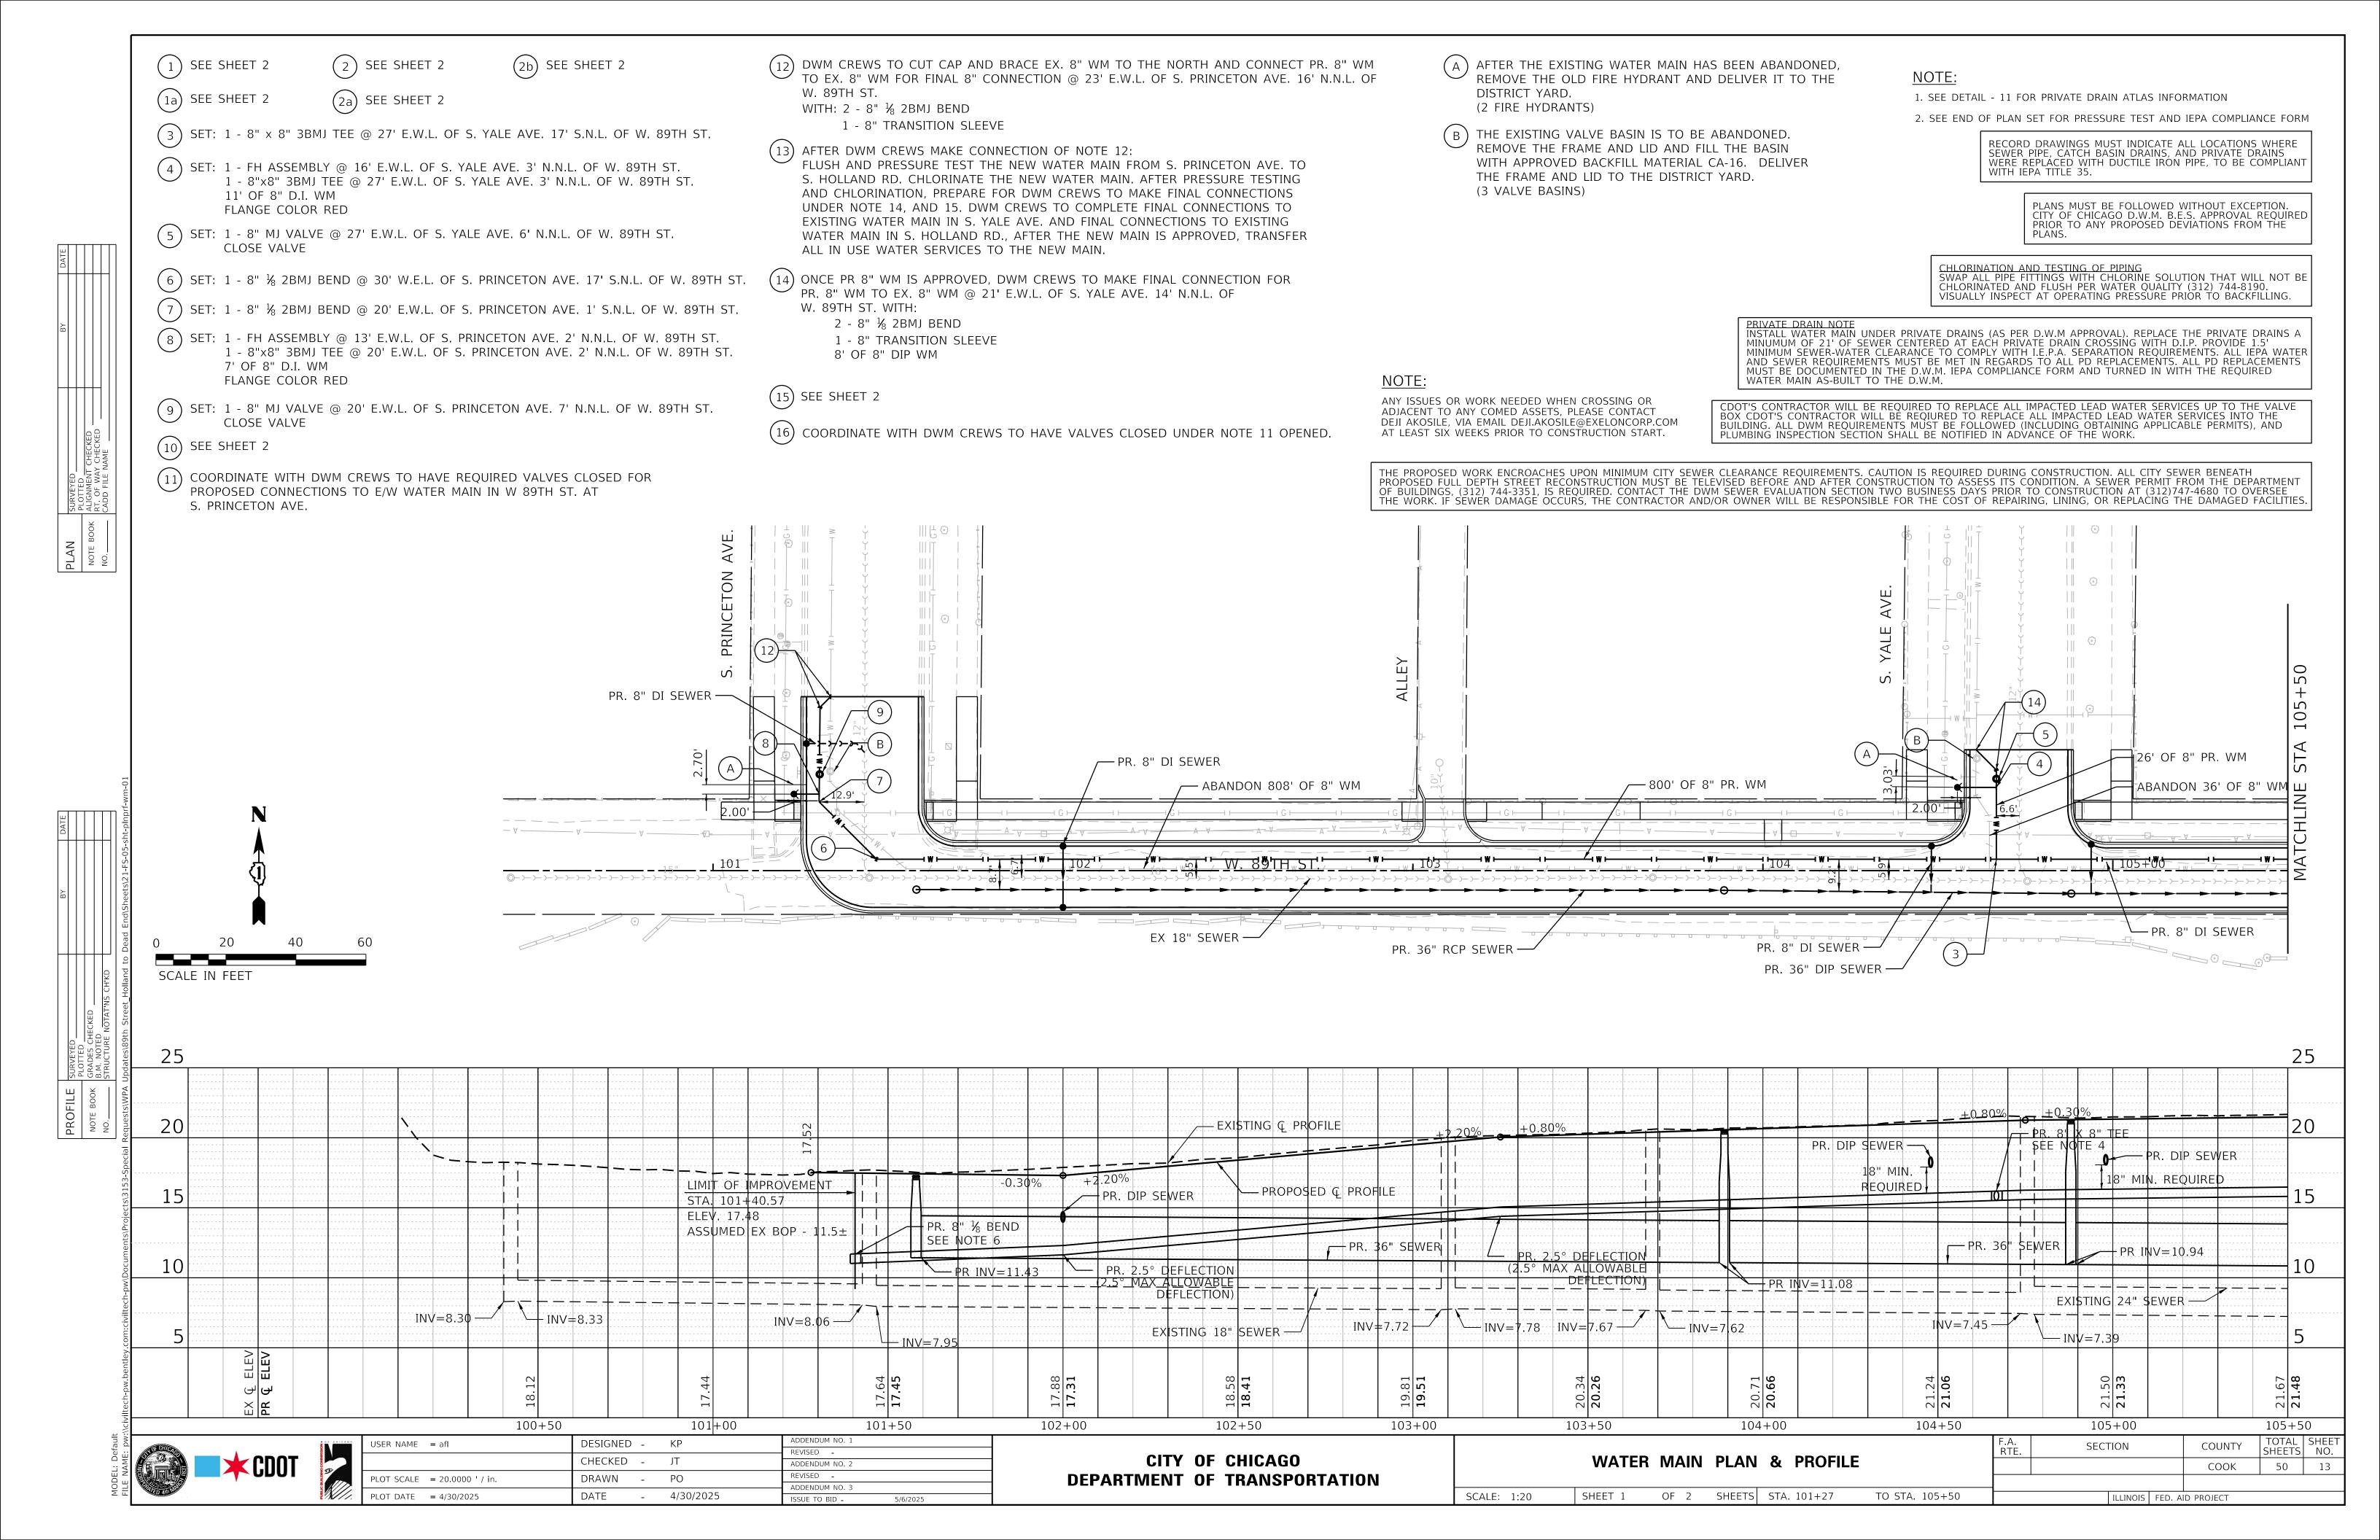

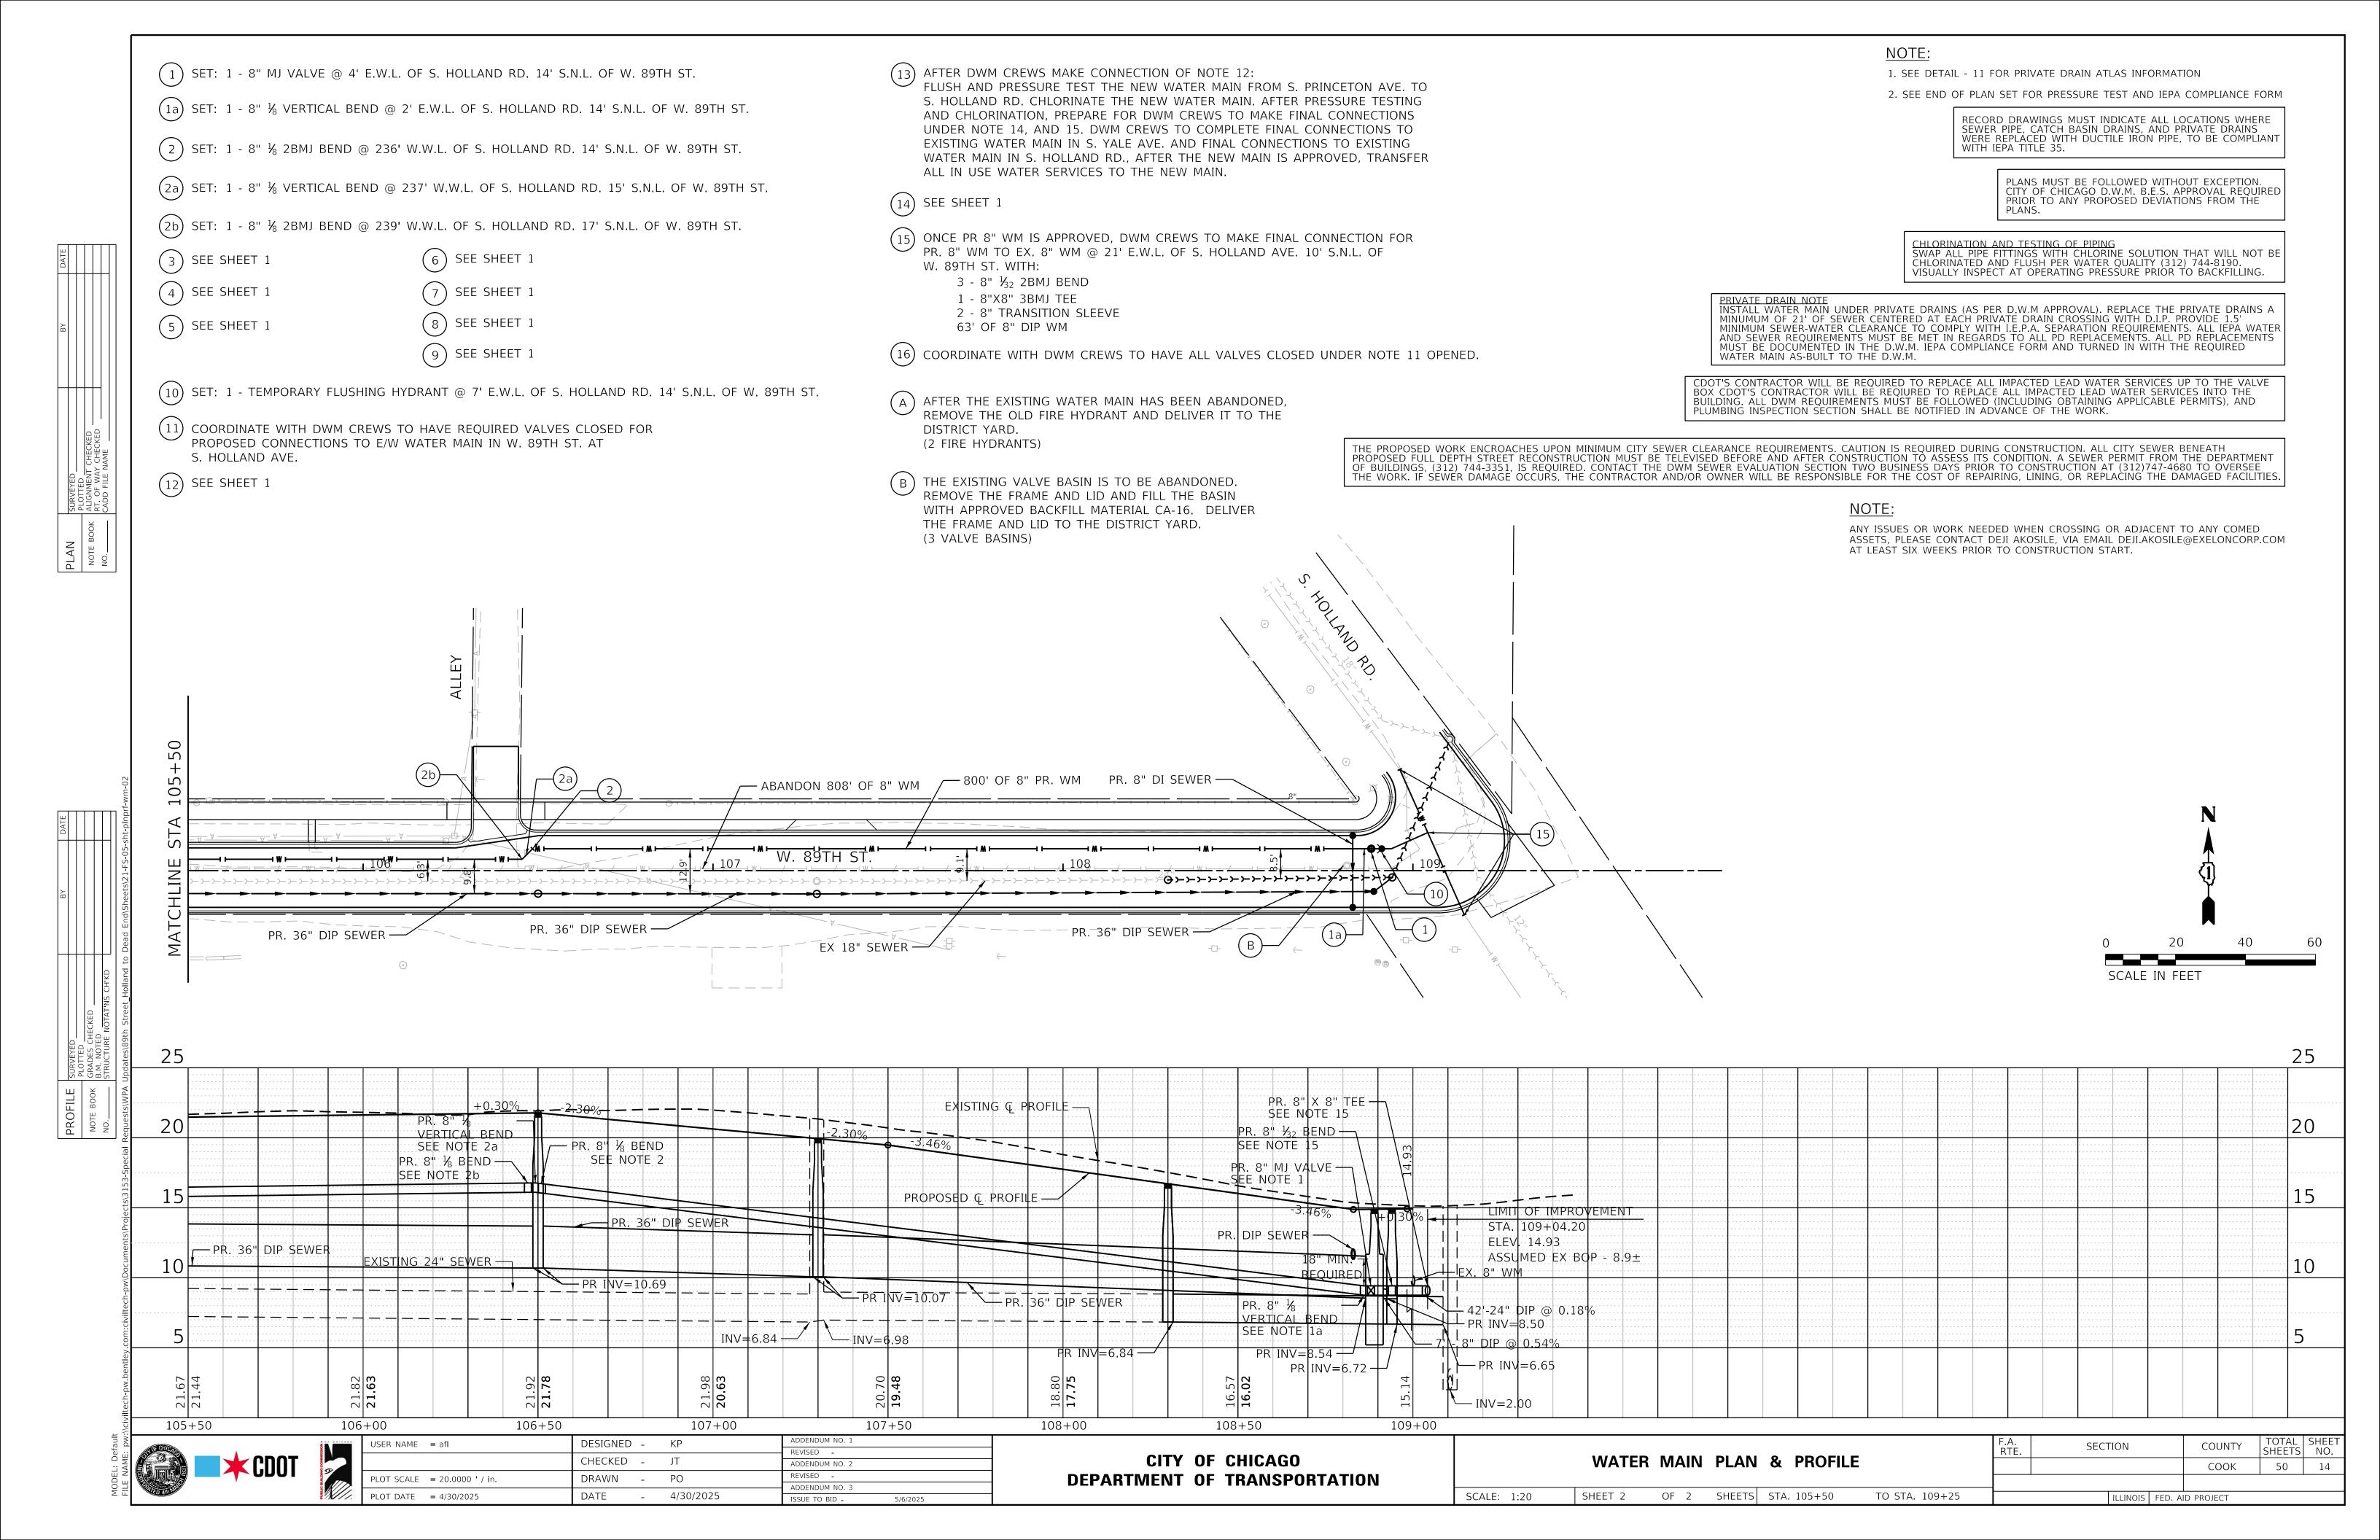



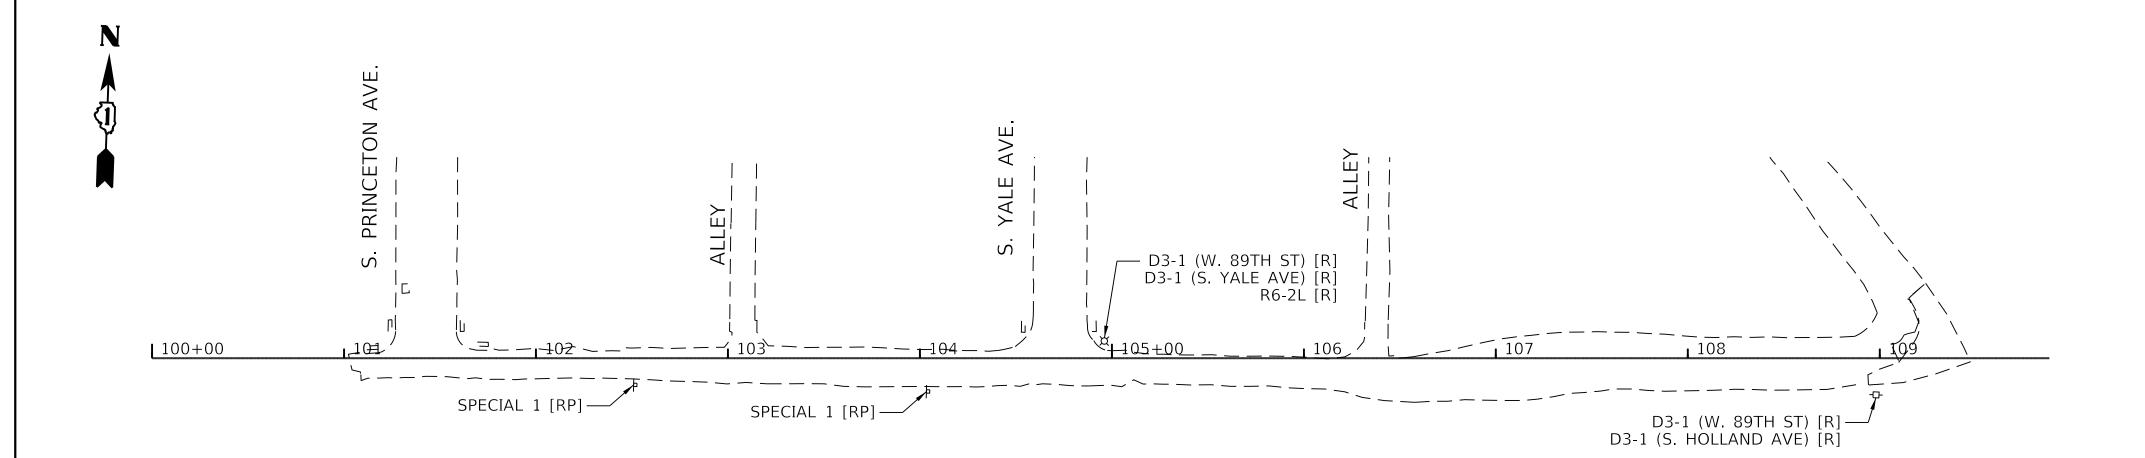

SIGNING LEGEND

3 **w 89TH** sт

D3-1 12.00" x 6.75" ONE WAY ←

s HOLLAND RD

D3-1 24.00" x 6.75" R6-2L 18" x 24"

S YALE AVE

D3-1 12.00" x 6.75" W.

S PRINCETON AVE


D3-1 24.00" x 6.75" R6-2R 18" x 24"


NO DUMPING UNDER PENALTY

SPECIAL 1 12.00" x 18.00"

6" WHITE CROSSWALK TYP. D3-1 (W. 89TH ST) [RDS, FLP] D3-1 (S. PRINCETON AVE) [RDS, FLP] R6-2L [RSS, CLP] R6-2R [RSS, CLP] D3-1 (W. 89TH ST) [RDS, FLP] D3-1 (W. 89TH ST) [RDS, FLP] D3-1 (S. YALE AVE) [RDS, FLP] R6-2L [RSS, CLP] R6-2R [RSS, CLP] D3-1 (W. 89TH ST) [RDS, FLP] D3-1 (S. HOLLAND AVE) [RDS, FLP] R6-2L [RSS, CLP] D3-1 (W. 89TH ST) [RDS, FLP] D3-1 (S. HOLLAND AVE) [RDS, FLP]

STRIPING LEGEND

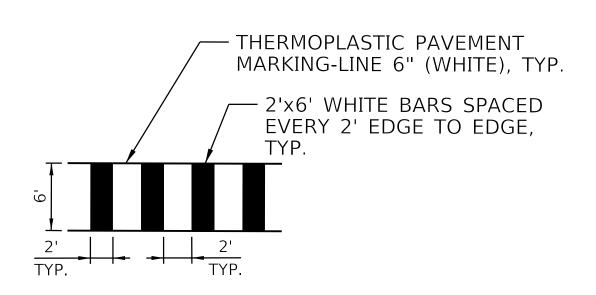

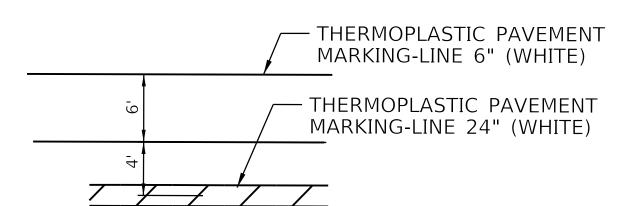

EXISTING SIGN LEGEND

SIGN CODE (SPECIAL TEXT) [ACTIVITY CODE]

SPECIAL TEXT

STREET NAME OR SPECIAL TEXT THAT DIFFERS FROM THE TEXT ASSOCIATED WITH EACH SIGN CODE (IF NEEDED)

ACTIVITY CODE

- R = REMOVE EXISTING SIGN PANEL AND SALVAGE
- RP = REMOVE EXISTING SIGN PANEL AND POLE ASSEMBLY, FROM PARKWAY, AND SALVAGE
- RS = REMOVE EXISTING SIGN PANEL AND POLE ASSEMBLY, FROM SIDEWALK, AND SALVAGE

PROPOSED SIGN LEGEND

STATION

SIGN CODE (SPECIAL TEXT) [FURNISH CODE, MOUNT CODE, POLE CODE]

SPECIAL TEXT

STREET NAME OR SPECIAL TEXT THAT DIFFERS FROM THE TEXT ASSOCIATED WITH EACH SIGN CODE (IF NEEDED)

FURNISH CODE

SCALE: 1:50

RSS = SIGN PANEL, TYPE 1, REFLECTIVE,

SINGLE-SIDED RDS = SIGN PANEL, TYPE 1, REFLECTIVE, DOUBLE-SIDED

MOUNT CODE

CSP = CENTER MOUNT ON SIGN POLE

FSP = FLAG MOUNT ON SIGN POLE

CLP = CENTER MOUNT BANDED TO LIGHT POLE FLP = FLAG MOUNT BANDED TO LIGHT POLE

POLE CODE (IF REQUIRED)

DG = SIGN SUPPORT POST, DIG METHOD DR = SIGN SUPPORT POST, DRILL METHOD

CODE	DESCRIPTION	AREA (SQ FT)								
CODE	DESCRIPTION	ANLA (3Q 11)	RSS	RDS	CSP	FSP	CLP	FLP		
D3-1	89TH ST	0.56		3				3		
D3-1	S HOLLAND RD	1.13		1				1		
D3-1	S YALE AVE	0.56		1				1		
D3-1	S PRINCETON AVE	1.13		1				1		
R6-2L	ONE WAY LEFT	3.00	2				2			
R6-2R	ONE WAY RIGHT	3.00	2				2			
		TOTALS	4	6	0	0	4	6		
	TOTAL AREA FURNIS	12.0	9.0	-	-	-	-			





USER NAME = afl	DESIGNED -	TJC	ADDENDUM NO. 1
		=	REVISED -
	DRAWN -	TJC	ADDENDUM NO. 2
PLOT SCALE = 50.000 ' / in.	CHECKED -	NV	REVISED -
			ADDENDUM NO. 3
PLOT DATE = $4/30/2025$	DATE -	04/22/2025	ISSUE TO BID - 5/6/2025

CITY	OF	CHICAGO
0	•	
DEPARTMENT	OF	TRANSPORTATION

	F.A. RTE.	SECTION	COUNTY	TOTAL SHEETS	SHEE NO.
PAVEMENT MARKING & SIGNAGE			СООК	50	15
SHEFT 1 OF 1 SHEFTS STA 101+27 TO STA 109+25 Γ		ILLINOIS FED	AID PROJECT		




DWG. NO.


22-052

COOK

TOTAL SHEET SHEETS NO.


50 | 16

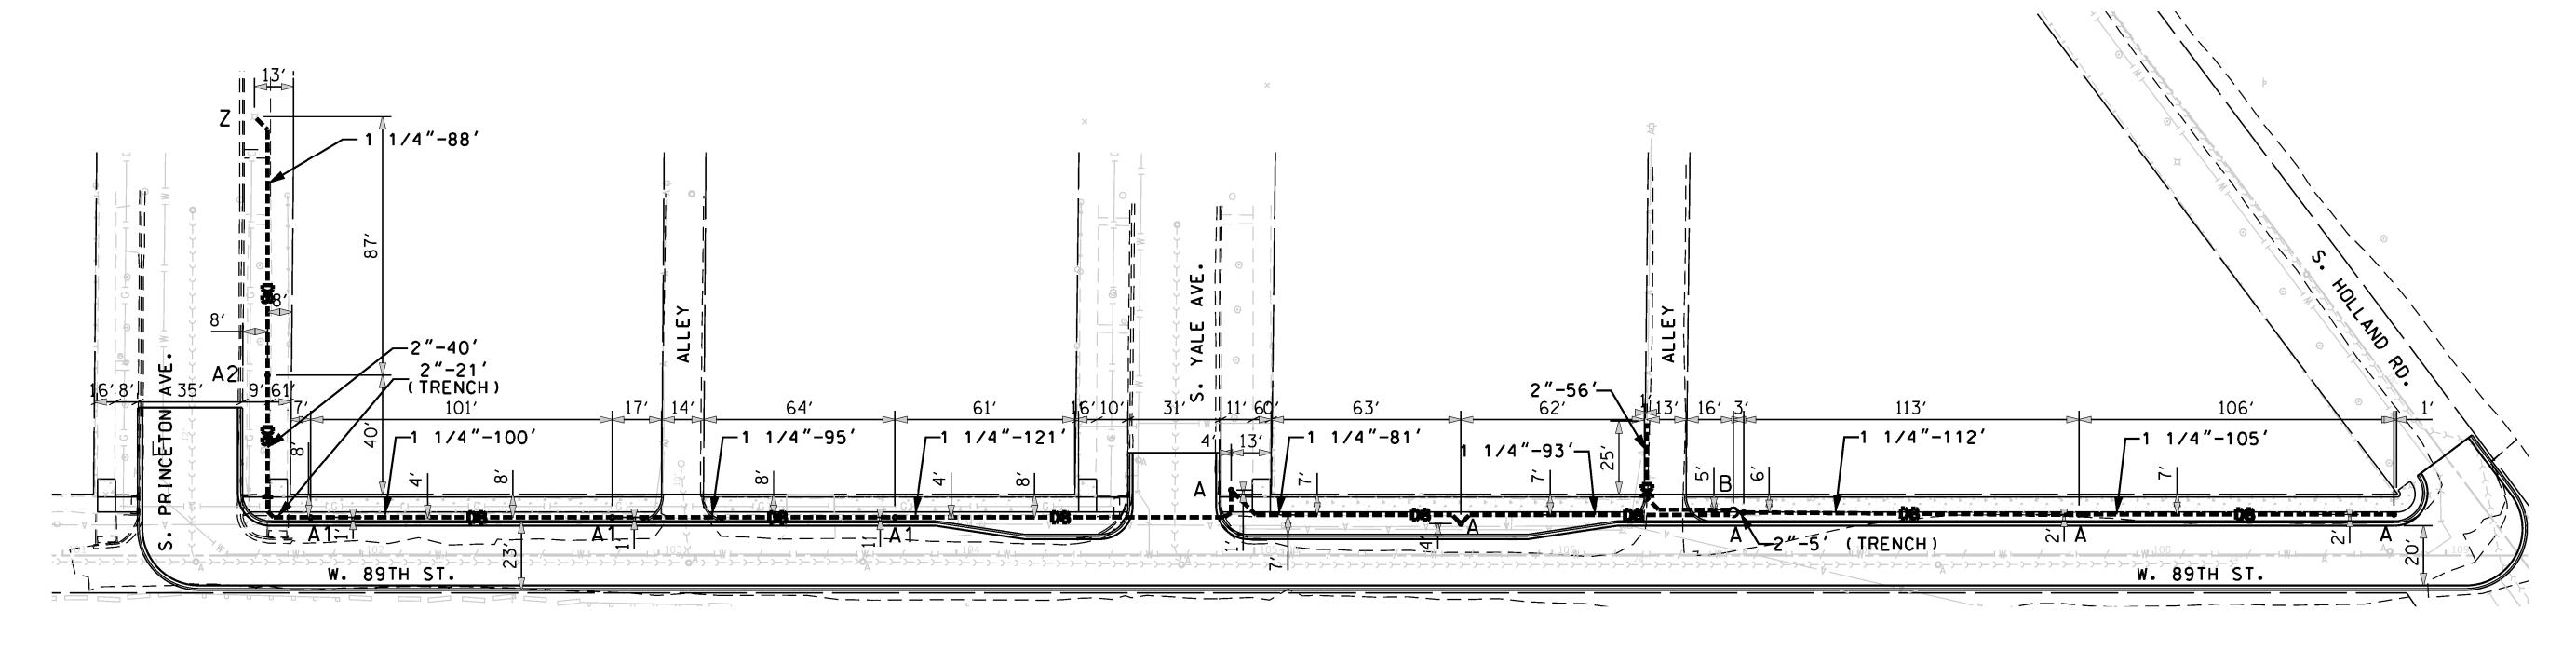

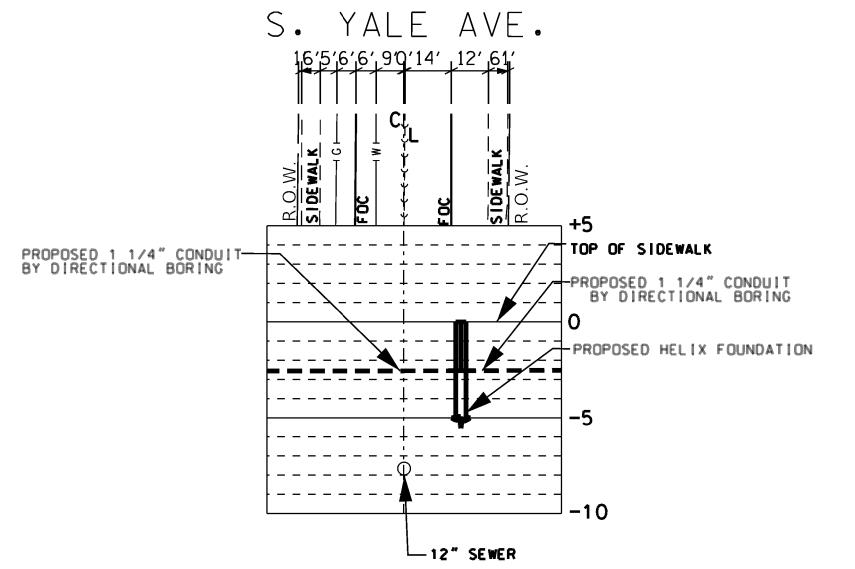

PROPOSED CONDUIT PROFILE OF CONDUIT CROSSING S. YALE AVE. ON THE NORTH SIDE OF W. 89TH ST.

W. 89TH ST.

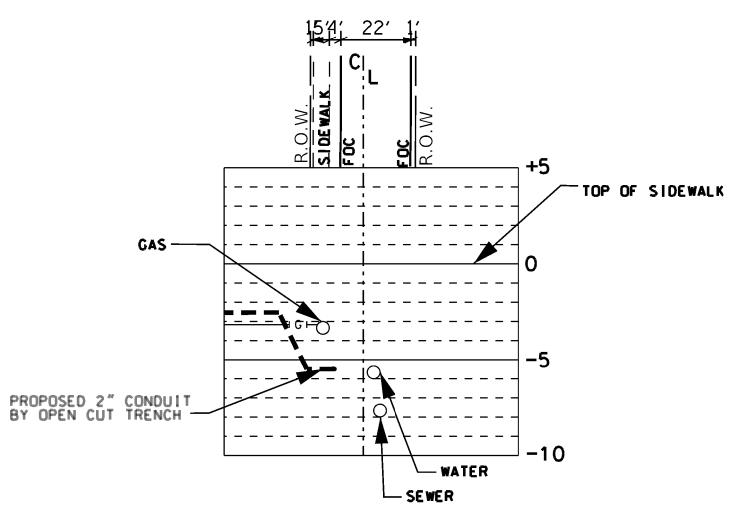

PROPOSED CONDUIT PROFILE OF CONDUIT CROSSING W. 89TH ST. ON THE EAST SIDE OF S. PRINCETON AVE.

NOTES:

- "A"- INSTALL 10" B.C. x 5' HELIX FOUNDATION AS PER DRAWING NO. 936, 3' OFF FACE OF CURB UNLESS NOTED OTHERWISE
- "A1"-INSTALL 10" B.C. × 5' HELIX FOUNDATION AS PER DRAWING NO. 936, 1.2' OFF FACE OF CURB UNLESS NOTED OTHERWISE
- "A2"-INSTALL 10" B.C. x 5' HELIX FOUNDATION AS PER DRAWING NO. 936, 8' OFF FACE OF CURB UNLESS NOTED OTHERWISE
- "B"- INSTALL 30" HANDHOLE AS PER DRAWING NO. 867 WITH 24" FRAME AND COVER AS PER DRAWING NO.966 & 968
- "Z"- INSTALL CONDUIT INTO EXISTING CONCRETE FOUNDATION

CONTRACTOR TO CONTACT D.I.G.G.E.R @ 312-744-7000 ALL UTILITY COMPANIES TO LOCATE EXISTING UNDERGROUND UTILITY LINES PRIOR TO COMMENCEMENT OF WORK.

CITY CONSTRUCTION DEPARTMENT OR ITS CONTRACTOR MUST COORDINATE THE LIGHTING SCHEME WITH COMED BY CALLING THEIR ACCOUNT MANAGER @1-773-838-4345

CONDUIT TO BE INSTALLED USING DIRECTIONAL BORING

DIRECTIONAL DRILLING IS APPROVED TO A MAXIMUM DEPTH OF 33 INCHES. ALL SERVICE CONTROL VALVE AND METER VAULT LOCATIONS MUST BE VERIFIED PRIOR TO CONSTRUCTION AND 3 FEET OF HORIZONTAL SEPERATION MUST BE MAINTAINED. SHOULD FIELD CONDITIONS REQUIRE ADDITIONAL ENGINEERING SERVICES OR RELOCATION. THEN COOT SHALL SUBMIT FUNDING AND/OR RFI FOR DWM APPROVAL PRIOR TO INSTALLATION.

LEGEND:

·--DB--- - DIRECTIONAL BORE

·--OC--- - OPEN CUT TRENCH


SCALE:

METHOD, UNLESS OTHERWISE NOTED.

OF CHICAGO	USER NAME = afl	DESIGNED	_	NRB	ADDENDUM NO. 1
		D D 41441		NDD	REVISED -
		DRAWN	-	NRB	ADDENDUM NO. 2
D C	PLOT SCALI 1:30	CHECKED	_	NRB	REVISED -
				0.4.10.0.10.00.5	ADDENDUM NO. 3
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CITY OF CHICAGO DEPARTMENT OF TRANSPORTATION

								ATL	AS P	-43	
_	PROPOSED LIGHTING IMPROVEMENTS						SECT	ION		COUN	T)
Р										coc	Κ
	SHEET 1	OF 3	SHEETS	STA.	TO STA.			ILLINOIS	FED. Al	D PROJECT	

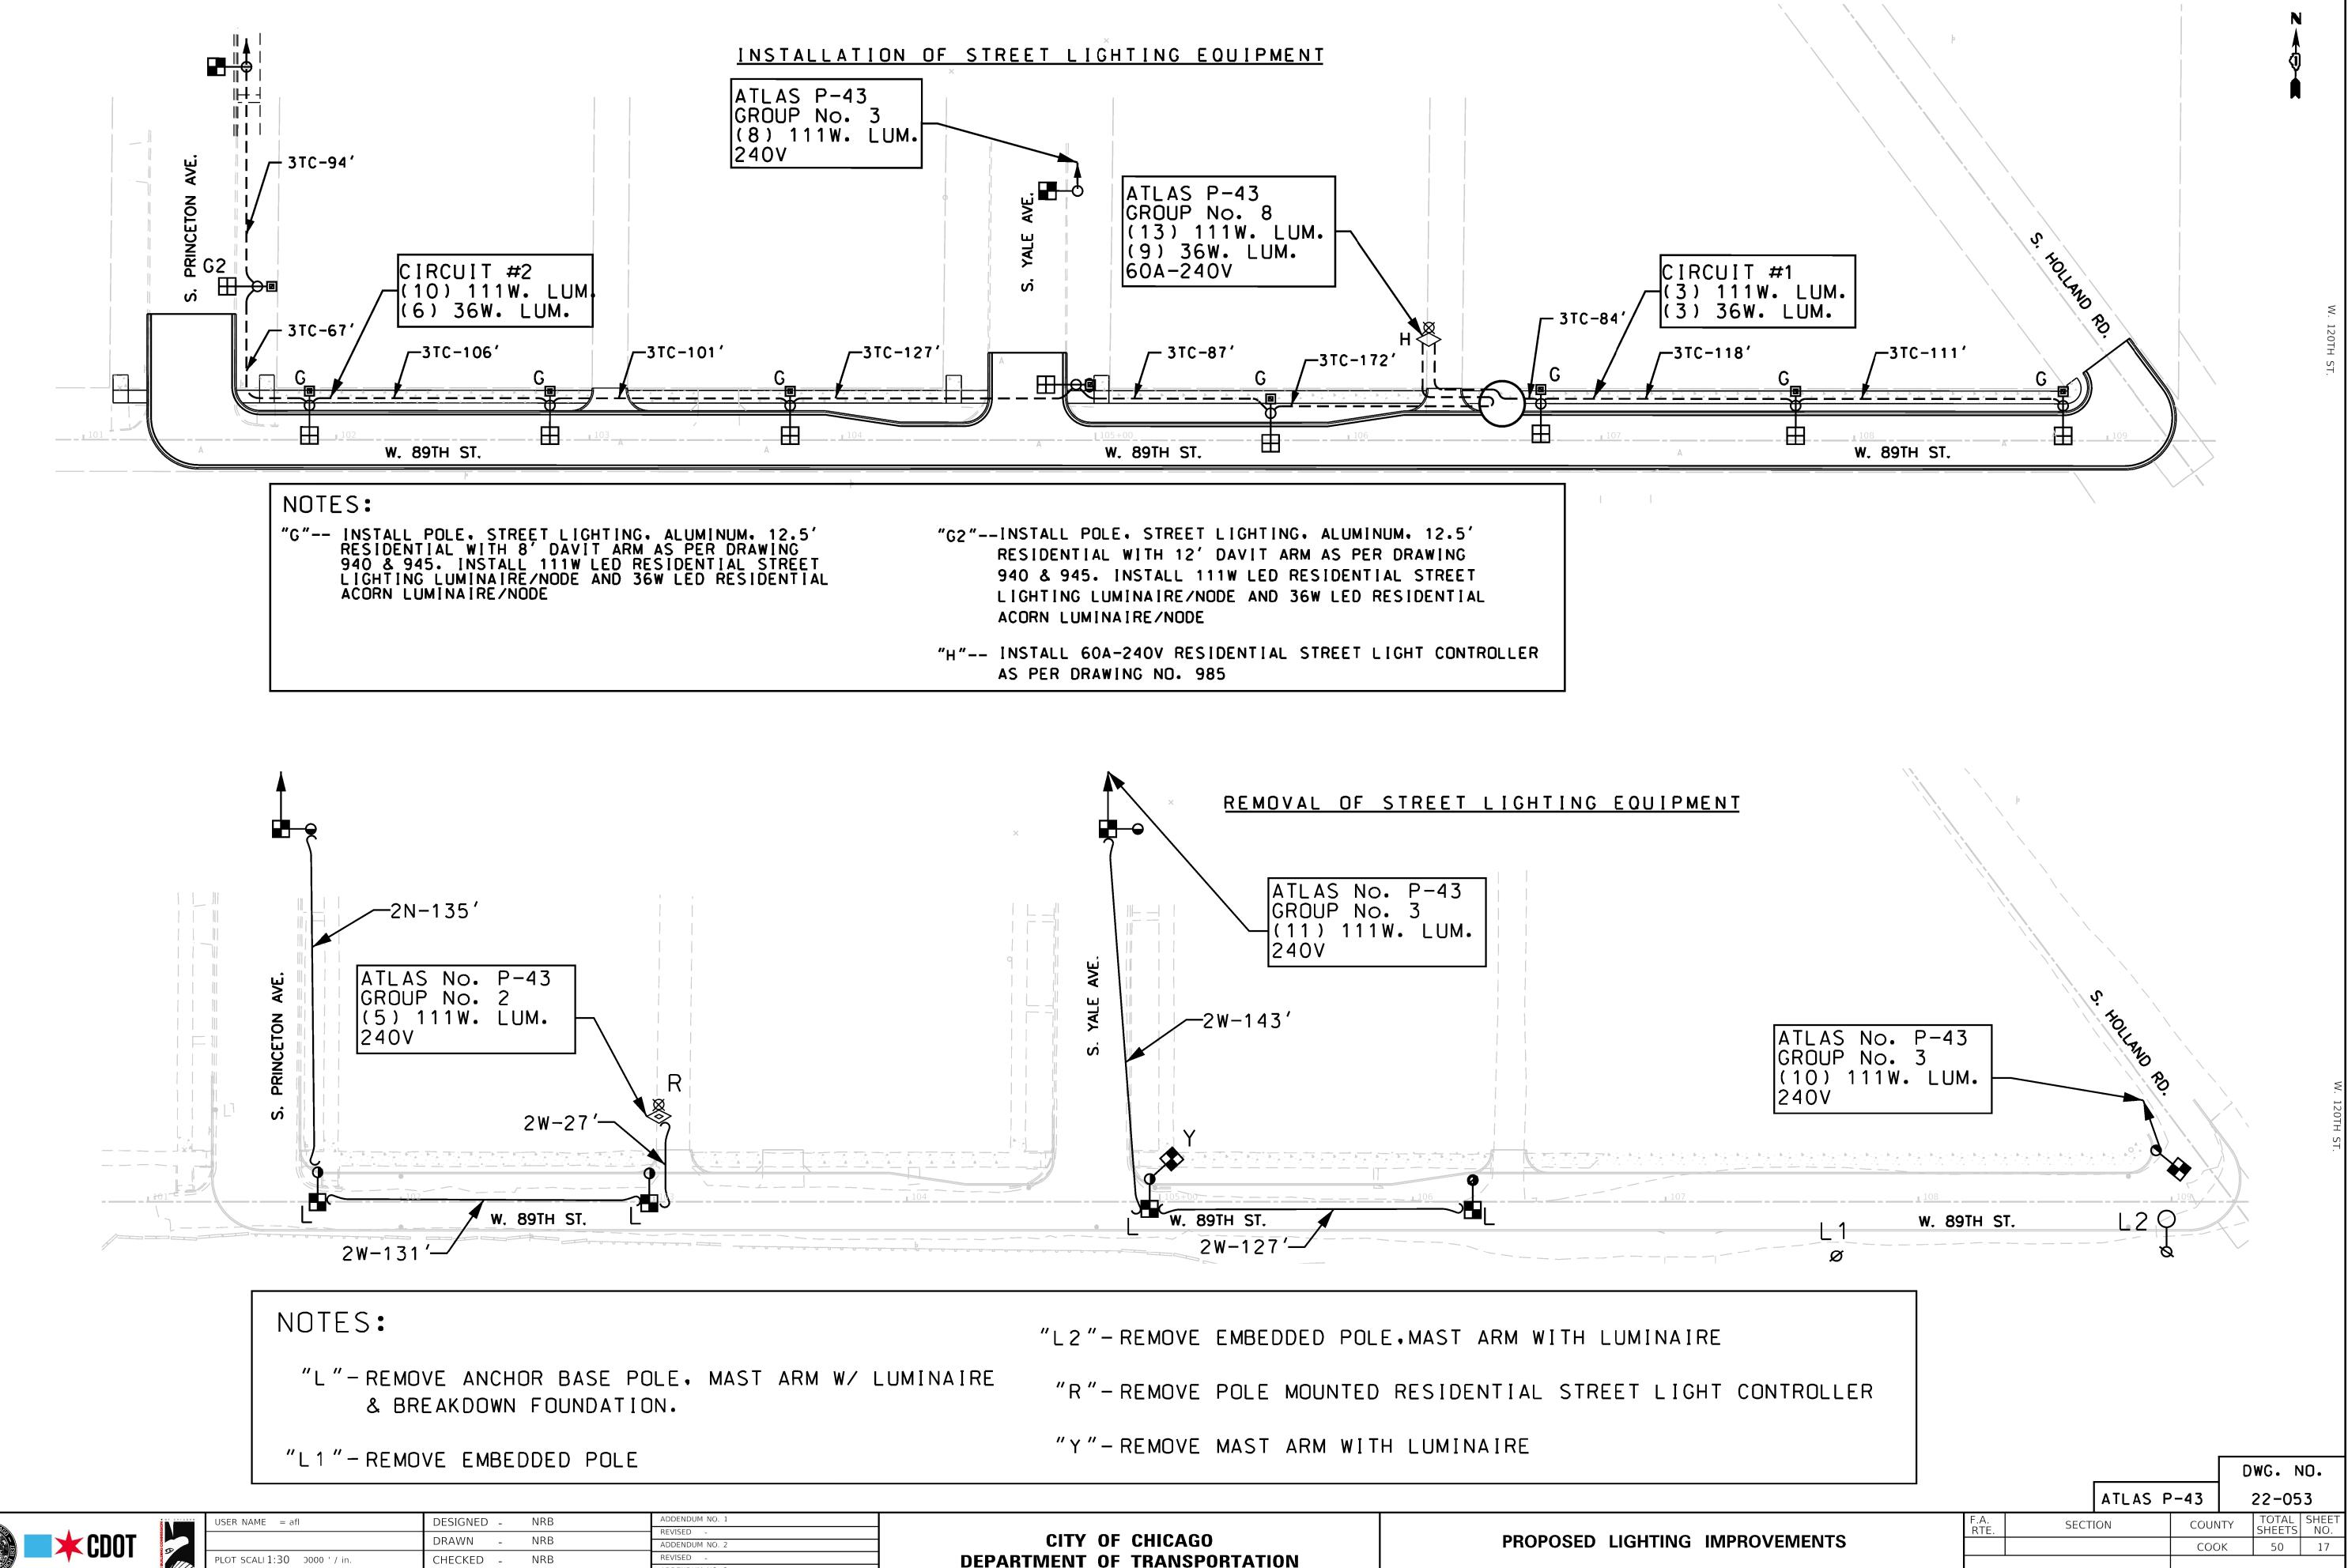

PLOT SCALI 1:30 0000 ' / in. CHECKED . NRB PLOT DATE = 4/30/202504/22/2025

DEPARTMENT OF TRANSPORTATION

OF 3 SHEETS STA. TO STA.

SCALE:

ILLINOIS FED. AID PROJECT



• OF CHICAGO	USER NAME = afl	DESIGNED -	ADDENDUM NO. 1		
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EN STATE OF		DRAWN -	ADDENDUM NO. 2		
	PLOT SCALBO.Đ 00 0000 'inin.	CHECKED -	REVISED -		
	· ·	DATE 04/22/2025	ADDENDUM NO. 3		
27K///.	PLOT DATE = $4/30/2025$	DATE - 04/22/2025	ISSUE TO BID - 5/6/2025		

	DDODOSED LIGHTING IMPDOVEMENTS					F.A. RTE.	SECTION	COUNTY	TOTAL SHEETS	SHEET NO.
PROPOSED LIGHTING IMPROVEMENTS							соок	50	18	
	SHEET 3	OF 3	SHEETS	STA.	TO STA.		ILLINOIS FED. A	ID PROJECT		


915 Har	oEnvironmental, Inc. ger Road, Suite 330 ok, IL 60523 9100			E	BORIN	G NUMB	ER E- ge 1 of		
CLIENT TranSystems Co	0220359.21	PROJECT LOCATION	PROJECT LOCATION Chicago, Cook County, IL						
DATE STARTED 1/3/22 DRILLING CONTRACTOR DRILLING METHOD Dire	R Environmental Soil Probing	GROUND ELEVATI GROUND WATER				CASING S	тав		
	CHECKED BY JJR	LEVELS (ft, bgs):	1/3/2022	DD	6.3				
O DEPTH (ft) GRAPHIC LOG	MATERIAL DESCRIPT	TION		REMARKS	SAMPLE TYPE NUMBER (Depth Interval)	PID RESULTS	RECOVERY (#)		
Silty TOPS(Poorly-grad CLAY (CL); Well-grade(OIL; trace Roots and Leaves; dark brown ed GRAVEL (GP), fine-grained; trace Silt; trace Si trace Gravel, fine; brown, moist d SAND (SW-SM), fine to medium-grained; little S trace Gravel, fine; grayish brown, moist			1	S-1 (0-4)	0.0	2.4		
4				1	S-2 (4-8)	0.0	3.1		
CLAY (CL);	trace Gravel, fine; grayish brown, wet			1	S-3 (8-12)	0.0	2.0		
End of boring En	ng at 12' BGS. Boring immediately backfilled with i	remaining soil.							


- 5			GZA GeoEnvironmental, Inc.			F	RORING	3 NUM	BER E-2
C	4	ZN	915 Harger Road, Suite 330 Oak Brook, IL 60523 630-684-9100			-			PAGE 1 OF 1
CL	.IEN	T Tra	anSystems Corporation	PROJECT NAME	TS CDOT C	CDD WI	PA Corridor	#5	
l			JMBER 81.0220359.21	PROJECT LOCATION					
	ΙTΕ	STAR	TED <u>1/3/22</u> COMPLETED <u>1/3/22</u>	GROUND ELEVATION	ON 602 +/	- 2	_ HOLE S	IZE 2 inche	es
DR	RILL	ING C	ONTRACTOR Environmental Soil Probing	-	DATE	TIME	DEPTH	CASING	STAB
DR			ETHOD Direct Push	GROUND WATER LEVELS (ft, bgs):	1/3/2022	DD	5.2		
LO			VLL CHECKED BY JJR						
DR	KILL	RIG _	Geoprobe 6610DT	-					
ОЕРТН		GRAPHIC LOG	MATERIAL DESCRIPTION	N		REMARKS	SAMPLE TYPE NUMBER (Depth Interval)	PID RESULTS	RECOVERY (ft)
Г		·	Silty TOPSOIL; trace Roots; dark brown, moist			1	S-1	0.0	2.2
			Poorly-graded SAND (SP-SM), fine to coarse-grained; little Silt; tr	ace Gravel, fine; dark bro	own, moist		(0-4)		
	7			,,	,				
			Well-graded SAND (SW), fine to medium-grained; trace Silt; trace	e Gravel, fine; orangish b	rown, wet				
- 4	1							0.0	45
			Well-graded SAND (SW), fine to medium-grained; trace Silt; trace	e Gravel, fine; light brown	ı, wet	1	S-2 (4-8)	0.0	1.5
-	_		CLAY (CL); trace Gravel, fine; gray, wet						
DR LO DR HLd30 C	<u>-</u>					1	S-3 (8-12)	0.0	1.9
1:	2								
			End of boring at 12' BGS. Boring immediately backfilled with remaining	aining soil.					
REMARKS	1.	Samp	le Collected						

G	ZN	GZA GeoEnvir 915 Harger Ro Oak Brook, IL 630-684-9100	pad, Suite 330 60523			E	BORING		BER E-3 PAGE 1 OF 1
CLIEN	VT Tr	anSystems Corporat	ion	PROJECT NAME	TS CDOT C	CDD W	PA Corridor	#5	
		•	59.21						
DATE	STAR	RTED 1/3/22	COMPLETED 1/3/22	GROUND ELEVATI	ON 599 +/	- 2	_ HOLE S	IZE 2 inche	es
DRILL	LING C	ONTRACTOR Env	rironmental Soil Probing		DATE	TIME	DEPTH	CASING	STAB
			sh	_ GROUND WATER LEVELS (ft, bgs):	1/3/2022	DD	5.7		
		Geoprobe 6610DT	CHECKED BY JJR	_					
DIVILL	_ NO _	Cooprose co to ST		_					
O DEPTH	GRAPHIC LOG		MATERIAL DESCRIPTION	ON		REMARKS	SAMPLE TYPE NUMBER (Depth Interval)	PID RESULTS	RECOVERY (ft)
 		CLÁY (CL); trace (Poorly-graded SAI brown, moist	ice Leaves and Roots; dark brown, moist Gravel, fine; trace Roots; dark brown, moist ND (SP-SM), fine to coarse-grained; little Silt; D (SW), fine to medium-grained; trace Silt; tra	, ,	,	1	S-1 (0-4)	0.0	2.1
			D (SW), fine to medium-grained; trace Silt; tra Gravel, fine; gray, wet	ice Gravel, fine; light browi	n, wet	1	S-2 (4-8)	0.0	2.2
8			Gravel, fine; gray, moist			1	S-3 (8-12)	0.0	2.5
	. Sam	End of boring at 12	2' BGS. Boring immediately backfilled with re	maining soil.		•			
MARKS									

CLIENT	Tran	Systems Corporation	PROJECT NAME	TS CDOT CO	DD W	PA Corridor	#5	
PROJEC	T NUI	MBER 81.0220359.21	PROJECT LOCATION	ON Chicago	, Cook	County, IL		
		ED <u>1/3/22</u> COMPLETED <u>1/3/22</u>	GROUND ELEVATION	ON 602 +/-	2	_ HOLE S	IZE 2 inches	
		NTRACTOR Environmental Soil Probing		DATE	TIME	DEPTH	CASING S	STAB
		THOD _Direct Push VLL CHECKED BY _JJR	GROUND WATER LEVELS (ft, bgs):	1/3/2022	DD	5.8		
		deoprobe 6610DT						
O DEPTH (ft)		MATERIAL DESCRIPTION			REMARKS	SAMPLE TYPE NUMBER (Depth Interval)	PID RESULTS	RECOVERY
-		Silty TOPSOIL containing Wood; trace Gravel, fine; trace Roots an CLAY (CL); trace Gravel, fine; dark brown, moist Well-graded SAND (SW), fine to medium-grained; trace Silt; trace brown, moist			1	S-1 (0-4)	0.0	2.5
4		Well-graded SAND (SW), fine to medium-grained; trace Silt; trace brown, and dark brown, moist	Gravel, fine; grayish bro	own, orangish	1	S-2 (4-8)	0.0	2.0
8		CLAY (CL); trace Gravel, fine; gray, wet						
					1	S-3 (8-12)	0.0	3.3

GZN	GZA GeoEnvironmental, Inc. 915 Harger Road, Suite 330							
	Oak Brook, IL 60523 630-684-9100			E	ORING	G NUM	BER E	E-5 DF 1
CLIENT T	anSystems Corporation	PROJECT NAME T	S CDOT C	CDD WI	PA Corridor	#5		
	IUMBER 81.0220359.21							
DATE STA	RTED 1/3/22 COMPLETED 1/3/22	GROUND ELEVATION	ON 599 +/	- 2	_ HOLE S	IZE 2 inche	es	
DRILLING	CONTRACTOR Environmental Soil Probing	-	DATE	TIME	DEPTH	CASING	STAR	
DRILLING	METHOD Direct Push	GROUND WATER LEVELS (ft, bgs):	1/3/2022	DD	5.8	January	UIAB	
LOGGED E	Y VLL CHECKED BY JJR	- LEVELS (II, bgs).						
DRILL RIG	Geoprobe 6610DT	-						
O DEPTH (ft) GRAPHIC LOG	MATERIAL DESCRIPTION	1		REMARKS	SAMPLE TYPE NUMBER (Depth Interval)	PID RESULTS	RECOVERY	(#)
	MULCH; red Well-graded SAND (SW-SM), fine to medium-grained; little Silt; tr Well-graded SAND (SW), fine to medium-grained; trace Silt; trace	race Gravel, fine; grayish e Gravel, fine; orangish bi	brown, mois rown, moist	it 1	S-1 (0-4)	0.0	1	1.7
	Well-graded SAND (SW), fine to medium-grained; little Gravel, fir Poorly-graded SAND (SP), fine to coarse-grained; little Gravel, fir Well-graded SAND (SW), fine to medium-grained; trace Silt; trace brown, moist CLAY (CL); trace Gravel, fine; gray, wet	e; trace Silt; light brown,	moist	1	S-2 (4-8)	0.0	1	1.9
8	CLAY (CL); trace Gravel, fine; gray and reddish brown, mottled, w	<i>r</i> et		1	S-3 (8-12)	0.0	3	3.1
12 R 1. San	End of boring at 12' BGS. Boring immediately backfilled with remaining the collected	aining soil.						

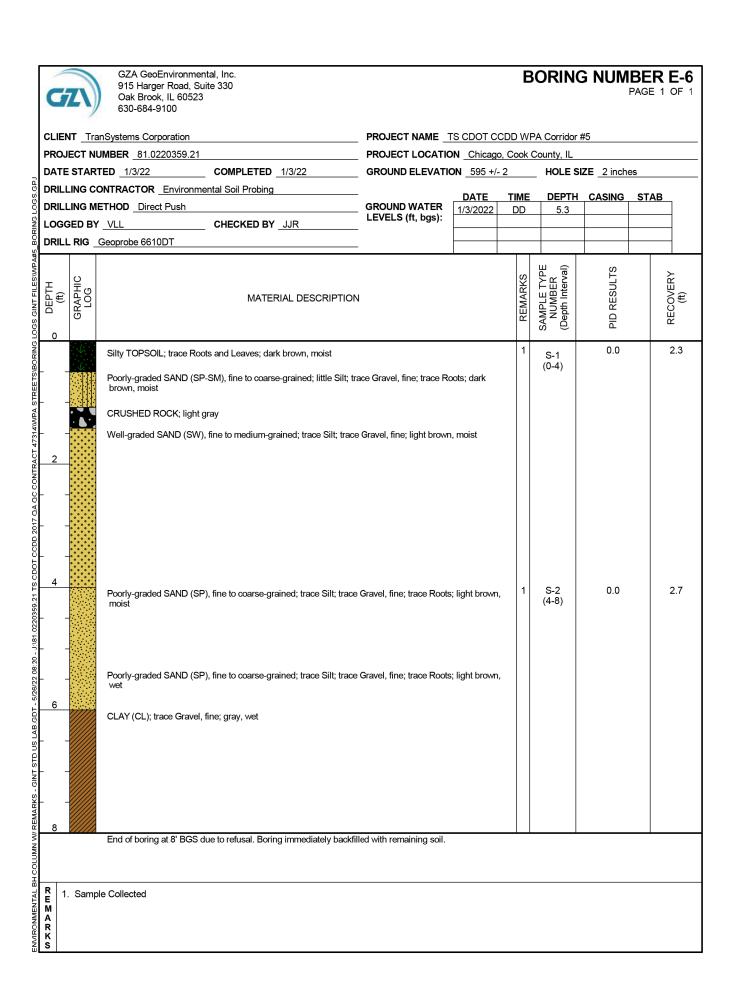


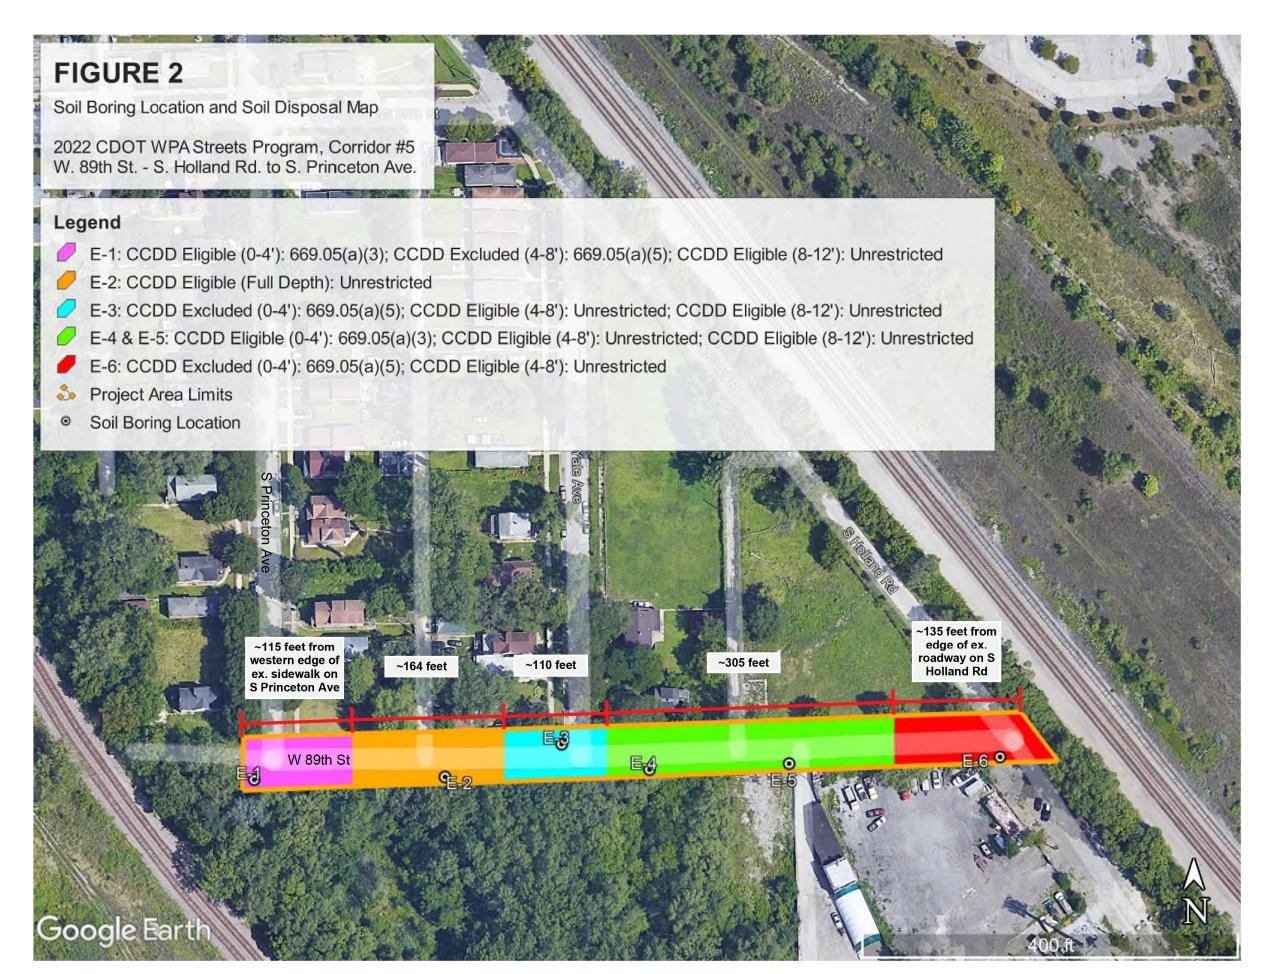



NO F CHICAGO	USER NAME = afl	DESIGNED -	ADDENDUM NO. 1
MISSIN		554444	REVISED -
NG COM		DRAWN -	ADDENDUM NO. 2
9	PLOT SCALE = 1.000 ' / in.	CHECKED -	REVISED -
	D. O.T. D. A.T.	DATE 04/22/2025	ADDENDUM NO. 3
27K///.	PLOT DATE = $4/30/2025$	DATE - 04/22/2025	ISSUE TO BID - 5/6/2025

	0011 5				F.A. RTE.	SECTION		COUNTY	TOTAL SHEETS	SHEET NO.
	SOIL B	ORING	LOG					COOK	50	19
SHEET 1	OF 1	SHEETS	STA.	TO STA.		ILLINOIS	FED. A	ID PROJECT		

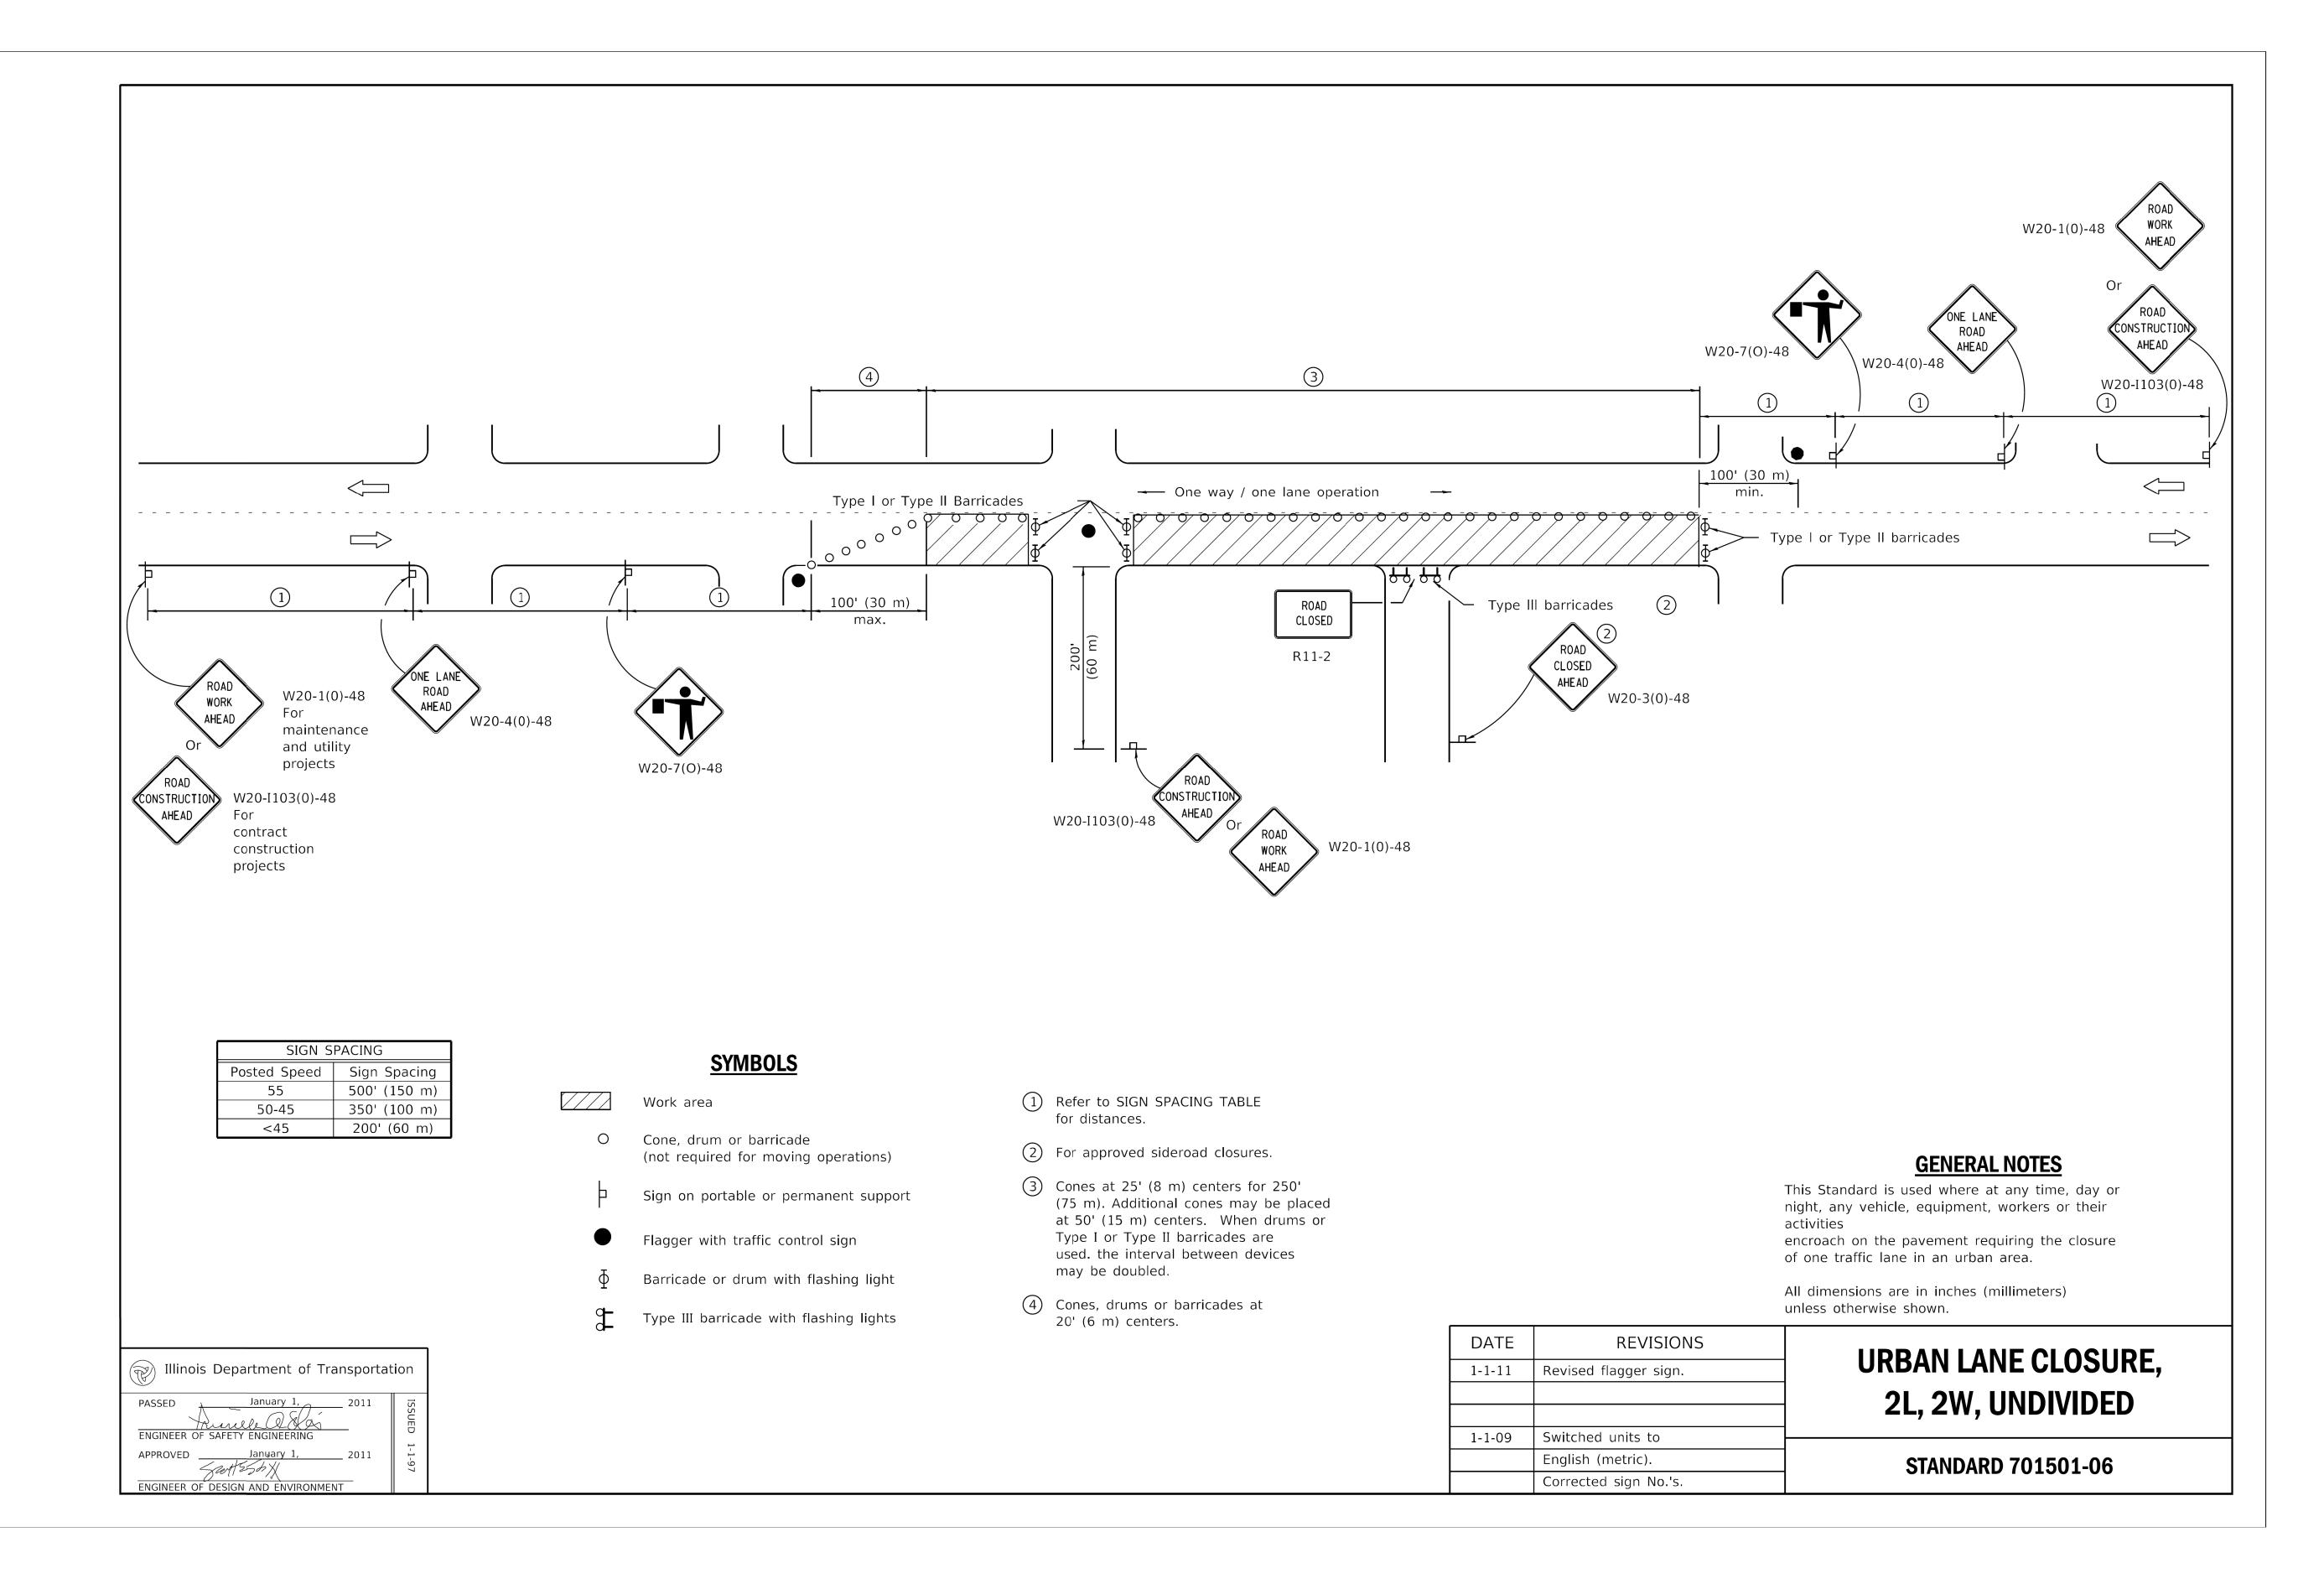







3 0	USER NAME = afl	DESIGNED -		ADDENDUM NO. 1		
		554444		REVISED -		
		DRAWN -		ADDENDUM NO. 2		
	PLOT SCALE = $10.0000 '$ / in.	CHECKED -		REVISED -		
	DI 07 D 175 4 120 120 5	D.A.T.E.	0.4./2.2./2.0.2.5	ADDENDUM NO. 3		
<i>'</i> .	PLOT DATE = $4/30/2025$	DATE -	04/22/2025	ISSUE TO BID -	5/6/2025	

CITY	OF	CHICAGO
DEPARTMENT	OF	TRANSPORTATION

	F.A. RTE.	SECTION	COUNTY	TOTAL SHEETS	SHEET NO.
IDOT HIGHWAY STANDARDS			СООК	50	20
SHEET 1 OF 27 SHEETS STA. TO STA.		ILLINOIS FED. A	ID PROJECT		

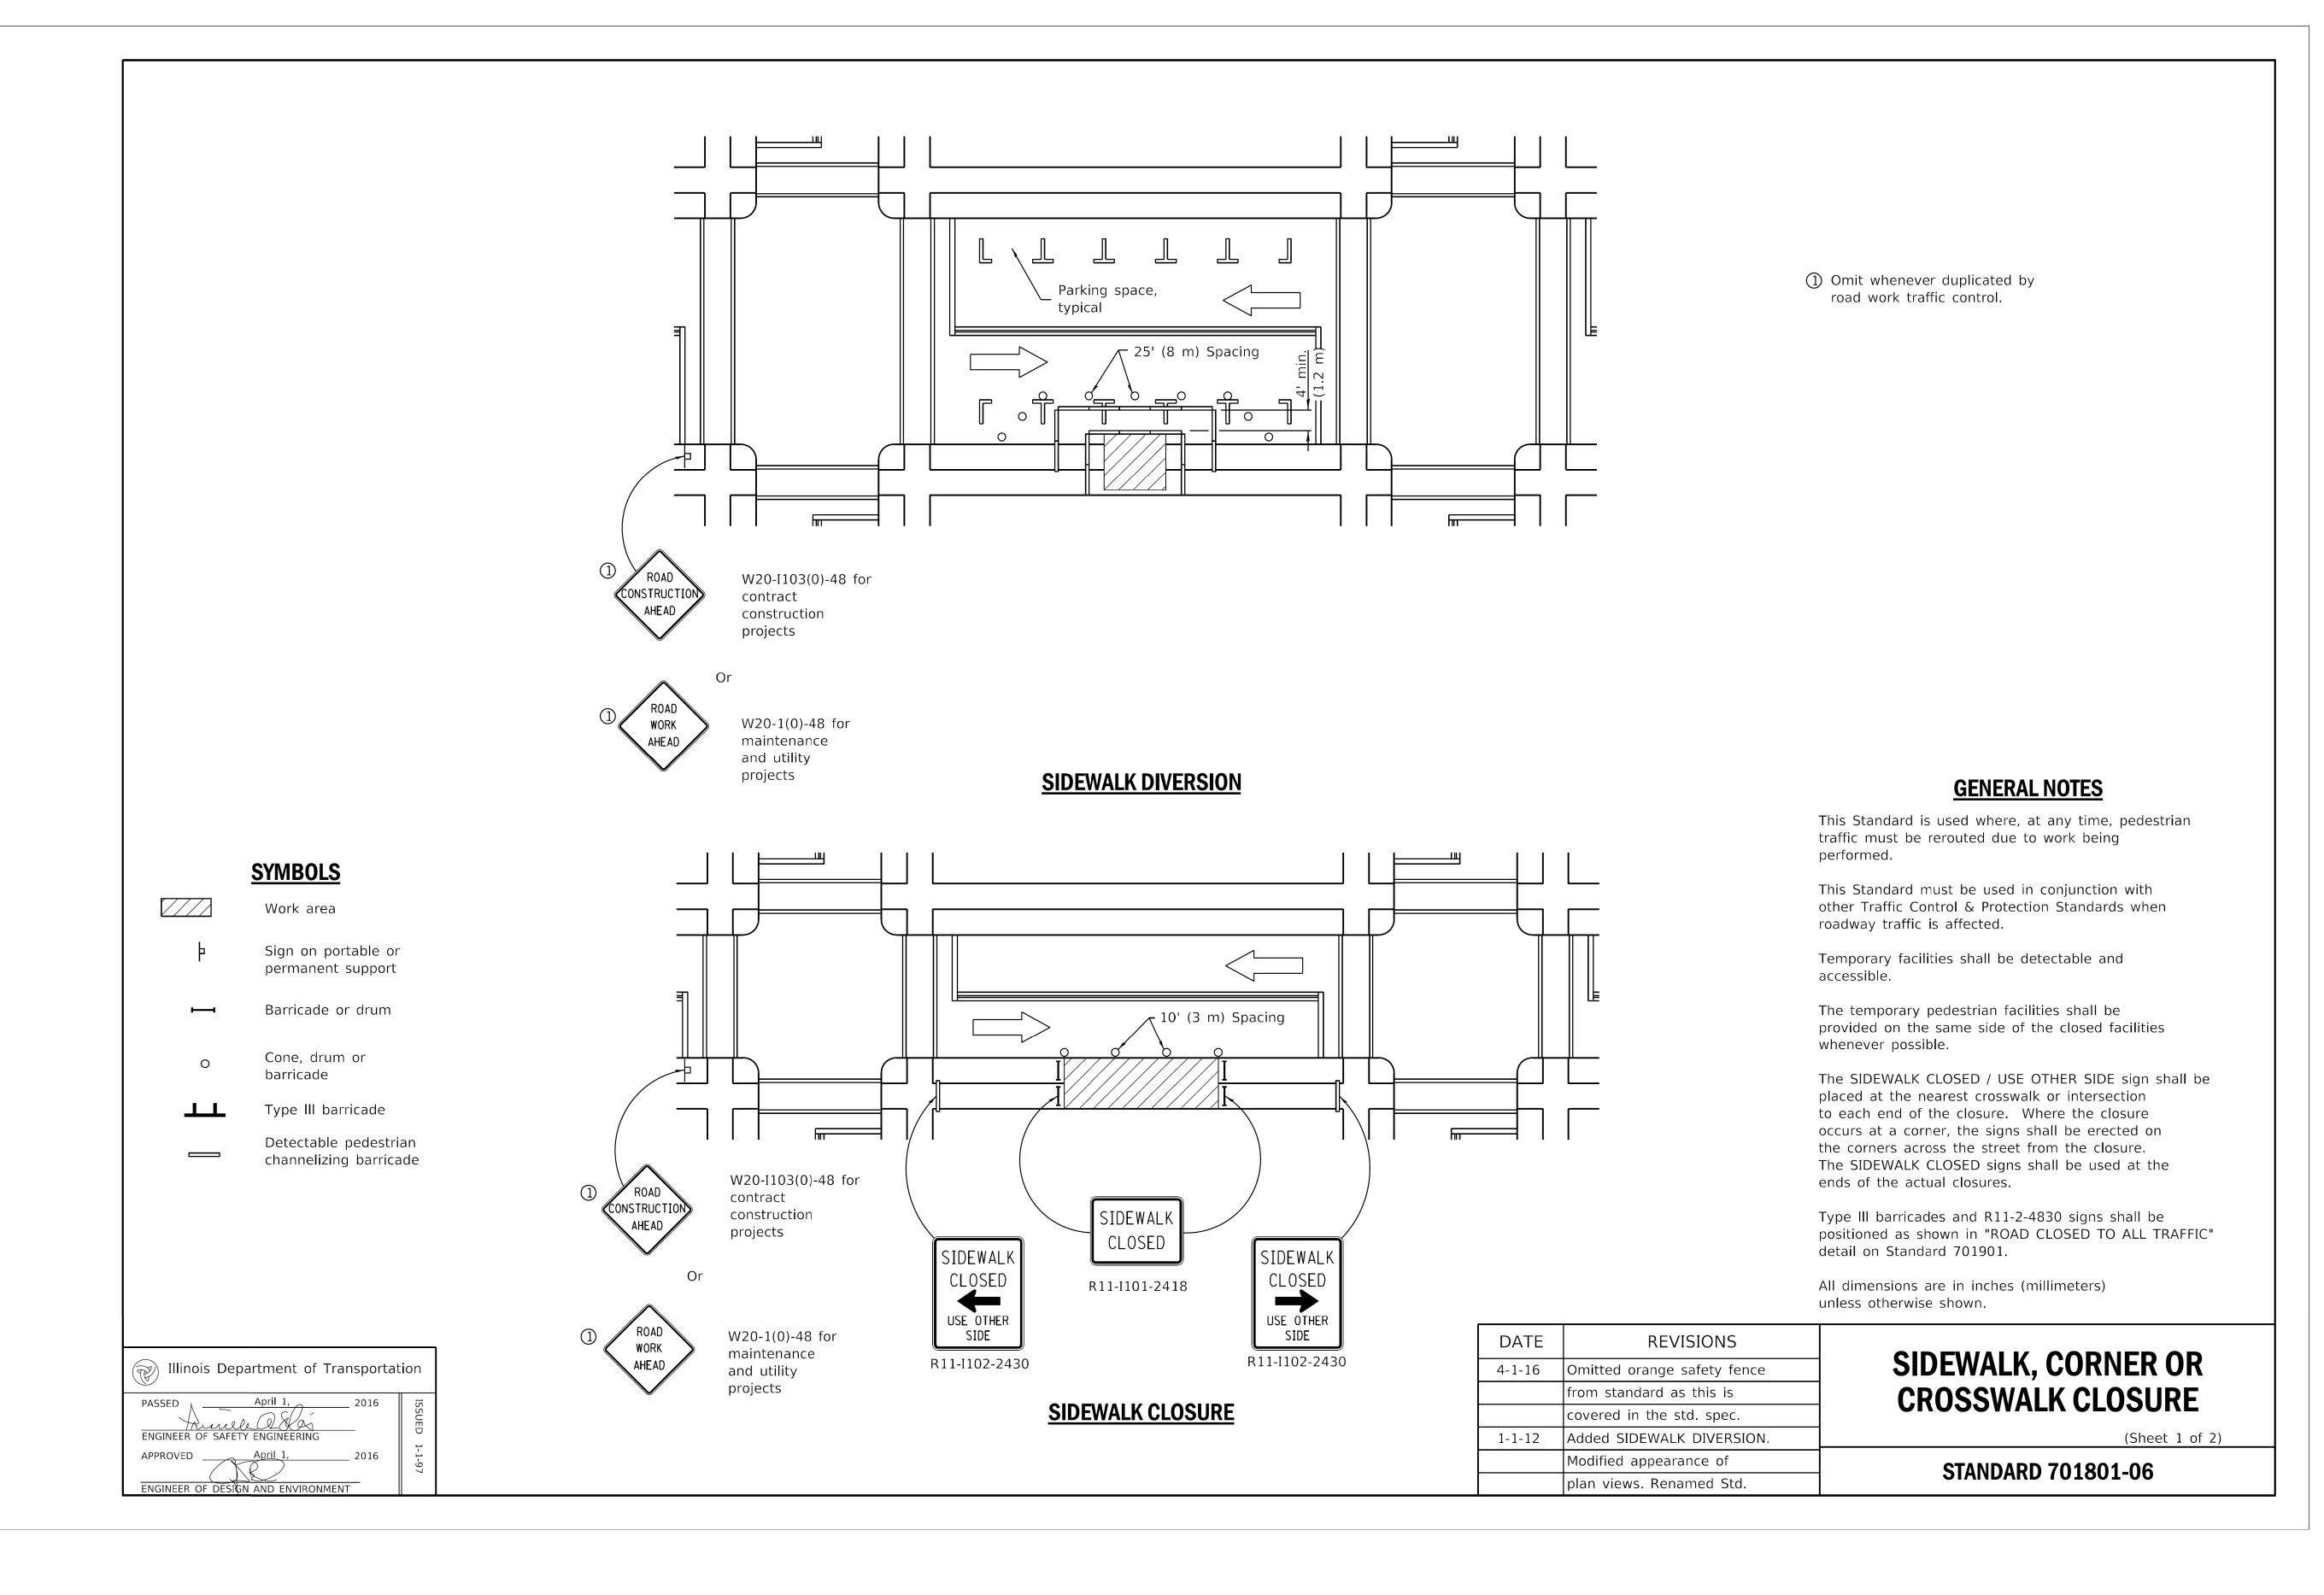


*CDOT

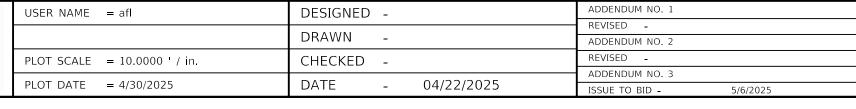

CITY OF CHICAGO
DEPARTMENT OF TRANSPORTATION

IDOT INCIDANA CTANDADO	F.A. RTE.	SECTION		COUNTY	TOTAL SHEETS	SHEET NO.
IDOT HIGHWAY STANDARDS				СООК	50	21
SHEET 2 OF 27 SHEETS STA. TO STA.		ILLINOIS	FED. AI	ID PROJECT		

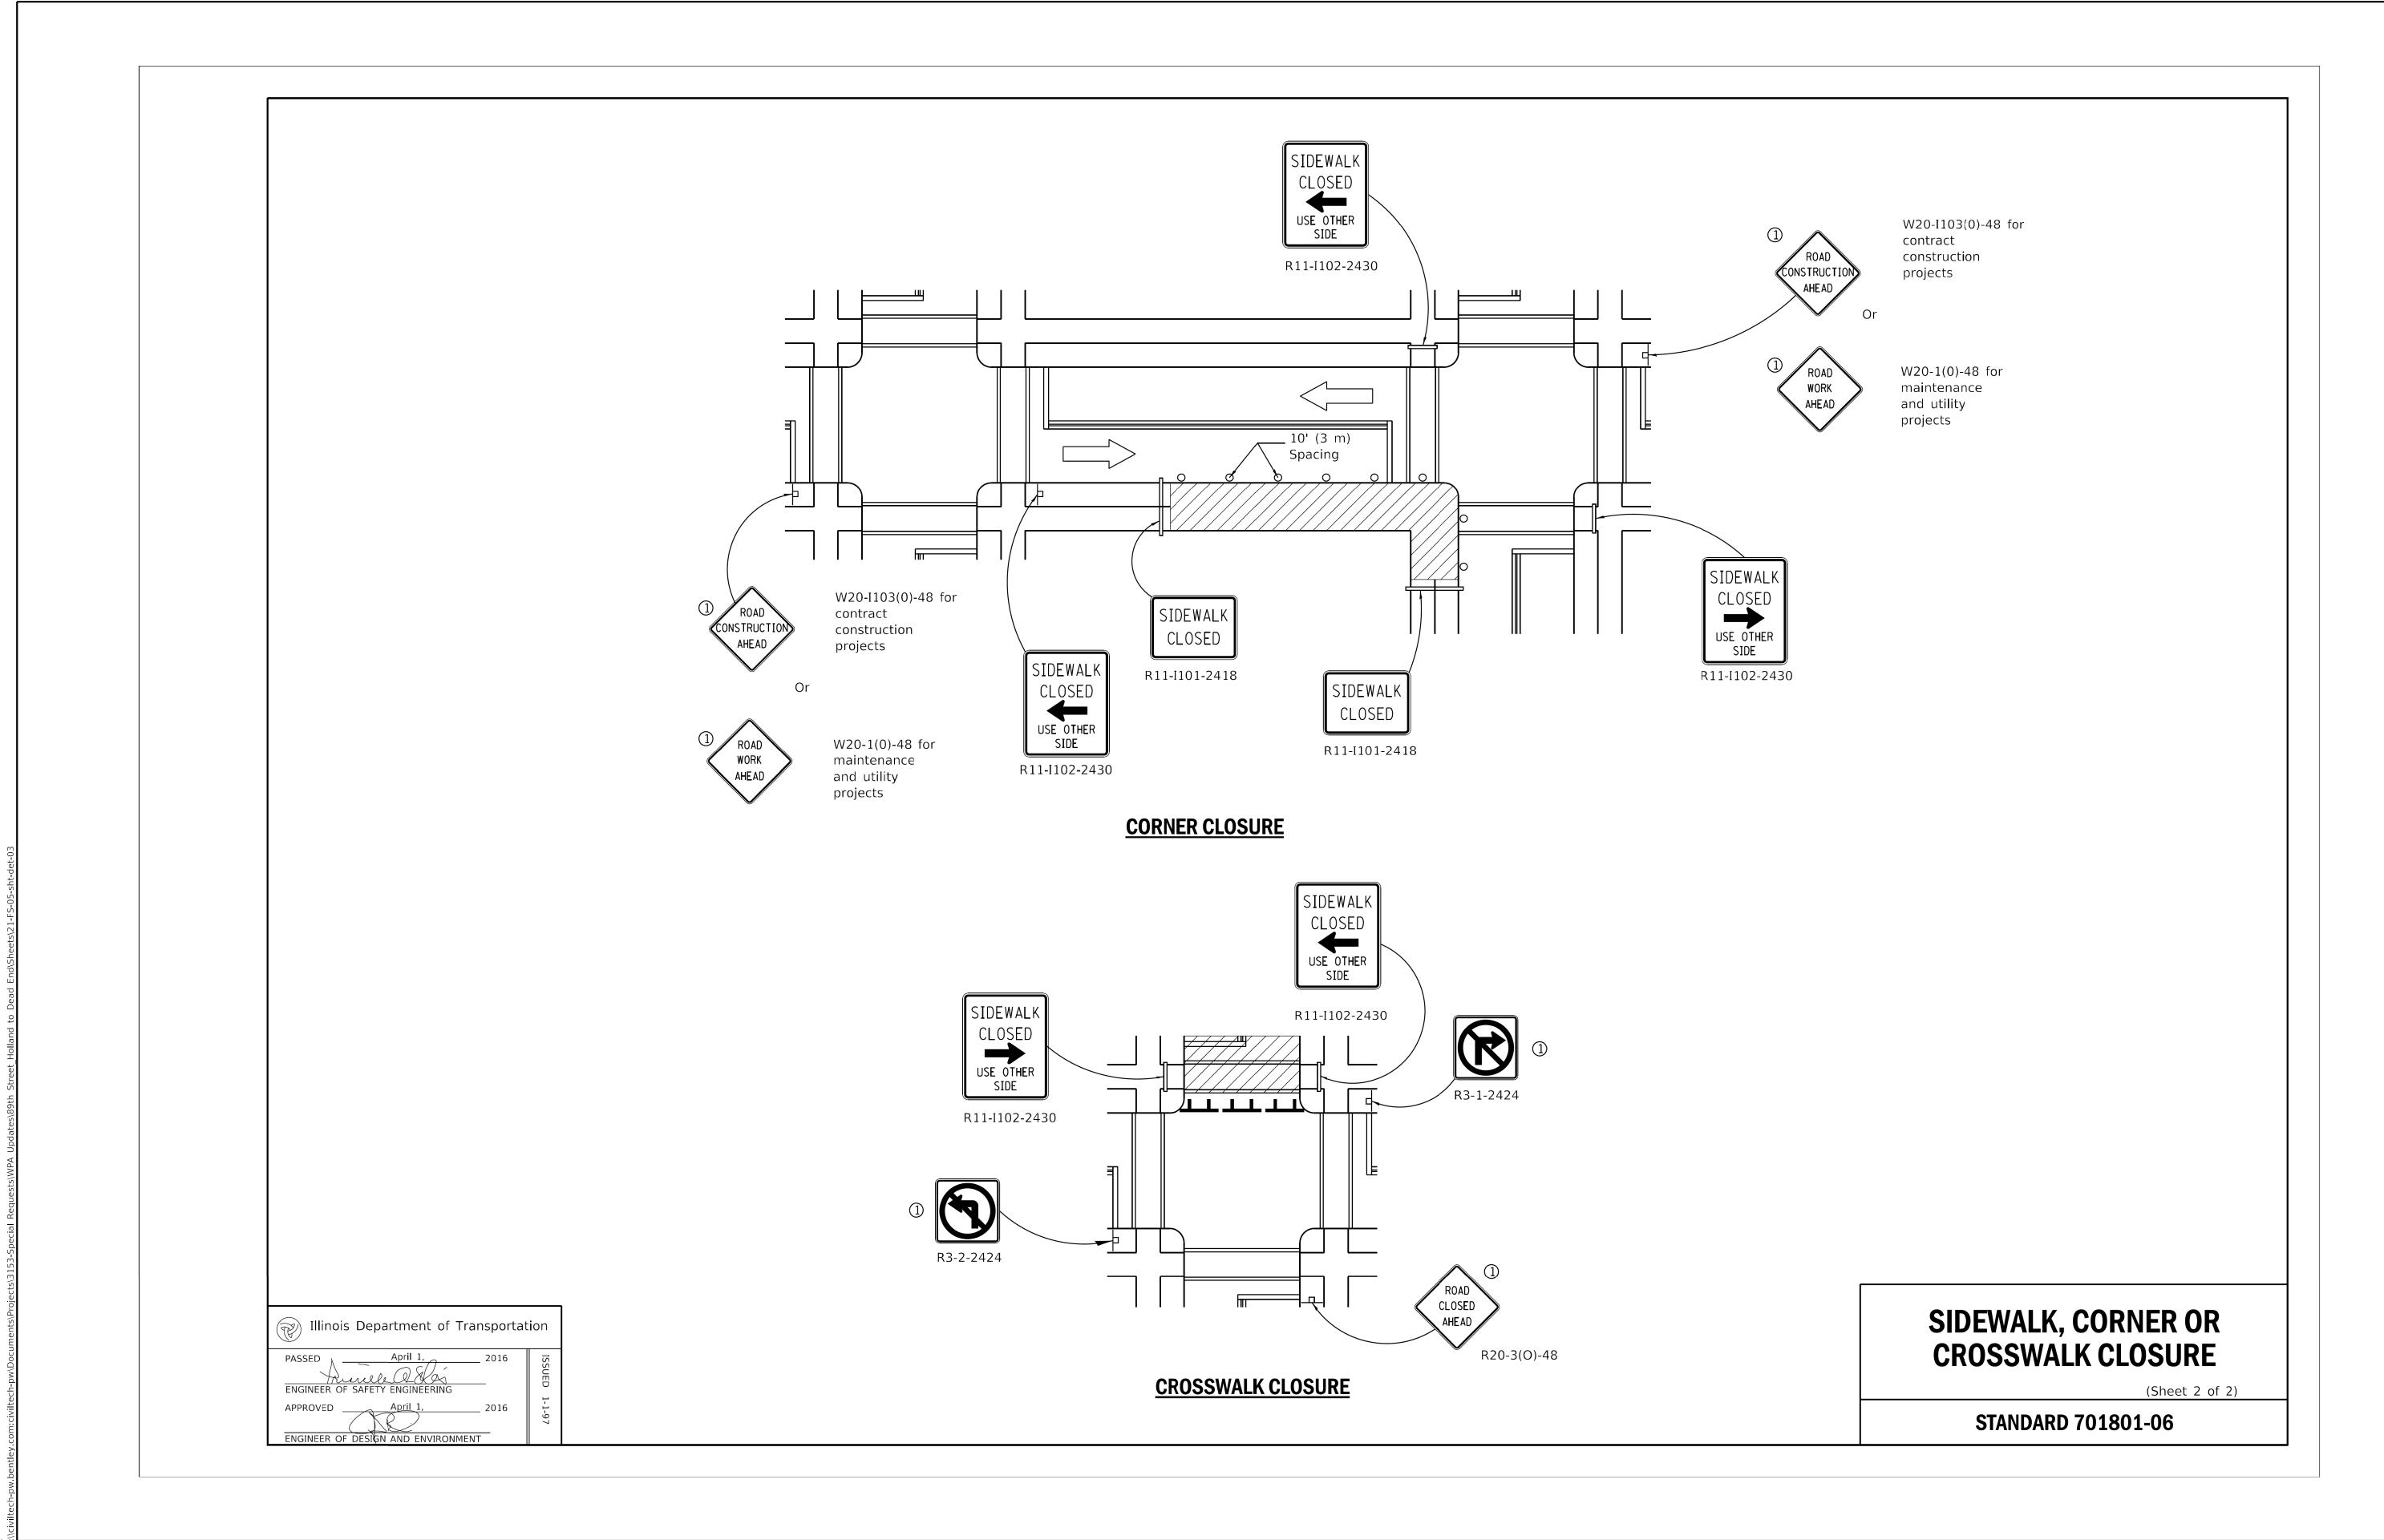

CDOT CDOT

USER NAME = aff | DESIGNED - ADDENDUM NO. 1


REVISED - ADDENDUM NO. 2


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PLOT DATE = 4/30/2025 DATE - 04/22/2025 ISSUE TO BID - 5/6/2025

CITY OF CHICAGO
DEPARTMENT OF TRANSPORTATION


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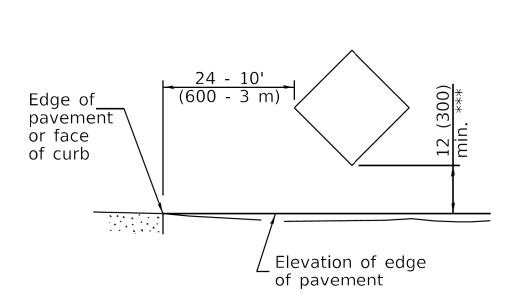
CITY	OF	CHICAGO
DEPARTMENT	OF	TRANSPORTATION

10.07		/A.V. 03			F.A. RTE.	SECT	ΓΙΟΝ		COUNTY	TOTAL SHEETS	SHEET NO.
IDOT HIGHWAY STANDARDS									COOK	50	23
SHEET 4	OF 27	SHEETS	STA.	TO STA.			ILLINOIS	FED. AI	D PROJECT		

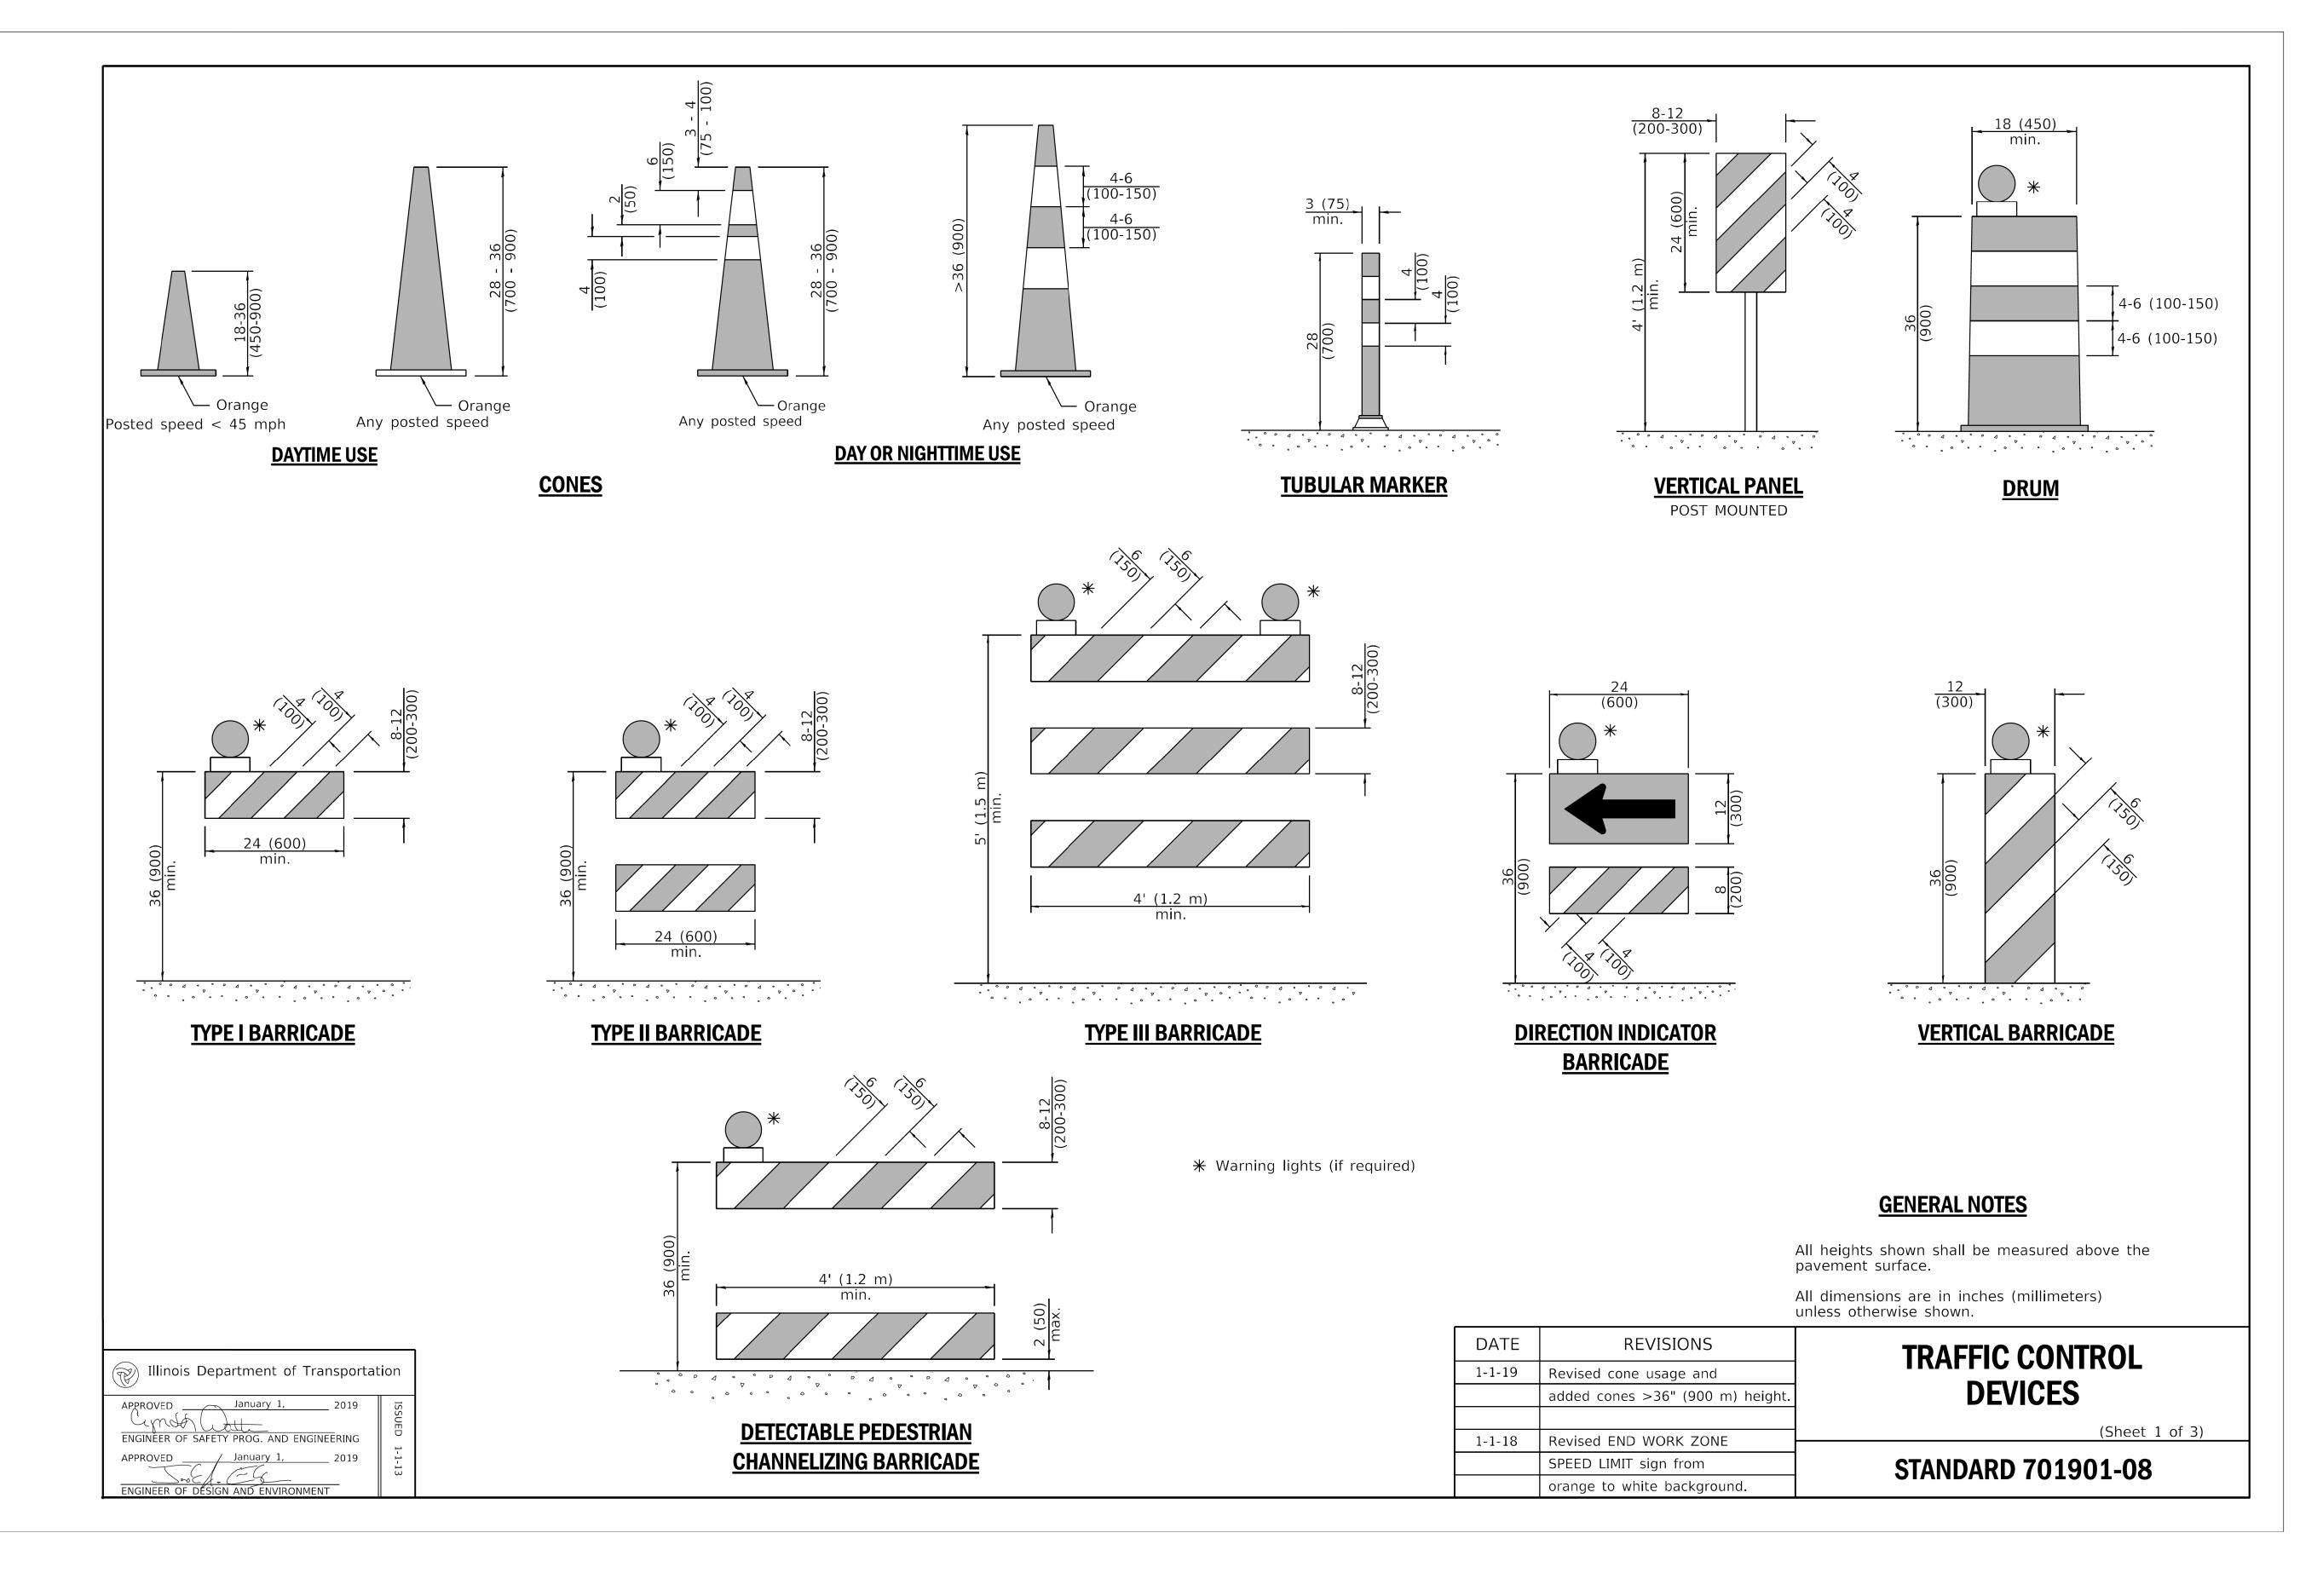

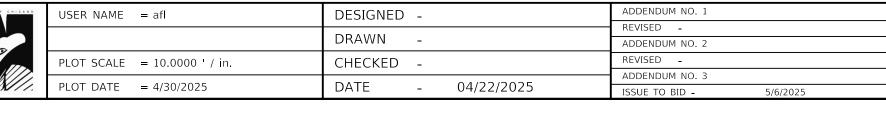
POST MOUNTED SIGNS

** When curb or paved shoulder are present this dimension shall be 24 (600) to the face of curb or 6' (1.8 m) to the outside edge of the paved shoulder.

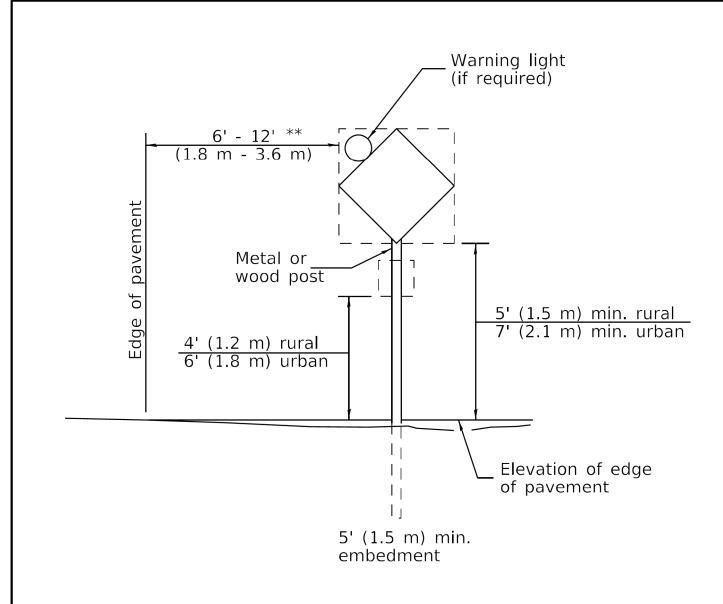

SIGNS ON TEMPORARY SUPPORTS

*** When work operations exceed four days, this dimension shall be 5' (1.5 m) min. If located behind other devices, the height shall be sufficient to be seen completely above the devices.

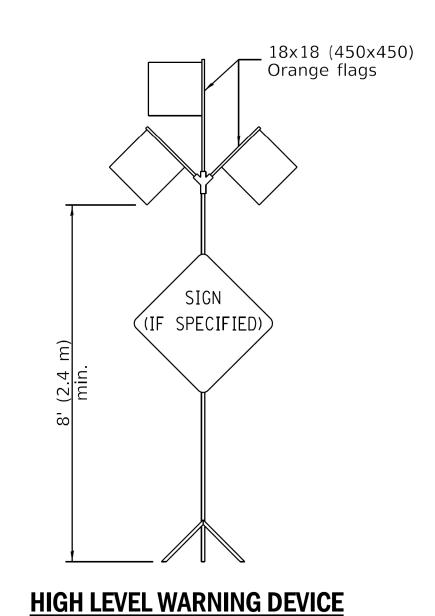

ROAD CONSTRUCTION NEXT X MILES

END CONSTRUCTION

G20-I104(0)-6036

G20-I105(0)-6024


This signing is required for all projects 2 miles (3200 m) or more in length.

ROAD CONSTRUCTION NEXT X MILES sign shall be placed 500' (150 m) in advance of project limits.

END CONSTRUCTION sign shall be erected at the end of the job unless another job is within 2 miles (3200 m).

Dual sign displays shall be utilized on multilane highways.

WORK LIMIT SIGNING

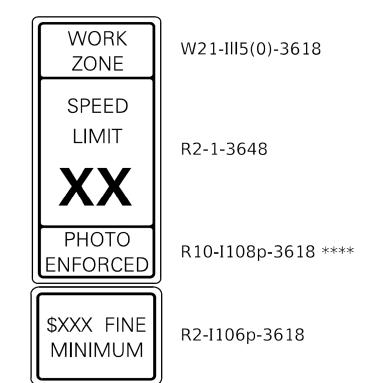

Sign assembly as shown on Standards or as allowed by District Operations.



This sign shall be used when the above sign assembly is used.

HIGHWAY CONSTRUCTION SPEED ZONE SIGNS

**** R10-I108p shall only be used along roadways under the juristiction of the State.


TRAFFIC CONTROL **DEVICES**

(Sheet 2 of 3)

TOTAL SHEET SHEETS NO.

50 24


STANDARD 701901-08

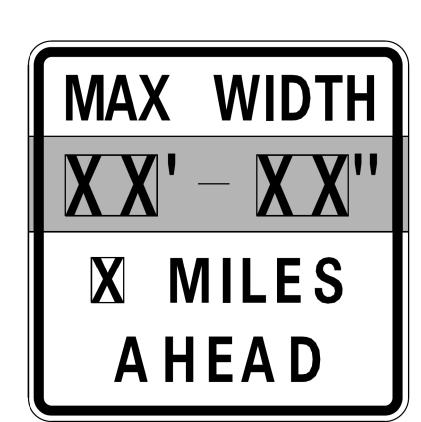



W12-I103-4848

WIDTH RESTRICTION SIGN

XX'-XX" width and X miles are variable.

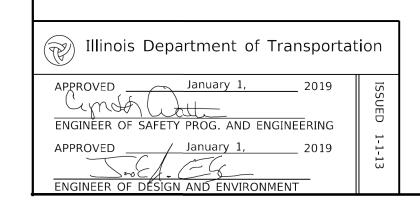

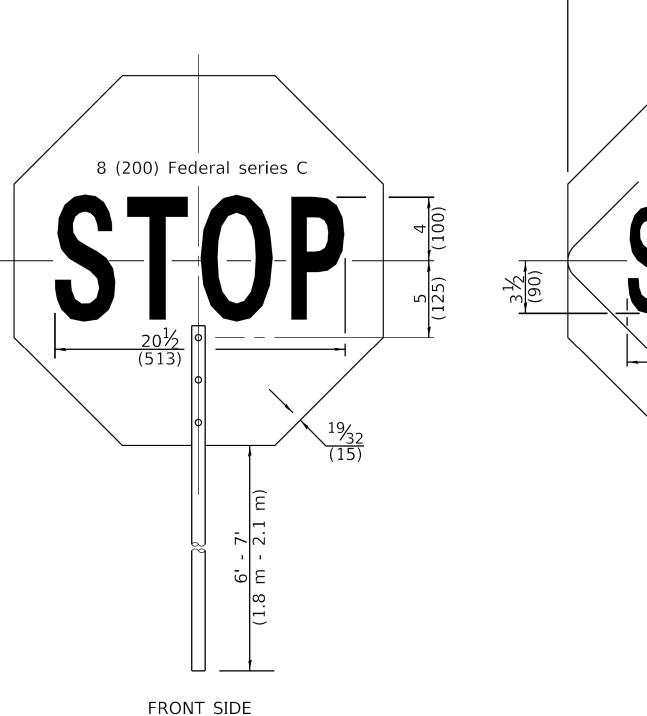

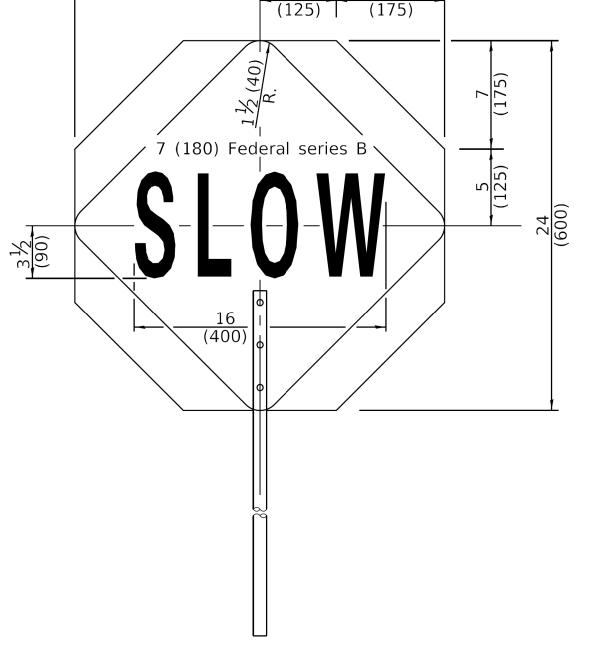

REVERSE SIDE

SCALE:


24 (600)

FLAGGER TRAFFIC CONTROL SIGN

0 0	USER NAME = afl	DESIGNED -	ADDENDUM NO. 1
		DRAWAL	REVISED -
		DRAWN -	ADDENDUM NO. 2
	PLOT SCALE = $10.0000 '$ / in.	CHECKED -	REVISED -
			ADDENDUM NO. 3
<i>'</i> .	PLOT DATE = $4/30/2025$	DATE - 04/22/2025	ISSUE TO BID - 5/6/2025

CITY OF CHICAGO **DEPARTMENT OF TRANSPORTATION**

						A. RTE.		SECT	ION		COUNTY
IDOT	IDOT HIGHWAY STANDARDS										COOK
		T									
SHEET 5	OF 27	SHEETS	STA.	TO STA.					ILLINOIS	FED. Al	ID PROJECT

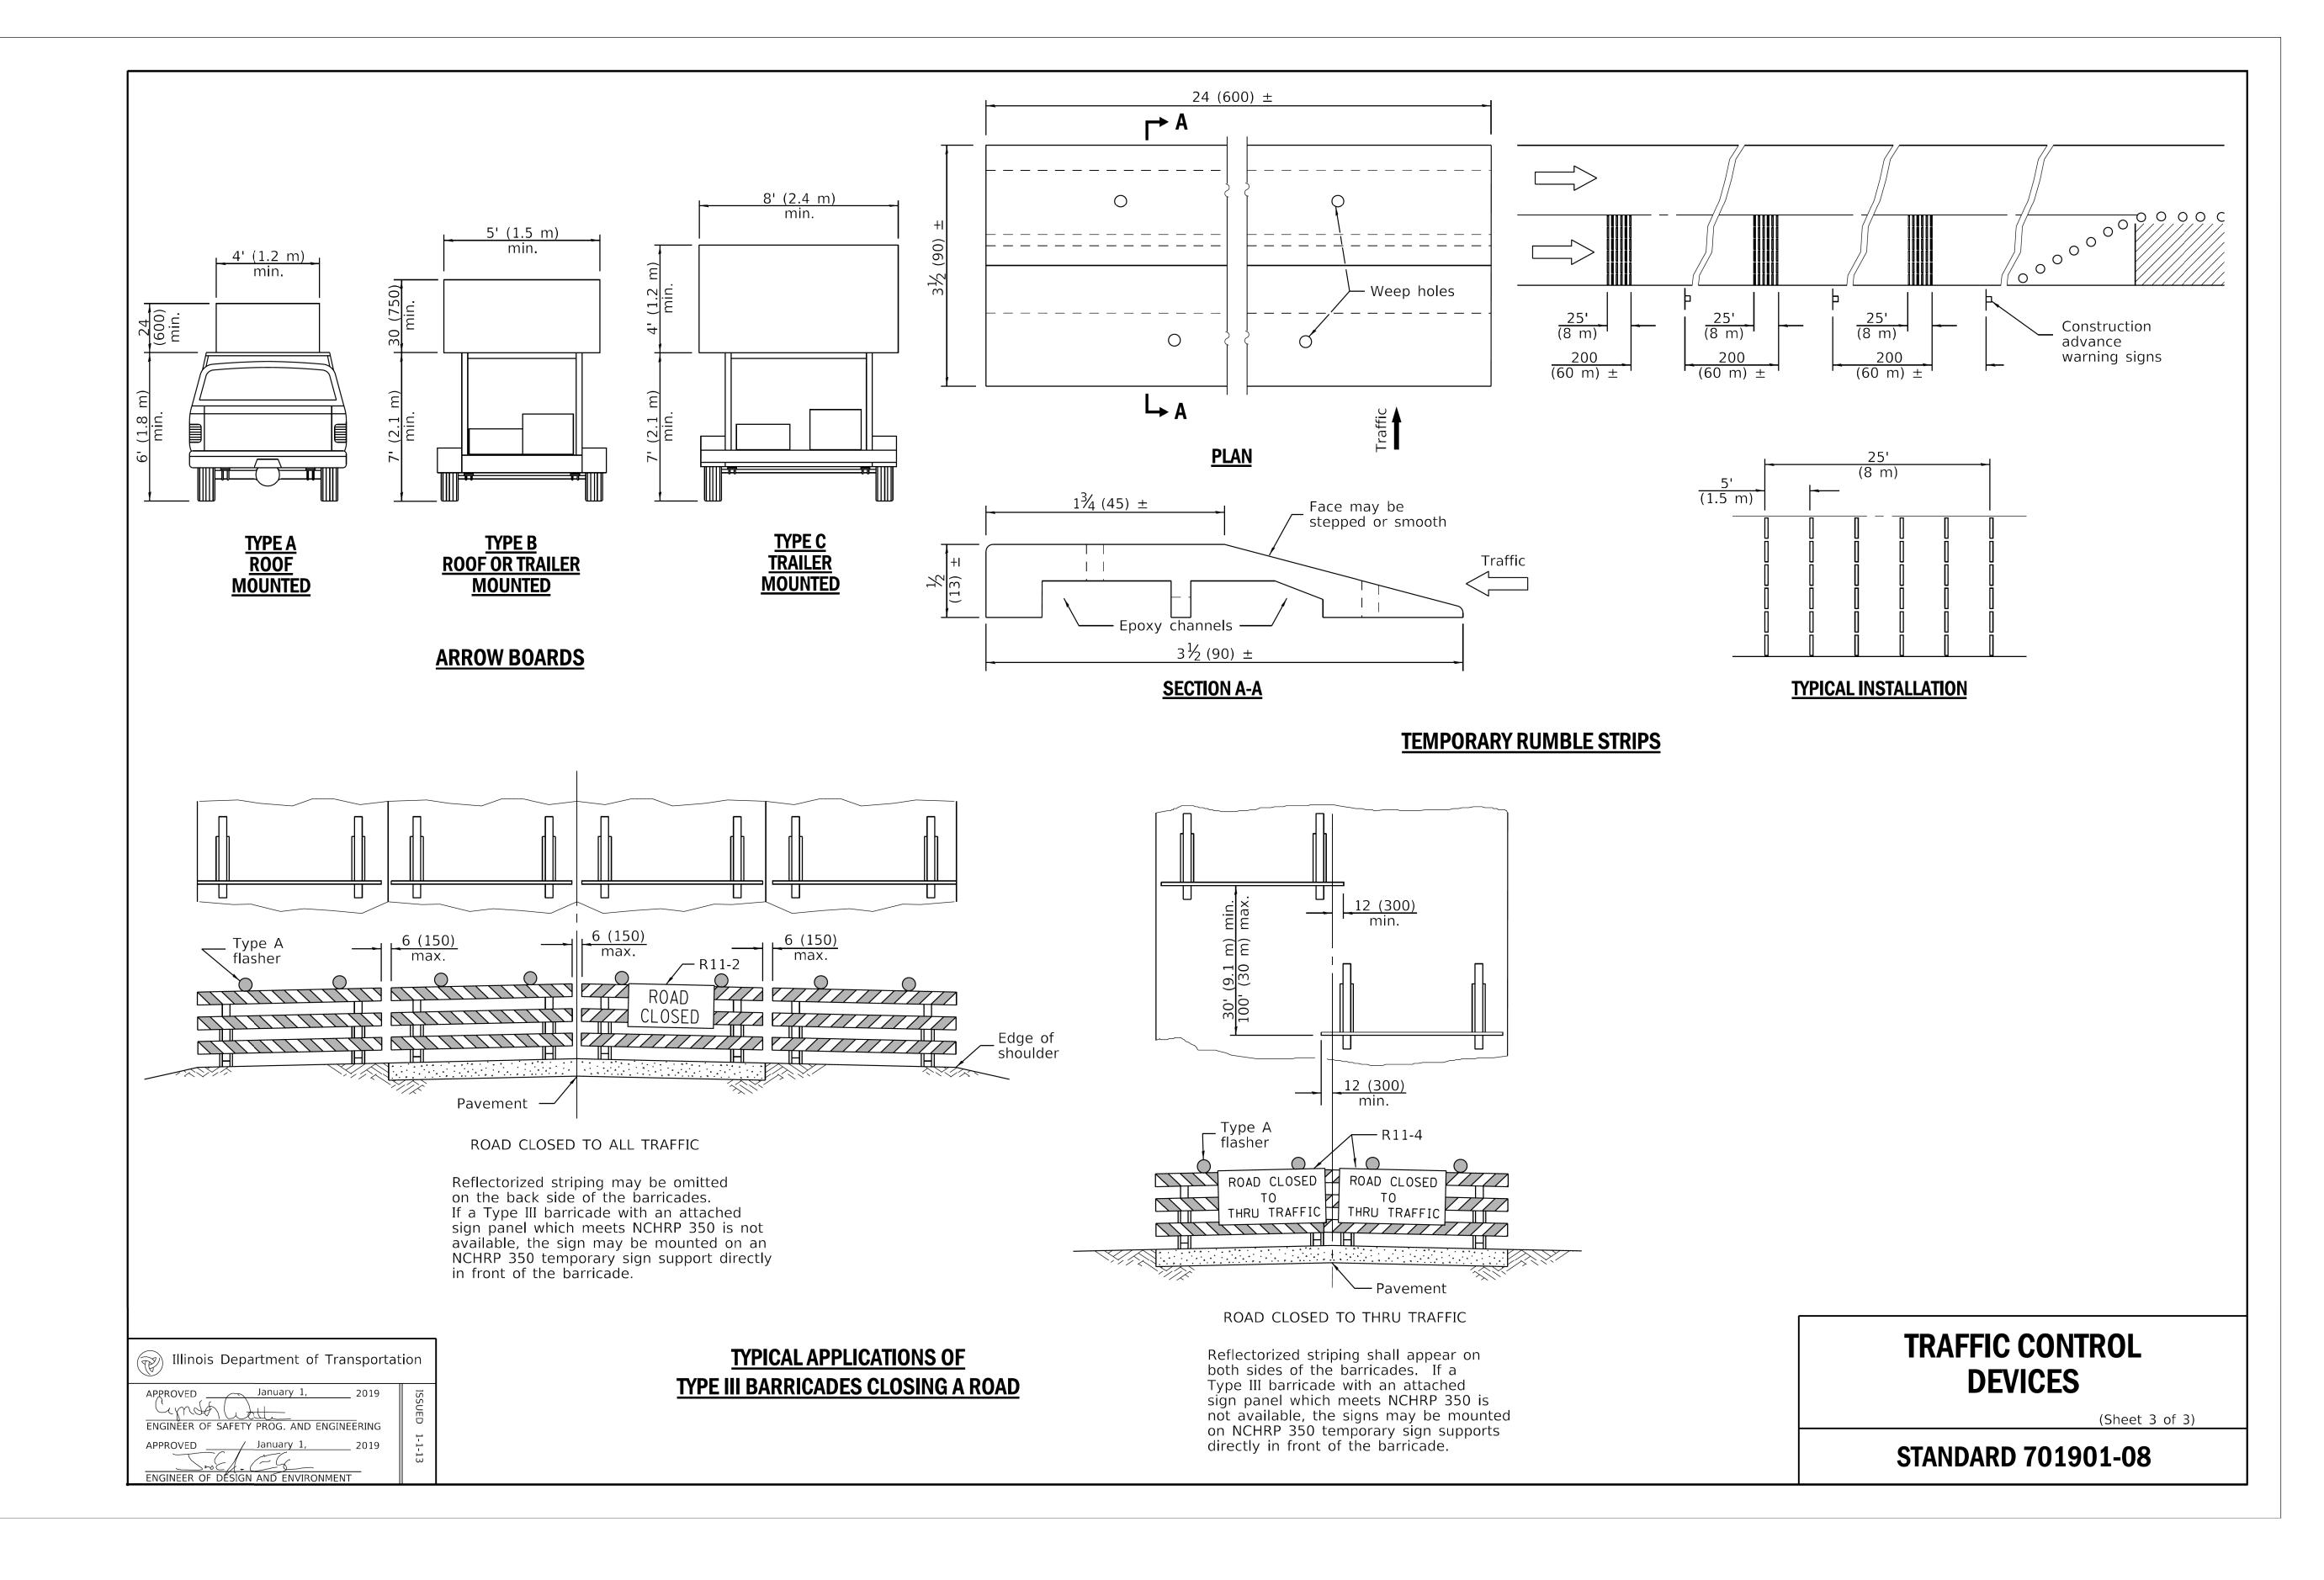




OF CHICAGO	USER NAME = afl	DESIGNED -	ADDENDUM NO. 1			
OF CHICAGO		DD AMAL	REVISED -			
D		DRAWN -	ADDENDUM NO. 2			
	PLOT SCALE = $10.0000 ' / in$.	CHECKED -	REVISED -			
	DLOT DATE A/20/2025	DATE 04/22/2025	ADDENDUM NO. 3			
%X///.	PLOT DATE = $4/30/2025$	DATE - 04/22/2025	ISSUE TO BID - 5/6/2025			

CITY	OF	CHICAGO
DEPARTMENT	OF	TRANSPORTATION


					F.A. RTE.	SECTION		COUNTY	TOTAL SHEETS	SHEET NO.
IDOT HIGHWAY STANDARDS								COOK	50	25
T										
SHEET 6	OF 27	SHEETS	STA.	TO STA.		ILLINOIS	FED. AI	ID PROJECT		

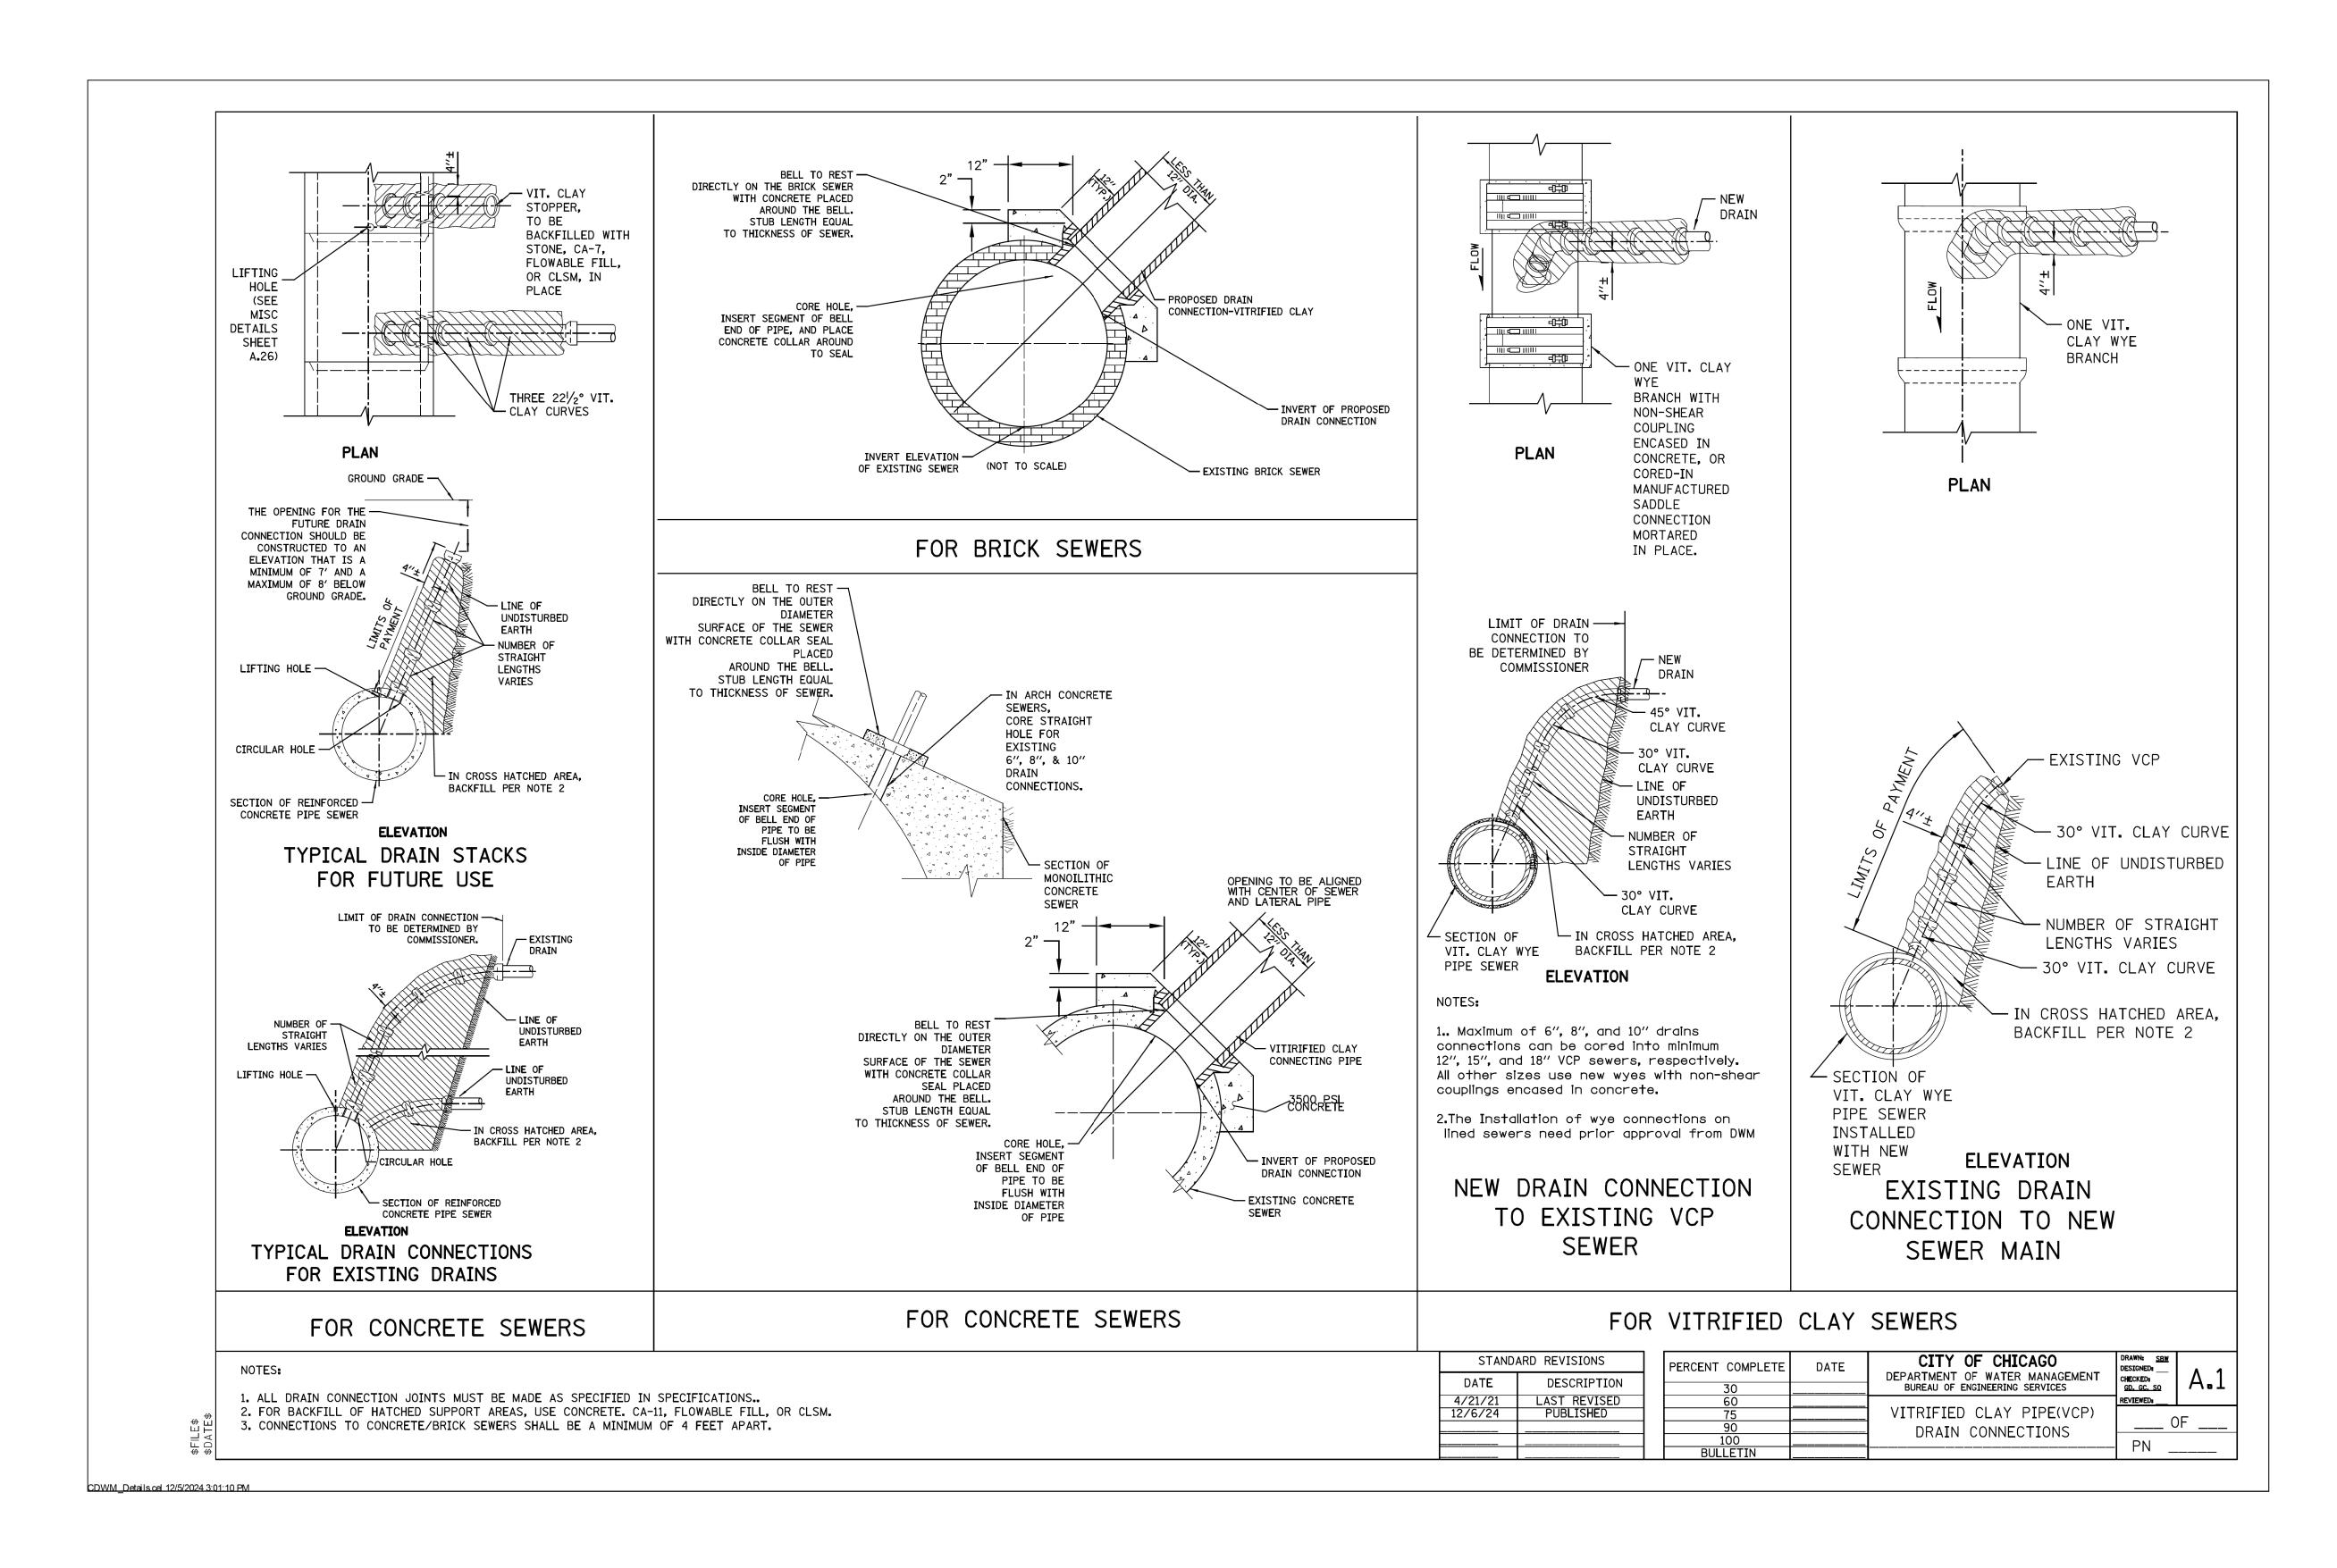


60	USER NAME = afl	DESIGNED -	ADDENDUM NO. 1				
		D.D. A.VANA	REVISED -				
		DRAWN -	ADDENDUM NO. 2				
	PLOT SCALE = $10.0000 '$ / in.	CHECKED -	REVISED -				
	DI 07 D 177	DATE 04/22/2025	ADDENDUM NO. 3				
/.	PLOT DATE = $4/30/2025$	DATE - 04/22/2025	ISSUE TO BID - 5/6/2025				

CITY	OF	CHICAGO
DEPARTMENT	OF	TRANSPORTATION

	0011	·			DET 4 11 0			F.A. RTE.	SEC	TION		COUNTY	TOTAL SHEETS	SHEET NO.
(CDW	IVI	SE	:WER	DETAILS							COOK	50	26
SHEET 7		OF	27	SHEETS	STA.	TO ST	A.			ILLINOIS	FED. Al	D PROJECT		

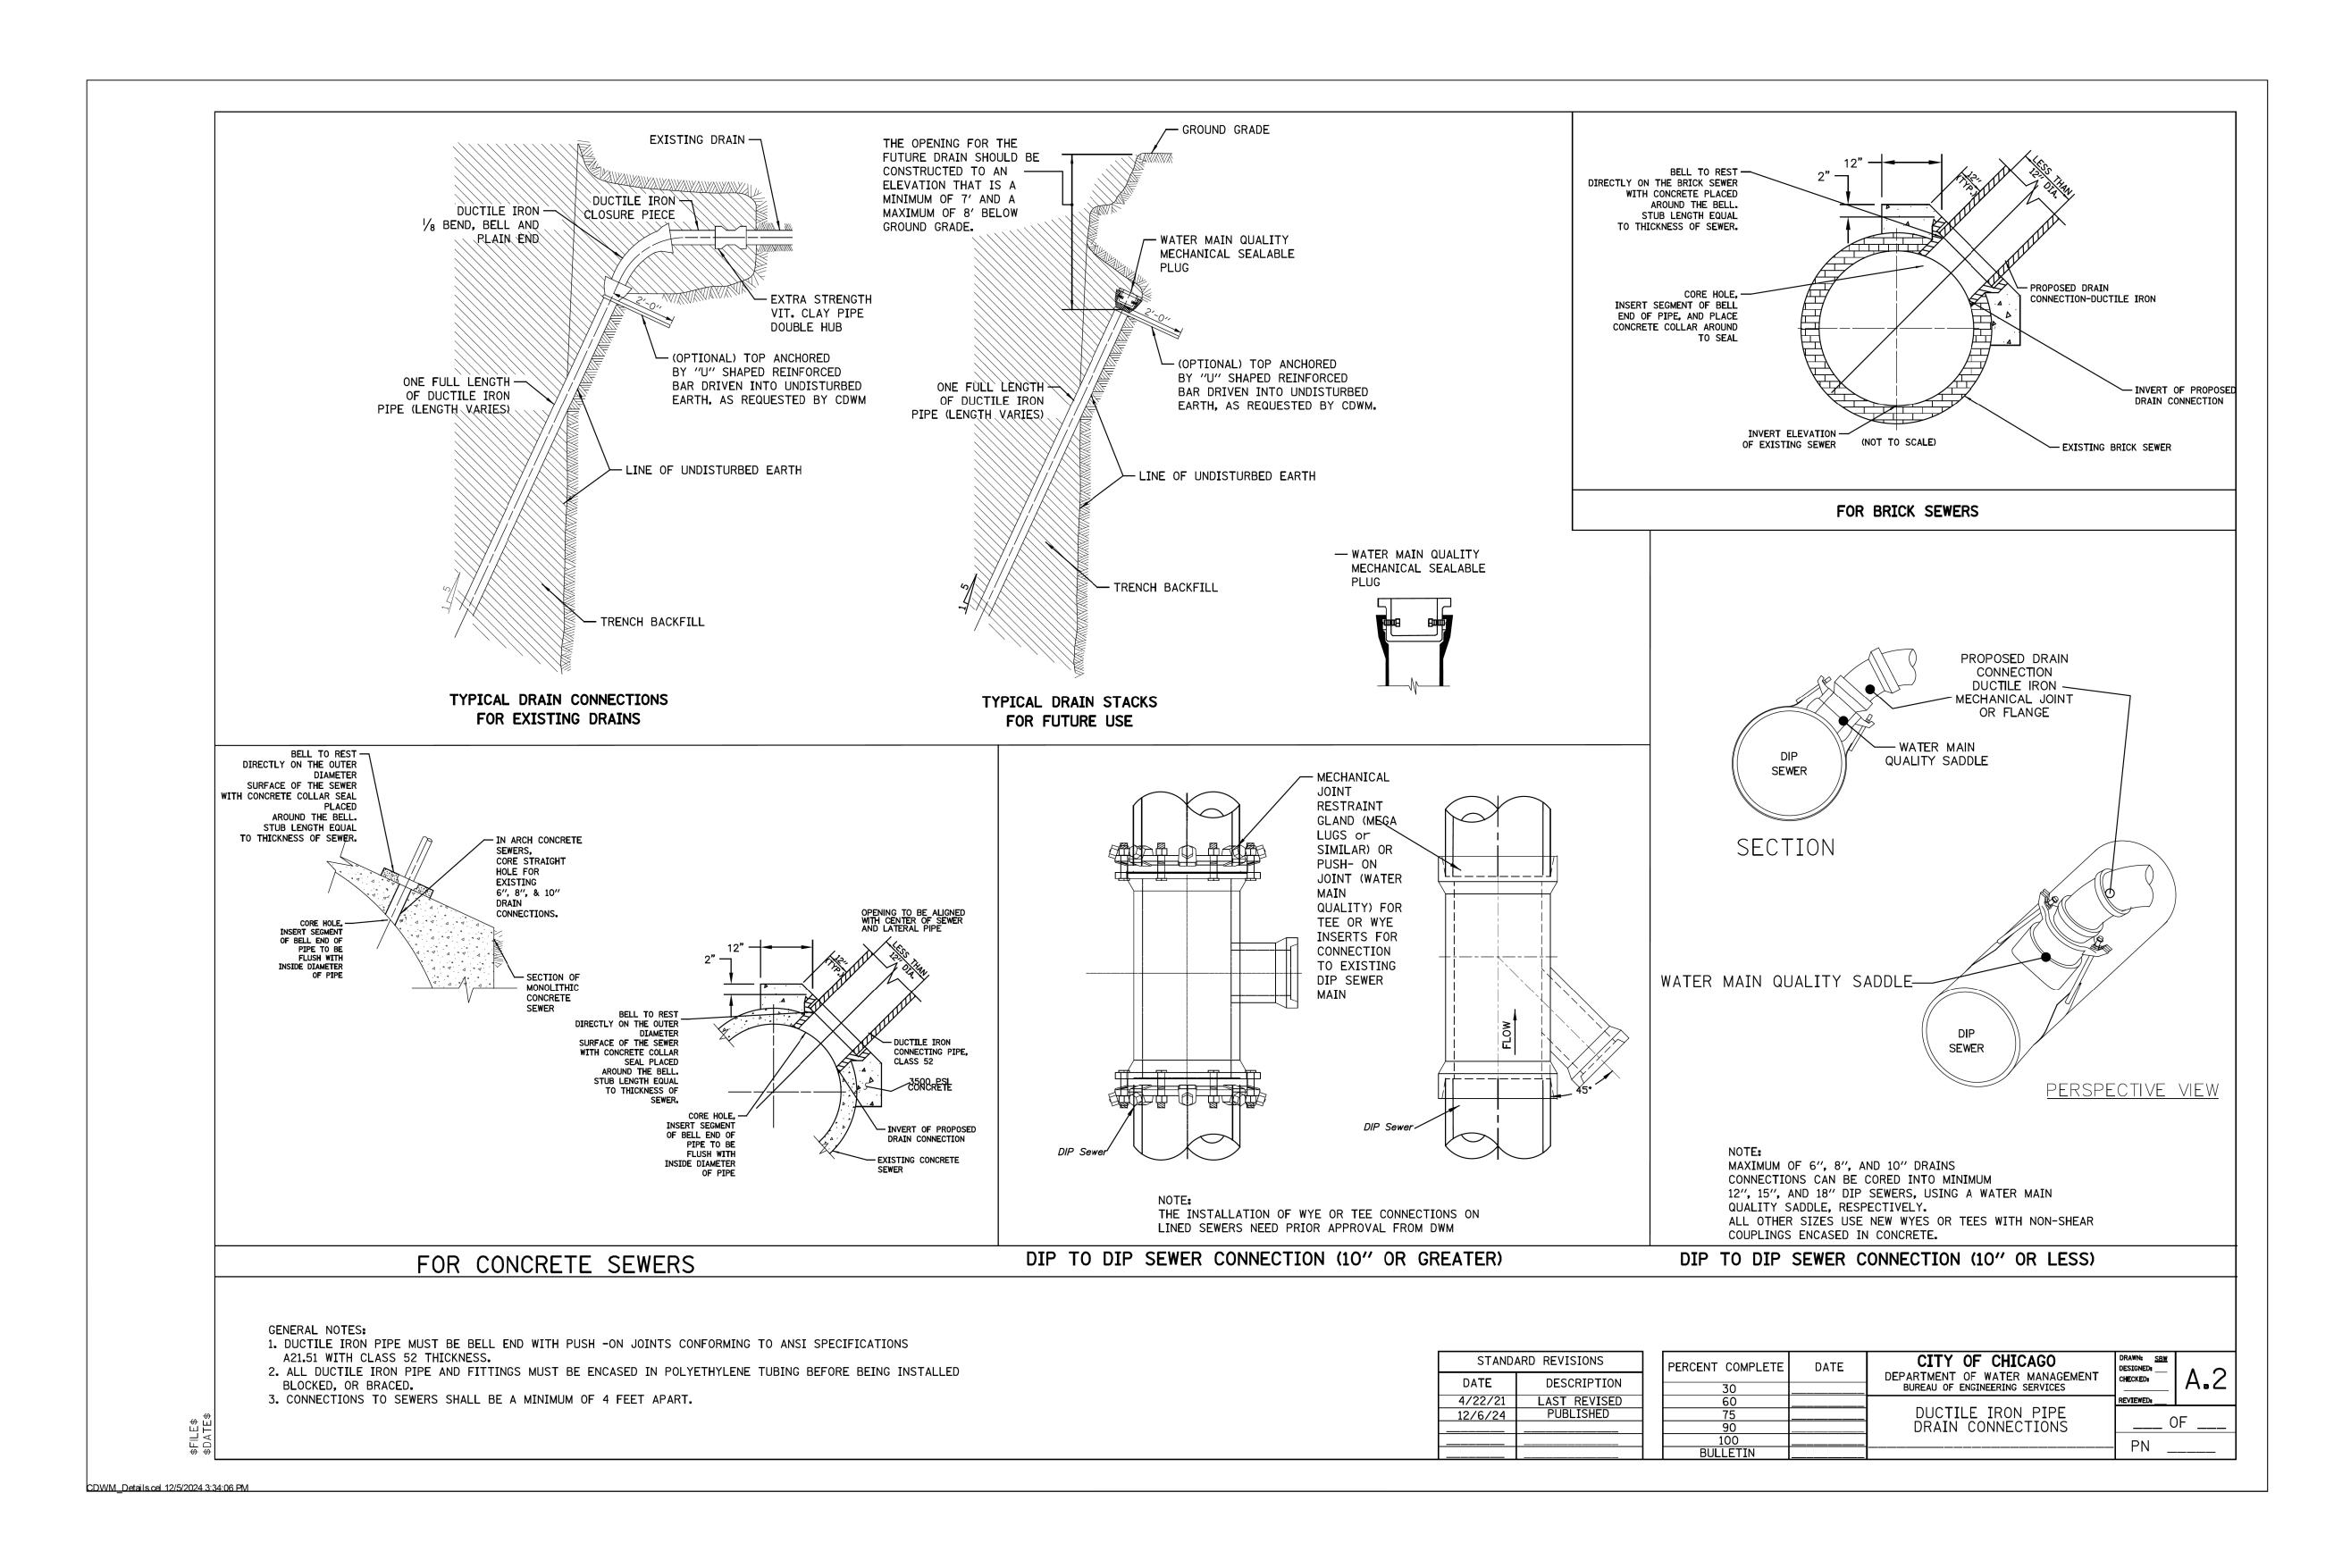




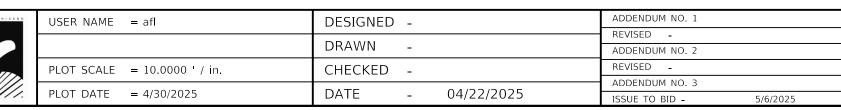


CITY	OF	CHICAGO
DEPARTMENT	OF	TRANSPORTATION

0.00			DETAIL O		F.A. RTE.	SECT	ΓΙΟΝ		COUNTY	TOTAL SHEETS	SHE NC
CD	WM S	EWEK	DETAILS						COOK	50	27
SHEET 8	OF 27	SHEETS	STA.	TO STA.			ILLINOIS	FED. Al	D PROJECT		

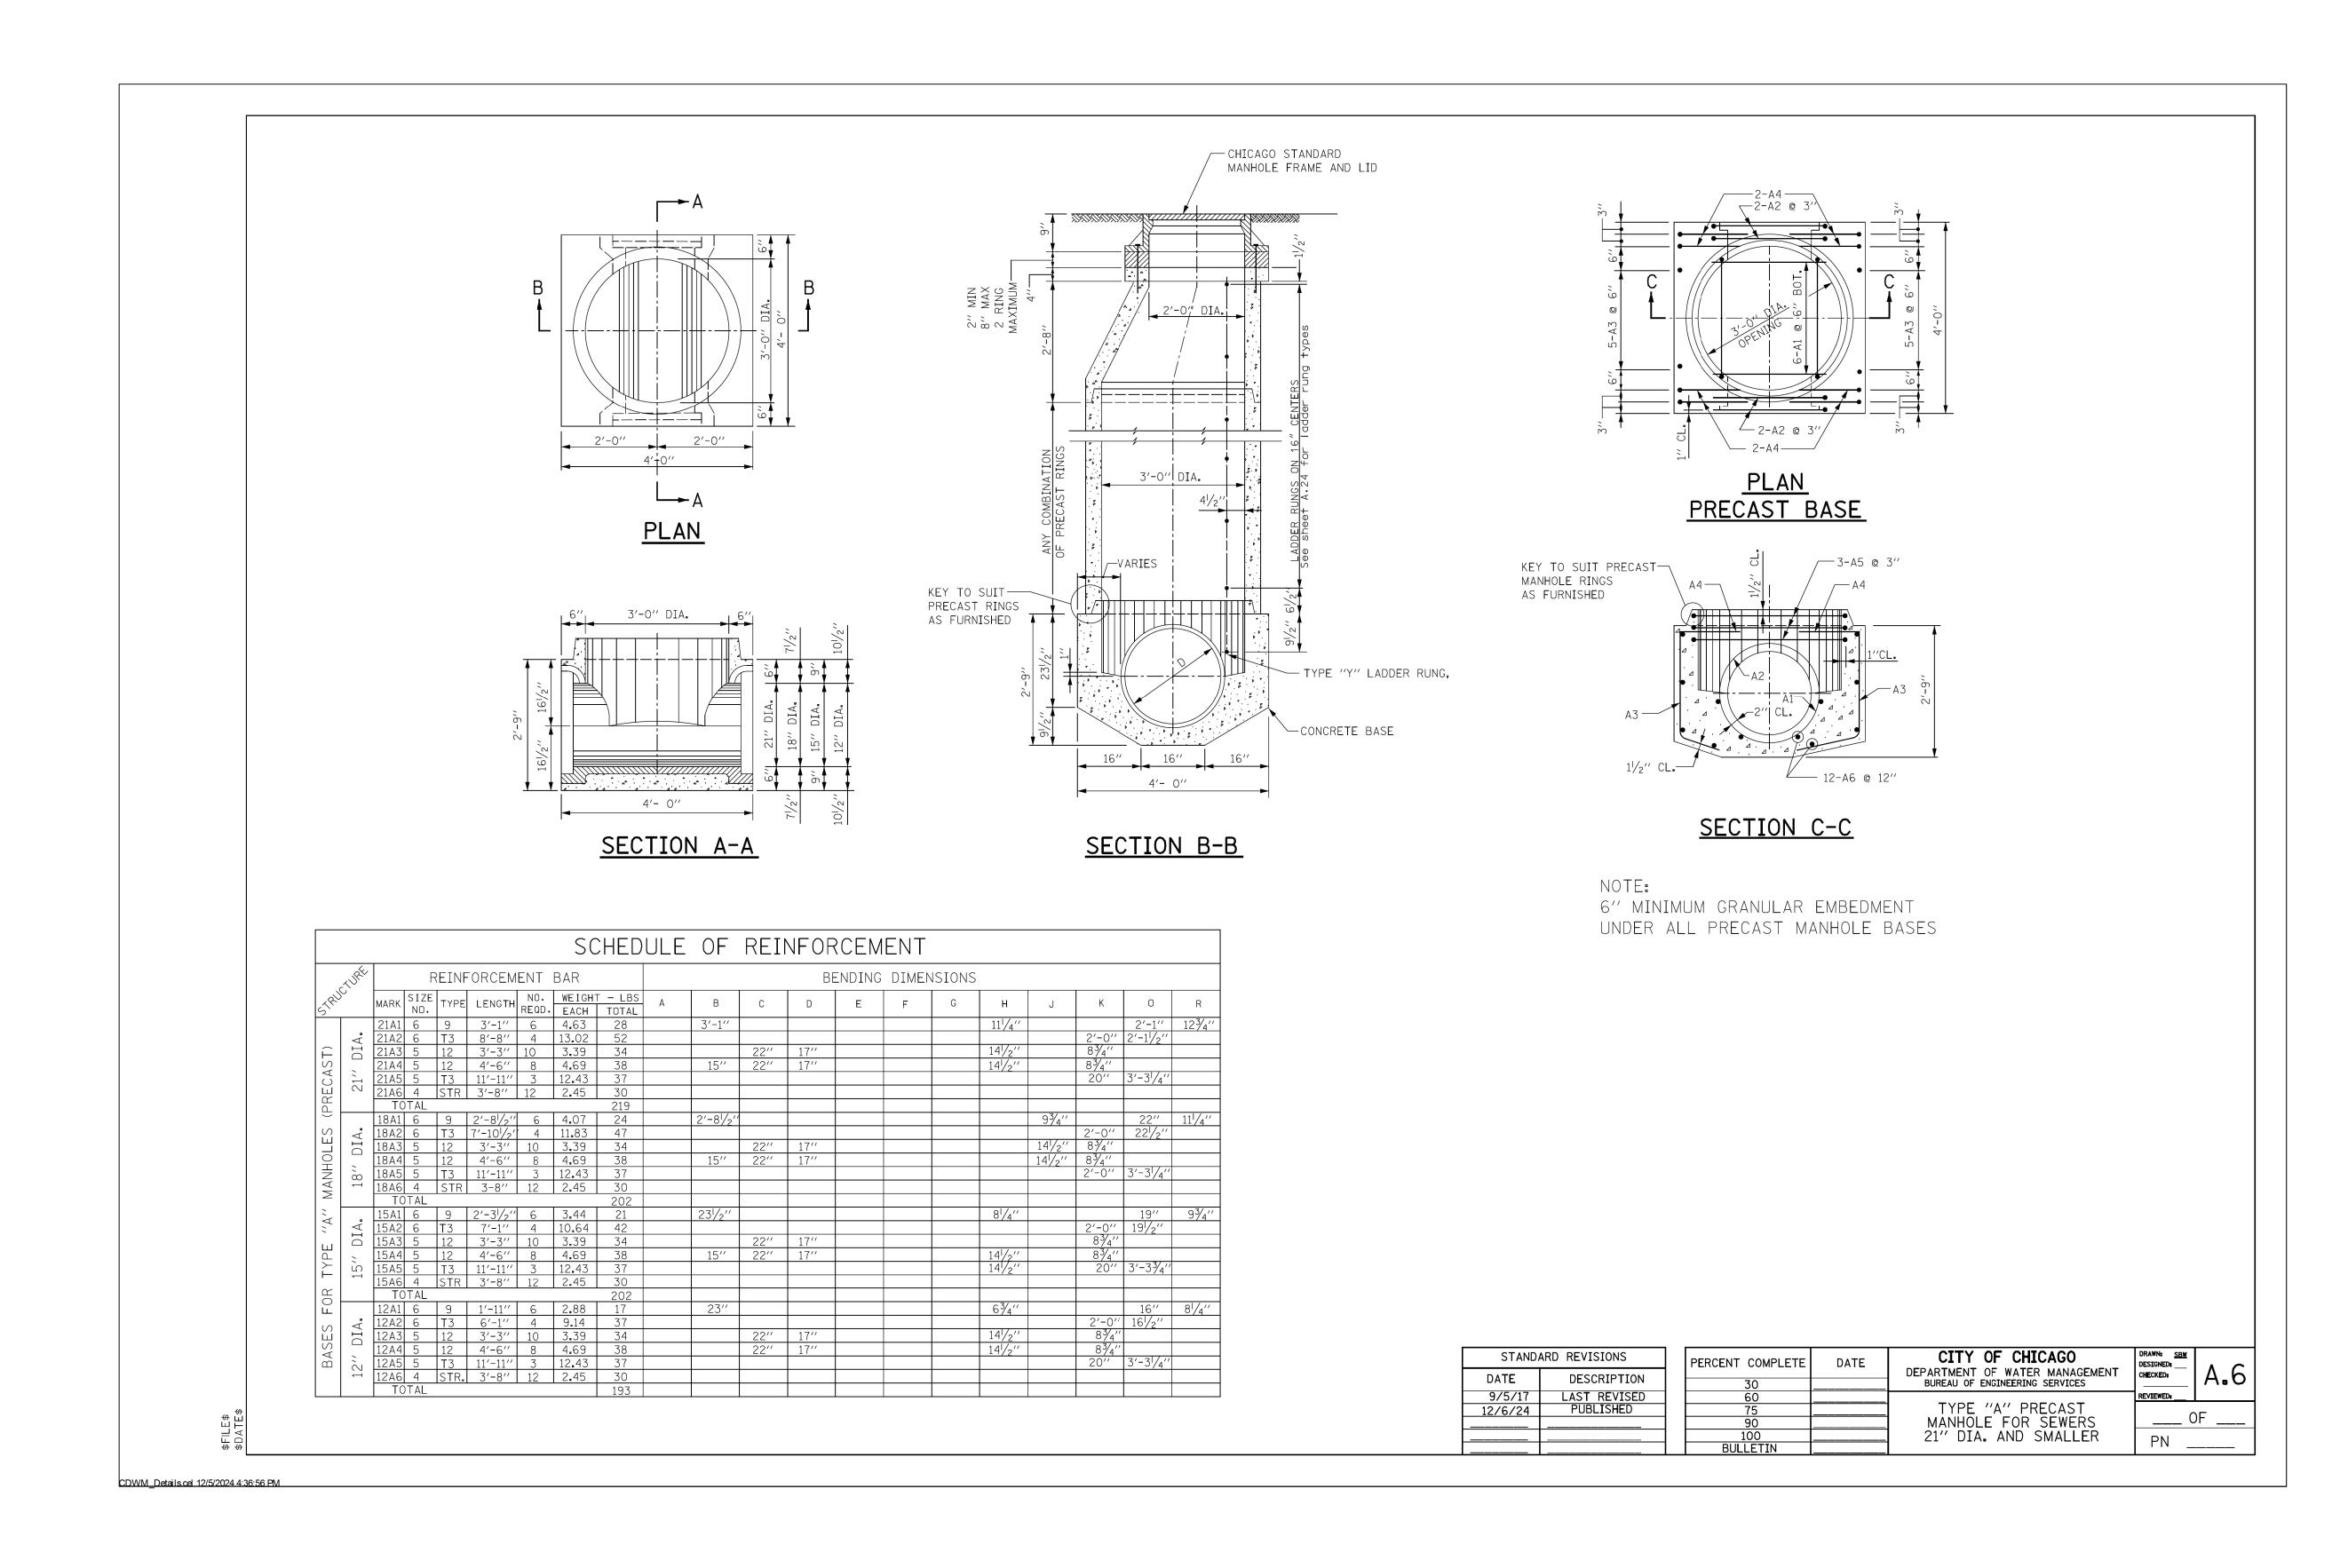




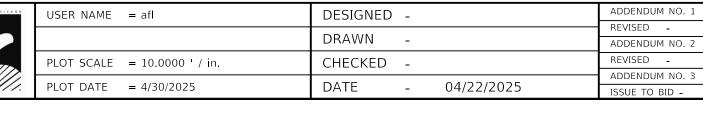

CITY	OF	CHICAGO
DEPARTMENT	OF	TRANSPORTATION

CDIAMA CEIAMED DETAIL C							SECTION		COUNTY	TOTAL SHEETS	
CDWM SEWER DETAILS								СООК	50	28	
	SHEET 9	OF 27	SHEETS	STA.	TO STA.		ILLINOI	S FED. A	ID PROJECT		

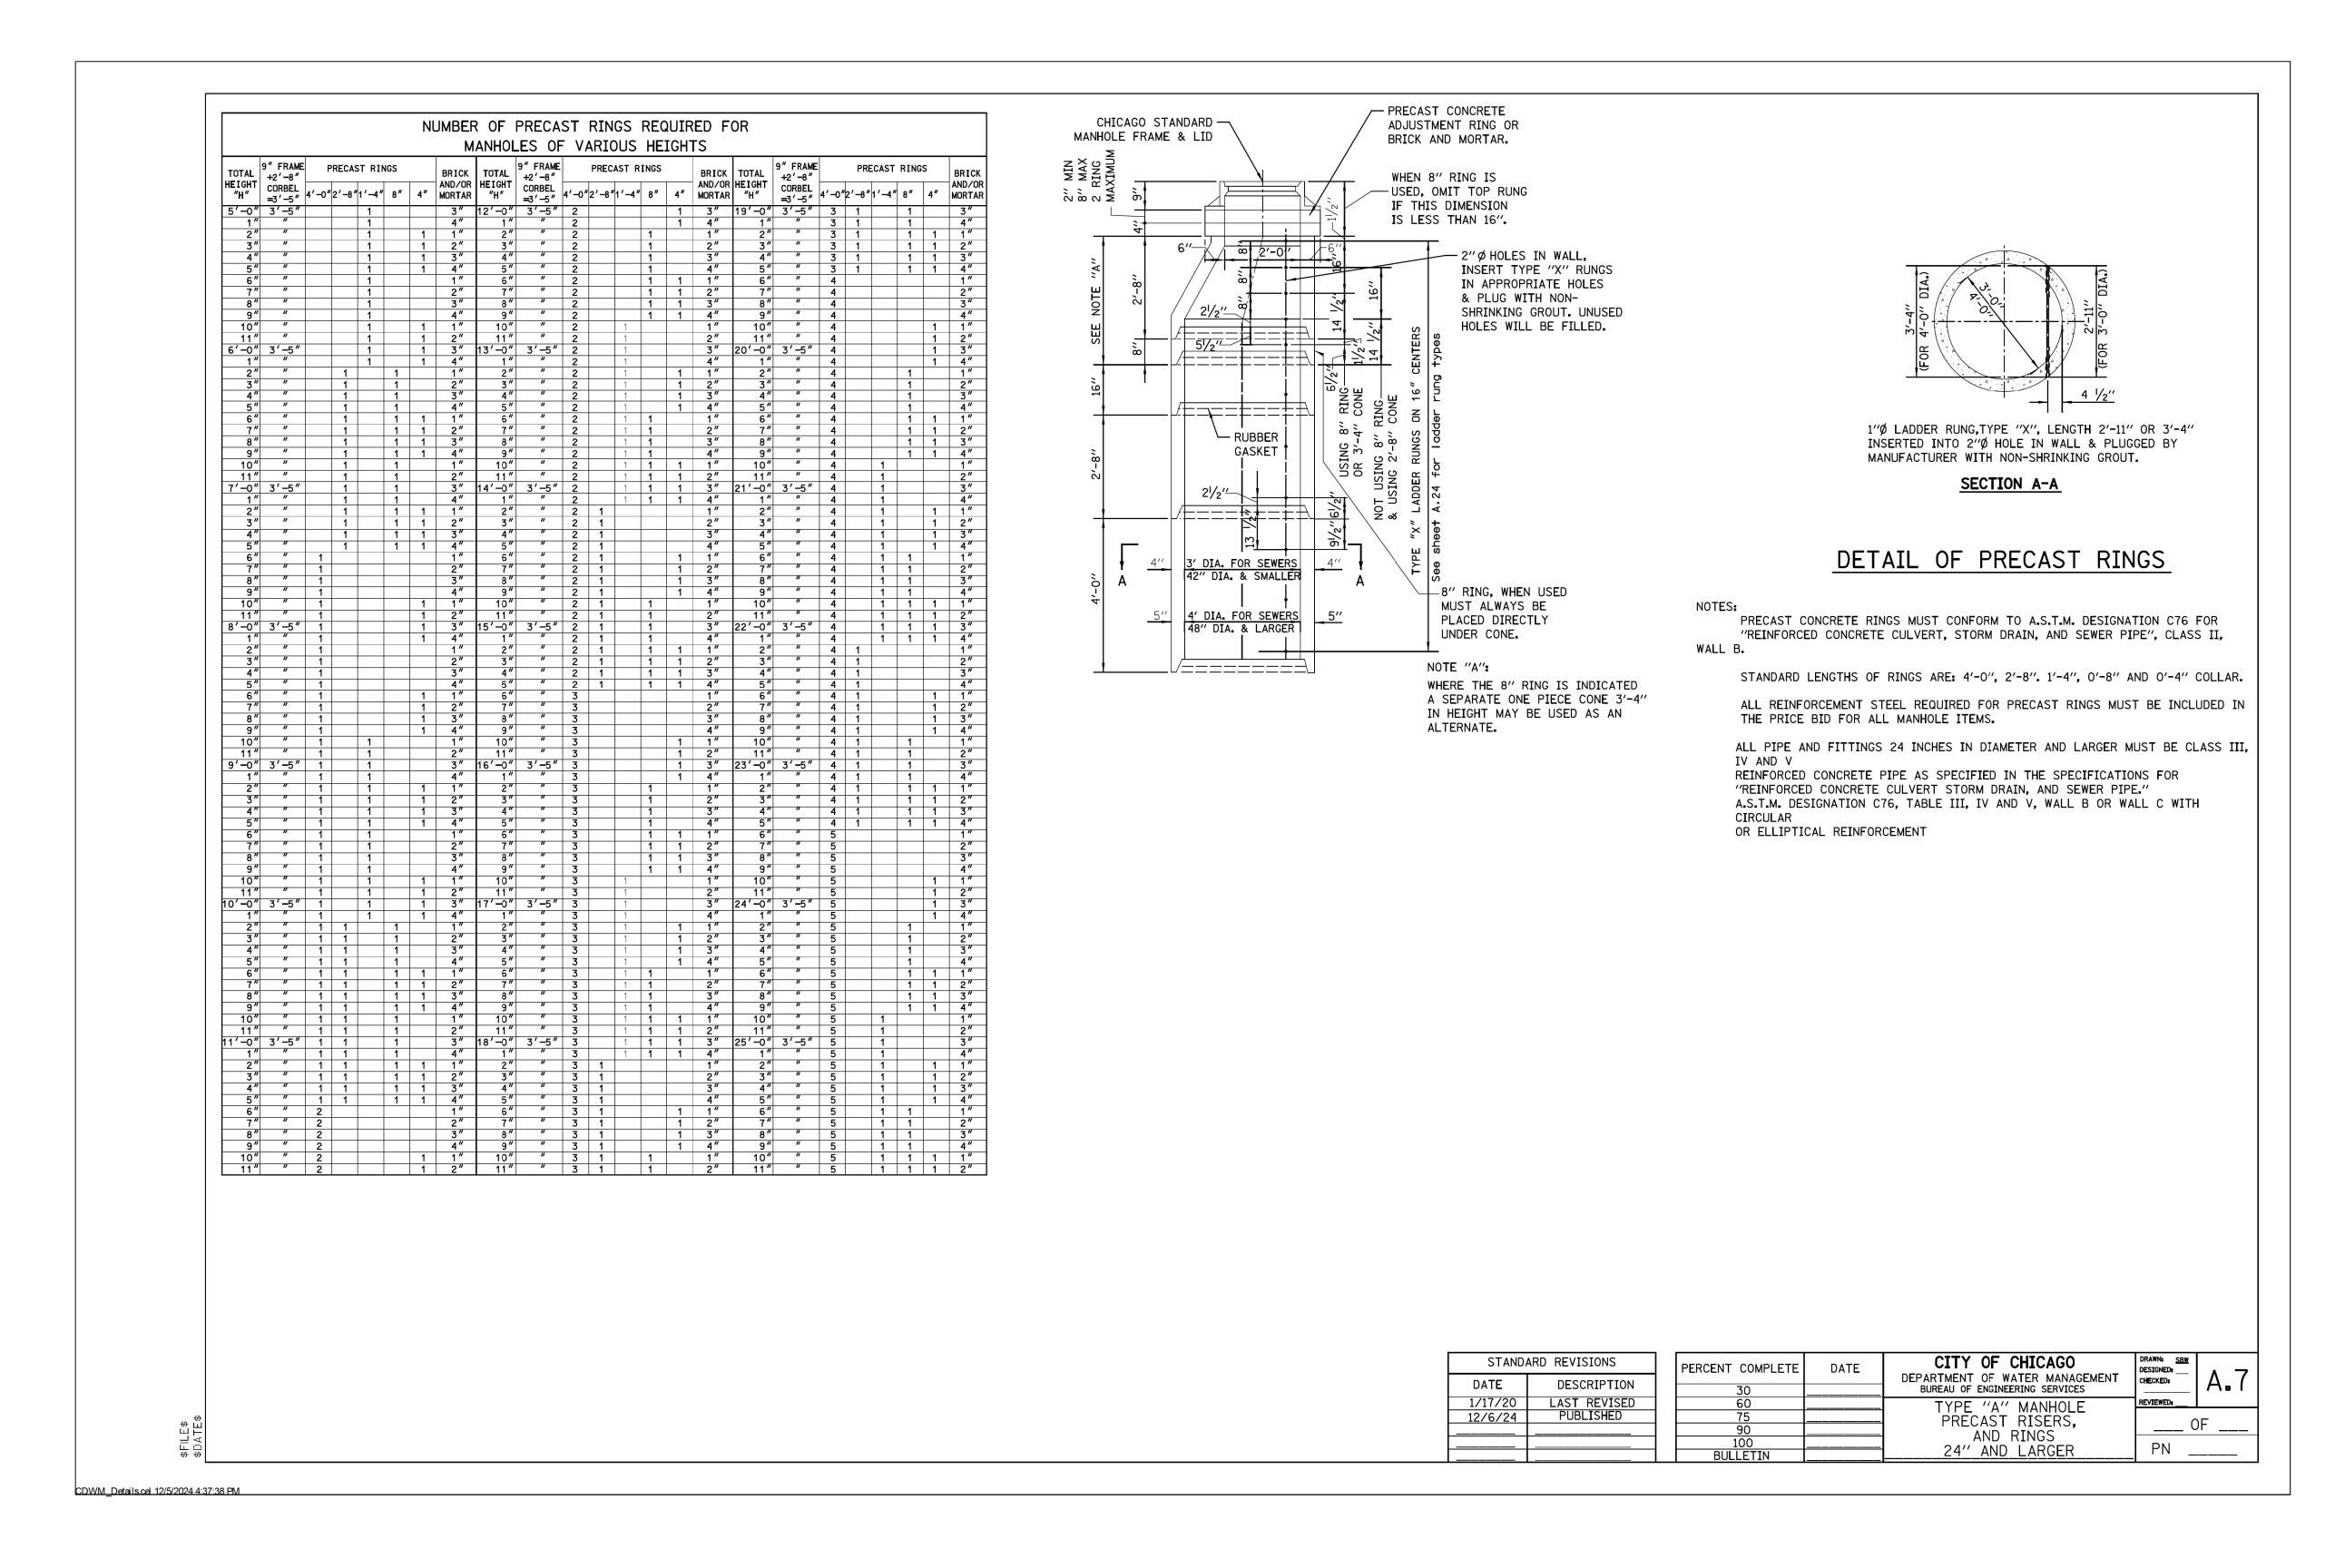

*CDOT

PUBLIC BULLDING COMMESSION


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	DD AMAN	REVISED -		
	DRAWN -	ADDENDUM NO. 2		
PLOT SCALE = 10.0000 ' / in.	CHECKED -	REVISED -		
		ADDENDUM NO. 3		
PLOT DATE = $4/30/2025$	DATE - 04/22/2025	ISSUE TO BID - 5/6/2025		

CITY	OF	CHICAGO
DEPARTMENT	OF	TRANSPORTATION

SCALE:

SHEET 10

				F.A. RTE.	SECTION	COUNTY	TOTAL SHEETS	SHEET NO.	
DWIM	DWM SEWER DETAILS				COOK	50	29		
OF	27	SHEETS	STA.	TO STA.		ILLINOIS FED	. AID PROJECT		

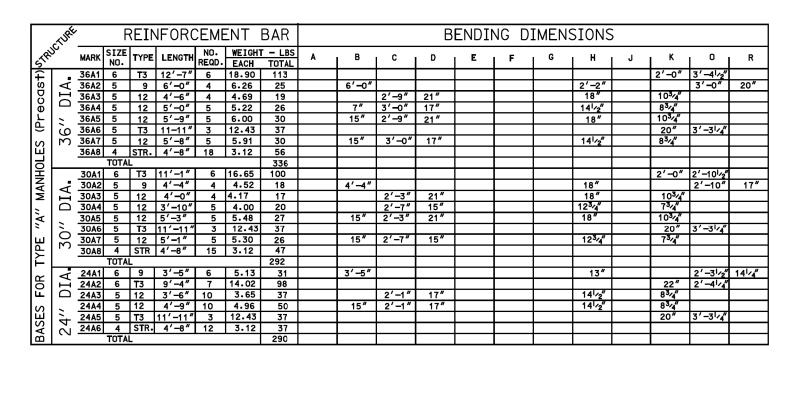

ALL DIMENSIONS ARE OUT TO OUT OF BAR.

BENDING RADII "R" TO OUTSIDE OF BAR. NUMBERS IN CIRCLES DENOTE BAR TYPE.

PLACING OF CONCRETE- CONCRETE MUST BE PLACED IN ACCORDANCE WITH THE METHOD OUTLINED IN THE CITY OF CHICAGO STANDARD SPECIFICATIONS. CONSTRUCTION JOINTS - JOINTS NOT INDICATED ON THE DRAWINGS MUST BE SO MADE AND LOCATED AS NOT TO IMPAIR THE STRENGTH OF THE STRUCTURE AND MUST BE APPROVED BY THE COMMISSIONER. JOINTS MUST BE CONSTRUCTED IN ACCORDANCE WITH THE METHOD OUTLINED IN THE SPECIFICATIONS.

CONCRETE PROTECTION FOR REINFORCEMENT- ALL REINFORCING STEEL MUST HAVE CLEAR CONCRETE COVERING AS FOLLOWS (UNLESS OTHERWISE NOTED): 3" AT EXTERIOR SURFACES WHERE CONCRETE IS DEPOSITED AGAINST THE GROUND; 2.5" AT SURFACES WHERE CONCRETE IS FORMED BUT SUBSEQUENTLY WILL BE IN CONTACT WITH SEWAGE; 2" AT ALL OTHER SURFACES.


REINFORCING STEEL- ALL REINFORCING BARS MUST BE ACCURATELY PLACED AND SECURELY SUPPORTED BY BAR SUPPORTS, SPACERS OR HIGH CHAIRS. ALL LAPS IN REINFORCING STEEL MUST BE BASED UPON THE 1989, ACI BUILDING CODE.

UNLESS OTHERWISE NOTED. HOOKS AND BENDS ON BARS MUST CONFORM TO RECOMMENDED DETAILS AS GIVEN IN THE "MANUAL OF STANDARD PRACTICE", C.R.S.I. 1990.

THE FOLLOWING ABBREVIATIONS ARE USED TO INDICATE THE LOCATION OF REINFORCING

BARS: DENOTES TOP N.F. DENOTES NEAR FACE DENOTES BOTTOM F.F. DENOTES FAR FACE I.F. DENOTES INSIDE FACE E.F. DENOTES EACH FACE DENOTES OUTSIDE FACE E.W. DENOTES EACH WAY

PLACING BAR SUPPORTS- ALL REINFORCING BARS MUST BE SUPPORTED, ANCHORED AND TIED AND MUST CONFORM TO THE "RECOMMENDED PRACTICE FOR PLACING REINFORCING BARS", 1986, PREPARED BY THE CONCRETE REINFORCING STEEL INSTITUTE.

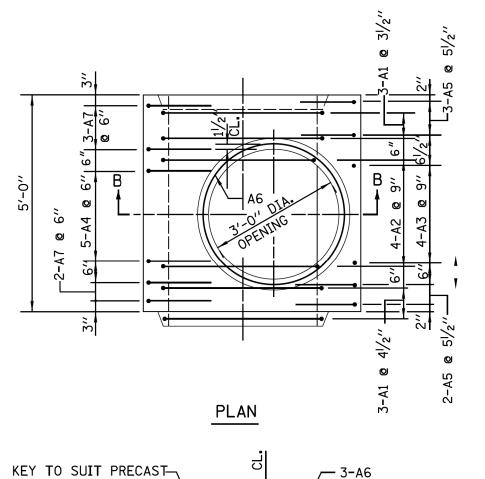



SECTION B-B


MANHOLE BASE FOR


36" DIA. SEWERS


MANHOLE RINGS AS FURNISHED

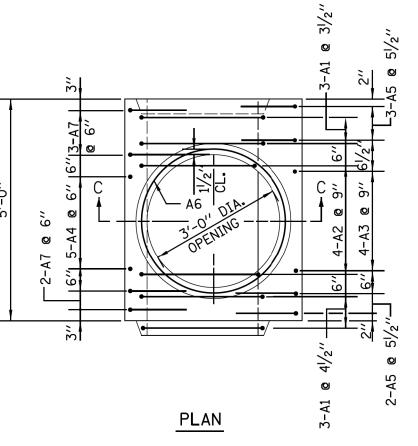

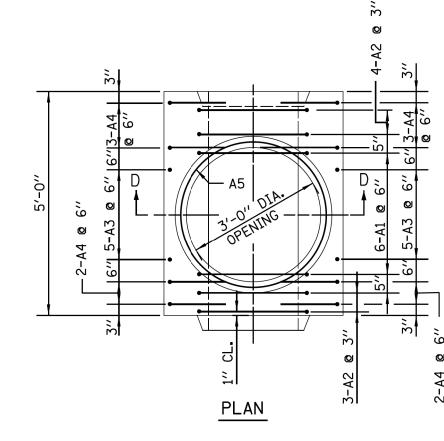

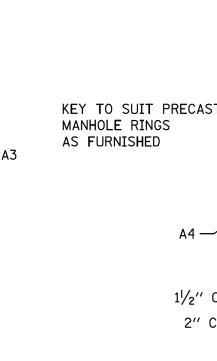

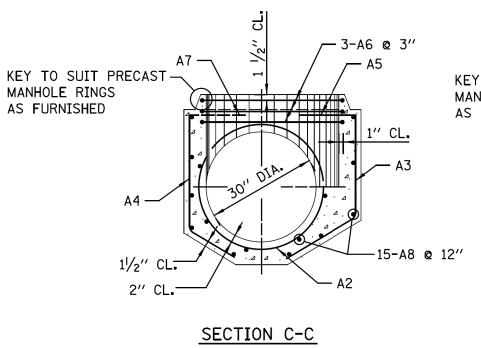

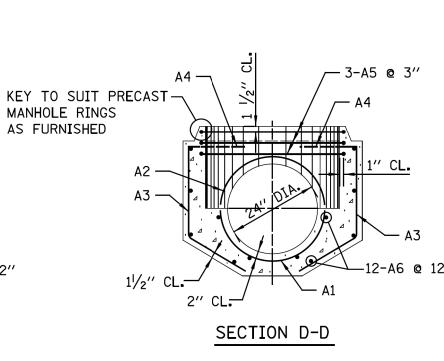

MANHOLE BASE FOR 30" DIA. SEWERS

MANHOLE BASE FOR 24" DIA. SEWERS

STAND	ARD REVISIONS
DATE	DESCRIPTION
2/23/17	LAST REVISED
12/6/24	PUBLISHED

SCALE:

	PERCENT COMPLETE	DATE	CITY OF CHICAGO DEPARTMENT OF WATER MANAGEMENT BUREAU OF ENGINEERING SERVICES	DRAWN: SI DESIGNED: CHECKED:
	60			REVIEWED:
	75		REINFORCEMENT FOR TYPE "A"	
	90		PRECAST BASES AND RINGS	
	100		24" to 36"	PN
	BULLETIN			1 17


CDWM_Details.cel 12/5/2024 4:38:10 PM





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	DRAWN -		REVISED -		
			ADDENDUM NO. 2		
PLOT SCALE = 10.0000 ' / in.	10.0000 ' / in.				
	D.4.T.E.	0.4.(2.2.(2.0.2.5	ADDENDUM NO. 3		
PLOT DATE = $4/30/2025$	DATE -	04/22/2025	ISSUE TO BID -	5/6/2025	

				F.A. RTE.	SECT	ΓΙΟΝ		COUNTY	TOTAL SHEETS		
CDWM SEWER DETAILS							COOK	50	30		
	_										
	SHEET 11	OF 27	SHEETS STA.	TO STA.			ILLINOIS	FED. AI	D PROJECT		

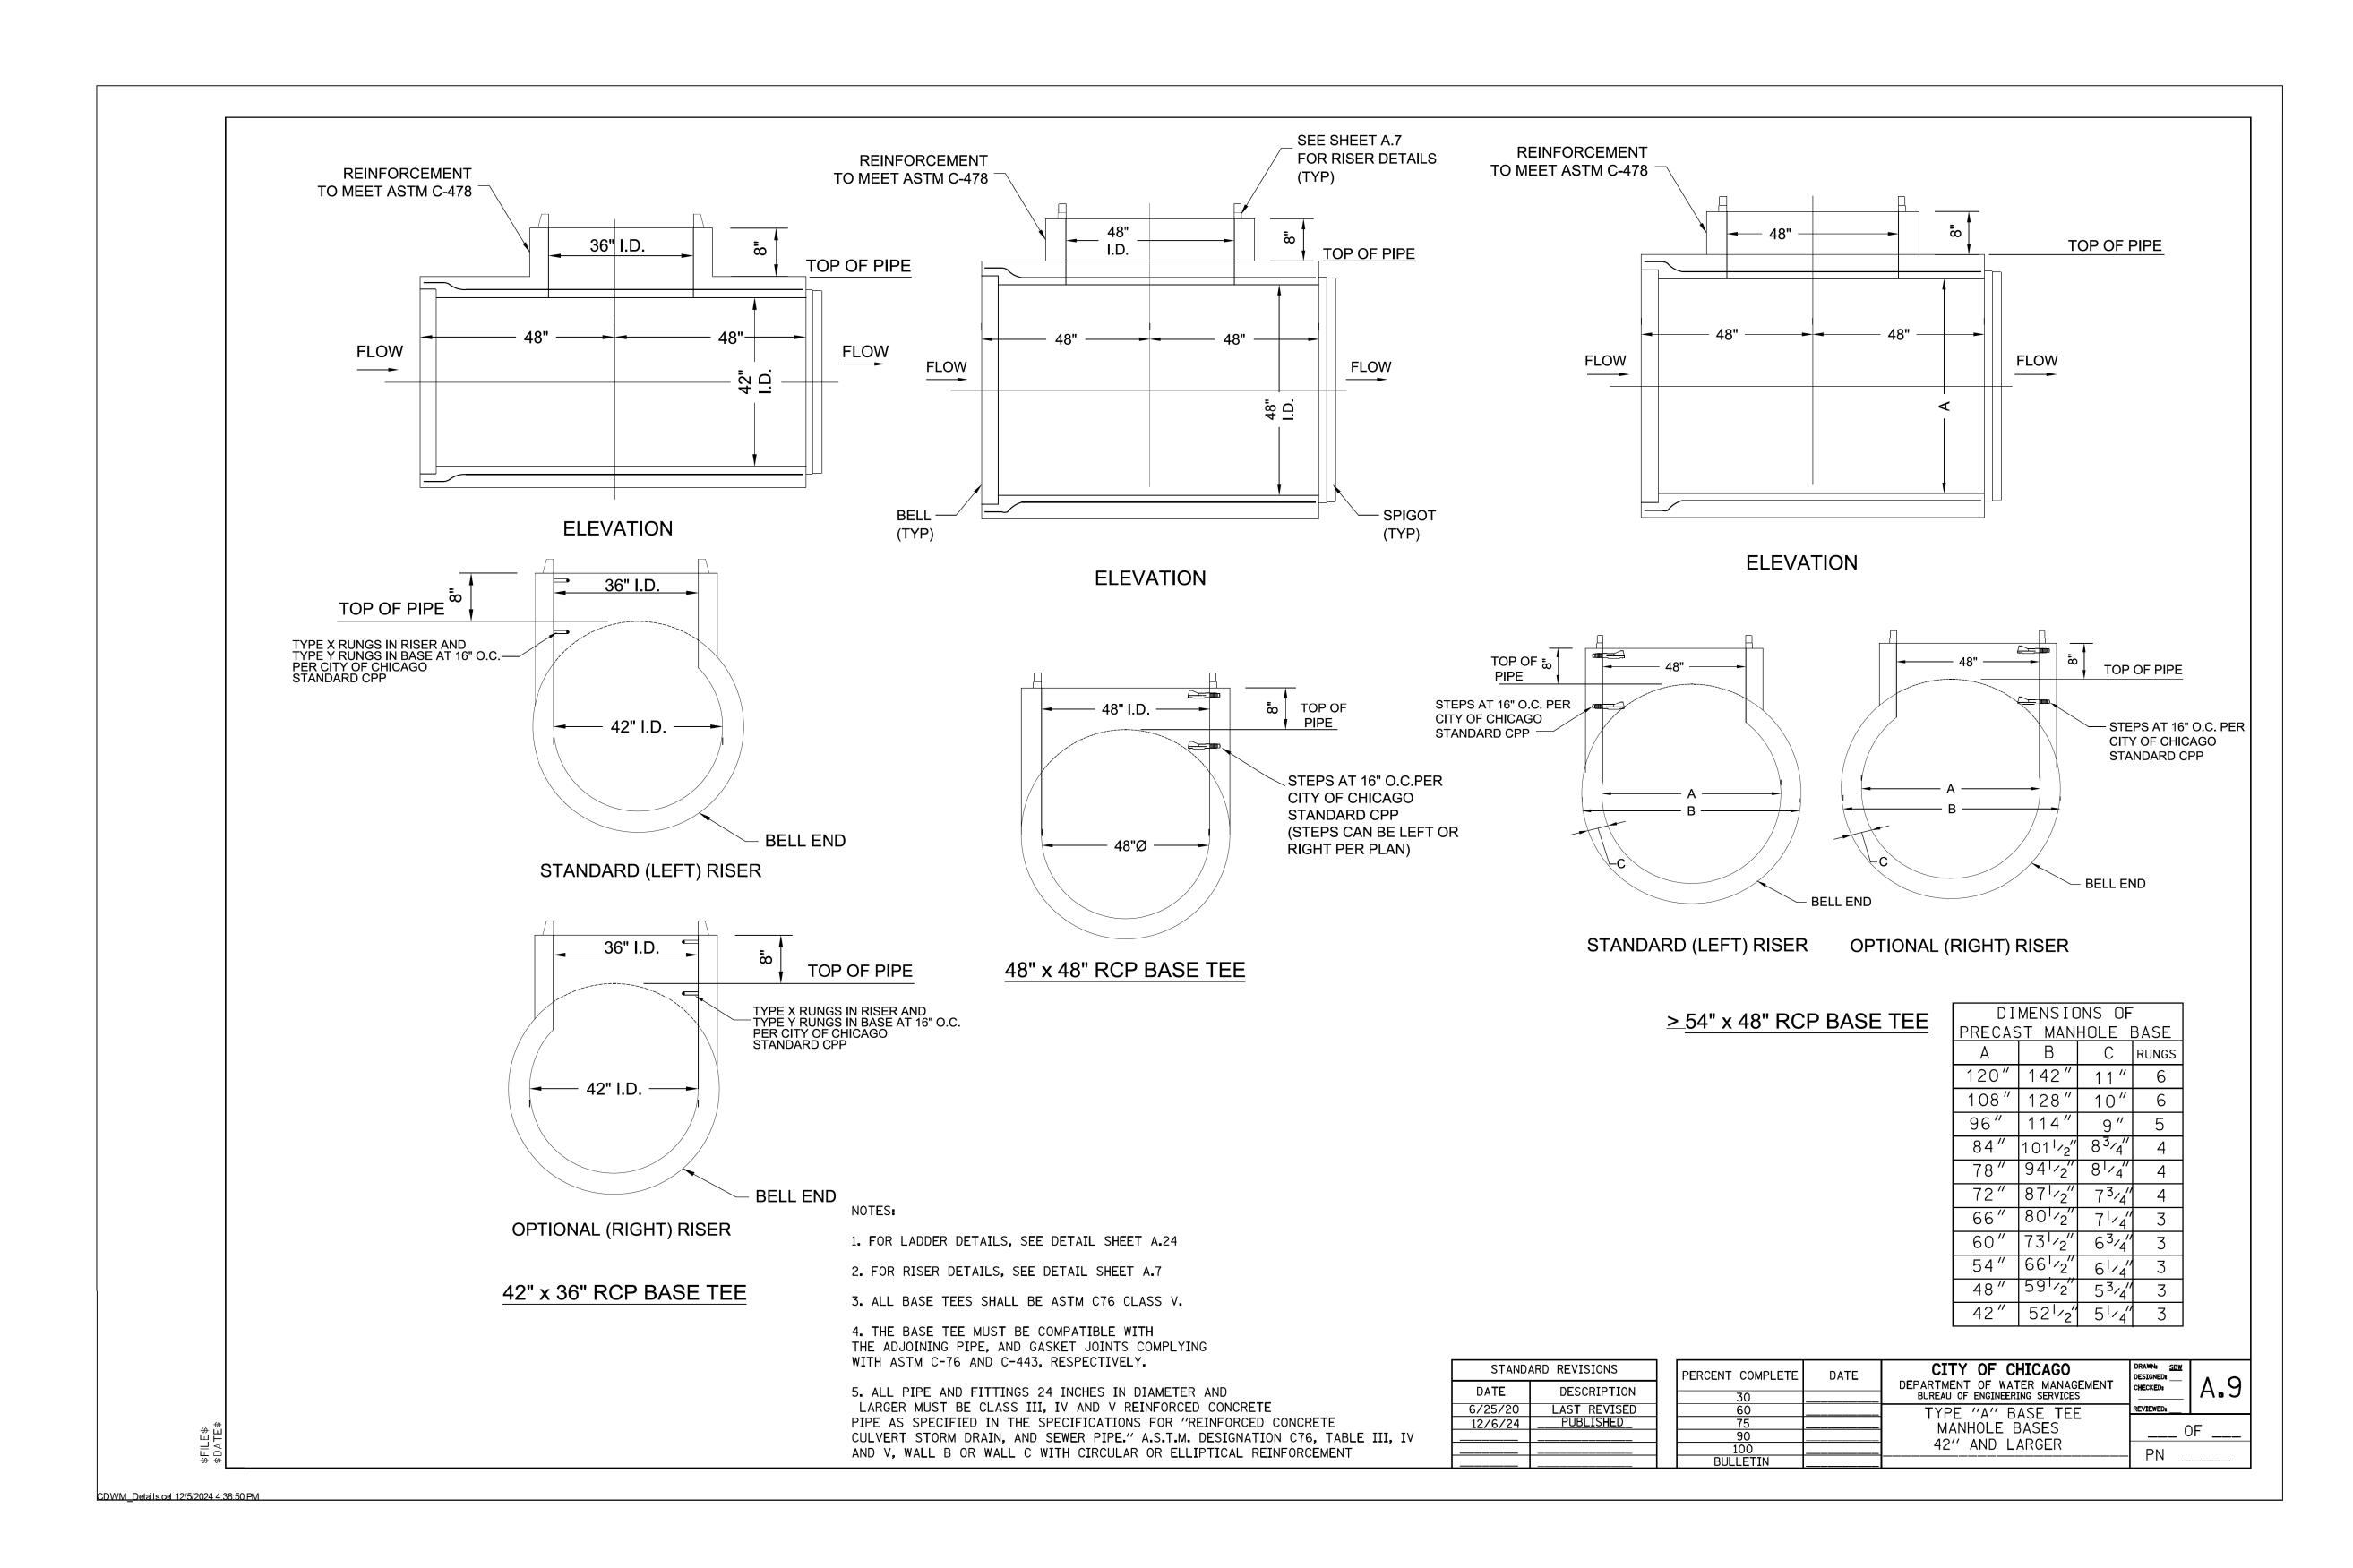




CAGO	USER NAME = afl	DESIGNED -	ADDENDUM NO. 1		
		DD AMAI	REVISED -		
		DRAWN -	ADDENDUM NO. 2		
	PLOT SCALE = $10.0000 '$ / in.	CHECKED -	REVISED -		
		DATE 04/22/2025	ADDENDUM NO. 3		
//.	PLOT DATE = $4/30/2025$	DATE - 04/22/2025	ISSUE TO BID - 5/6/2025		

CITY	OF	CHICAGO
DEPARTMENT	OF	TRANSPORTATION

						F.A. RTE.	SEC ⁻	TION		COUNTY	TOTAL SHEETS	SHEE NO.
CDWM SEWER DETAILS								COOK	50	31		
	T											
	SHEET 12	OF 27	SHEETS	STA.	TO STA.			ILLINOIS	FED. A	ID PROJECT		

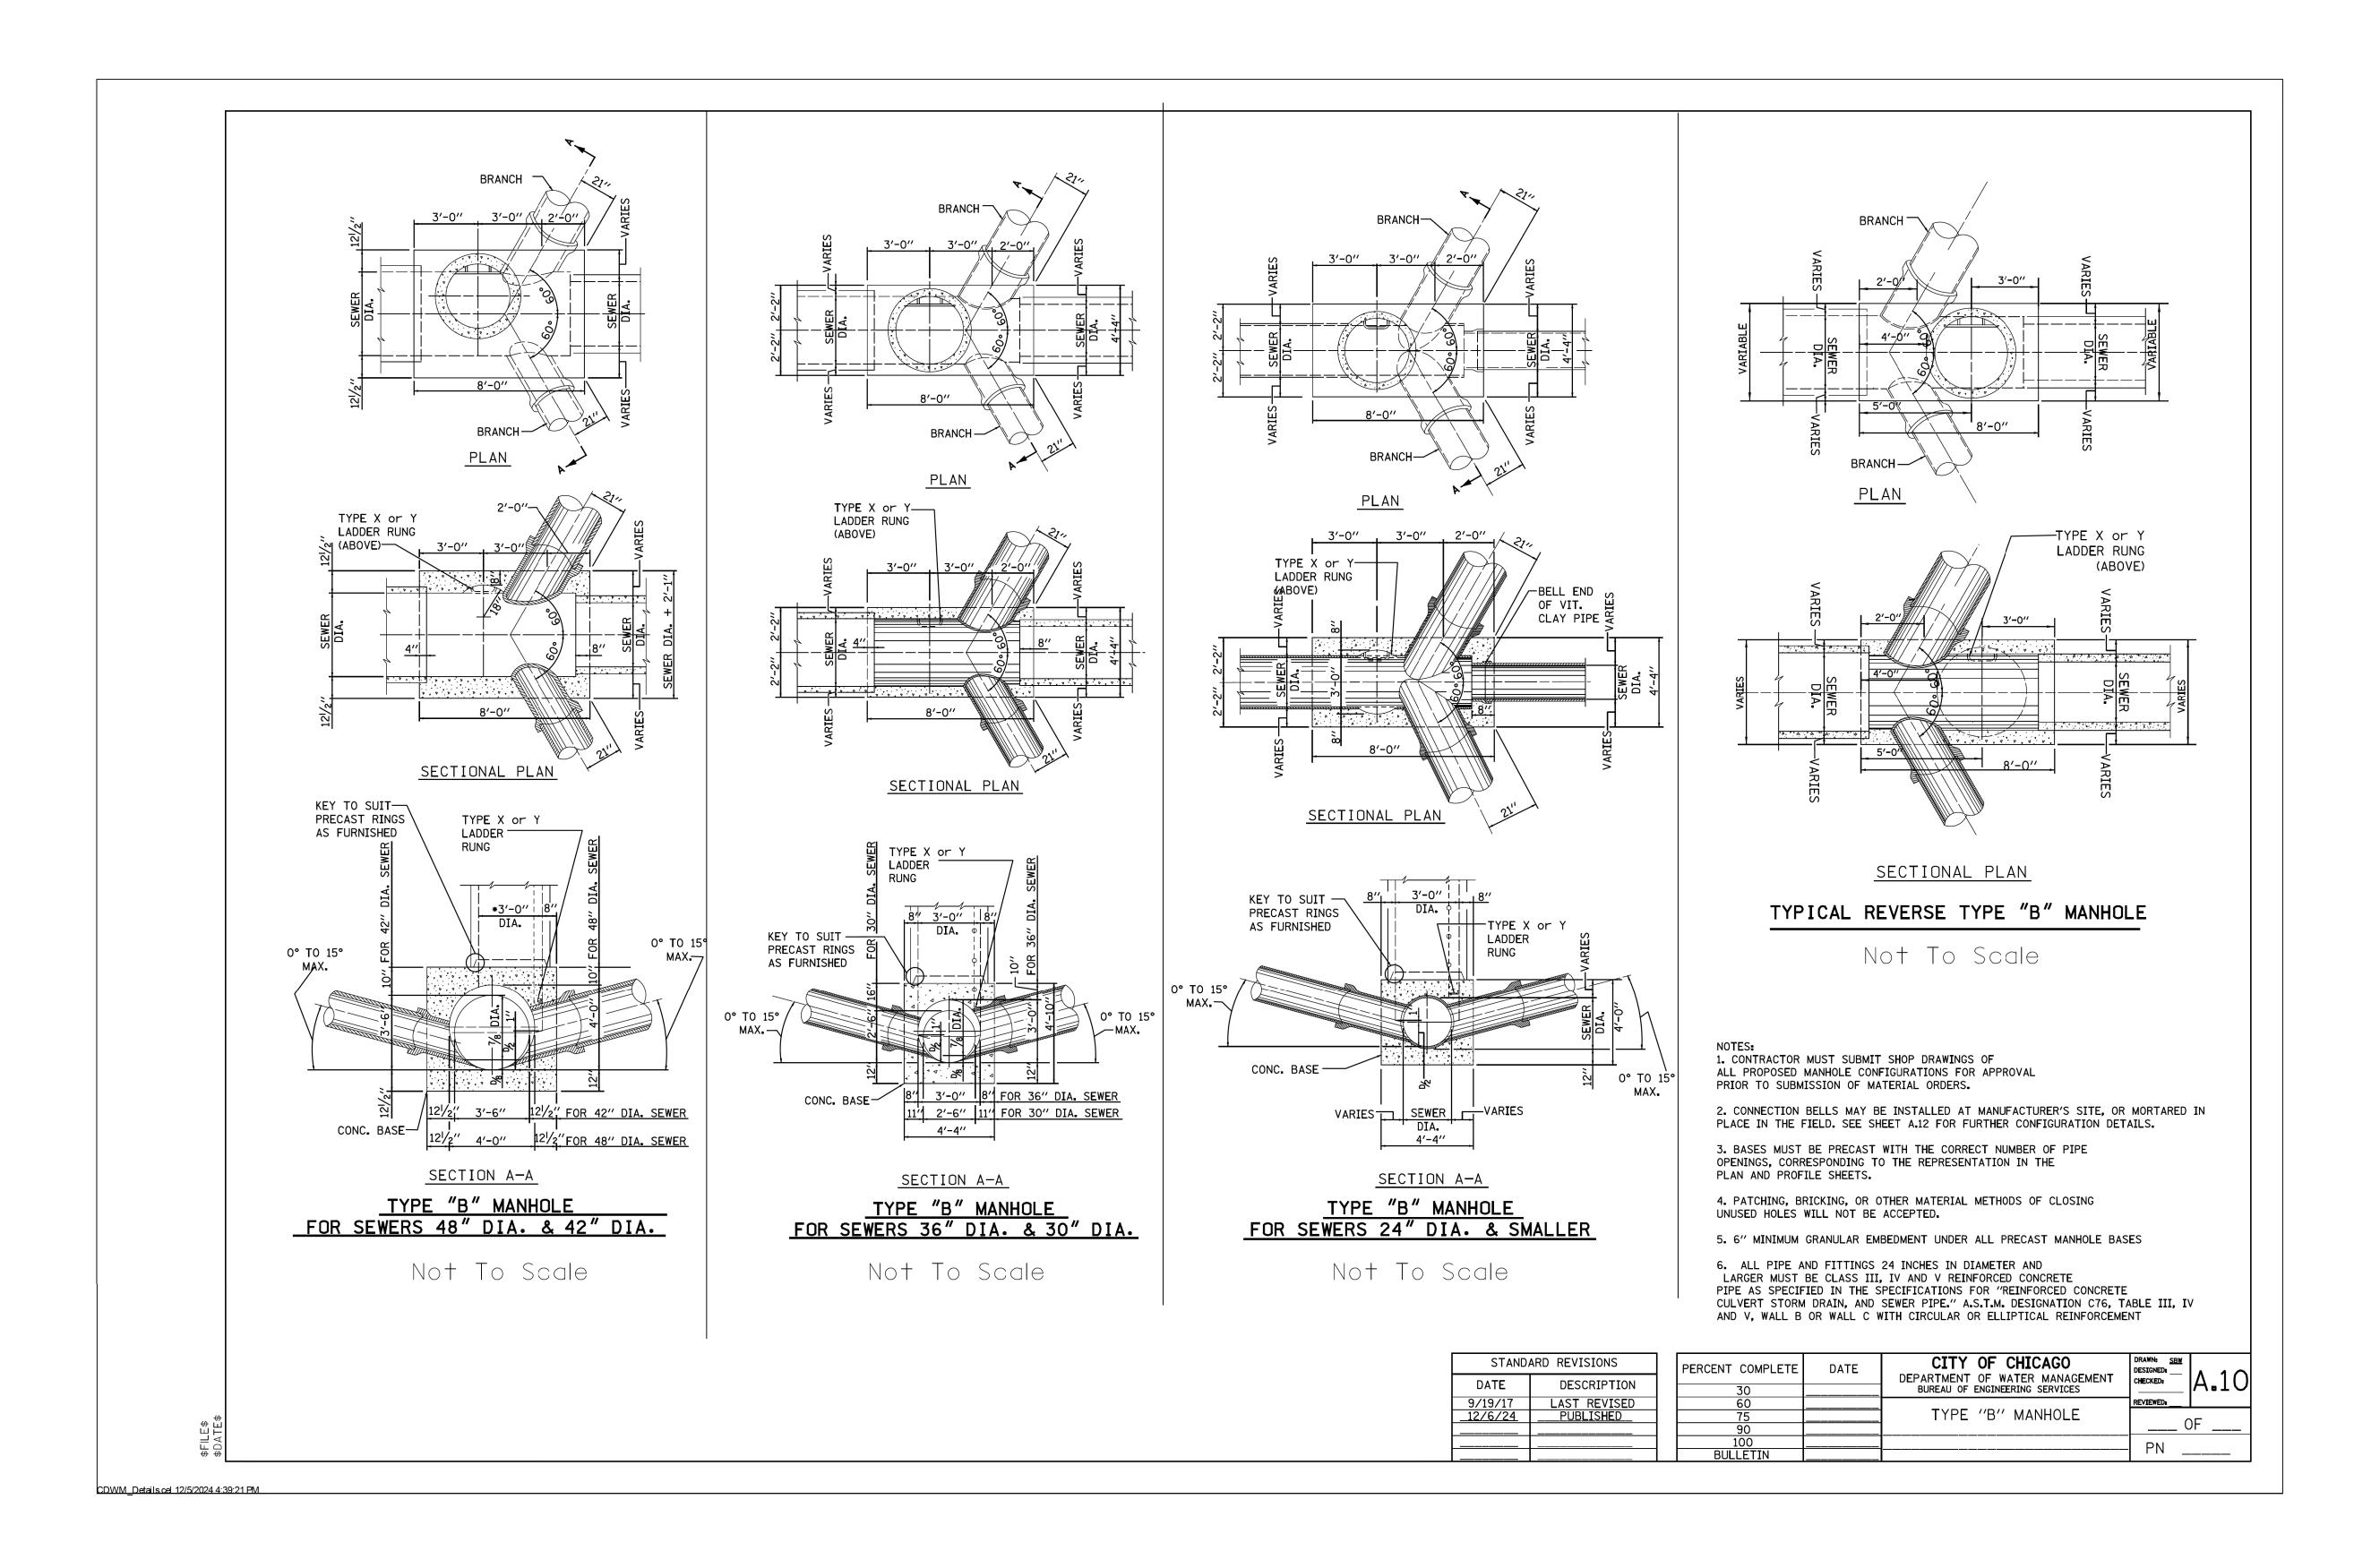




0 0	USER NAME = afl	DESIGNED -	ADDENDUM NO. 1		
		DDAMAI	REVISED -		
		DRAWN -	ADDENDUM NO. 2		
	PLOT SCALE = $10.0000 '$ / in.	CHECKED -	REVISED -		
		DATE 04/22/2025	ADDENDUM NO. 3		
<i>'</i> .	PLOT DATE = $4/30/2025$	DATE - 04/22/2025	ISSUE TO BID - 5/6/2025		

CITY OF CHICAGO
DEPARTMENT OF TRANSPORTATION

			DET 411 0		F.A. RTE.	SECTION	COUNTY	TOTAL SHEETS	SHEET NO.
CDWM SEWER DETAILS							СООК	50	32
T									
SHEET 13	OF 27	SHEETS	STA.	TO STA.		ILLINOIS FED. A	ID PROJECT		

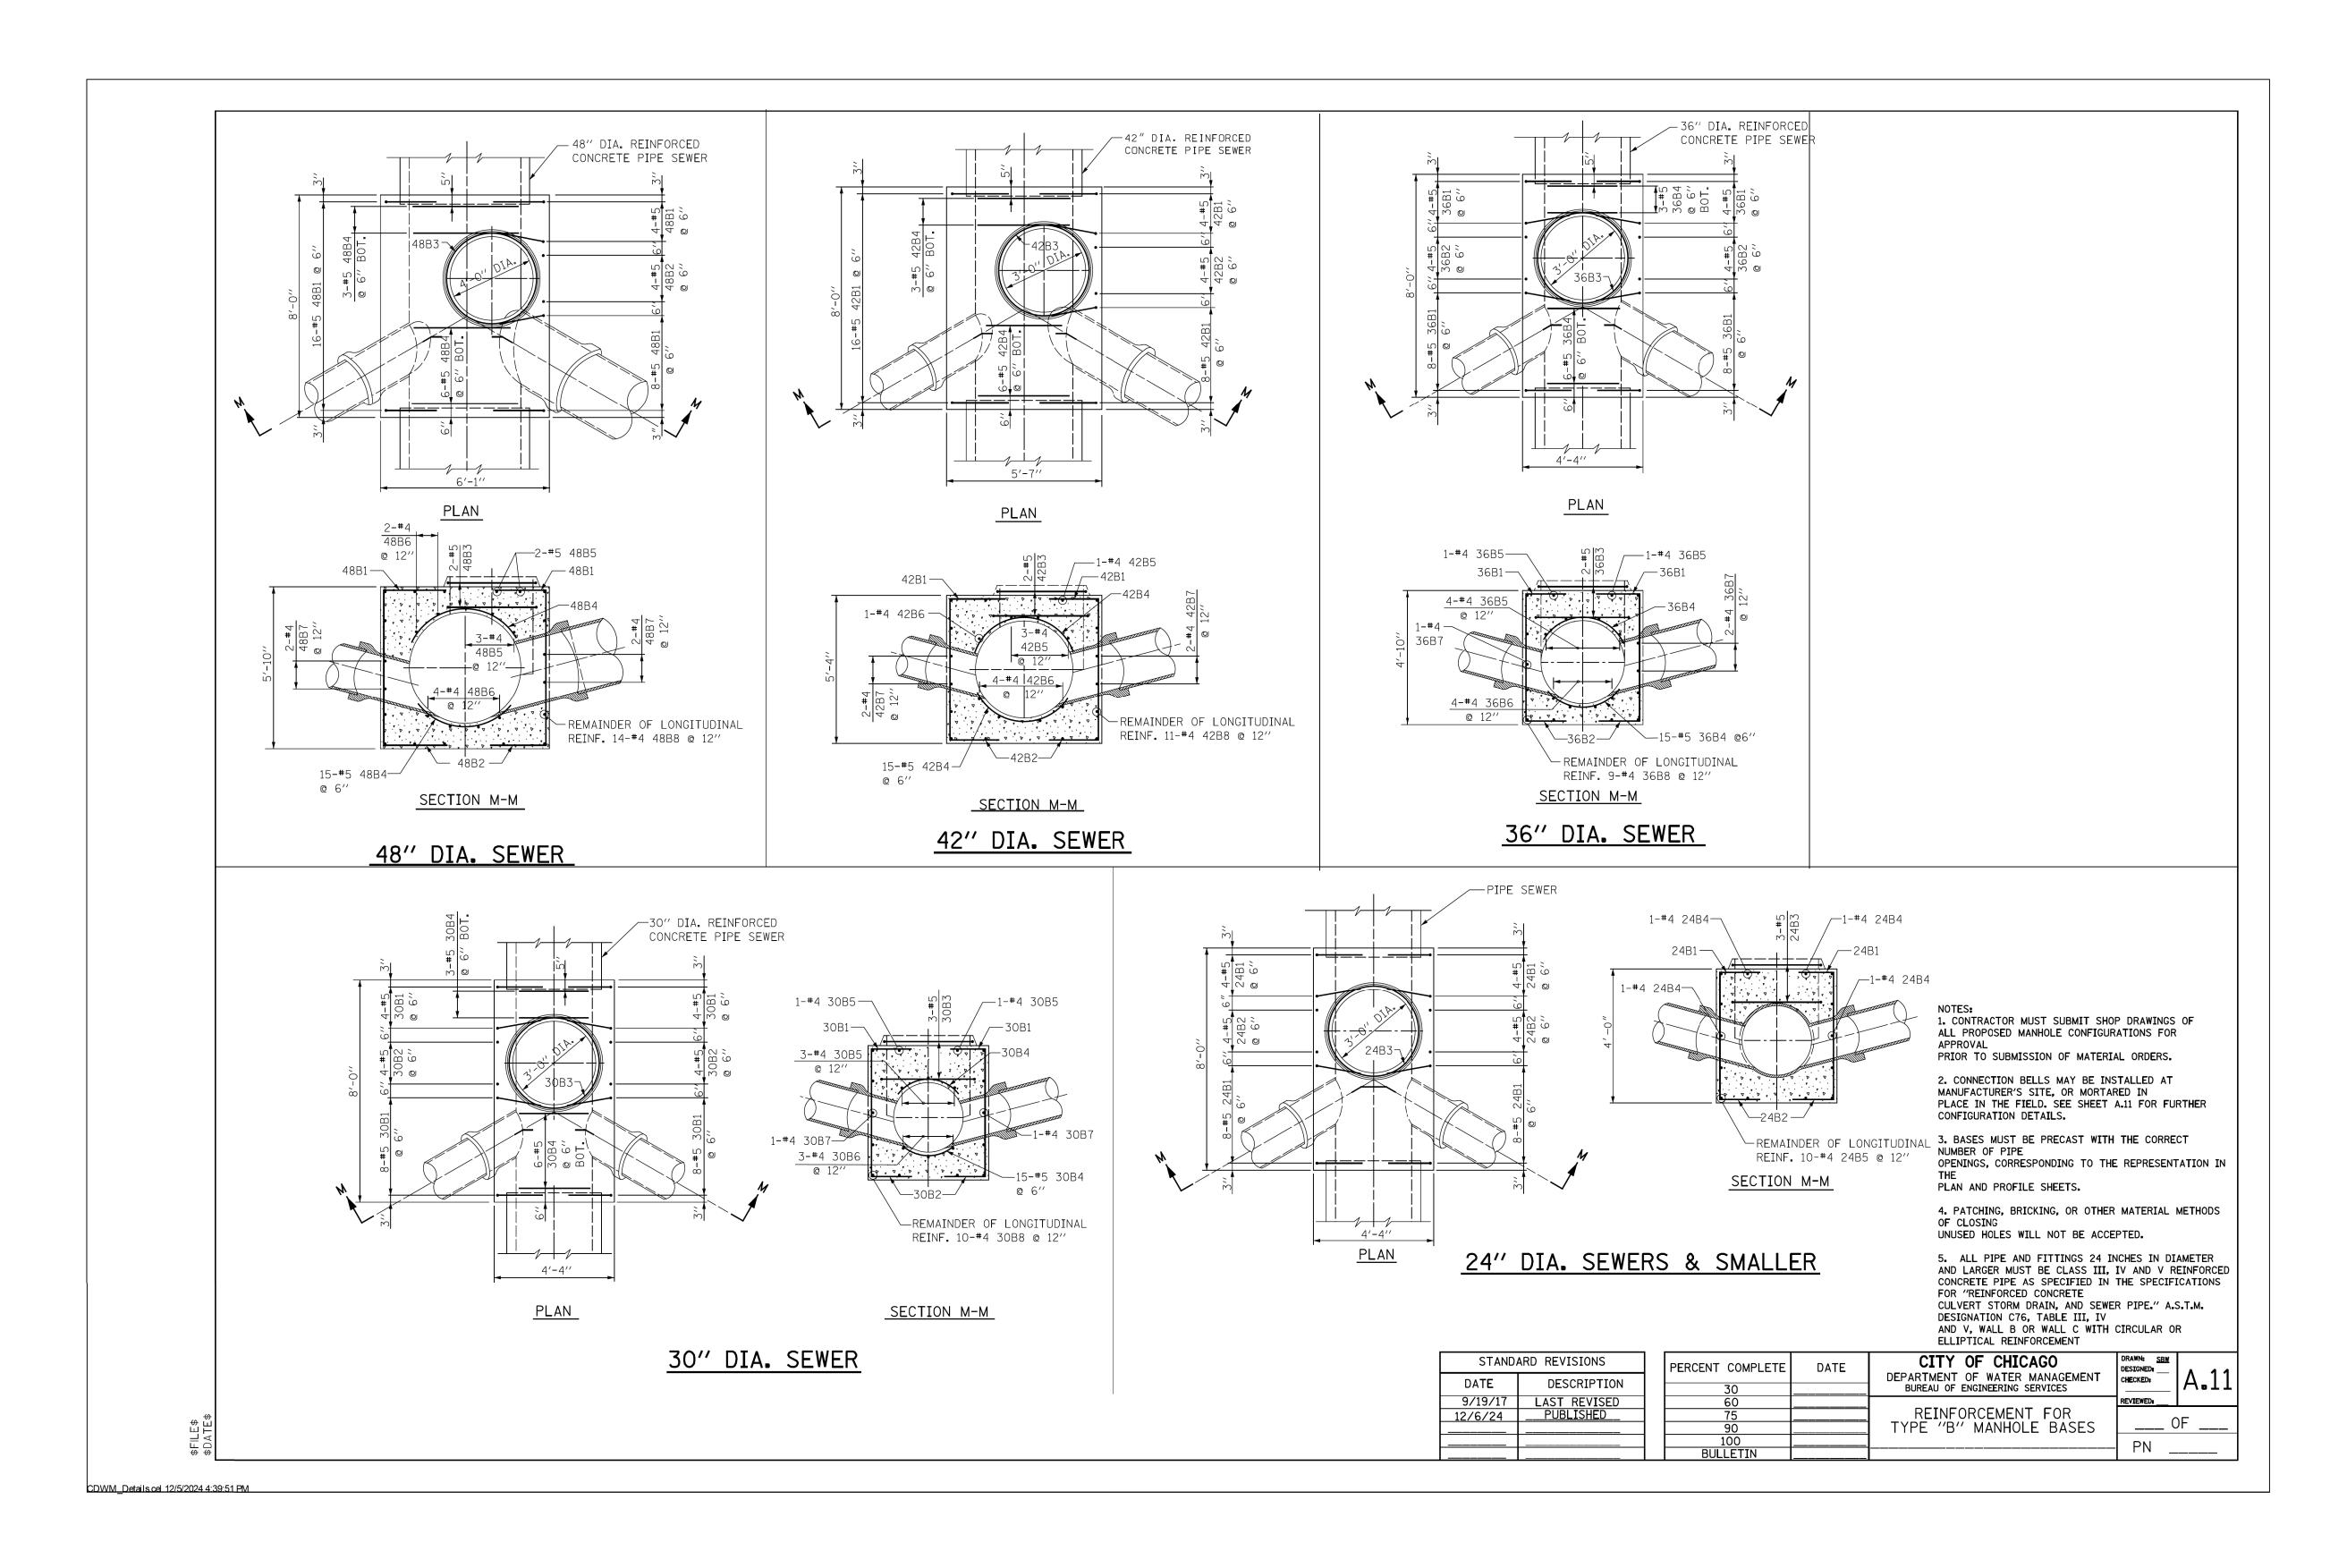





CAGO	USER NAME = afl	DESIGNED -		ADDENDUM NO. 1		
		554444		REVISED -		
		DRAWN -		ADDENDUM NO. 2		
	PLOT SCALE = 10.0000 ' / in.	CHECKED -		REVISED -		
	N.O.T. DATE: 4/20/2025	DATE 04/22/2	025	ADDENDUM NO. 3		
//.	PLOT DATE = $4/30/2025$	DATE - 04/22/2	025	ISSUE TO BID -	5/6/2025	

CITY	OF	CHICAGO
DEPARTMENT	OF	TRANSPORTATION

	CDWM SEWER DETAILS							F.A. SECTION		COUNTY	TOTAL SHEETS	SHEET NO.	
											COOK	50	33
				1									
	SHEET 14	OF	27	SHEETS	STA.	TO STA.			ILLINOIS	FED. AI	D PROJECT		

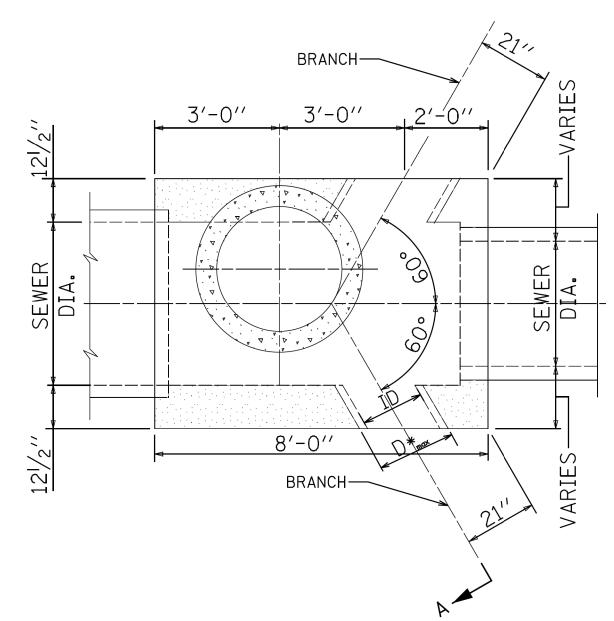

TYPICAL 4 OPENING TYPE B MANHOLE

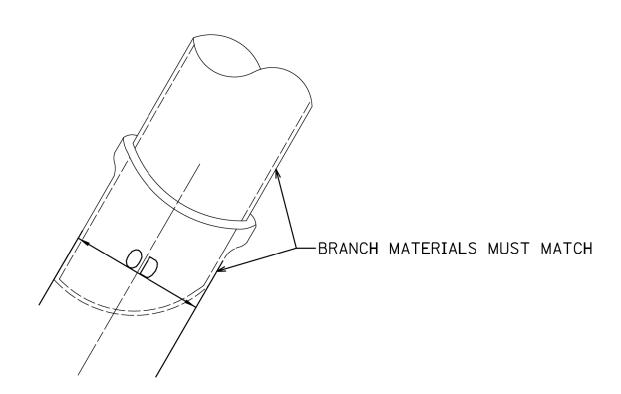

NOTES:
1. CONTRACTOR MUST SUBMIT SHOP DRAWINGS OF ALL PROPOSED MANHOLE CONFIGURATIONS FOR APPROVAL PRIOR TO SUBMISSION OF MATERIAL ORDERS.

2. CONNECTION BELLS MAY BE INSTALLED AT MANUFACTURER'S SITE, OR MORTARED IN PLACE IN THE FIELD.

3. BASES MUST BE PRECAST WITH THE CORRECT NUMBER OF PIPE OPENINGS, CORRESPONDING TO THE REPRESENTATION IN THE PLAN AND PROFILE SHEETS.

4. PATCHING, BRICKING, OR OTHER MATERIAL METHODS OF CLOSING UNUSED HOLES WILL NOT BE ACCEPTED.

5. ALL PIPE AND FITTINGS 24 INCHES IN DIAMETER AND LARGER MUST BE CLASS III, IV AND V REINFORCED CONCRETE PIPE AS SPECIFIED IN THE SPECIFICATIONS FOR "REINFORCED CONCRETE CULVERT STORM DRAIN, AND SEWER PIPE." A.S.T.M. DESIGNATION C76, TABLE III, IV AND V, WALL B OR WALL C WITH CIRCULAR OR ELLIPTICAL REINFORCEMENT

BRANCH SIZING CHART

ID PIPE (in.)	MATERIAL	OD PIPE (in.)	D* _{max (in.)}
12	VCP	14.36	18.36
15	VCP	17.8	21.8
18	VCP	21.48	25.48
21	VCP	25.54	31.54
8	DIP	9.05	13.05
10	DIP	11.1	15.1
12	DIP	13.2	17.2
14	DIP	15.3	19.3
16	DIP	17.4	21.4
18	DIP	19.5	23.5
20	DIP	21.6	25.6
24	DIP	25.8	29.8
24	RCP III (Wall B)	30	34
27	RCP III (Wall B)	33.5	37.5
30	RCP III (Wall B)	37	41
33	RCP III (Wall B)	40.5	44.5
36	RCP III (Wall B)	44	48
42	RCP III (Wall B)	51	55
48	RCP III (Wall B)	58	62
Notes:			
1 If the pipe of	loop and wall size is	not about an th	nia tabla

- 1. If the pipe class and wall size is not shown on this table, then D*max =OD pipe + 4"
- 2. D*max indicates the maximum size of branch opening to be cast or cut into structure.

STAND		PERC				
DATE	DATE DESCRIPTION					
9/10/21	LAST REVISED					
12/6/24	PUBLISHED					

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60		TYPE "B" MANHOLE	REVIEWED:		
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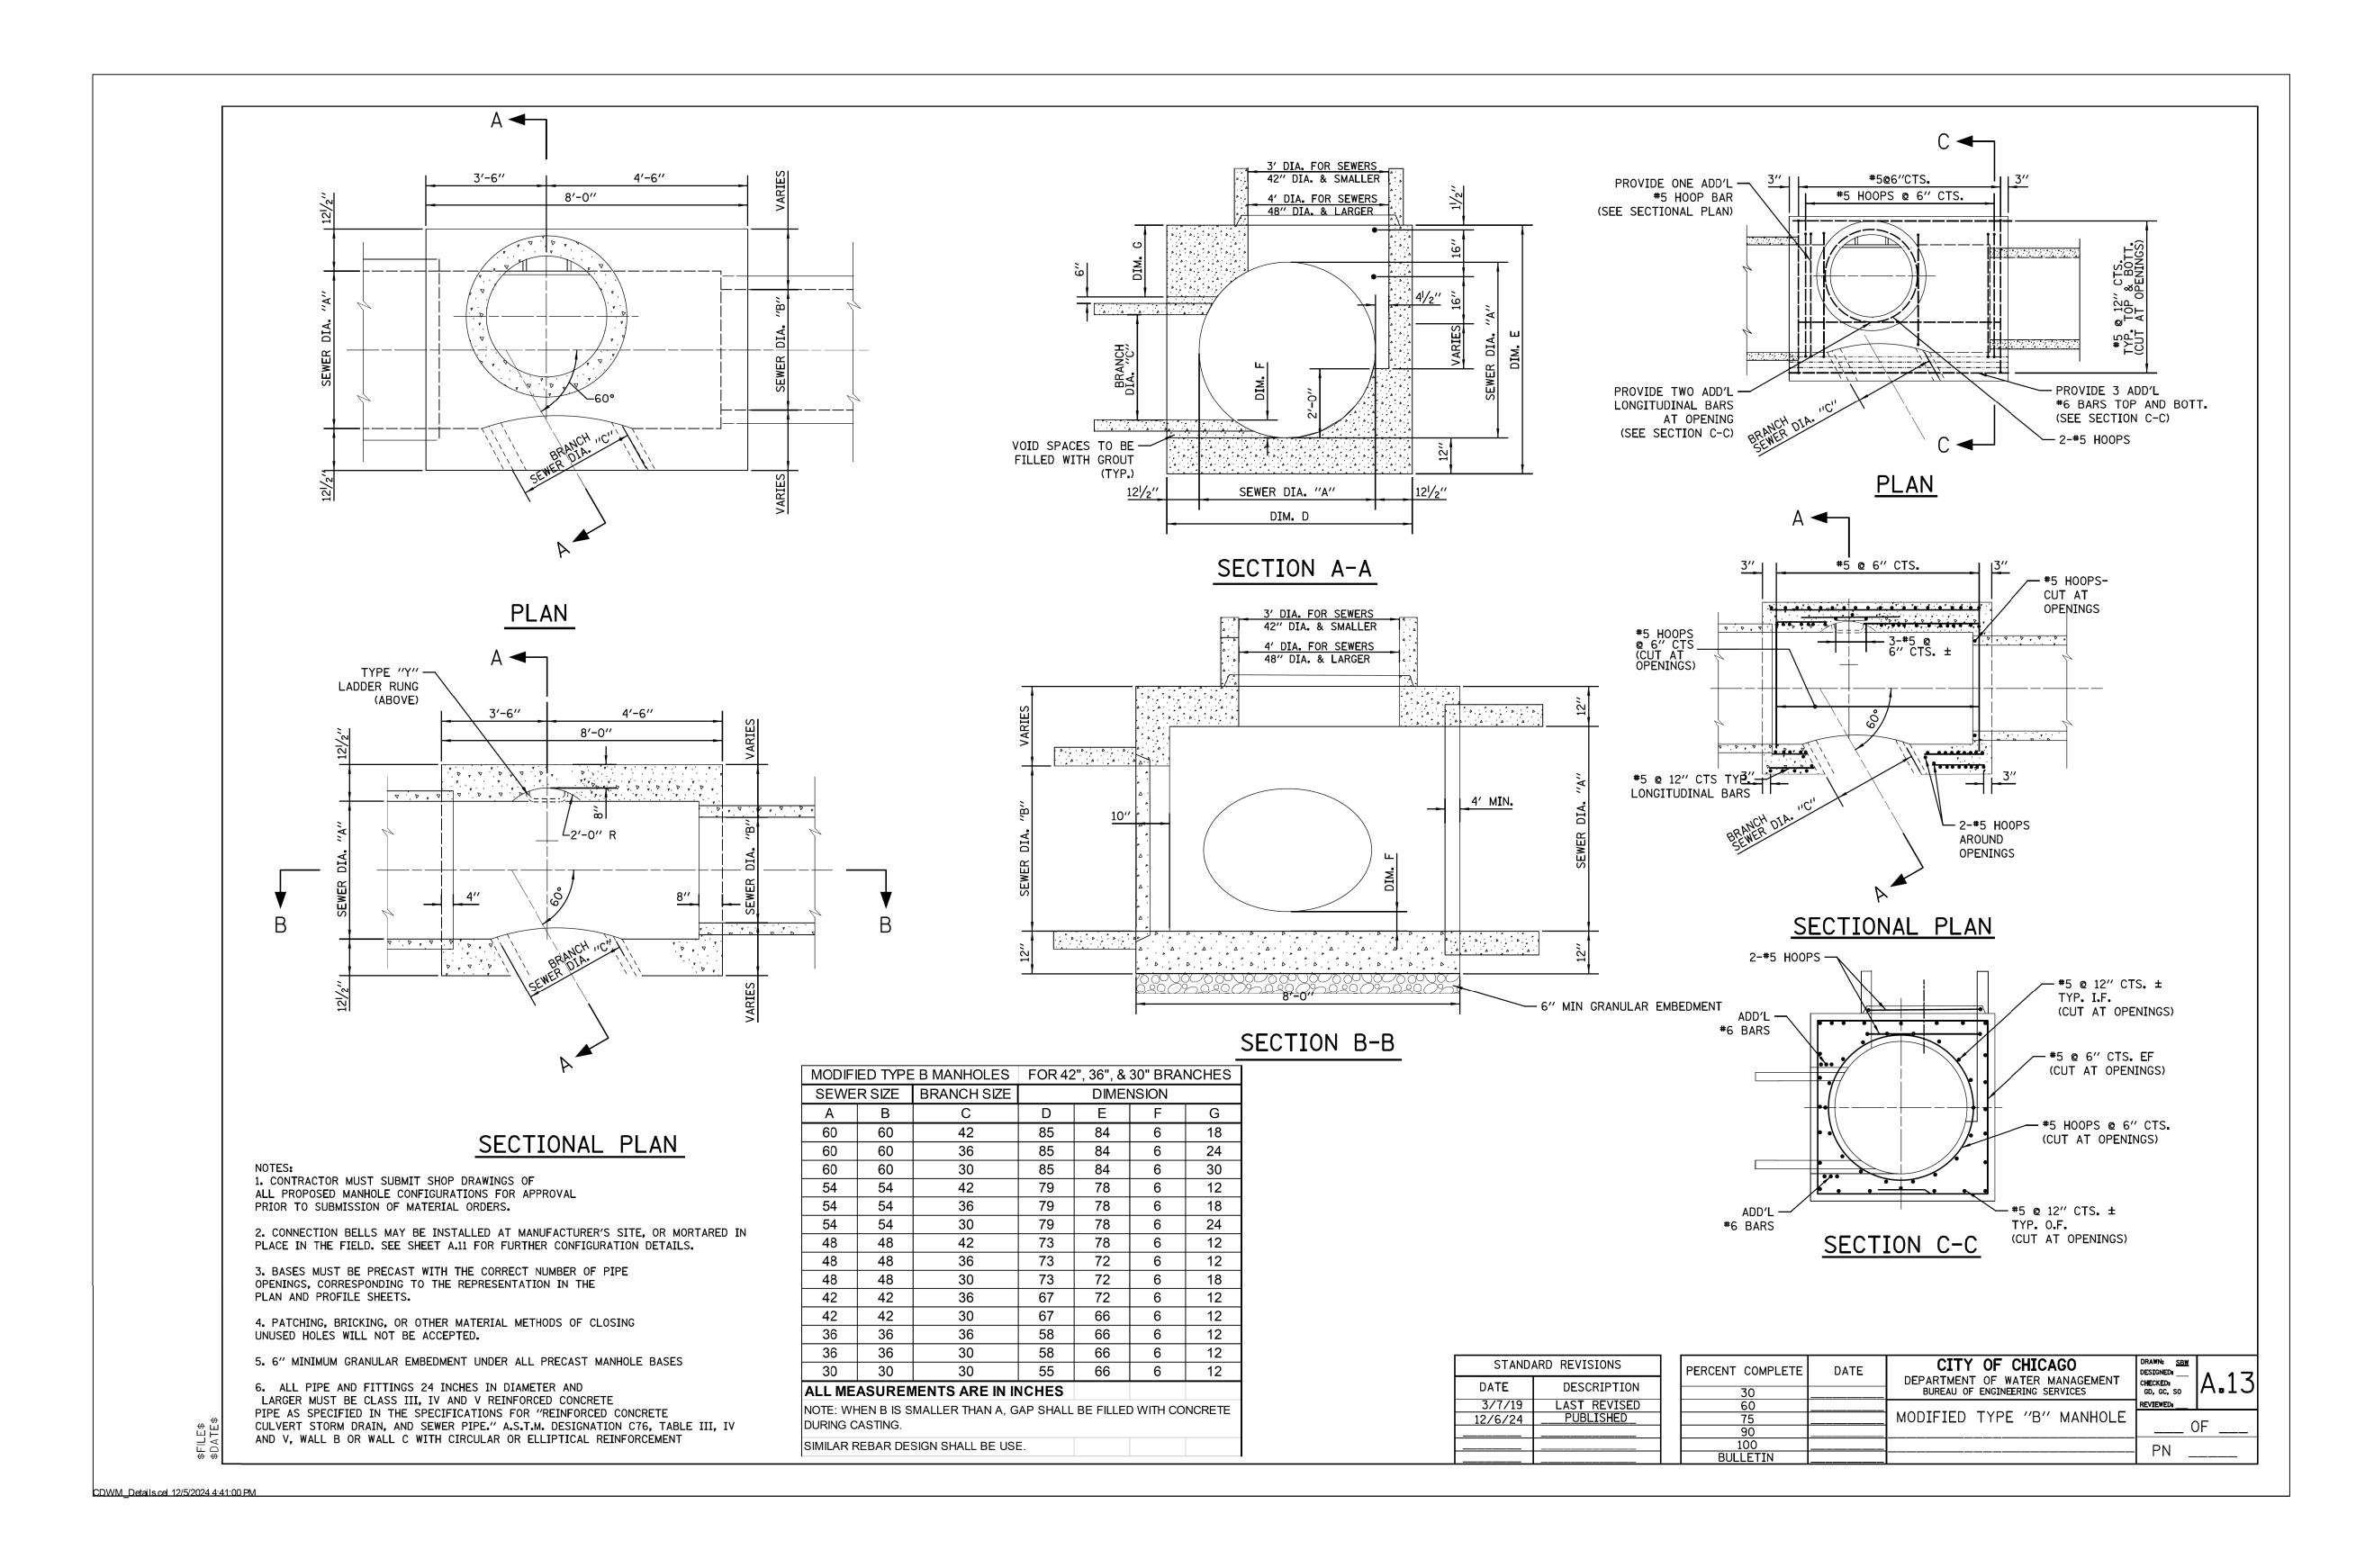
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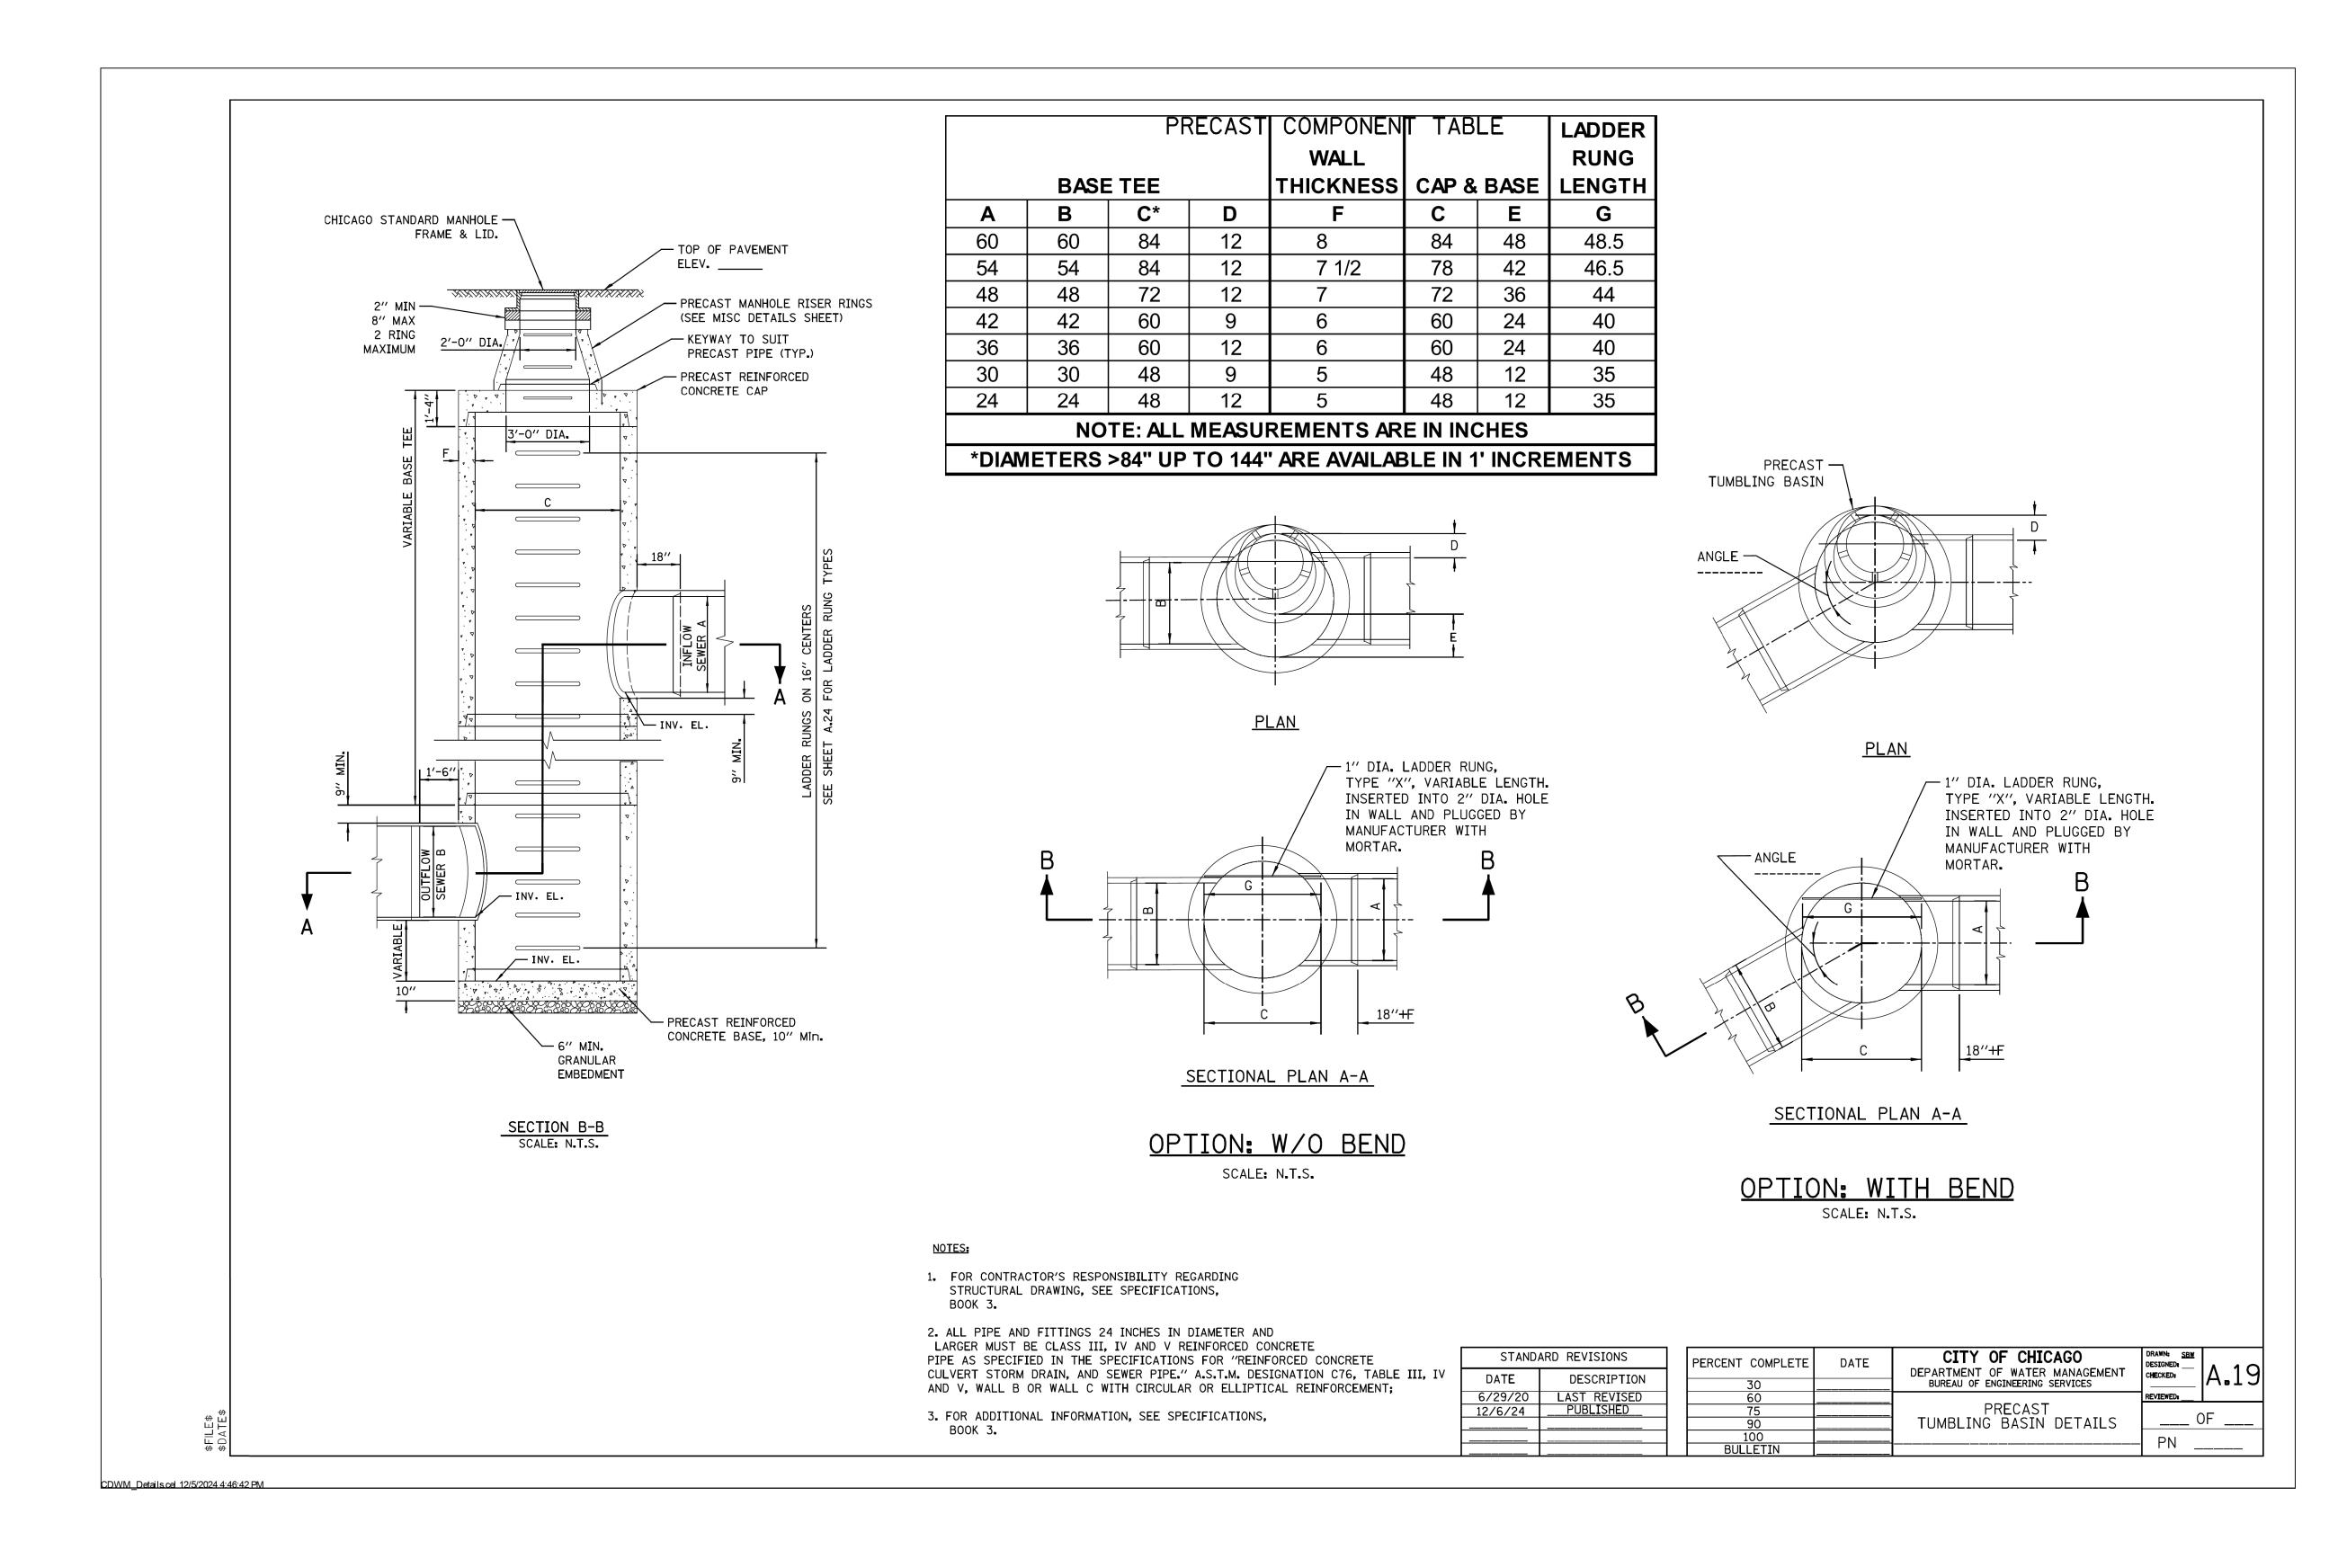
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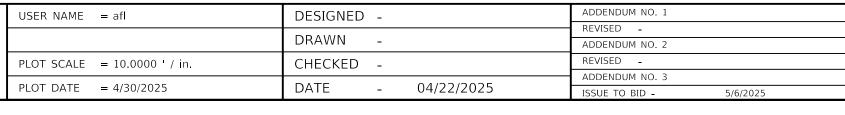
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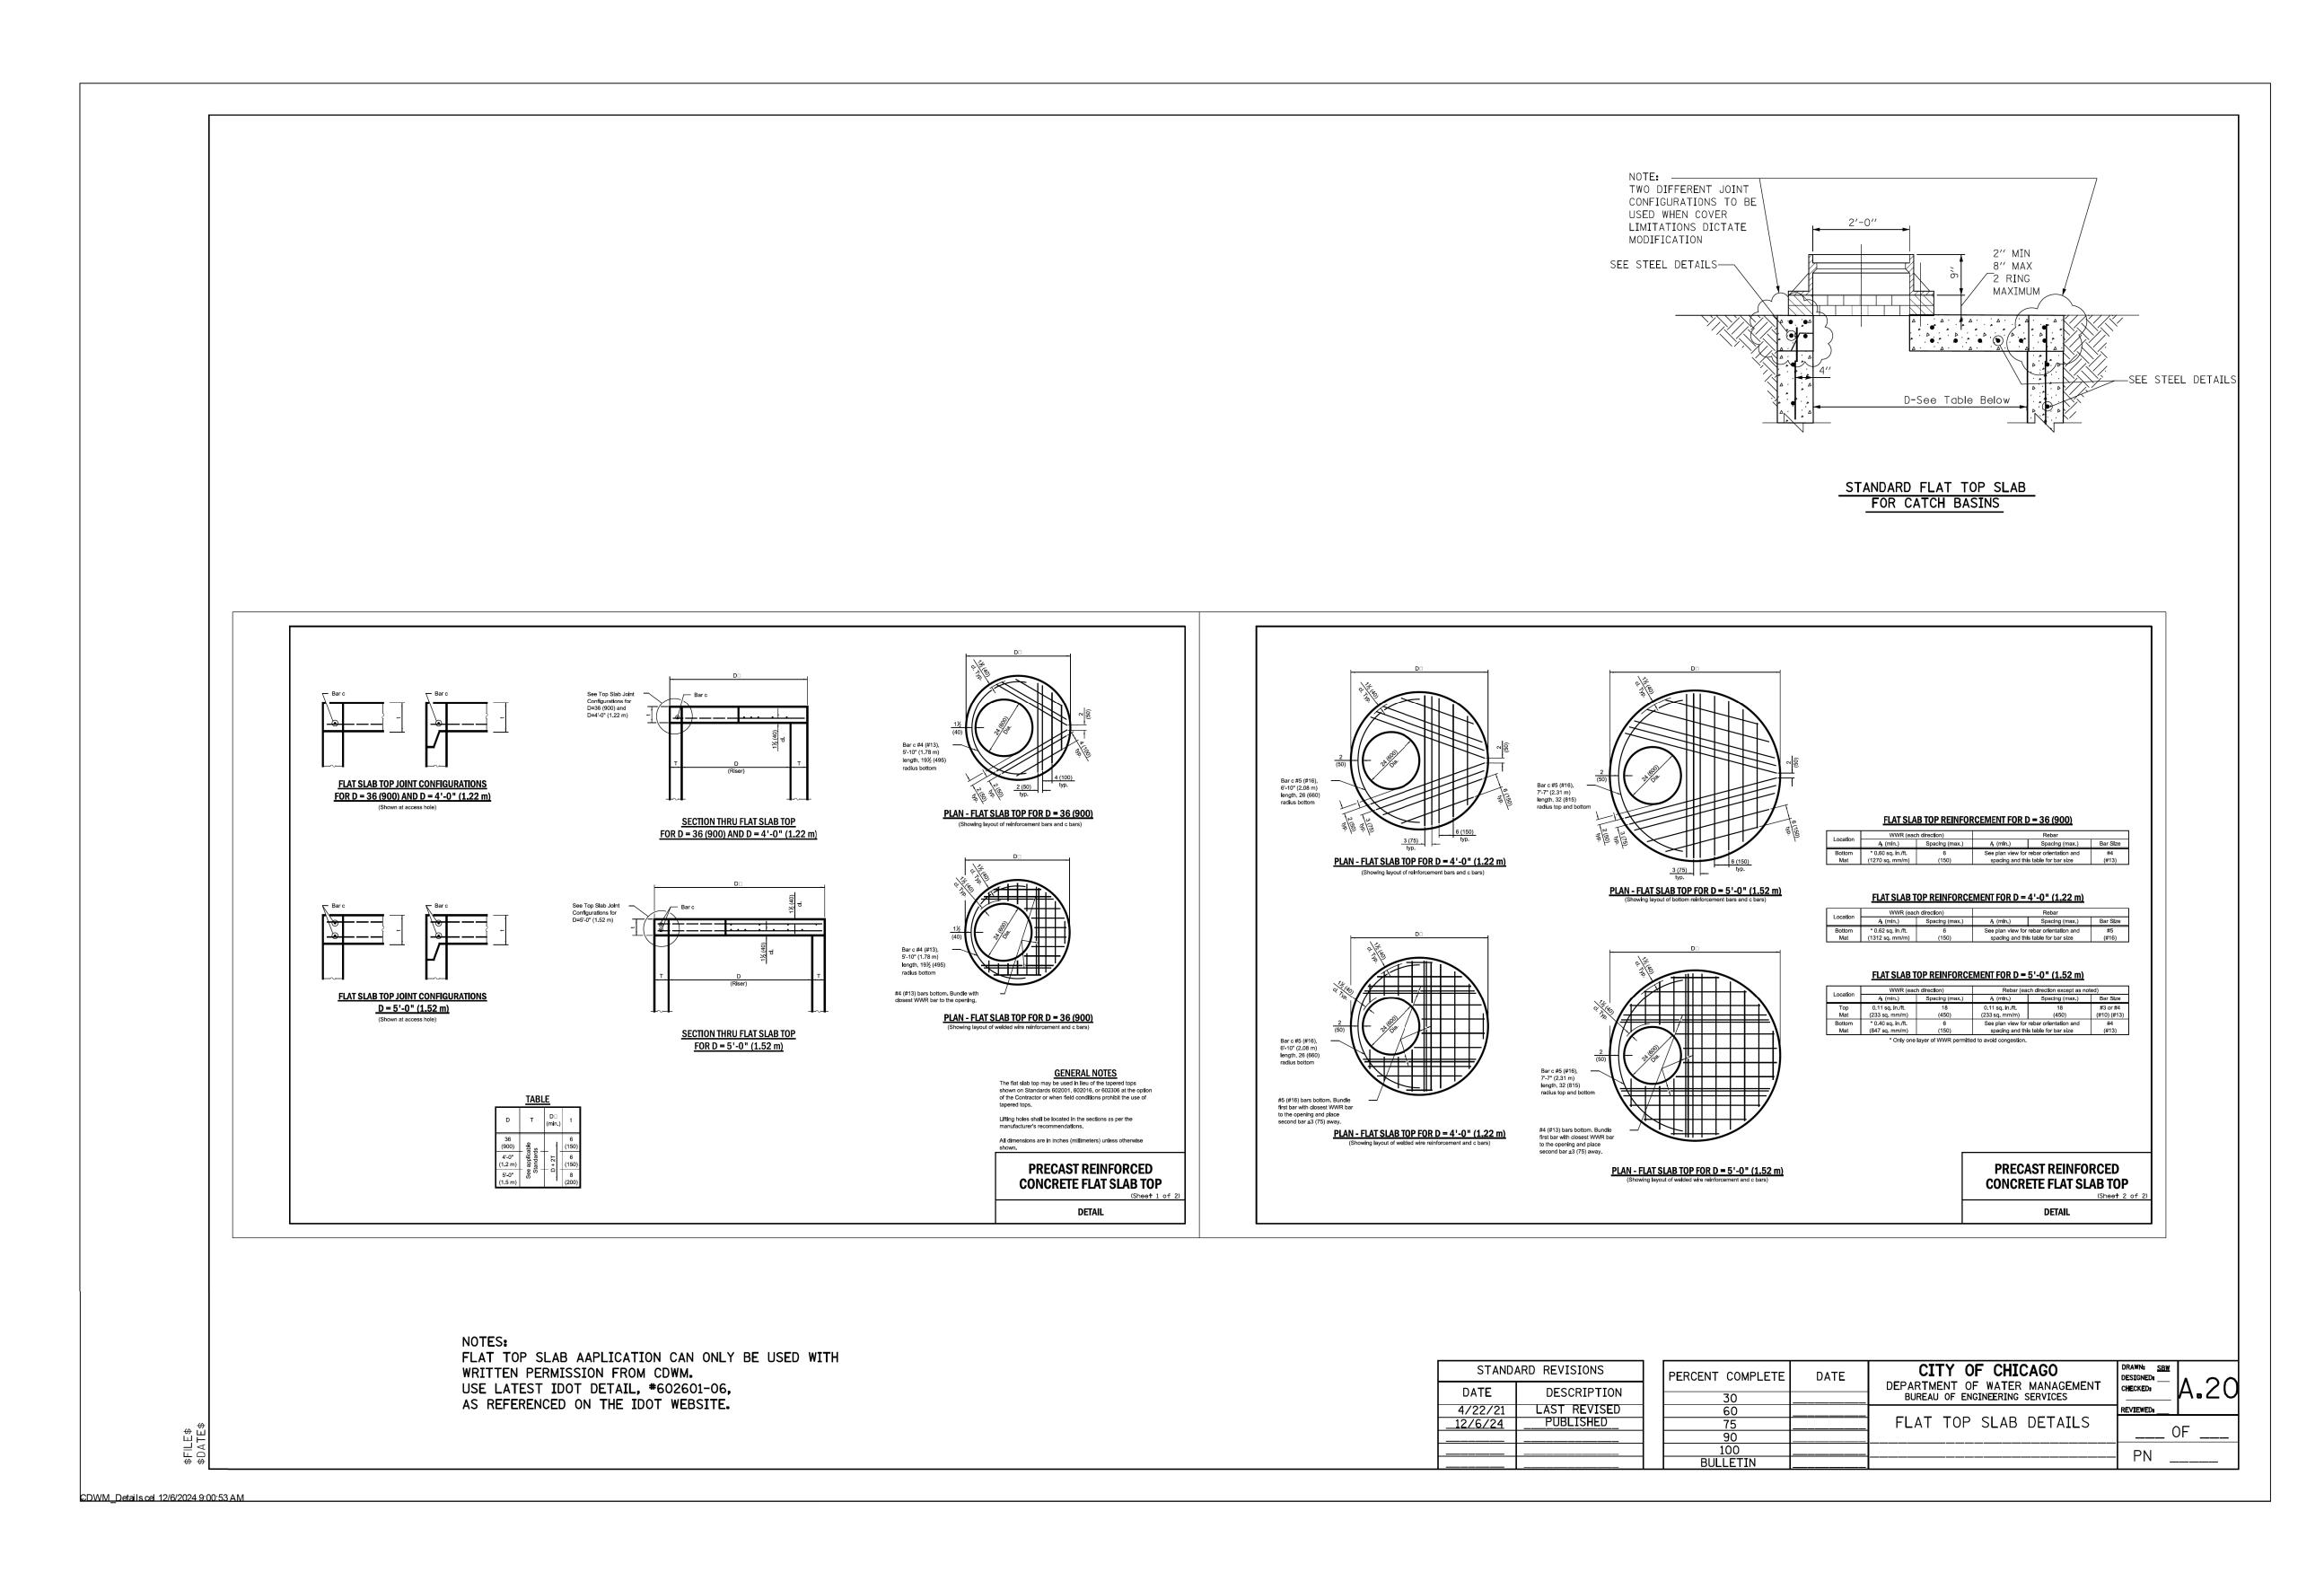






CITY OF CHICAGO
DEPARTMENT OF TRANSPORTATION

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CDWM SEWER DETAILS												COOK	50	36
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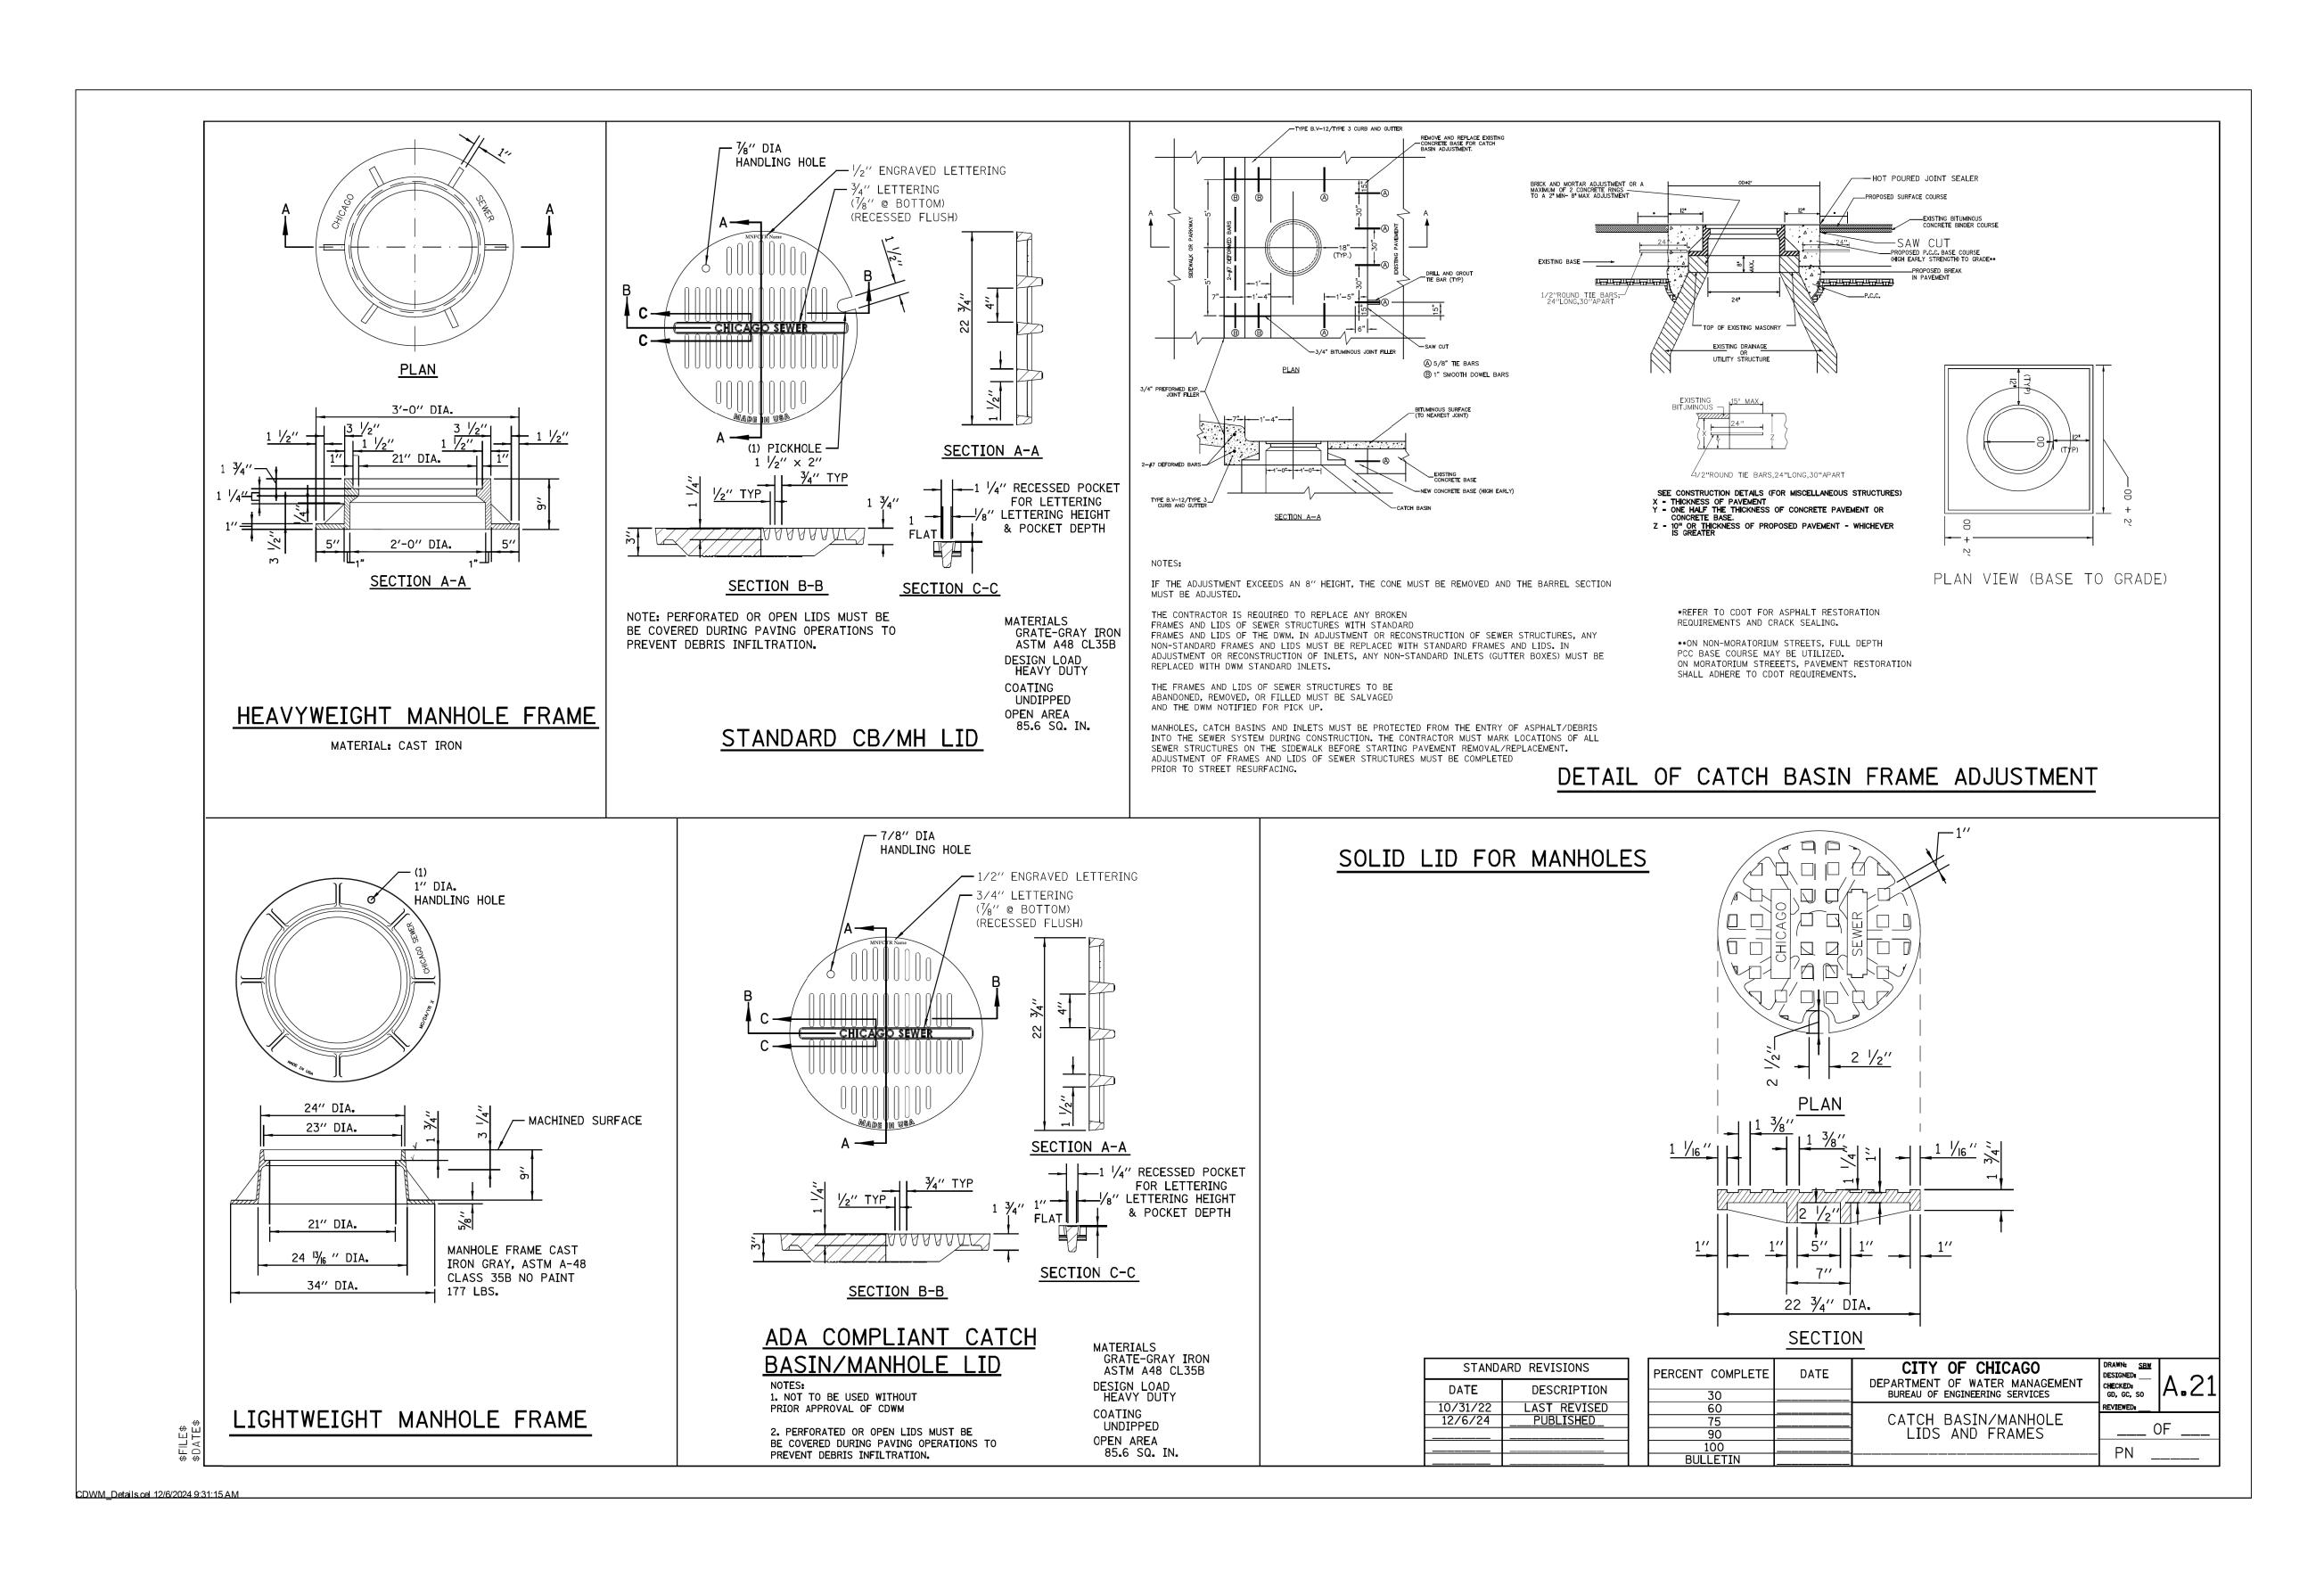




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DEPARTMENT OF TRANSPORTATION

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									СООК	50	37
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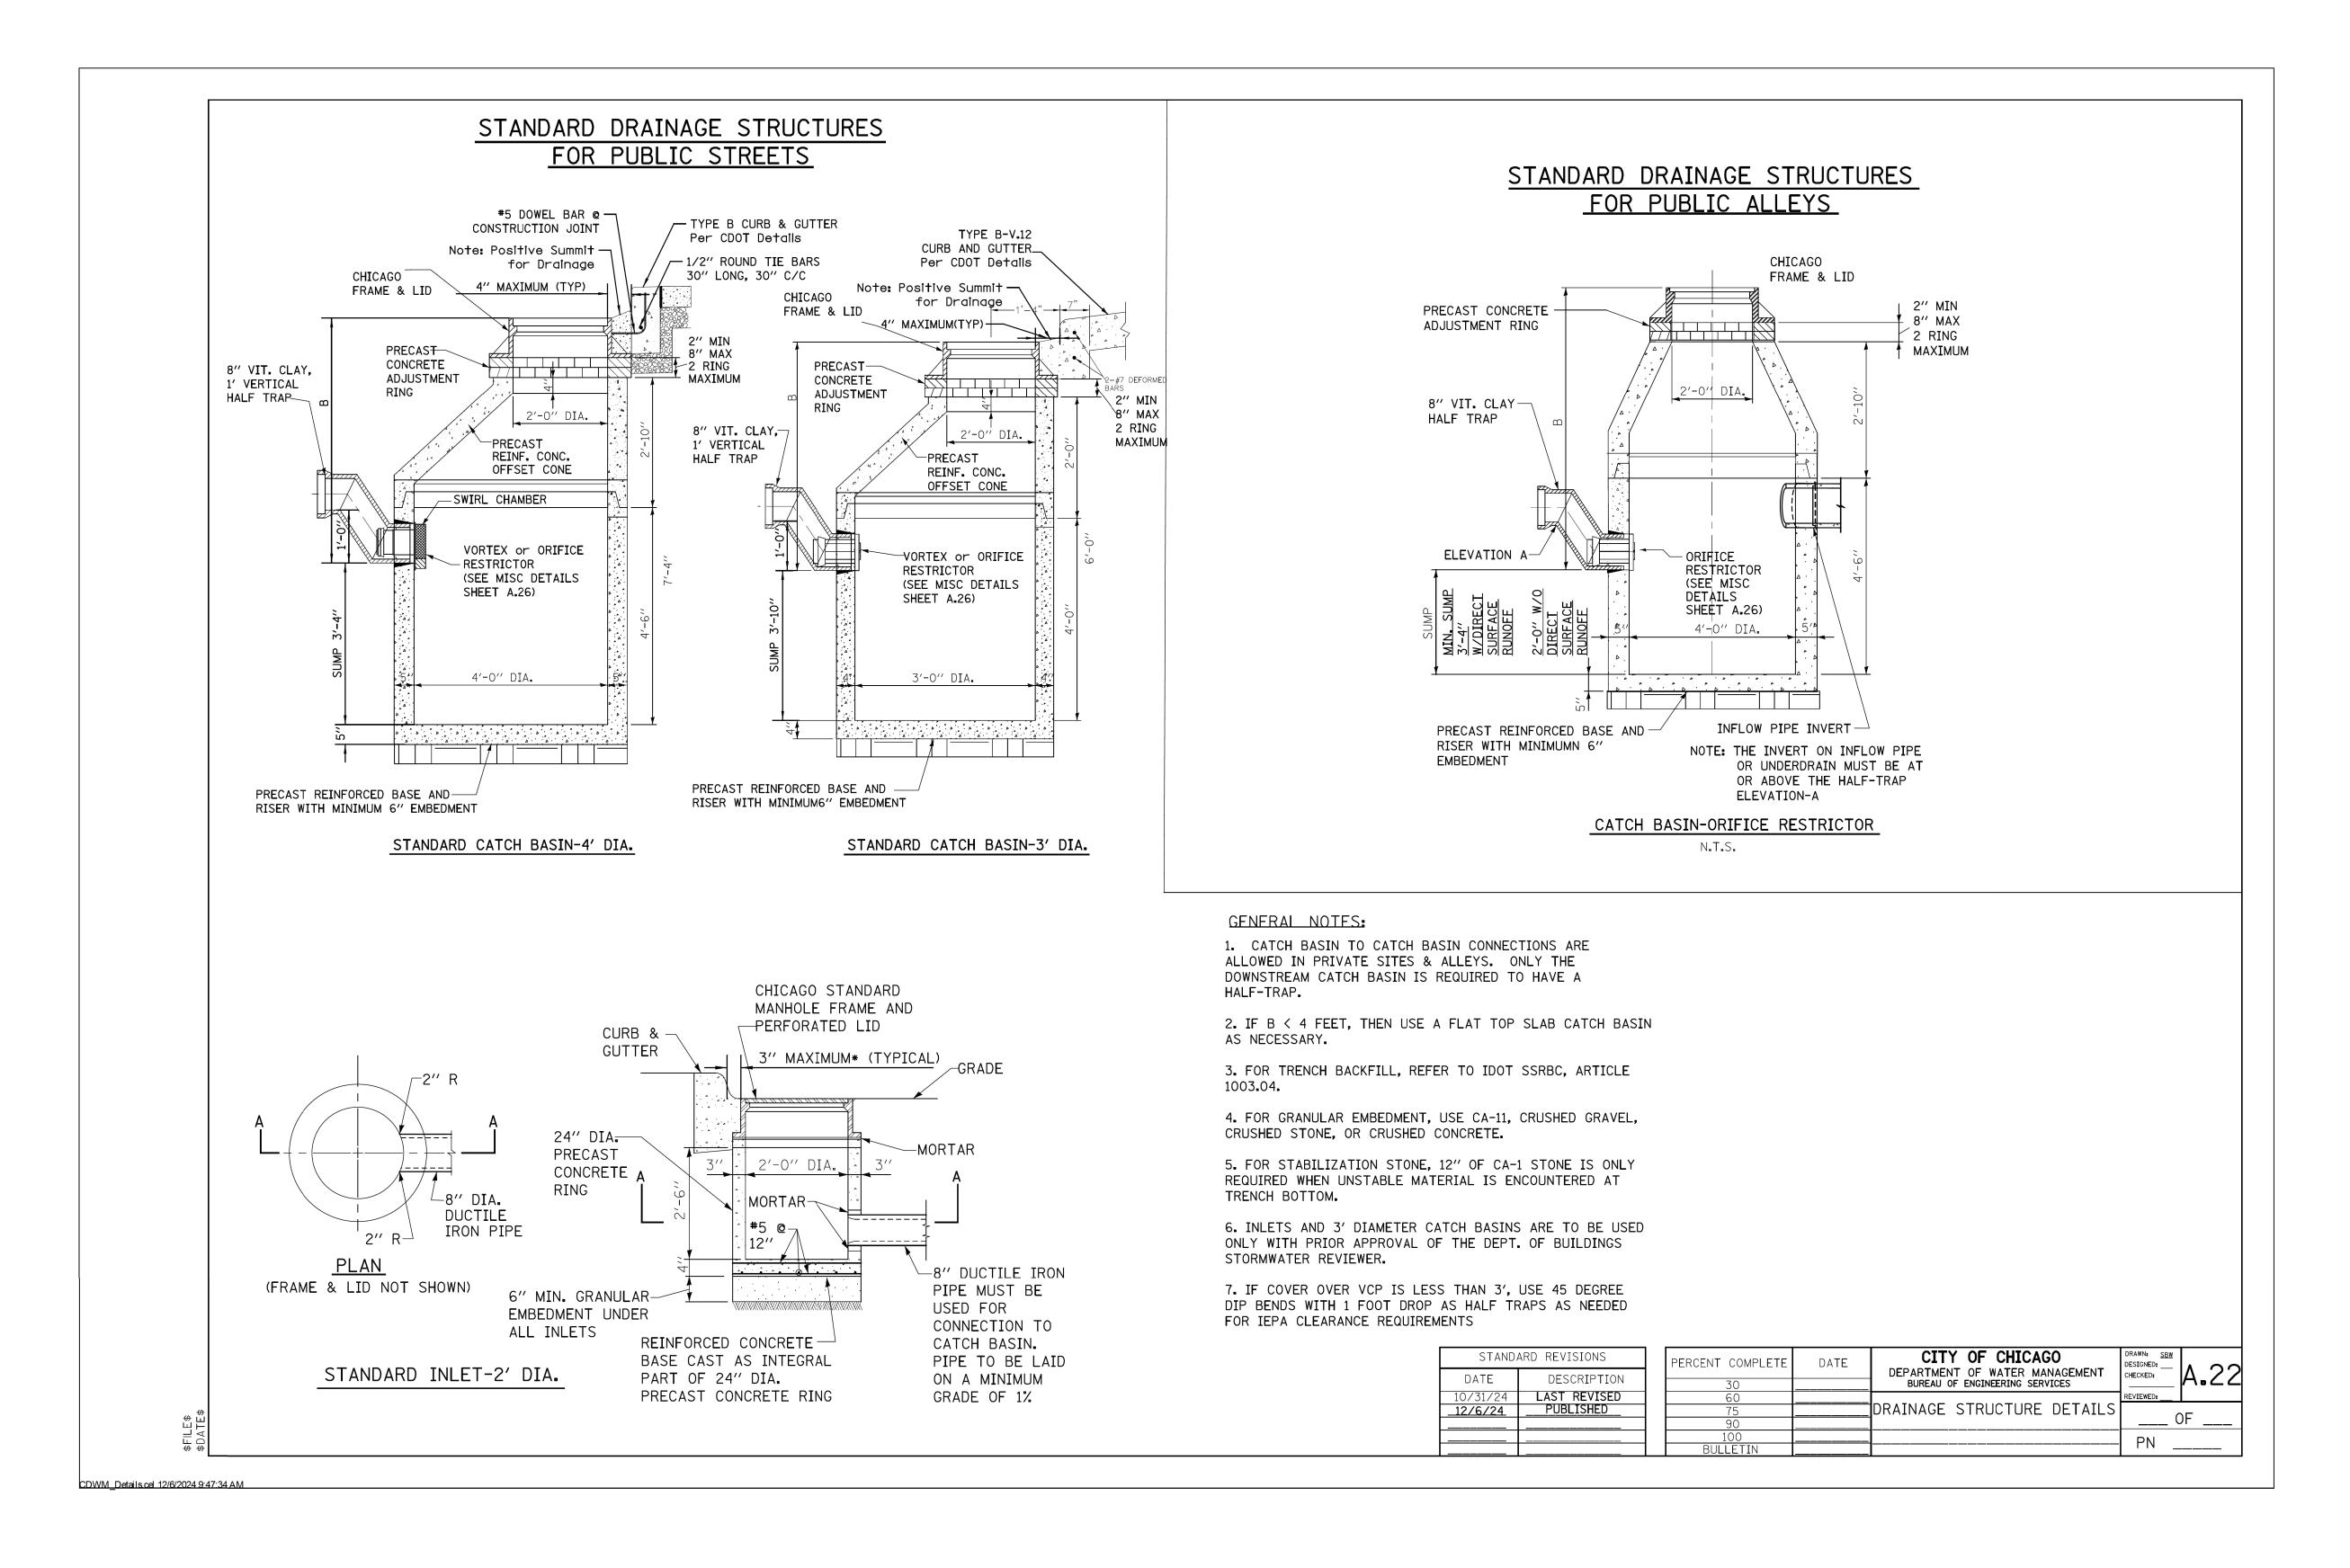
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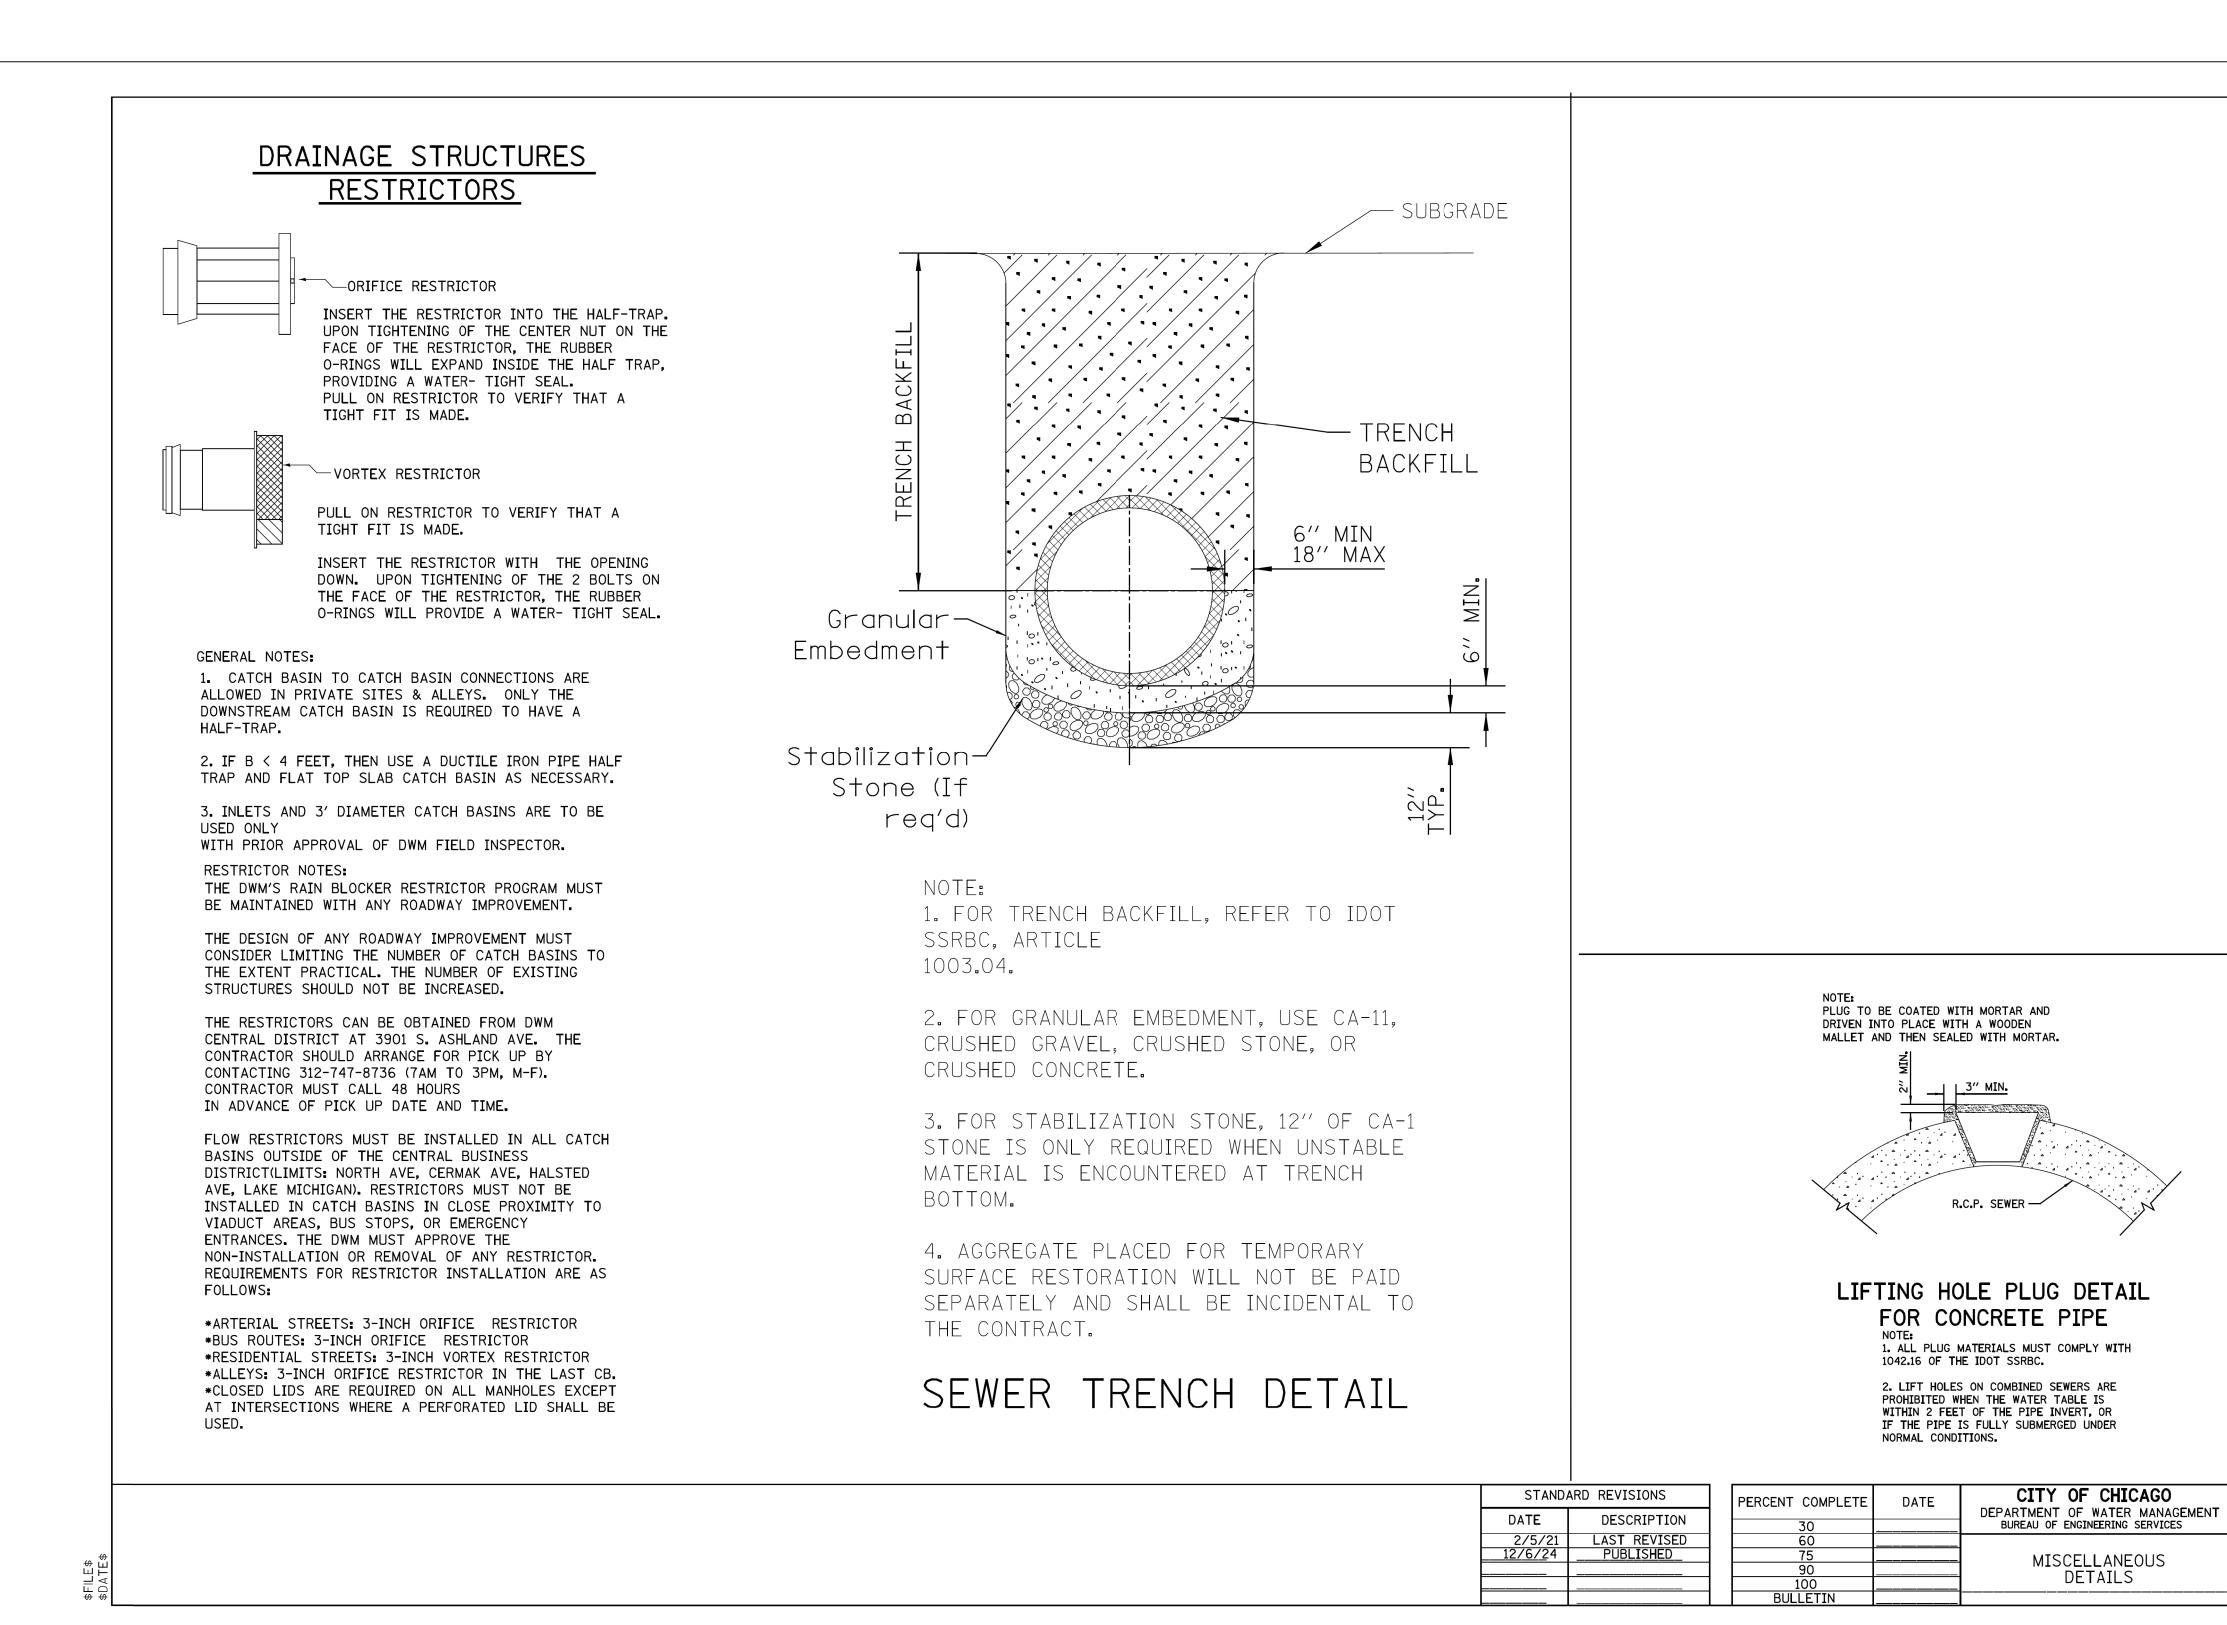




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DEPARTMENT OF TRANSPORTATION

l F					F.A. RTE.	SECTION		COUNTY	TOTAL SHEETS	SHEE NO.			
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DEPARTMENT OF TRANSPORTATION

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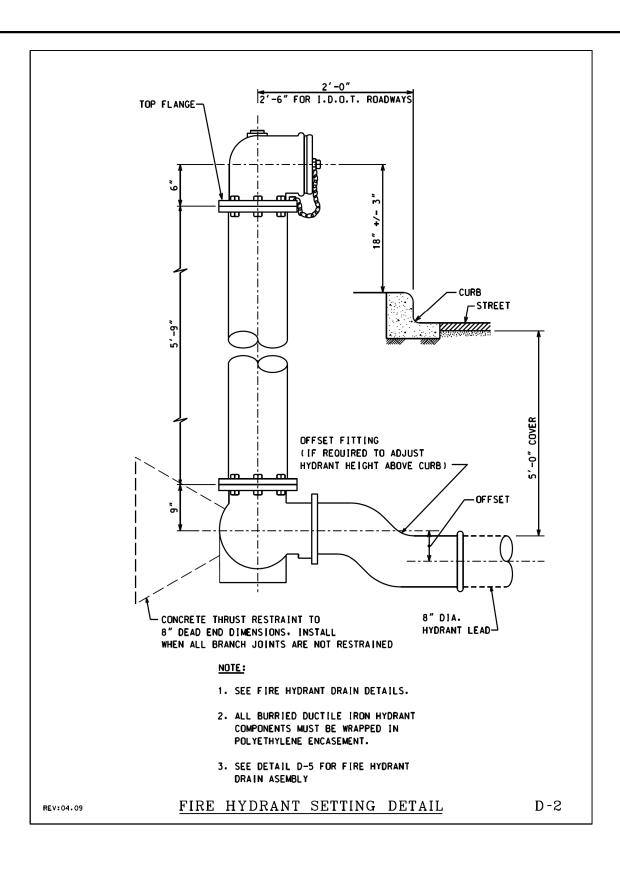
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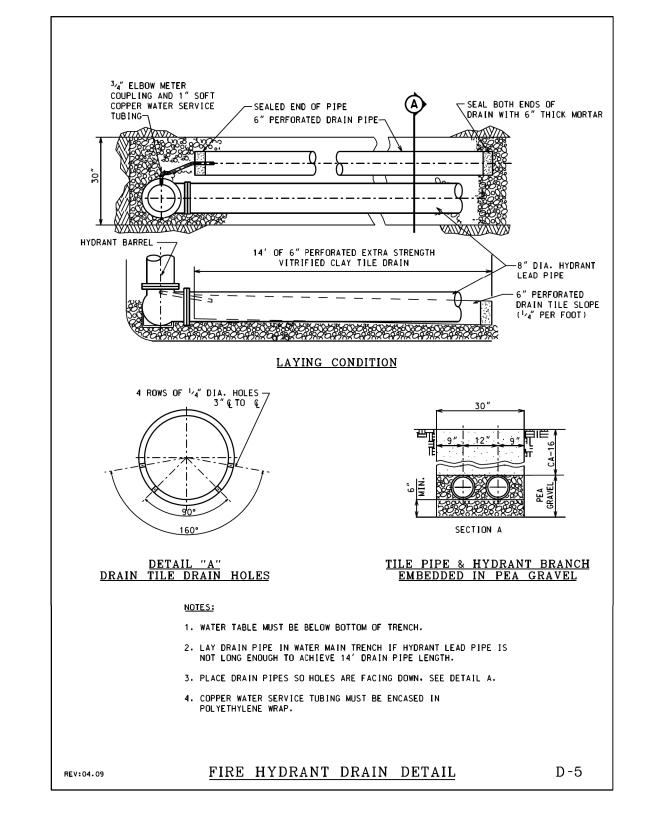
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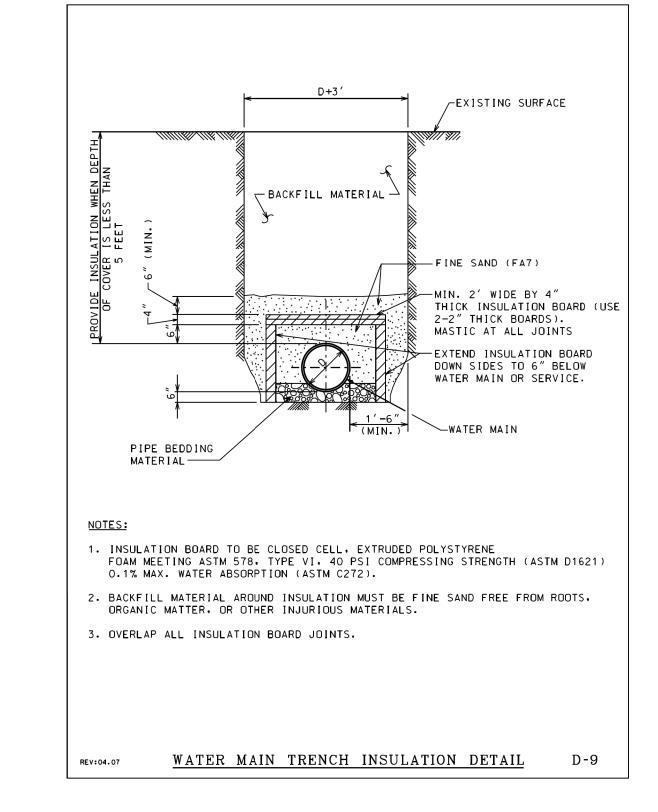
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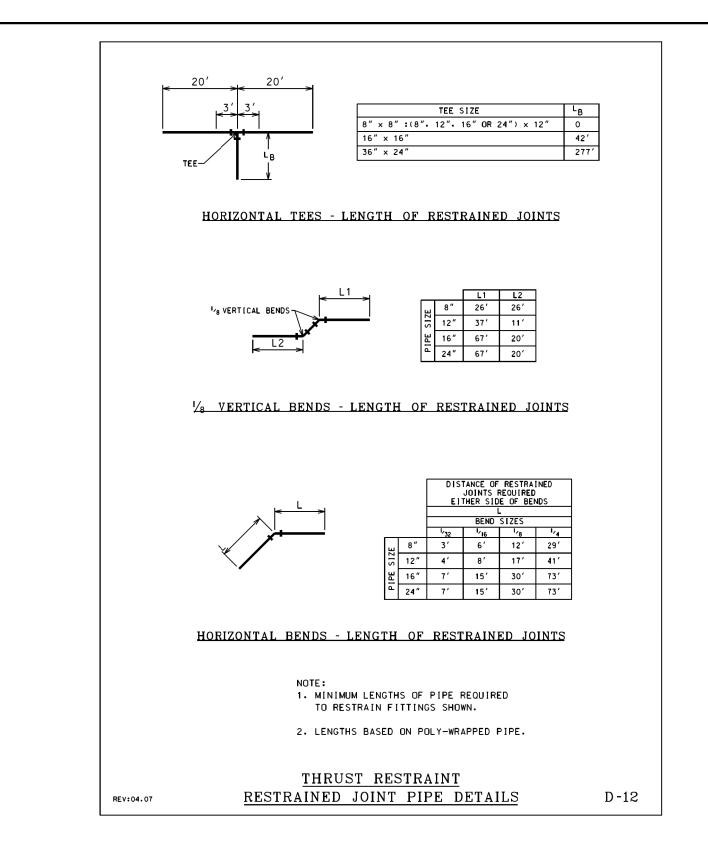









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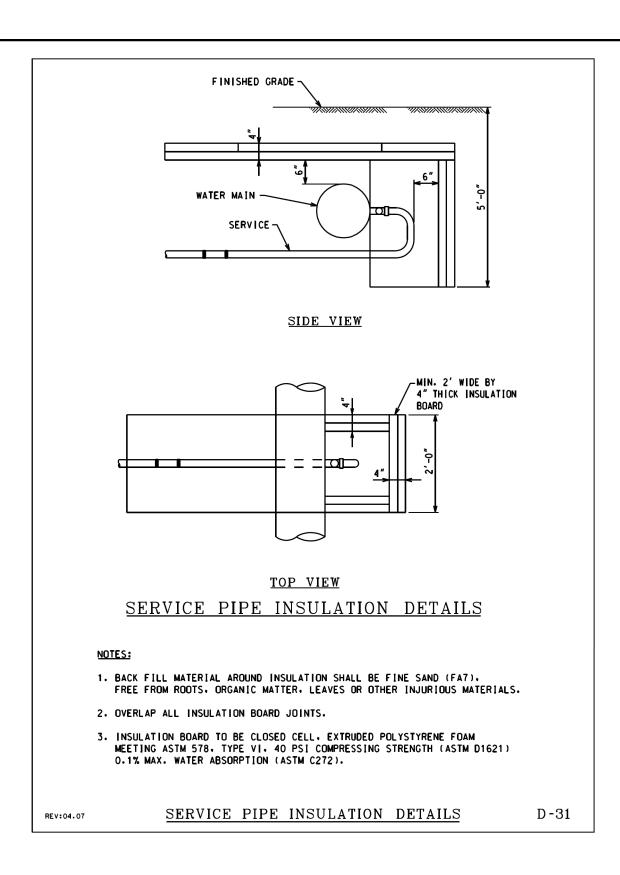






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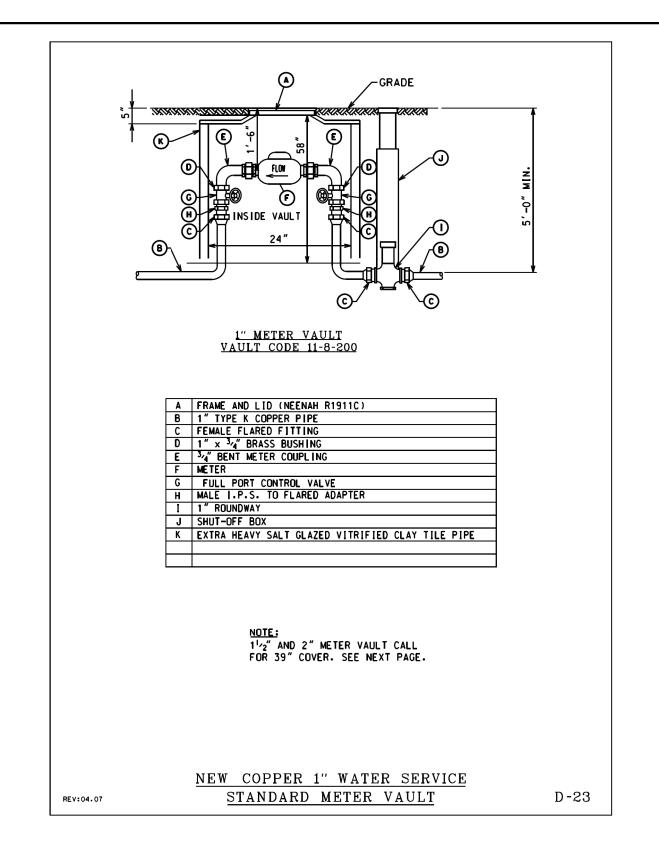
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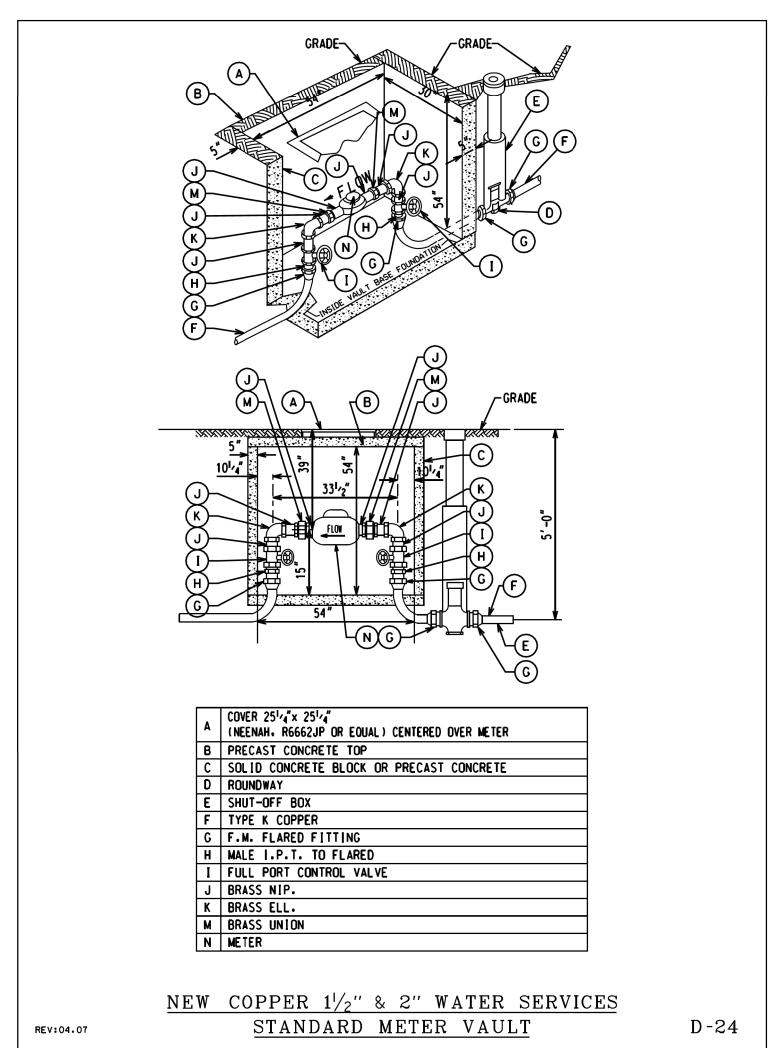
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DWM	WATER	DETAILS						COOK	50	41
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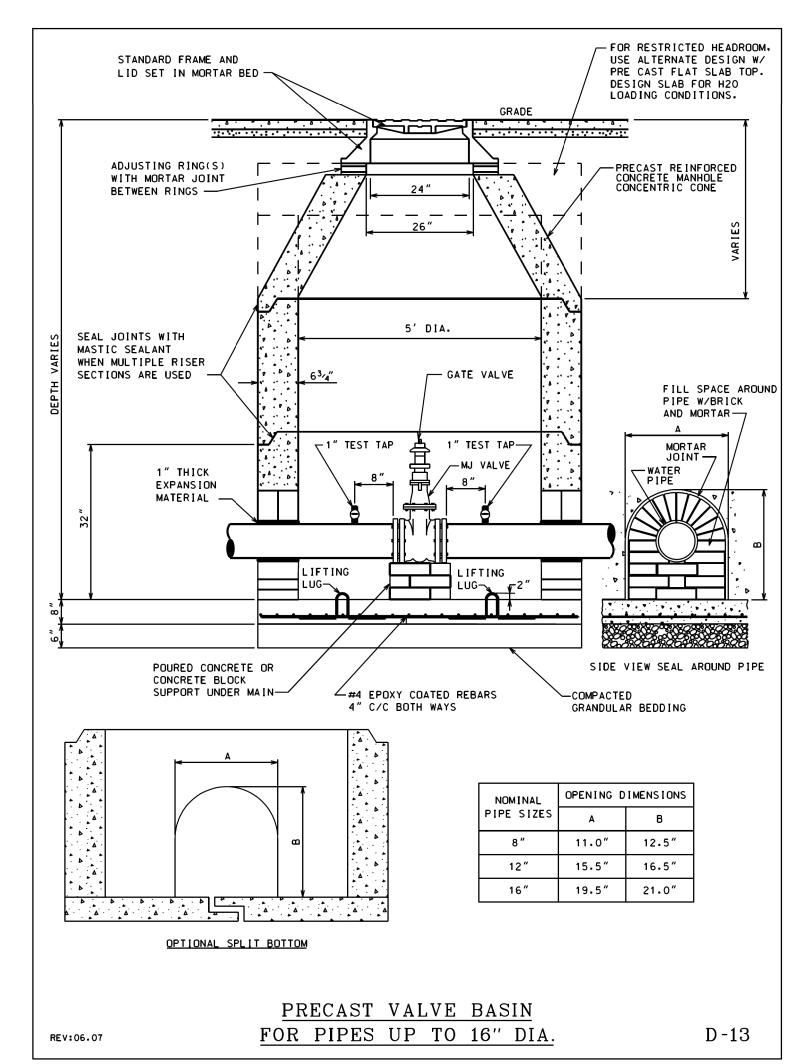


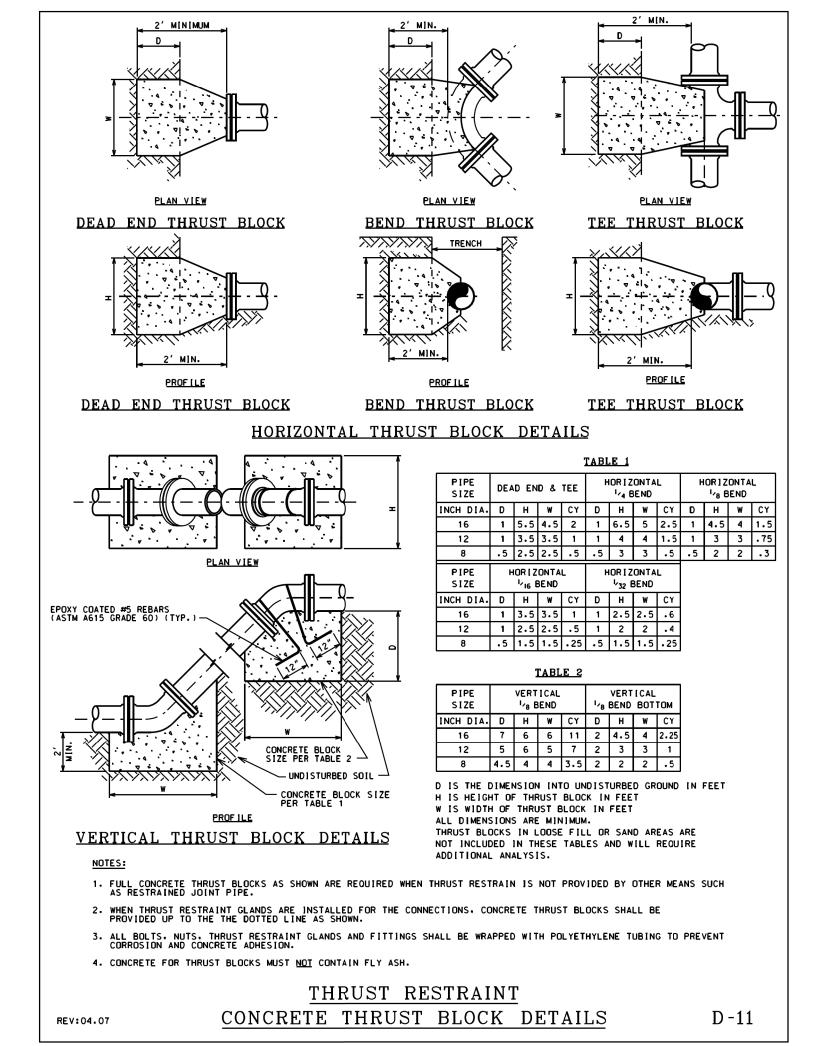

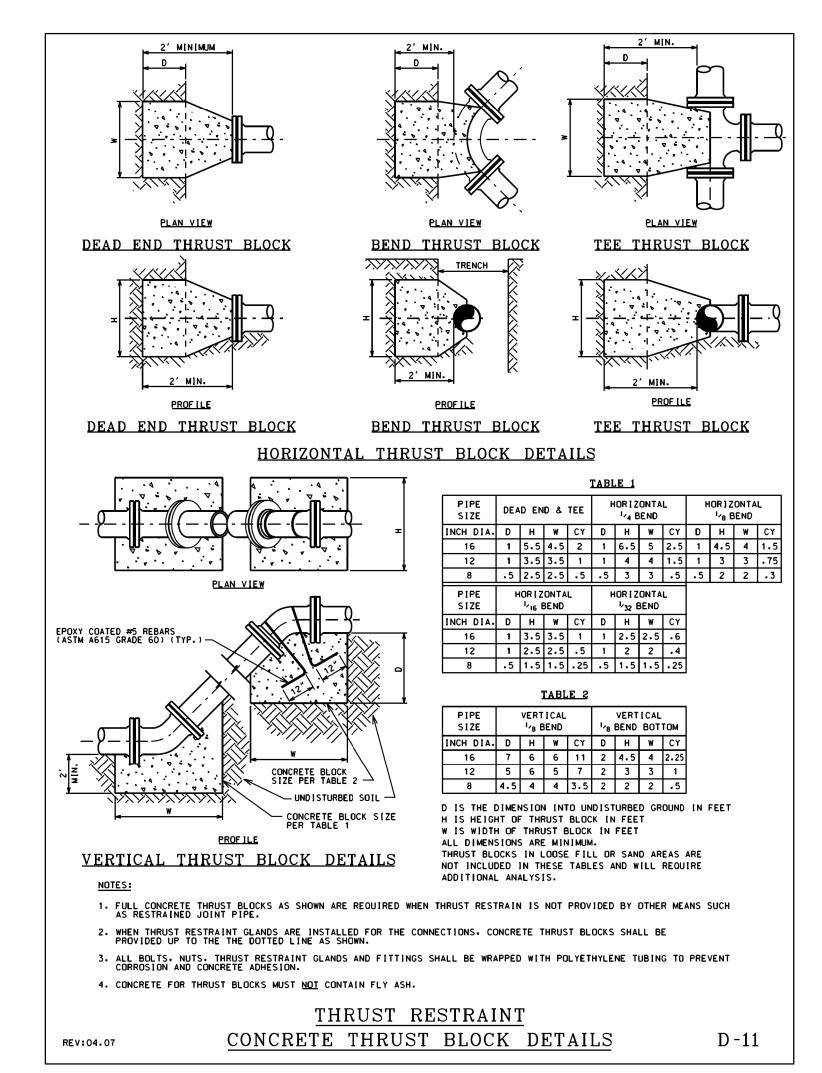

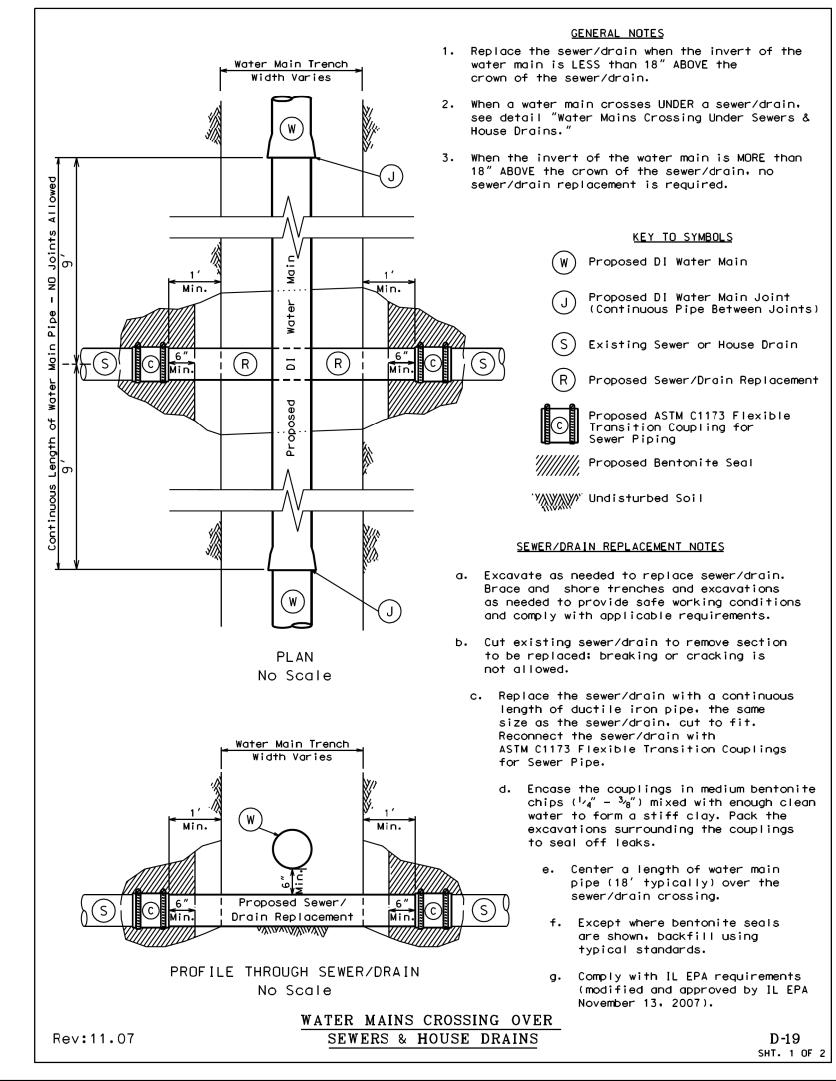

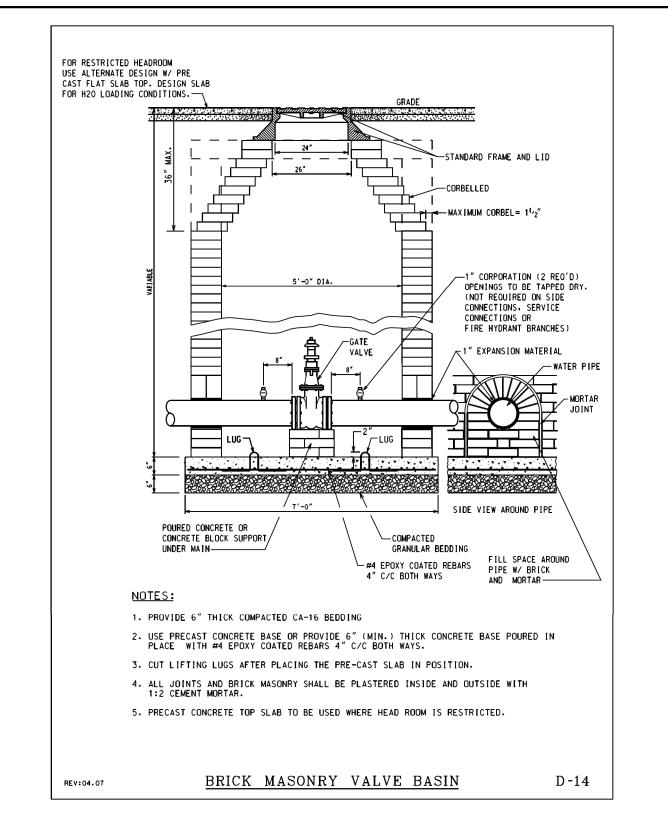

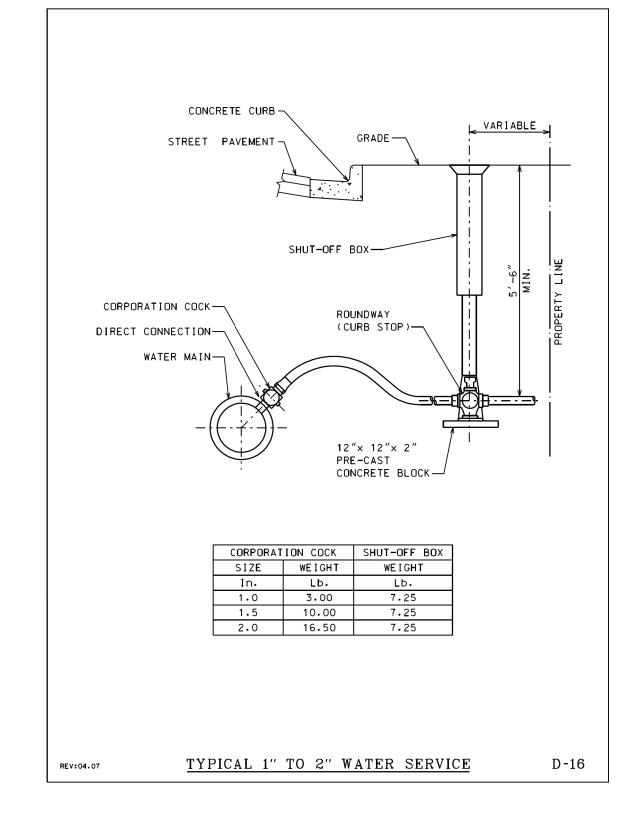




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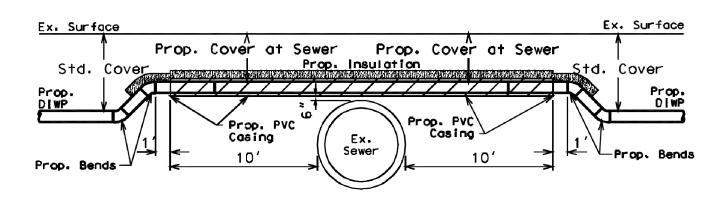
		0014/14 14/47ED DETAIL 0		F.A. RTE.	SECTION	COUNTY	TOTAL SHEETS	SHEET NO.
CITY OF CHICAGO	CDWM WATER DETAILS					СООК	50	42
DEPARTMENT OF TRANSPORTATION				_				
	SCALE:	SHEET 23 OF 27 SHEETS STA.	TO STA.		ILLINOIS FED. A	ID PROJECT		

SEWER CROSSING DETAIL A.O Water Main 1.5' Above Sewer

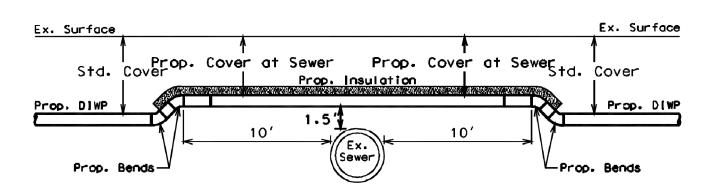


Profile View Along Water Main Centerline

SEWER CROSSING DETAIL A.1 Water Main 6" Above Sewer - Case Water Main




Profile View Along Water Main Centerline


SEWER CROSSING DETAIL B.1
Water Main 1.5' Below Sewer - Case Water Main

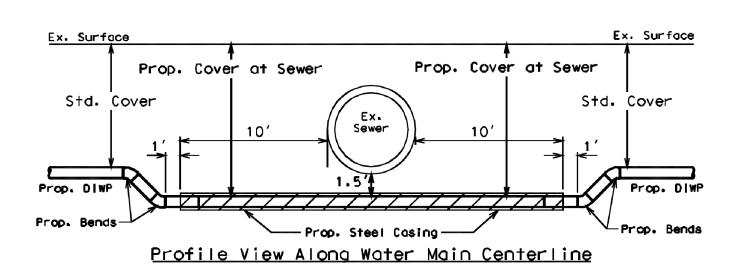

SEWER CROSSING DETAIL A.2 Water Main 6" Above Sewer - Replace Sewer

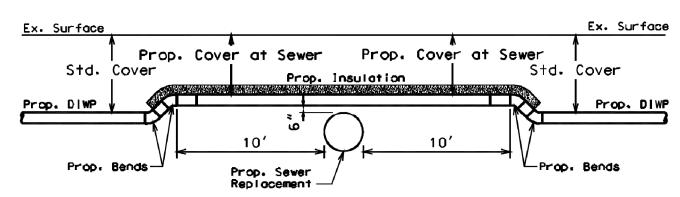


Profile View Along Water Main Centerline

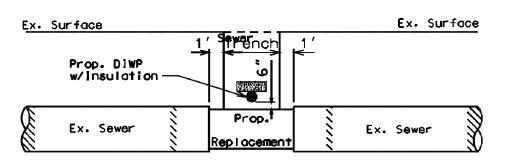


Profile View Along Sewer Centerline




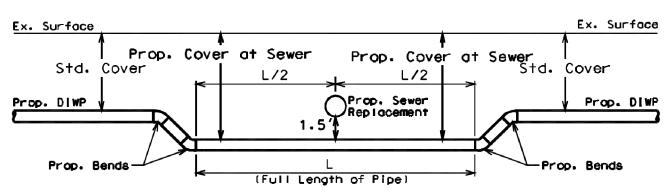


Profile View Along Water Main Centerline

Ex. Surface Ex. Surface

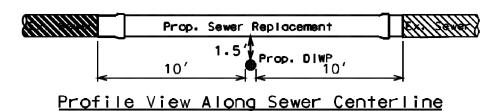

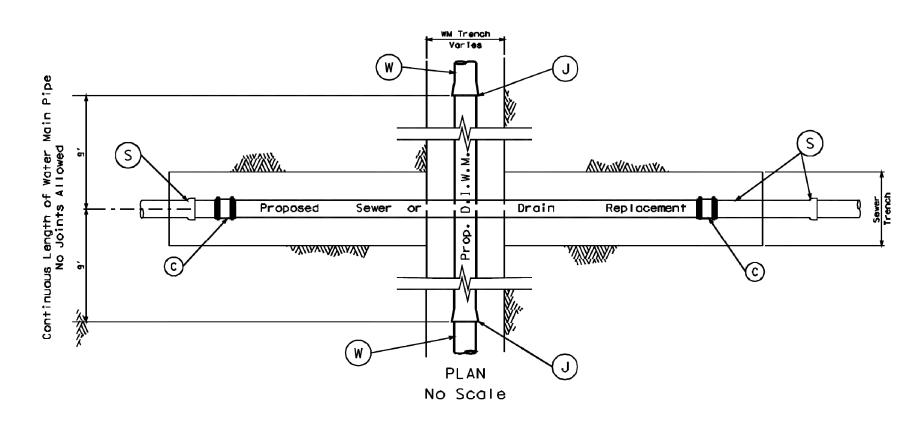

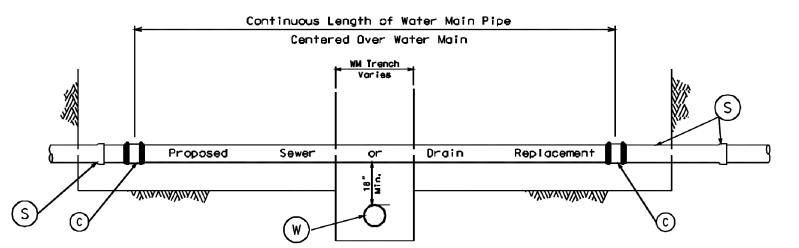

PROFILE THROUGH SEWER/DRAIN
No Scale

GENERAL NOTES

- Replace the sewer/drain in all cases when a water main crosses UNDER the sewer/drain.
- When a water main crosses OVER a sewer/drain, see detail "Water Mains Crossing Over Sewers & House Drains."

KEY TO SYMBOLS

- W Proposed DI Water Main
- Proposed DI Water Main Joint (Continuous Pipe Between Joints)
- S Existing Sewer or House Drain
- R Proposed Sewer/Drain Replacement
- © Proposed ASTM C1173 Flexible
 Transition Coupling for Sewer Piping

'YWW Undisturbed Soil


SEWER/DRAIN REPLACEMENT NOTES

- a. Minimum clearance between the crown of the water main and the invert of the sewer/drain is 18".
- b. Excavate as needed to replace sewer/drain. Brace and shore trenches and excavations as needed to provide safe working conditions and comply with applicable requirements.
- Cut existing sewer/drain to remove section to be replaced; breaking or cracking is not allowed.
- d. Replace the sewer/drain with a continuous length of ductile iron pipe, the same size as the sewer/drain, cut to fit. Reconnect the sewer/drain with ASTM C1173 Flexible Transition Couplings for Sewer Pipe.
- e. Center a length of water main pipe (18' typically) under the sewer/drain crossing.
- f. Backfill using typical standards.
- g. Comply with IL EPA requirements.

WATER MAINS CROSSING UNDER SEWERS & HOUSE DRAINS






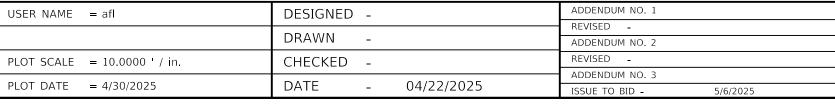

CITY OF CHICAGO
DEPARTMENT OF TRANSPORTATION


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CDWM WATER DETAILS									COOK	50	43
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SCALE:	SHEET 24	OF 2	27 SHEETS	STA.	TO STA.			ILLINOIS FED. AI	D PROJECT		

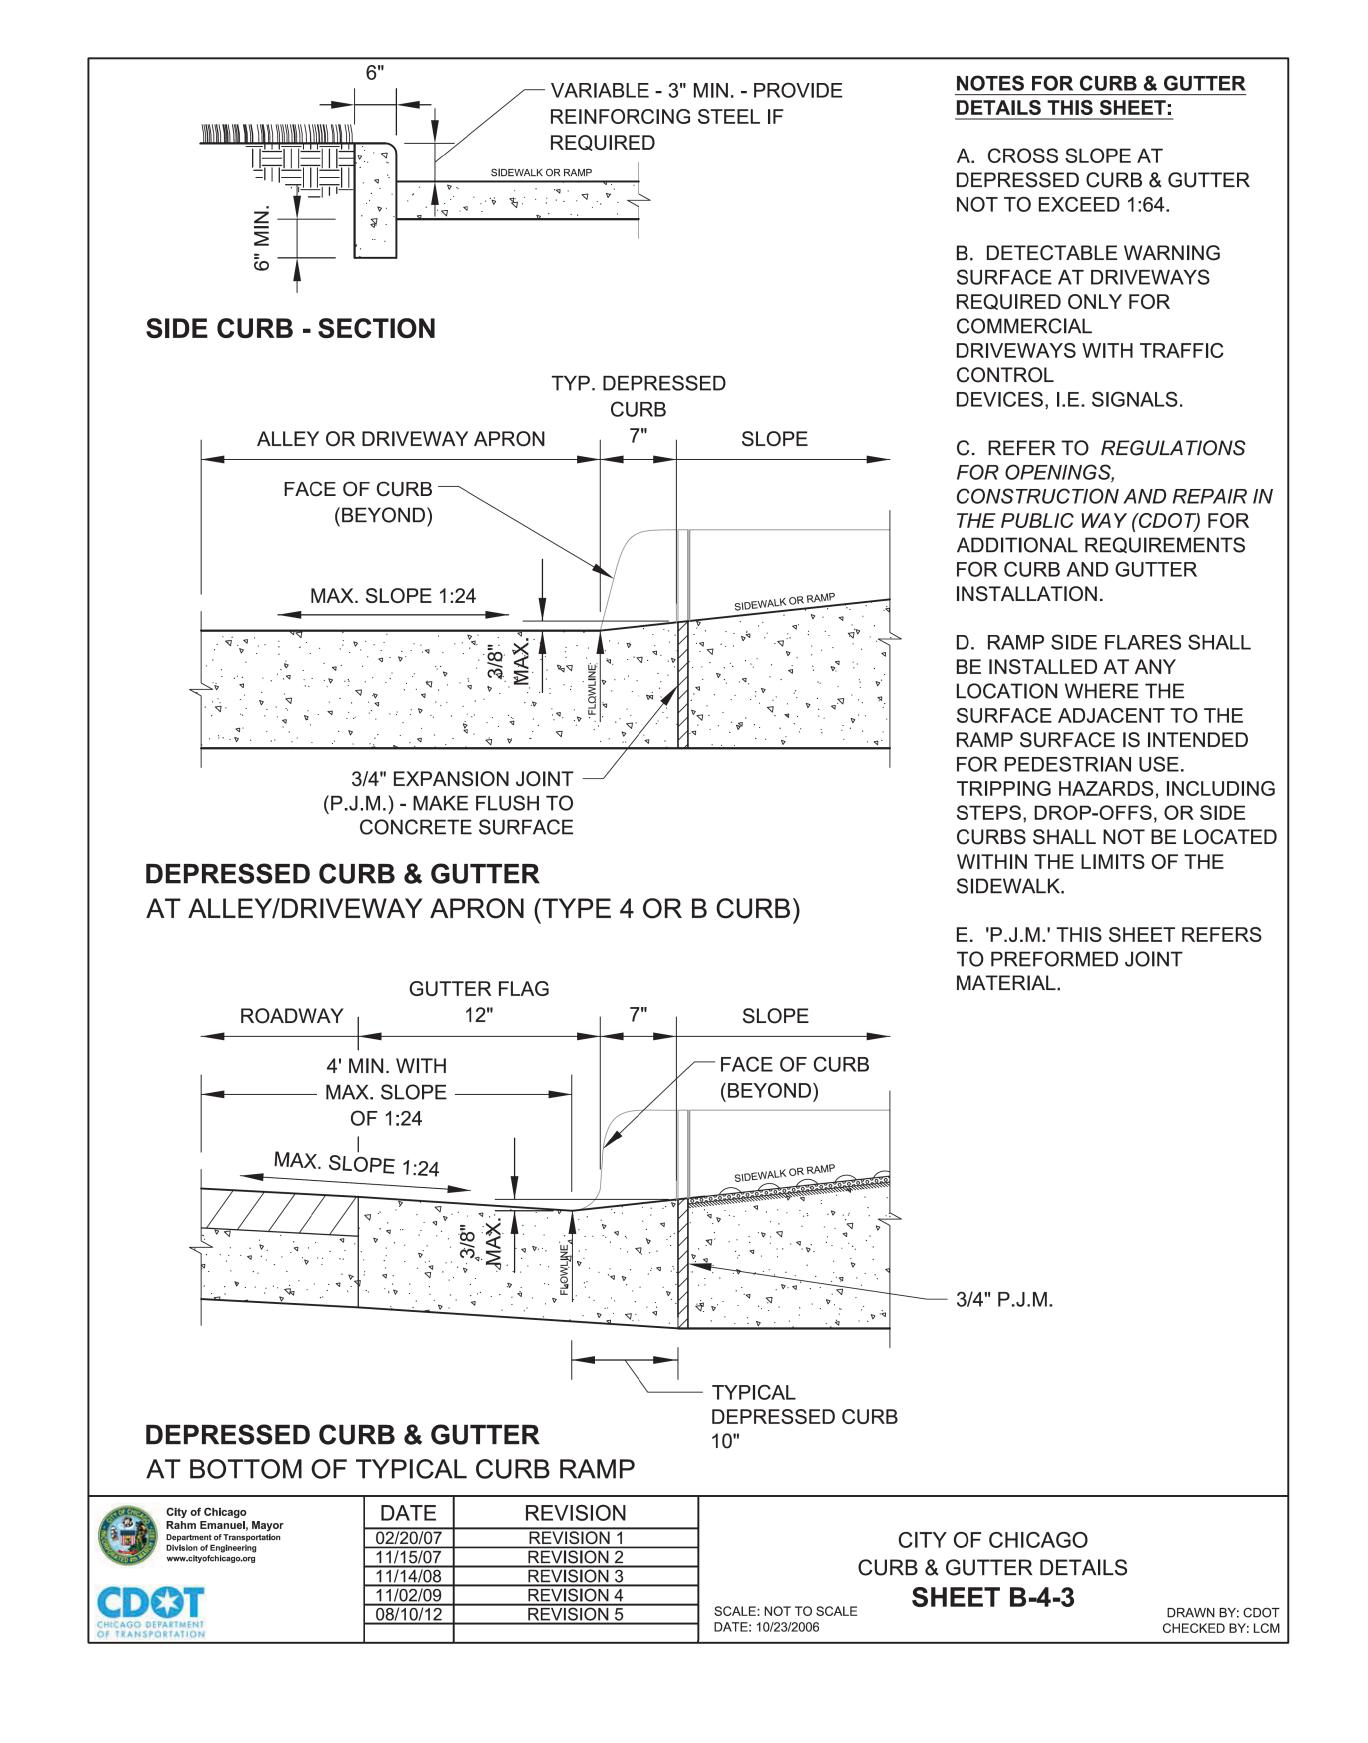



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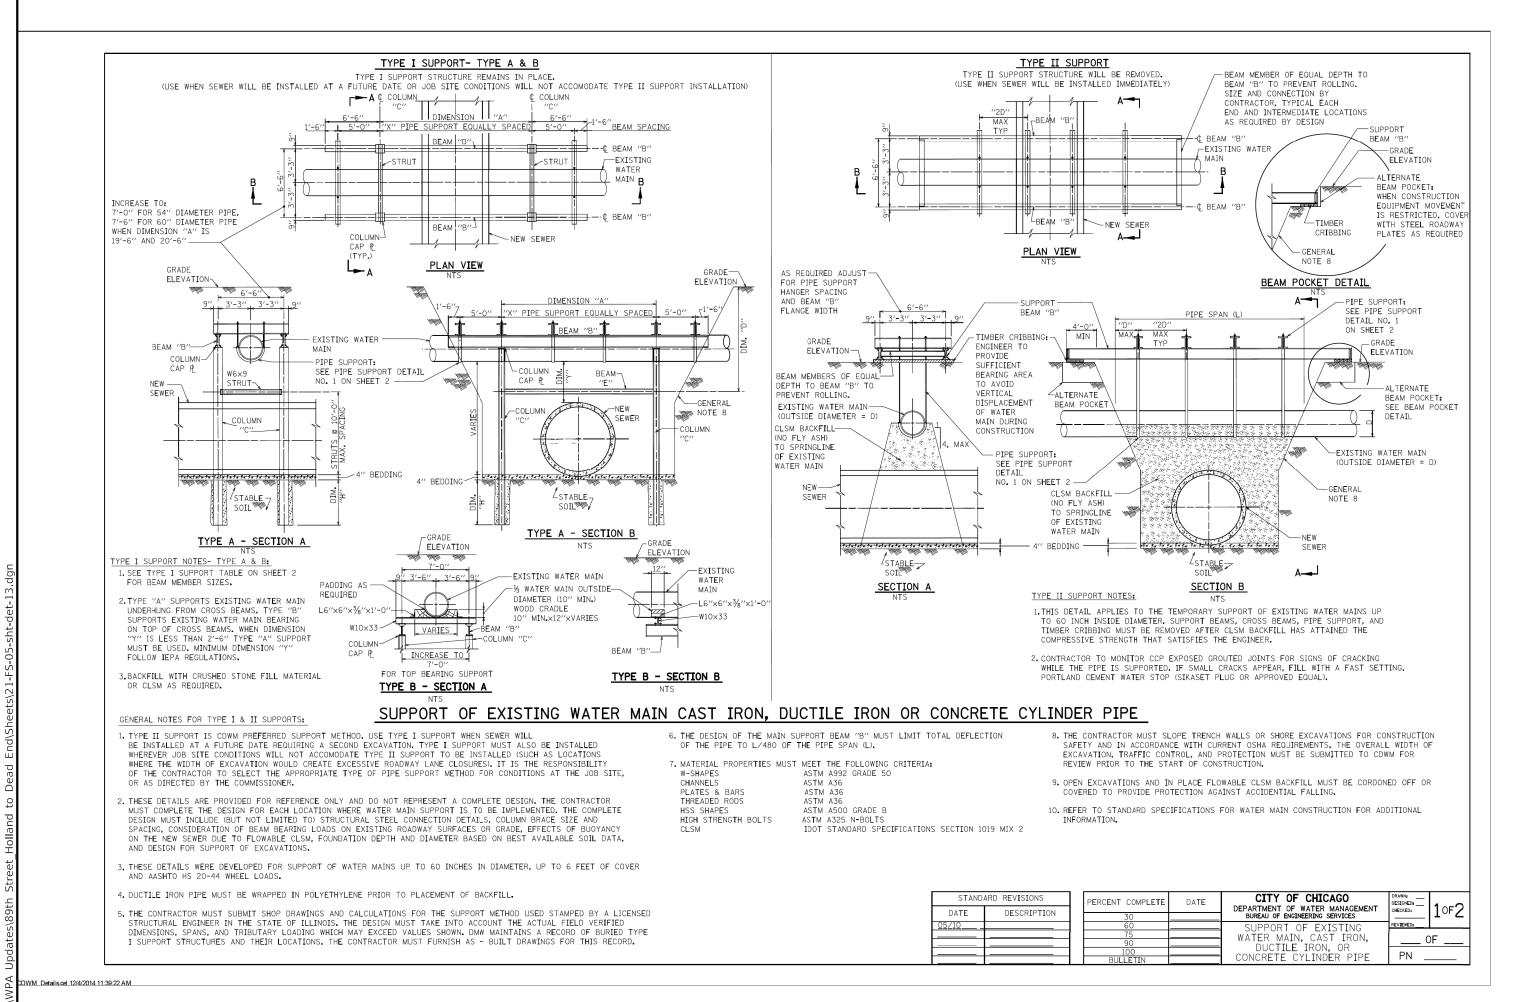
SHEET 26 OF 27 SHEETS STA.


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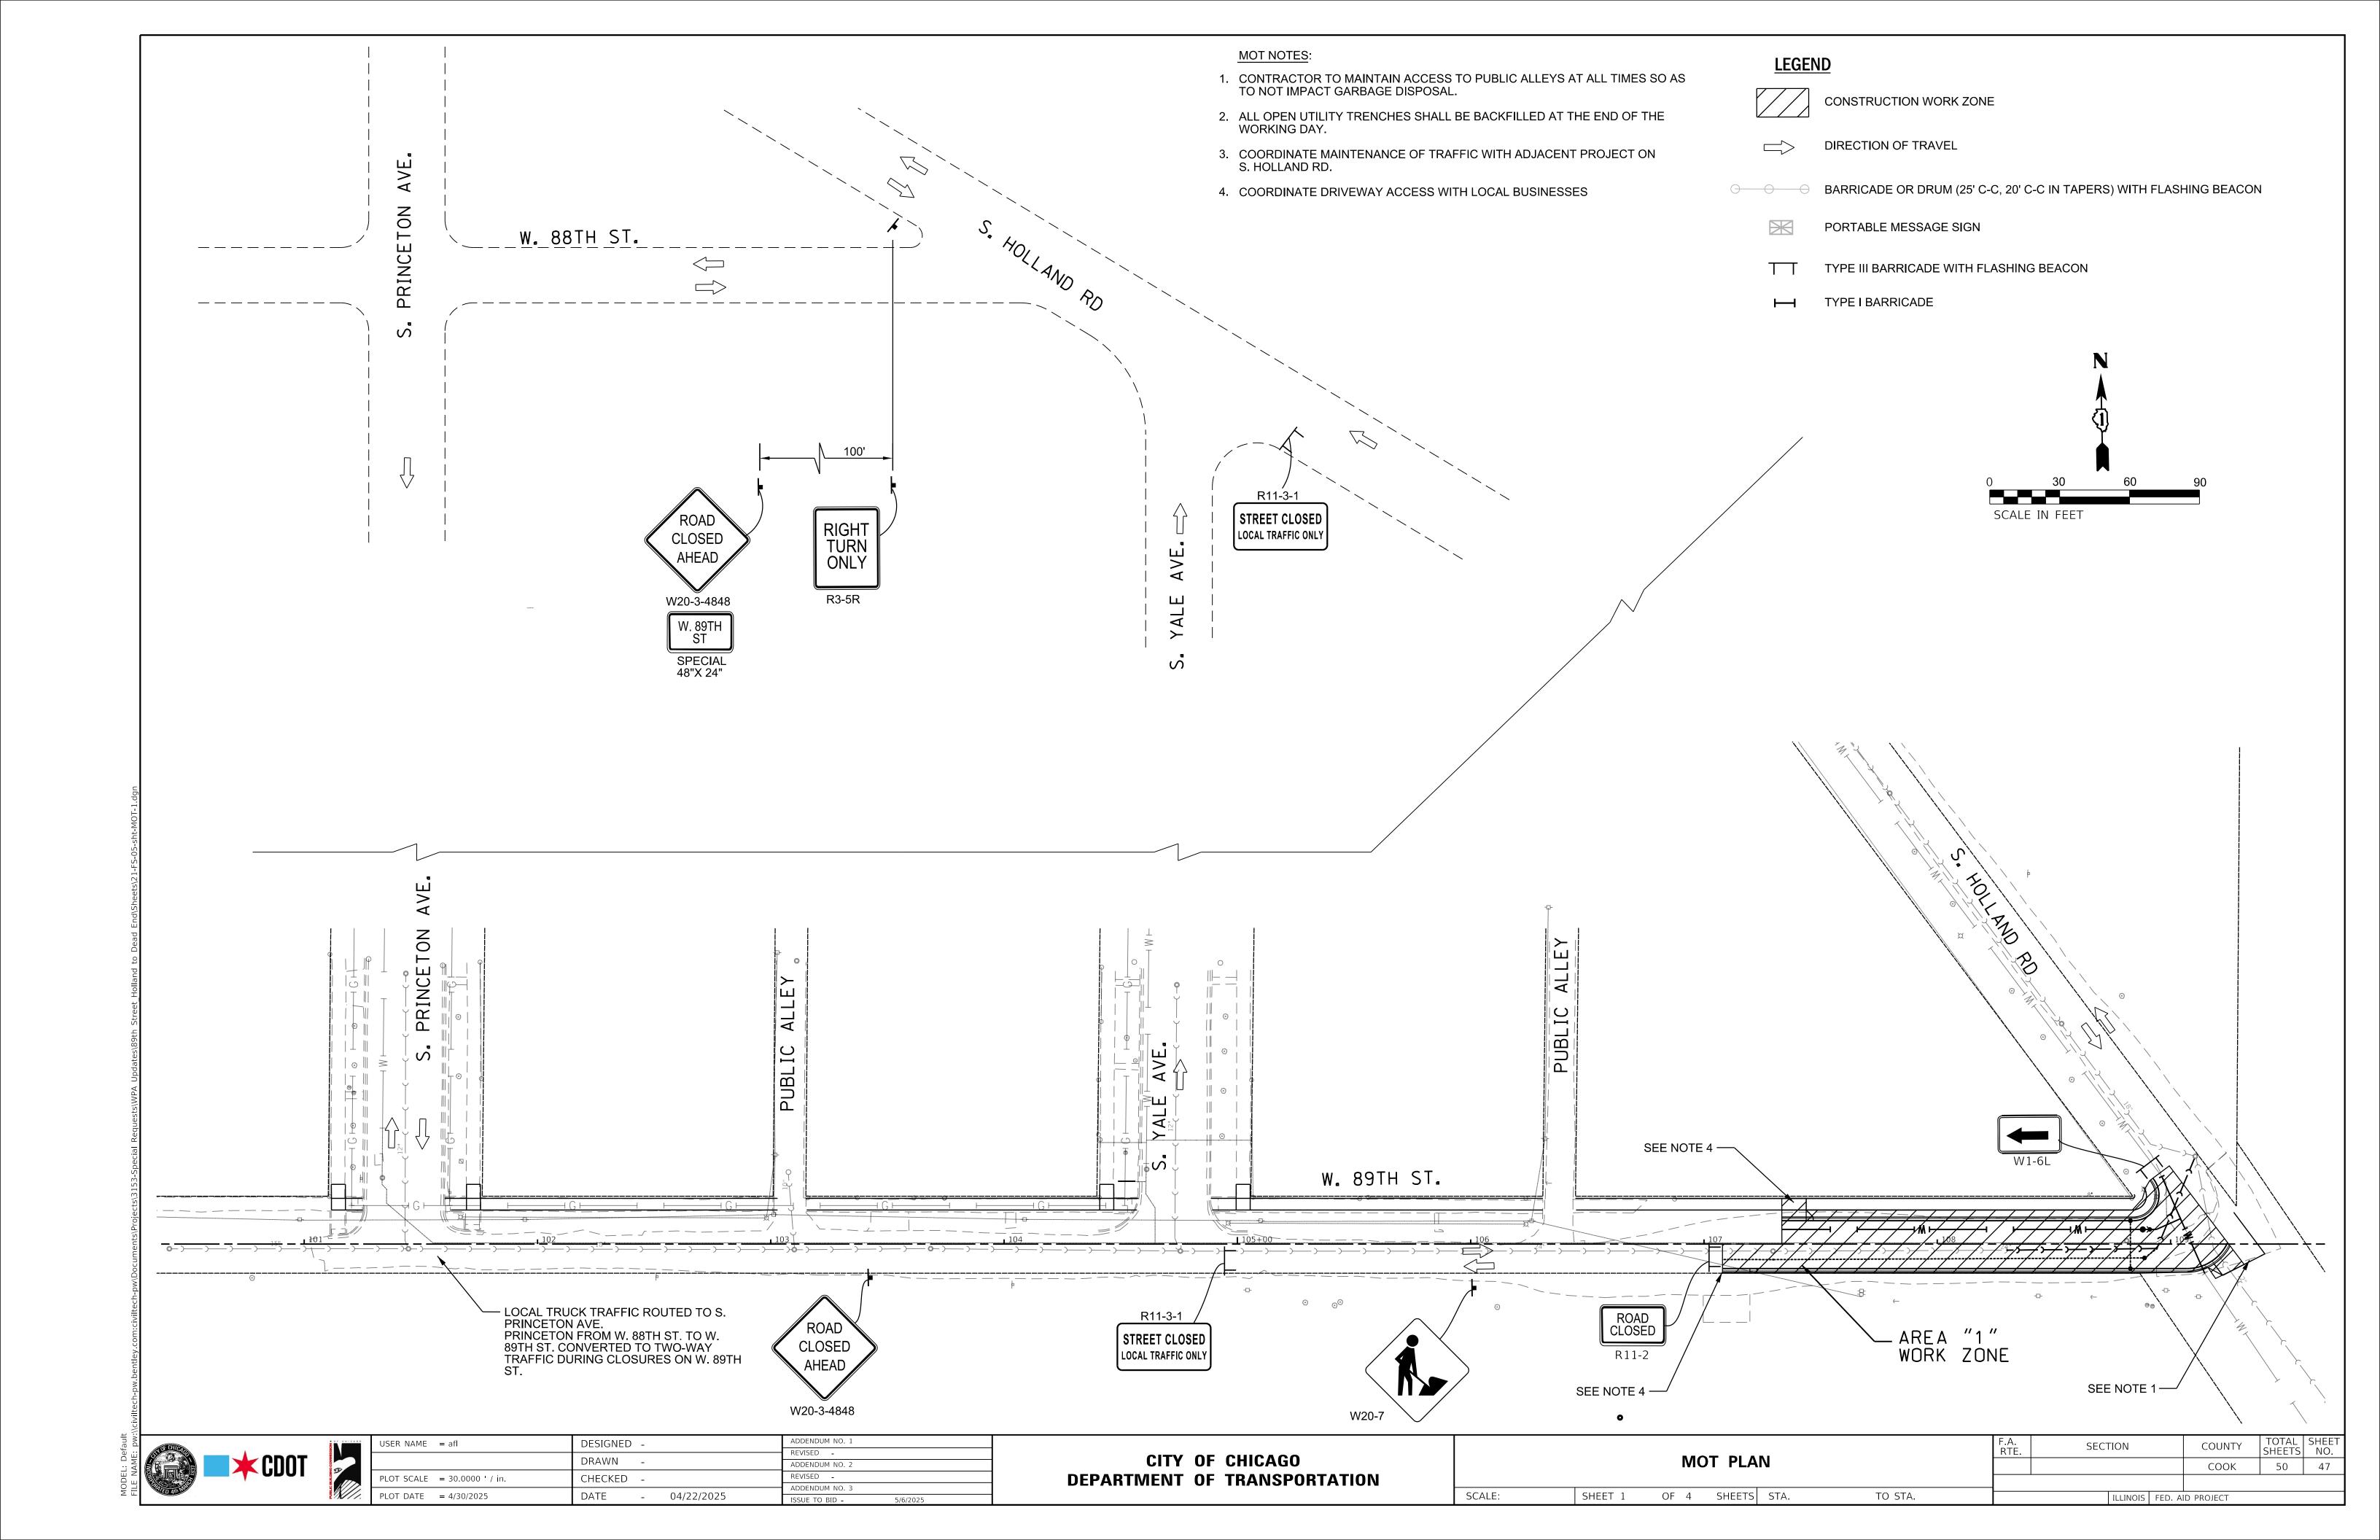


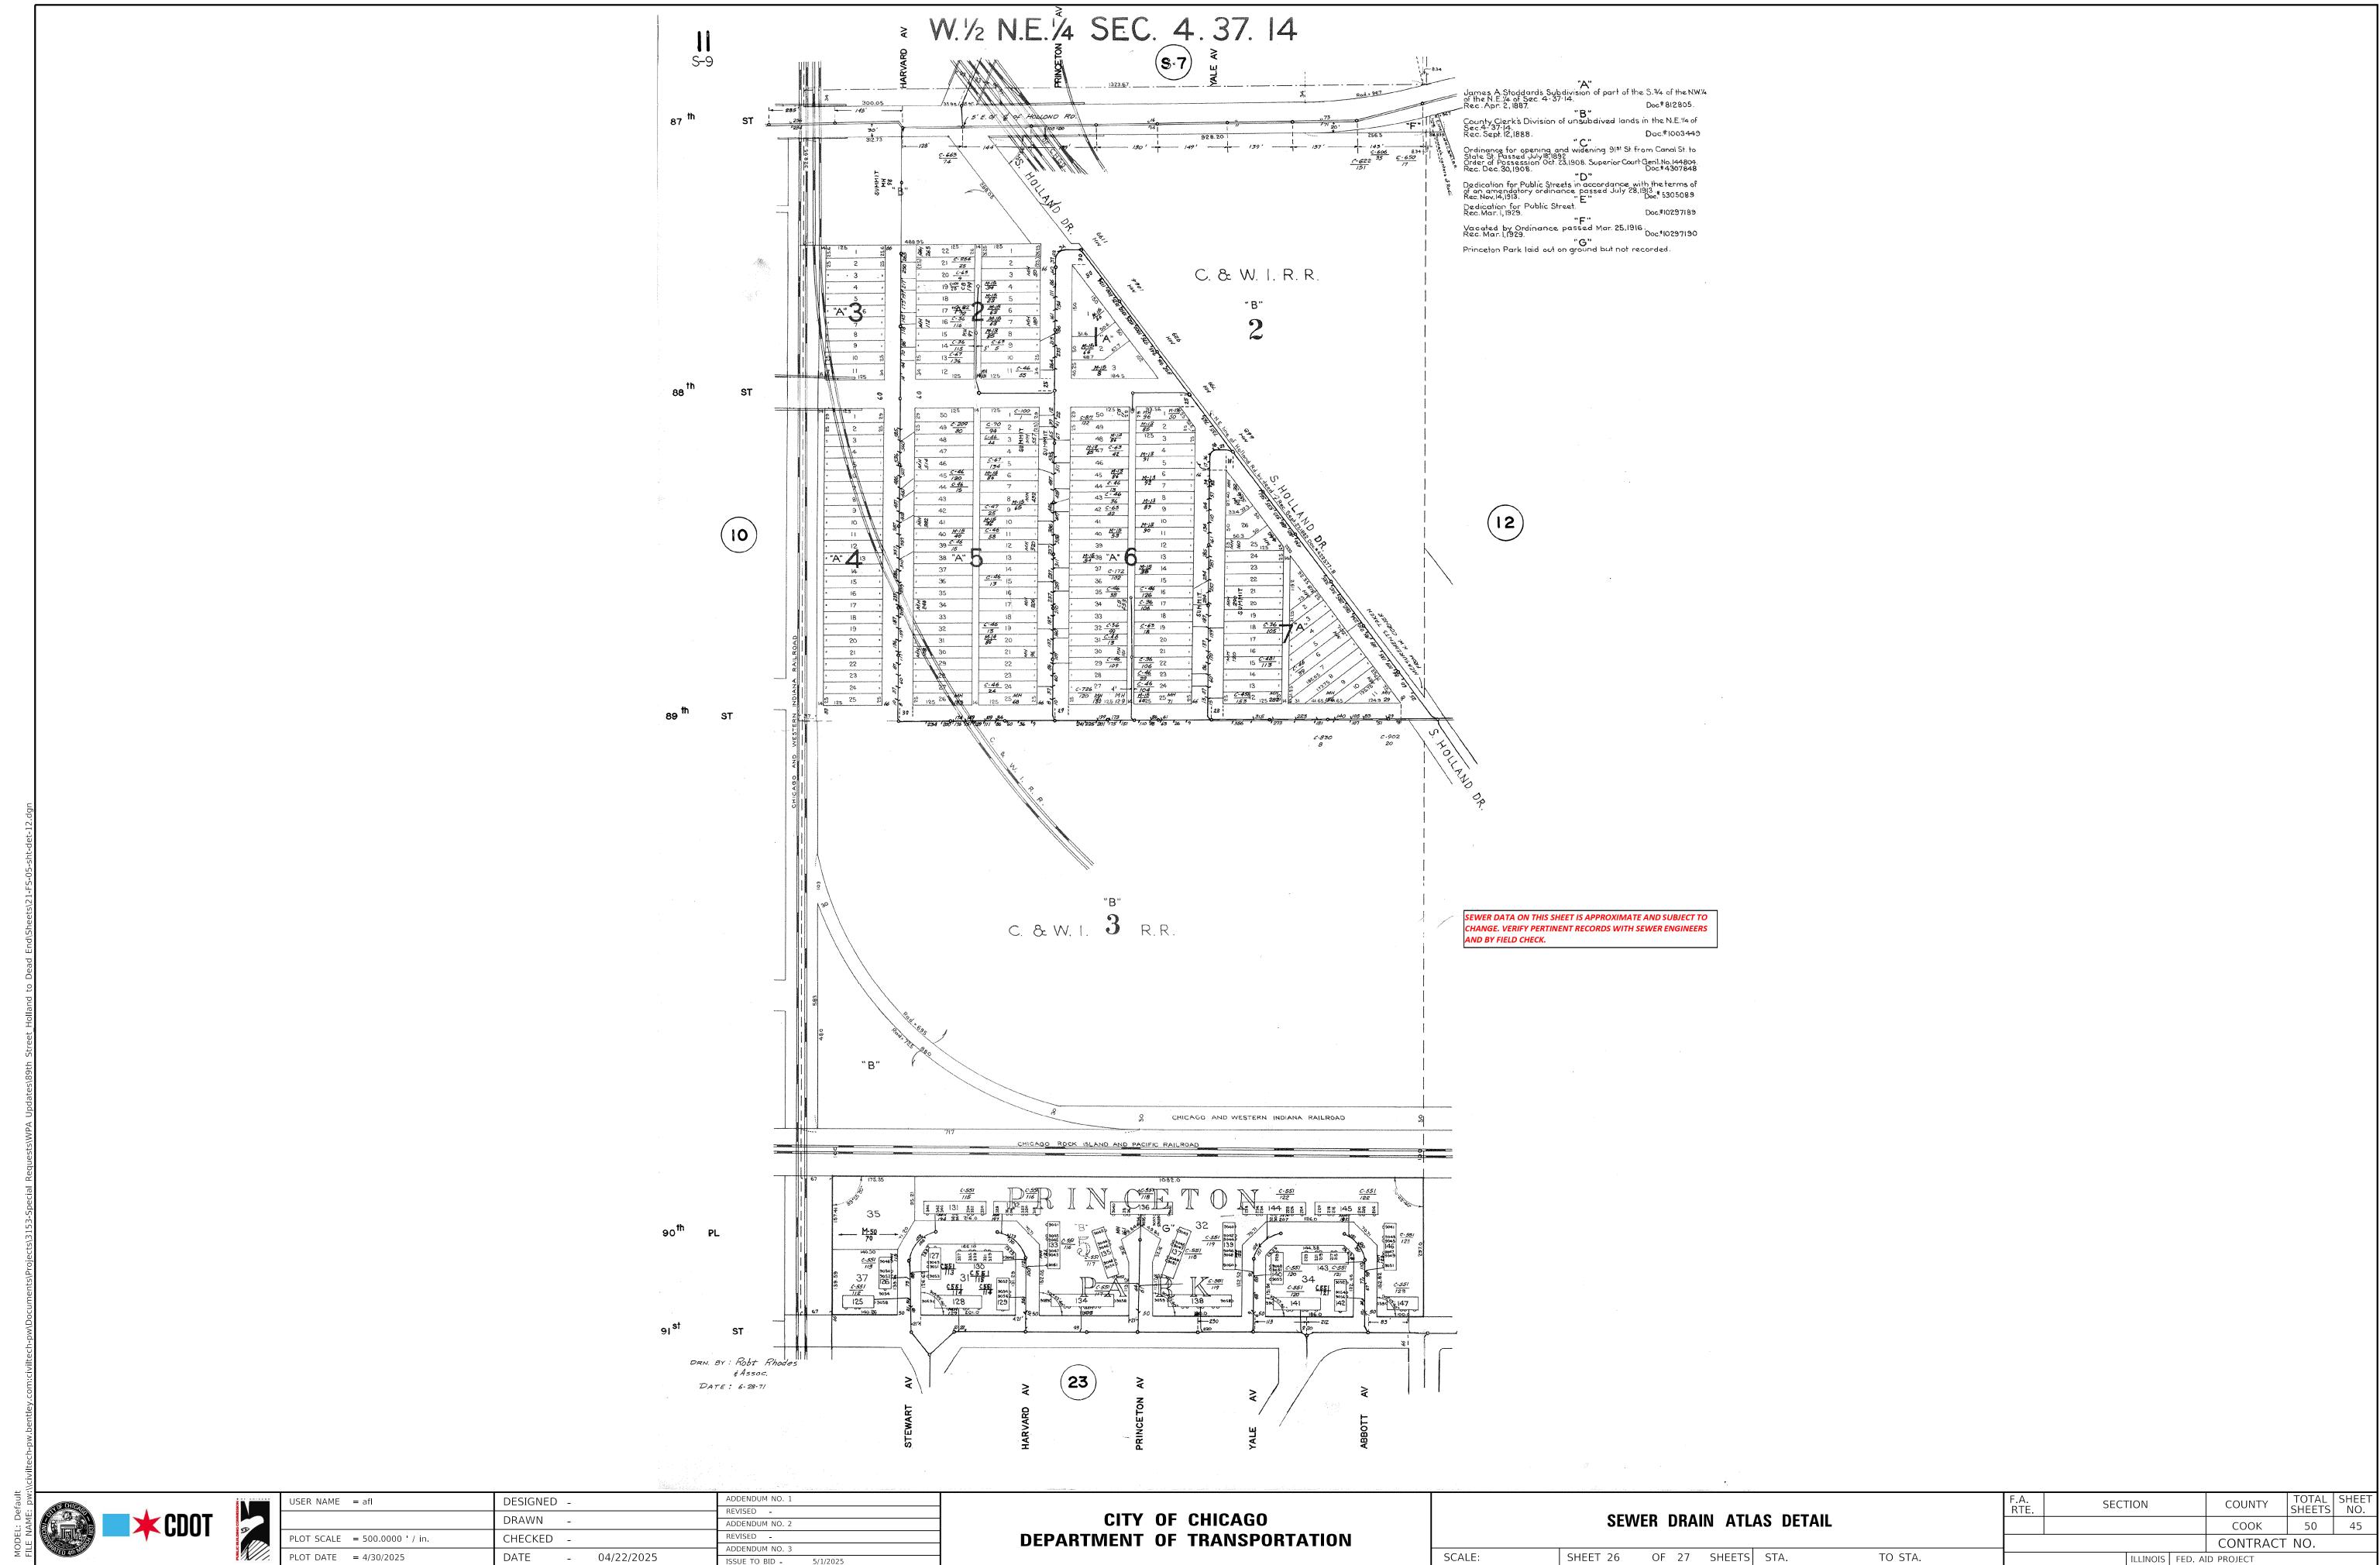


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DEPARTMENT	OF	TRANSPORTATION

WATER MAIN SUPPORT DETAIL		F.A. RTE.	SECTI	ION		COUNTY	TOTAL SHEETS					
		-					COOK	50	46			
	I											
	SHEET 27	OF 27	SHEETS	STA. 0+00	TO STA. 0+00			ILLINOIS F	ED. AII	D PROJECT		



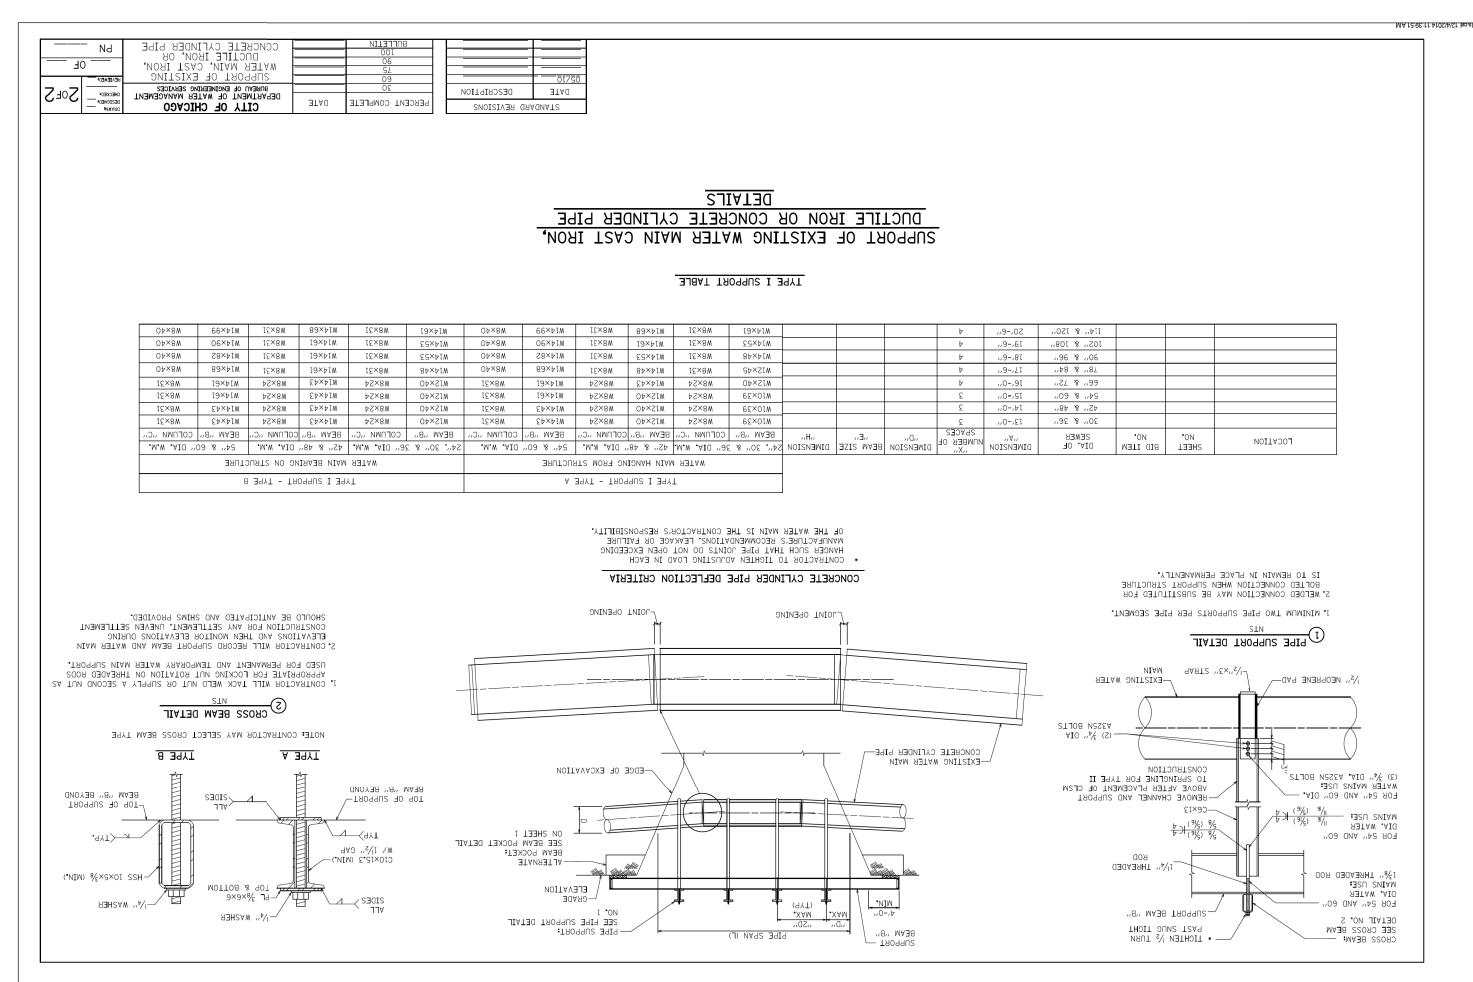
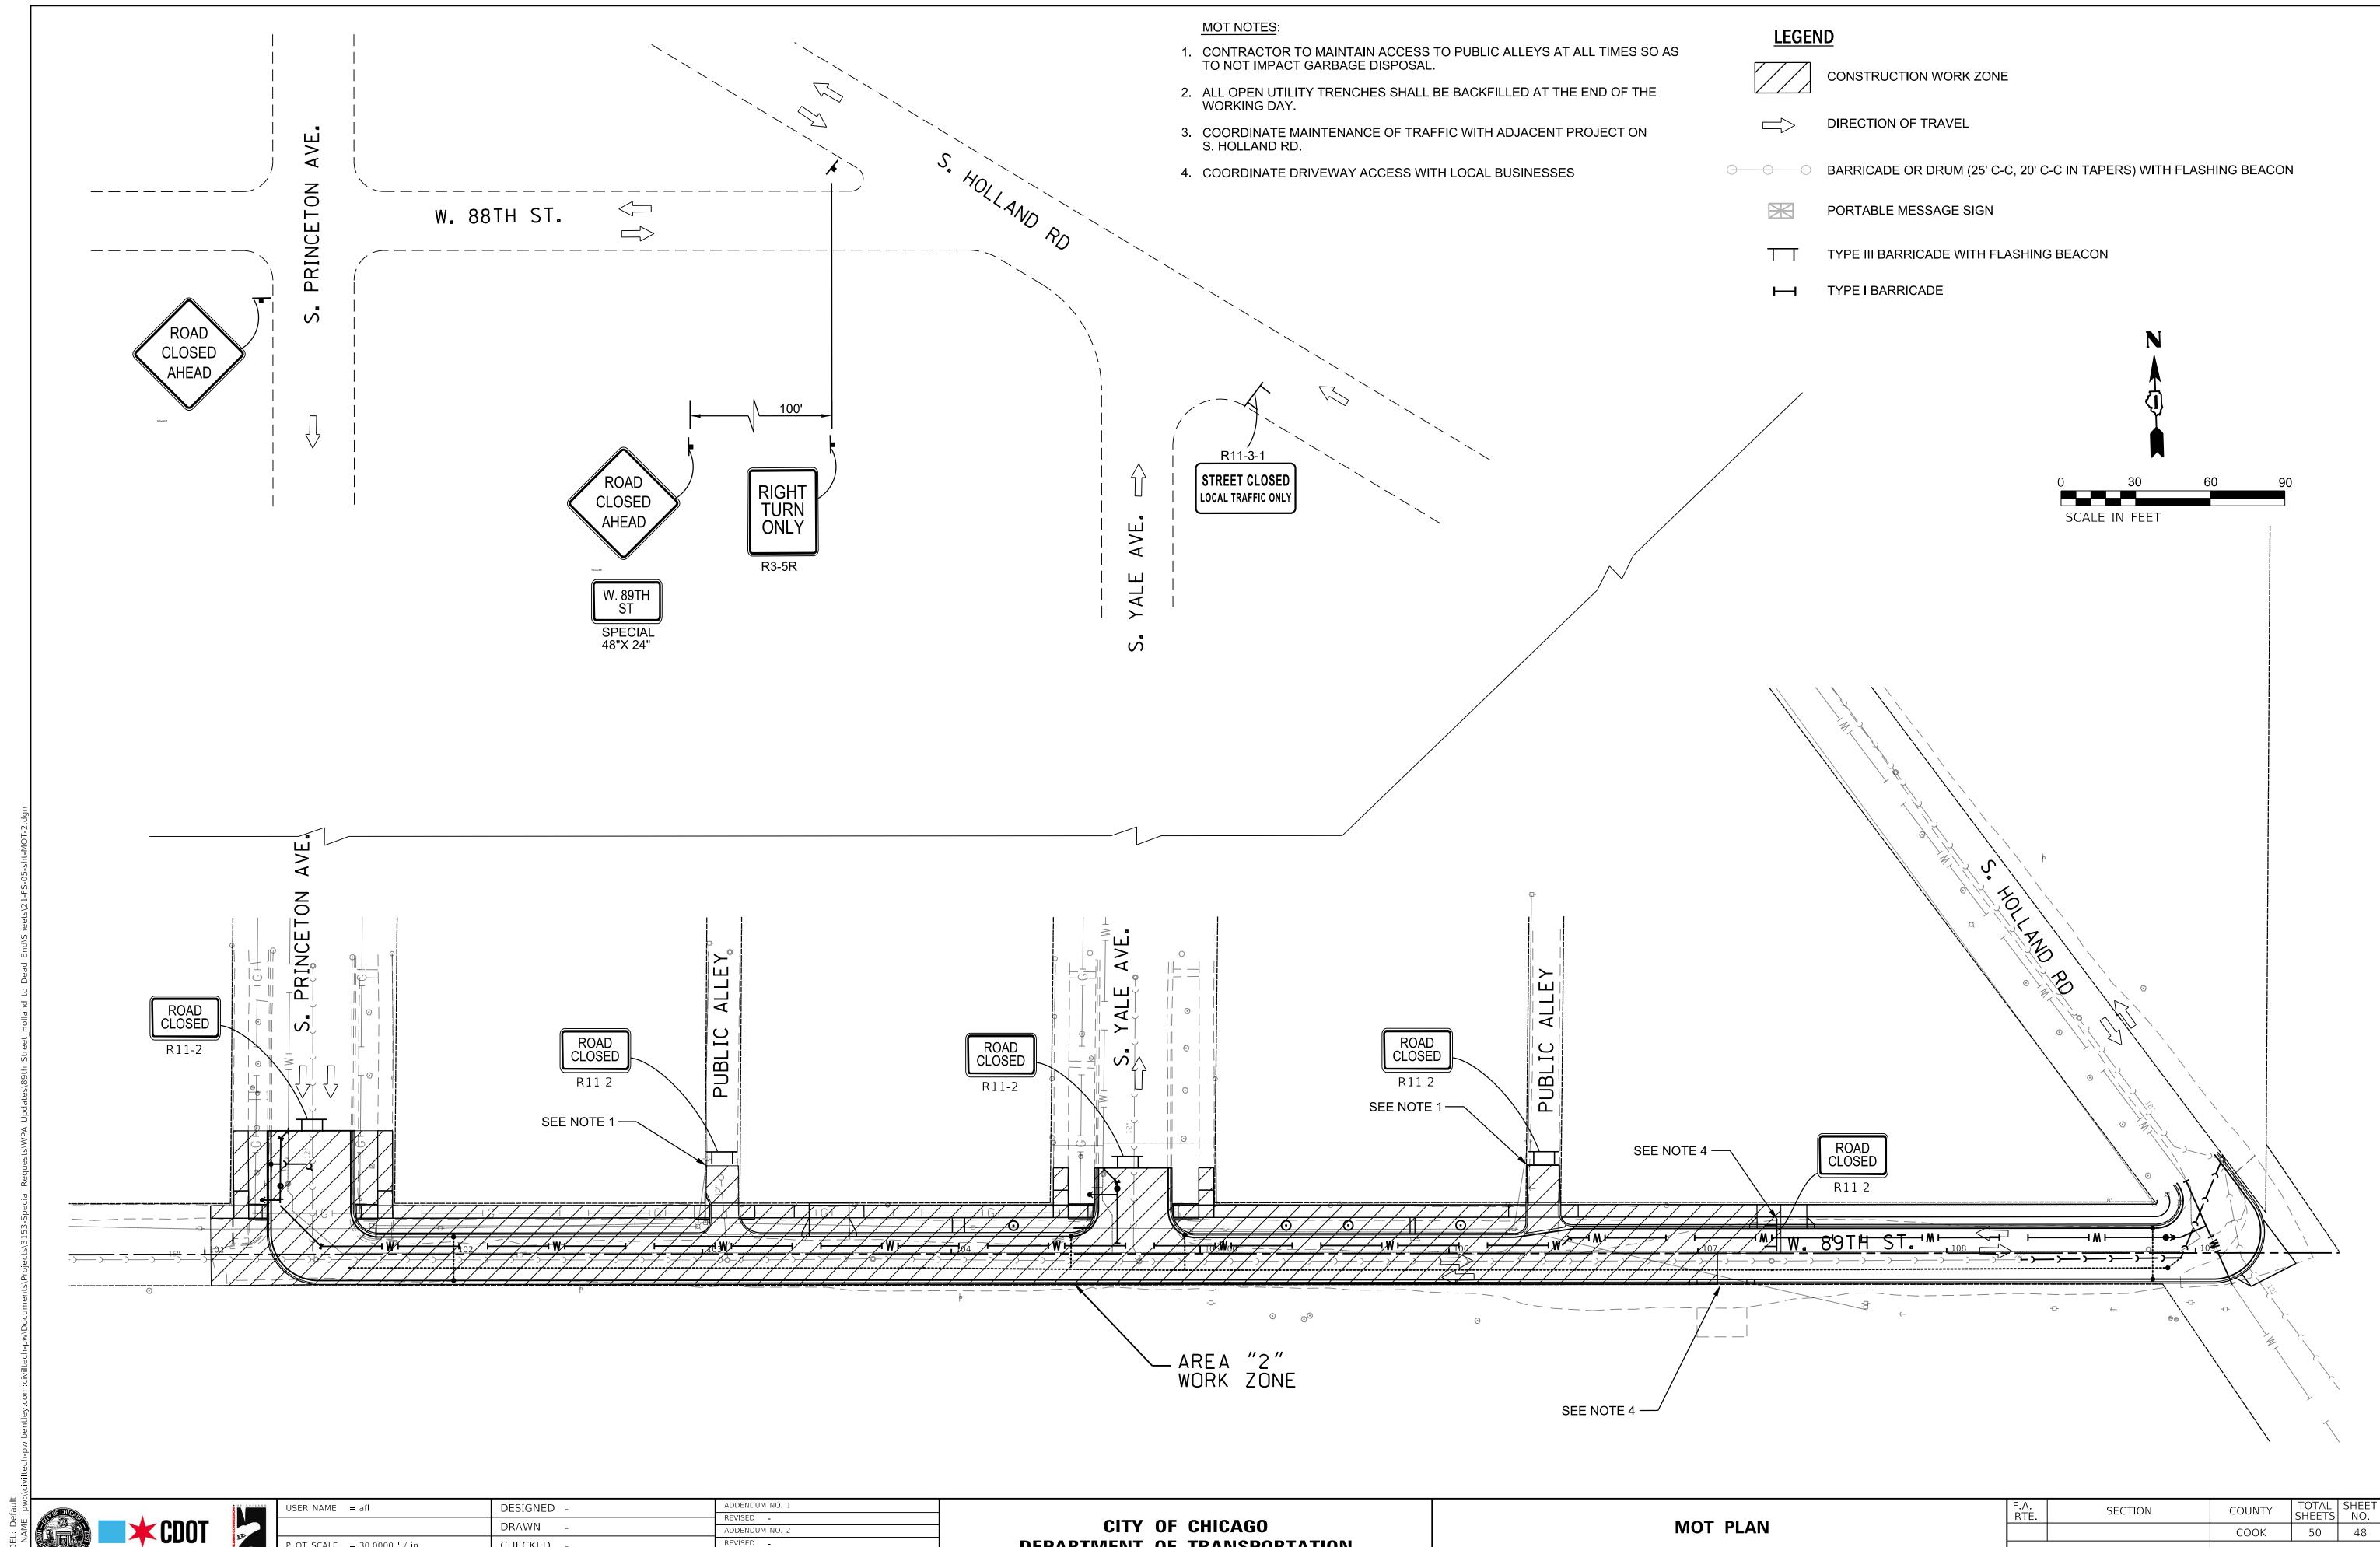
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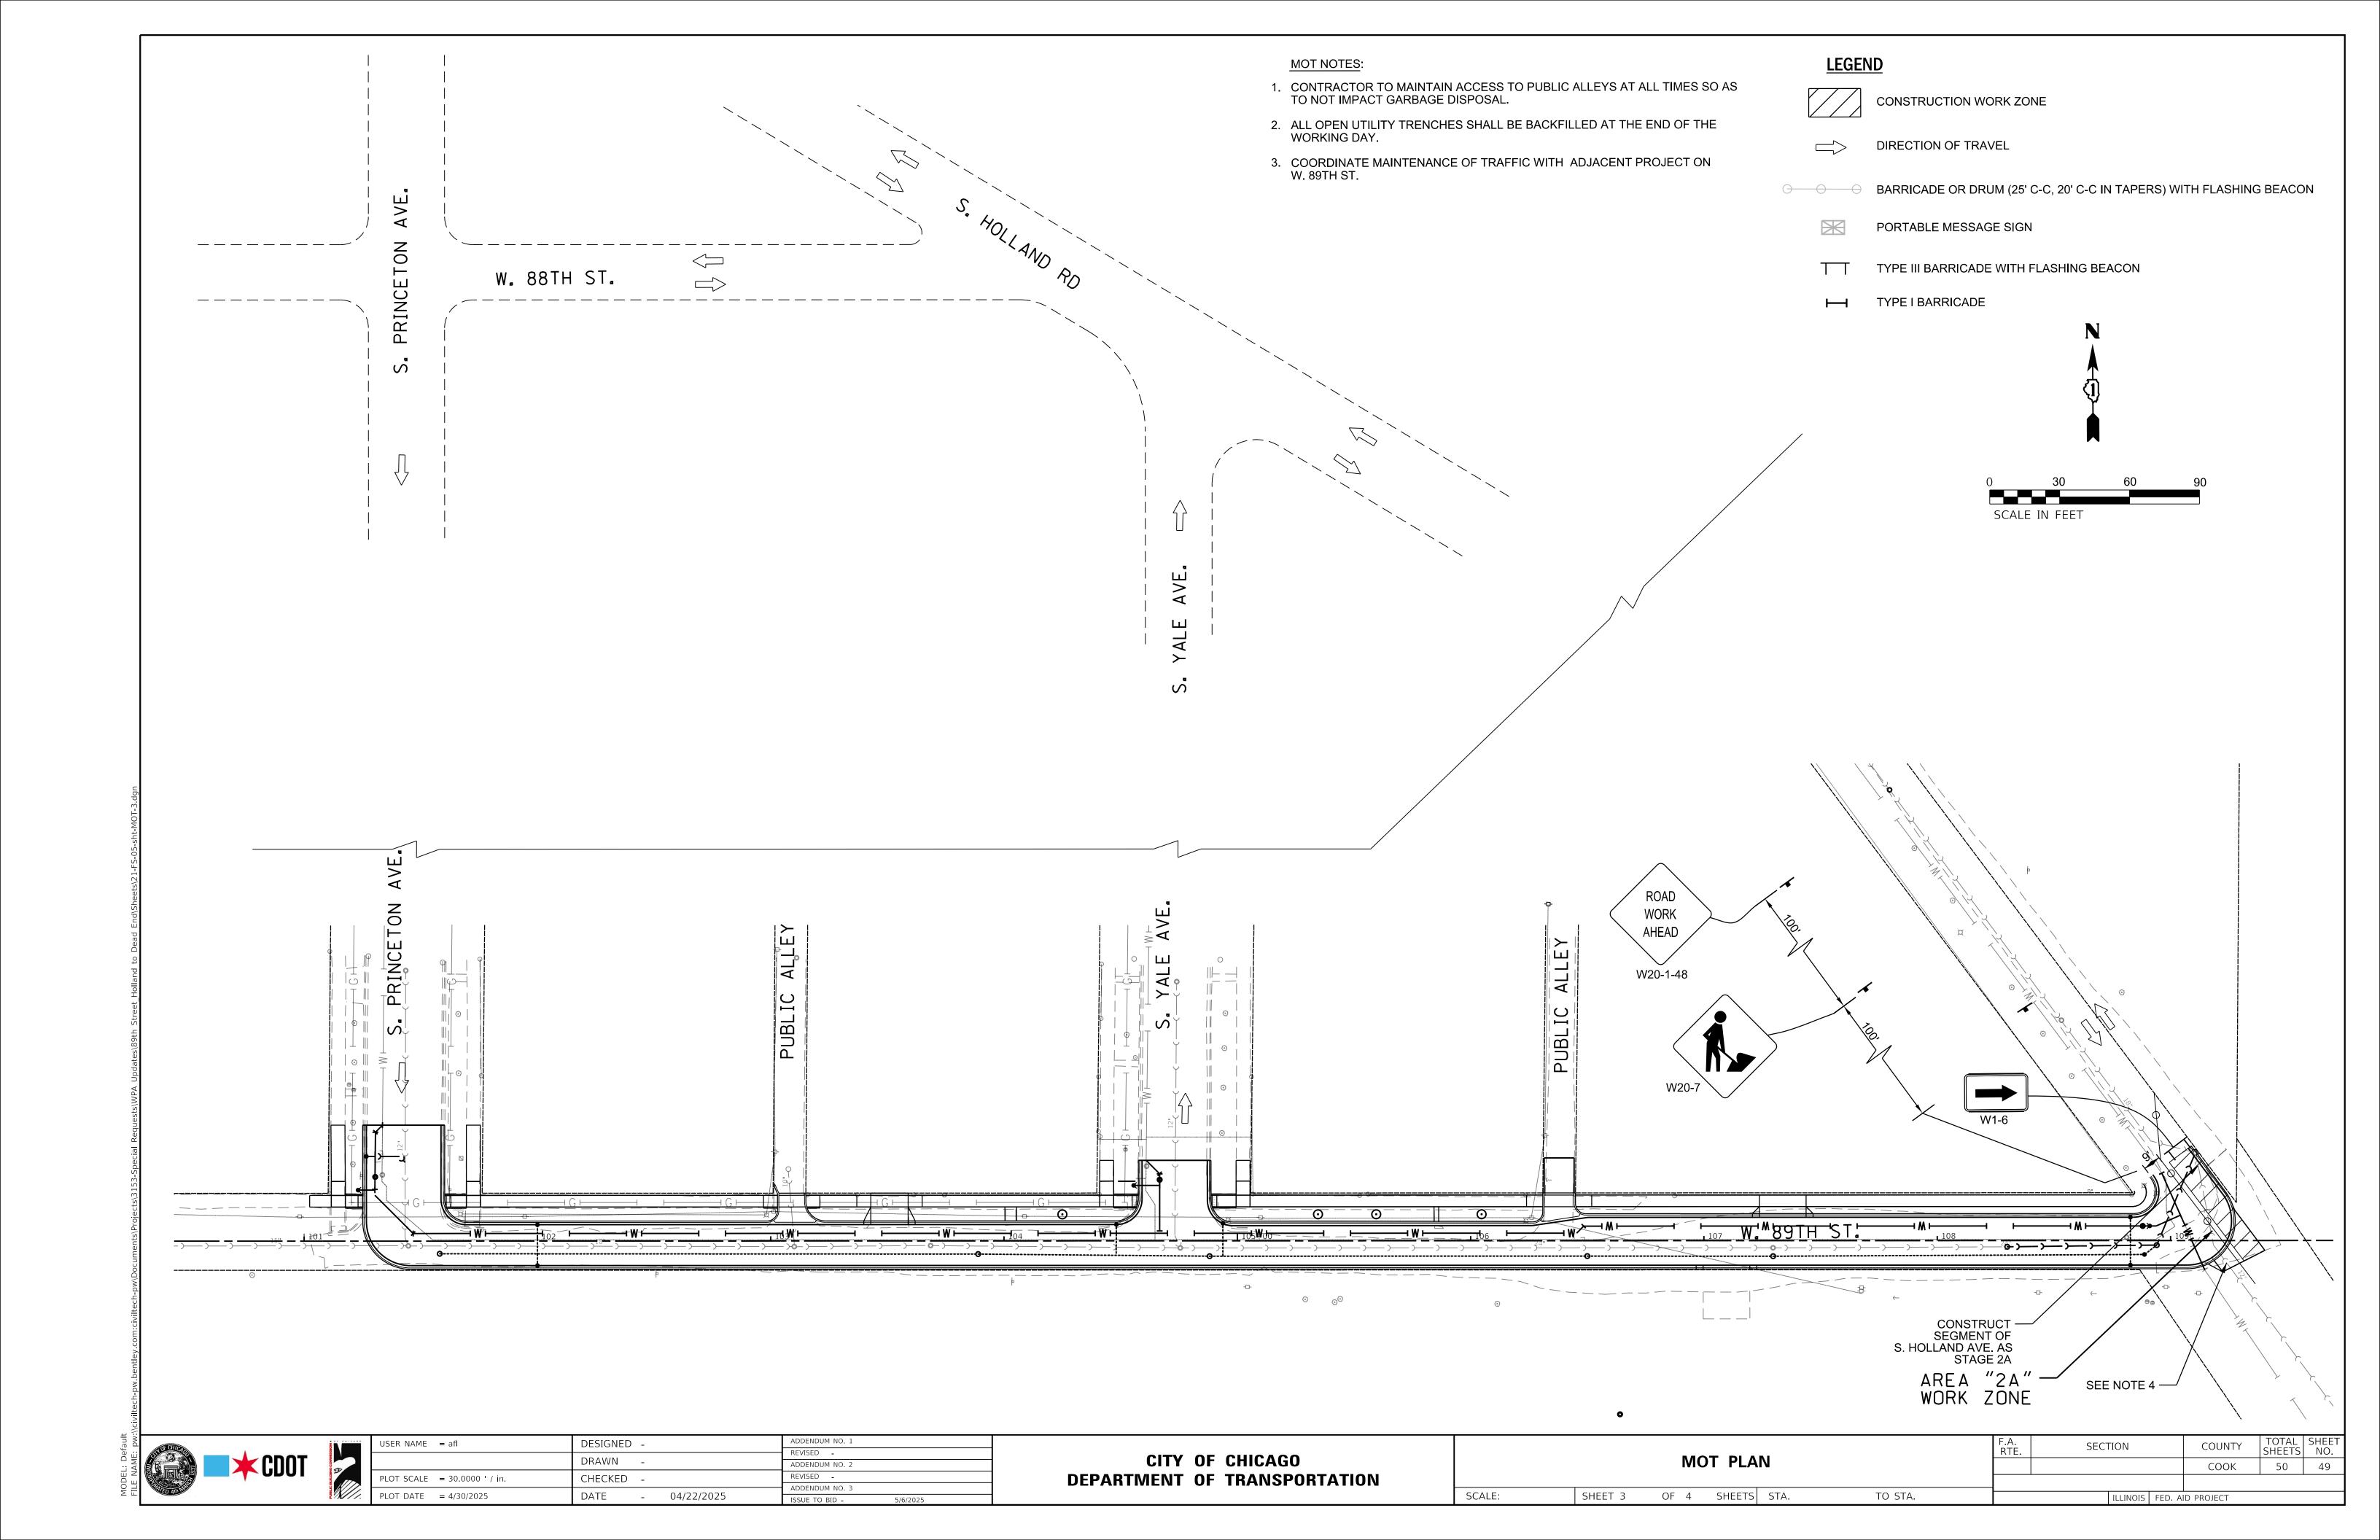
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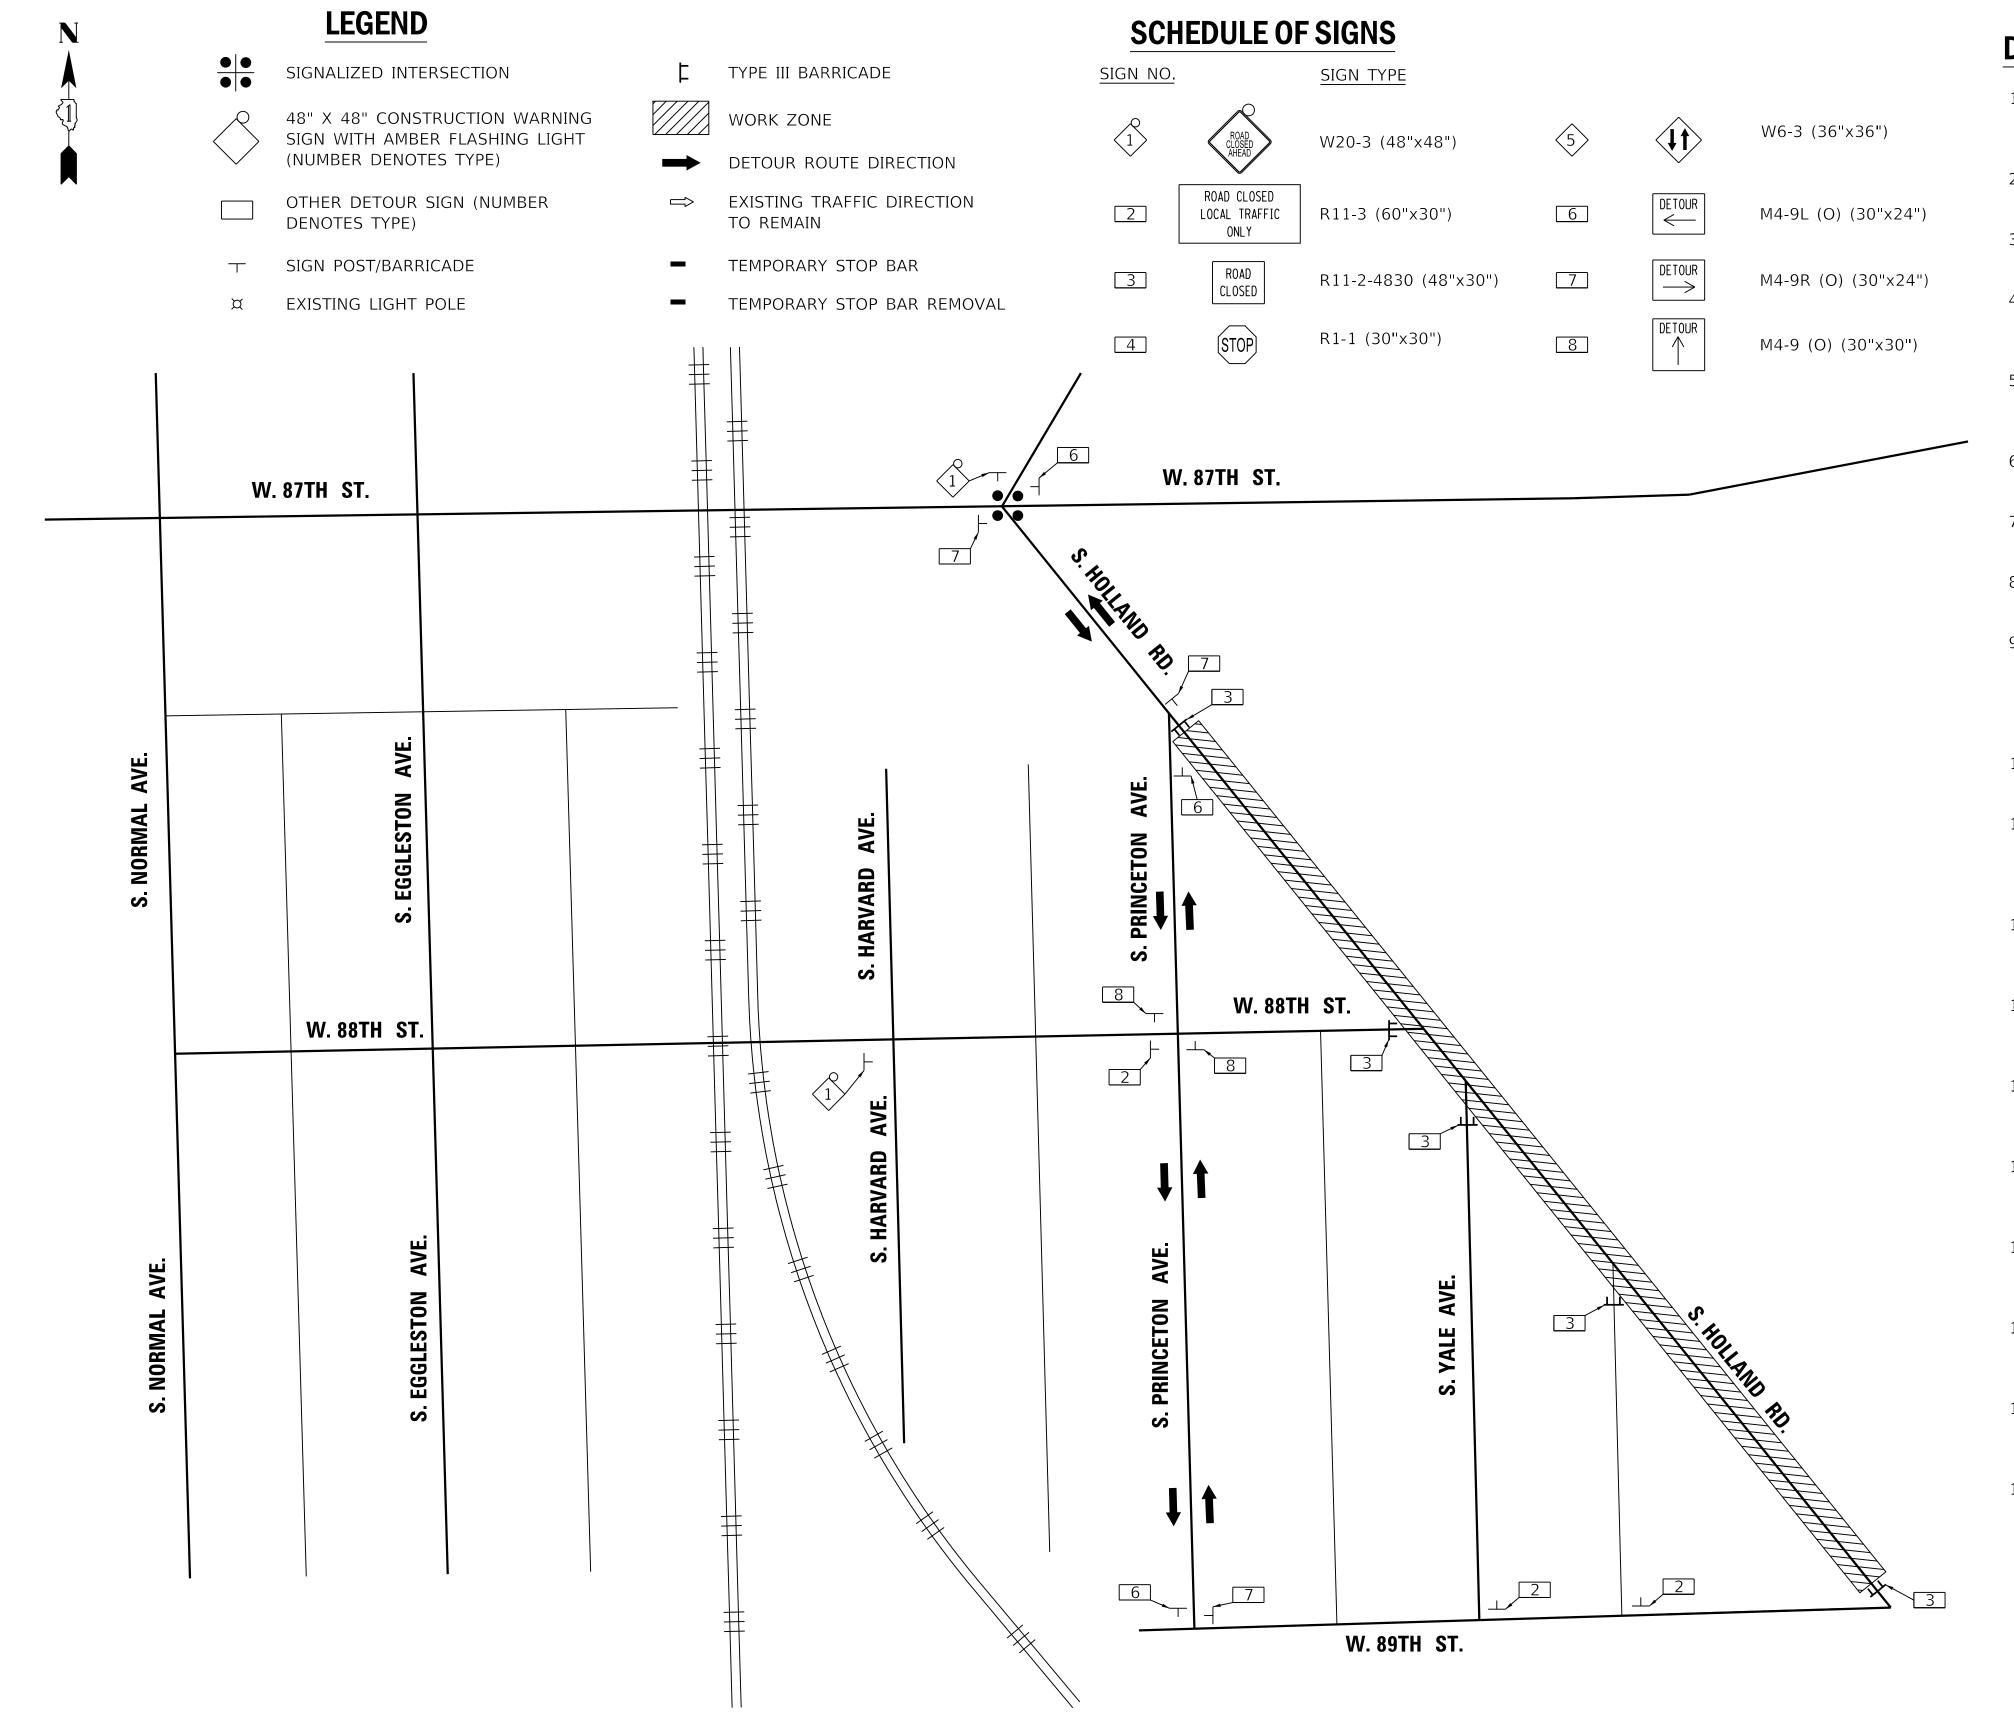
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OF 4 SHEETS STA. TO STA.

ILLINOIS FED. AID PROJECT





DETOUR GENERAL NOTES

- 1. ALL SIGNING SHALL BE IN ACCORDANCE WITH THE APPLICABLE PROVISIONS OF THE STANDARD SPECIFICATIONS, THE DETAILS IN THESE PLANS, THE LATEST EDITION OF THE STATE OF ILLINOIS "MANUAL ON UNIFORM TRAFFIC CONTROL DEVICES," AND AS DIRECTED BY THE ENGINEER.
- 2. THE SIZES OF ALL SIGNS NOT SPECIFIED IN THESE PLANS SHALL BE AS REQUIRED BY THE ILLINOIS "MANUAL ON UNIFORM TRAFFIC CONTROL DEVICES."
- 3. ADDITIONAL SIGNING AND/OR BARRICADES DEEMED NECESSARY BY THE ENGINEER SHALL BE PROVIDED AND INSTALLED AT NO ADDITIONAL COST.
- 4. THE CONTRACTOR SHALL PROVIDE THE ENGINEER WITH THE NAMES AND PHONE NUMBERS OF THEIR REPRESENTATIVES ON THE CONSTRUCTION SITE, AND THEIR REPRESENTATIVE RESPONSIBLE FOR THE DETOUR SIGNING, PRIOR TO THE START OF WORK.
- 5. THE CONTRACTOR SHALL BE RESPONSIBLE FOR THE FIELD LOCATION OF ALL DETOUR AND CONSTRUCTION SIGNING. THE CONTRACTOR MAY REQUEST THE ENGINEER TO FIELD VERIFY THE POSITIONS OF ANY SIGNS.
- ACTUAL LOCATIONS FOR SIGNING SHOWN ON THE DETOUR PLANS MAY BE ADJUSTED TO FIT FIELD CONDITIONS.
- 7. ALL EXISTING SIGNING THAT IS NOT APPLICABLE WHILE THE DETOUR IS IN EFFECT SHALL BE COMPLETELY COVERED BY THE CONTRACTOR IN A MANNER MEETING THE APPROVAL OF THE ENGINEER.
- 8. ALL DETOUR SIGNING SHALL BE POST OR BARRICADE MOUNTED. SIGNS SHALL BE POST MOUNTED WHEN DETOUR EXCEEDS FOUR DAYS AND PER IDOT HIGHWAY STANDARD 701901.
- 9. ALL DETOUR SIGNING EXCEPT REGULATORY SIGNS SHALL HAVE BLACK LEGENDS ON FLUORESCENT ORANGE SHEETING AND STANDARD BLACK BORDERS. THE FLUORESCENT ORANGE REFLECTIVE SHEETING SHALL MEET THE REQUIREMENTS OF ARTICLE 1106.01 OF THE STANDARD SPECIFICATIONS. ALL DETOUR SIGNING SHALL BE NEW OR IN LIKE-NEW CONDITION. THE ENGINEER SHALL BE THE SOLE JUDGE OF THE CONDITION OF THE SIGNS.
- 10. THE ROAD NAME SIGN SHALL BE A BLACK LEGEND ON ORANGE REFLECTIVE SHEETING. THE SIGN BLANK SHALL BE VARIABLE WITH DESIGN SERIES C LETTERS. THE CAPITAL LETTERS SHALL BE 6".
- 11. AT A MINIMUM, ALL AMBER FLASHING LIGHTS THAT ARE REQUIRED FOR THE DETOUR SIGNING SHALL MEET THE REQUIREMENTS FOR TYPE A-LOW INTENSITY FLASHING LIGHTS IN ARTICLE 1106.02 OF THE STANDARD SPECIFICATIONS. ALL LIGHTS SHALL OPERATE DURING HOURS OF DARKNESS. ONLY LIGHTS THAT HAVE BEEN APPROVED BY THE ILLINOIS DEPARTMENT OF TRANSPORTATION SHALL BE USED.
- 12. THE CONTRACTOR SHALL BE RESPONSIBLE FOR ENSURING THAT ALL BARRICADES, SIGNS, LIGHTS AND OTHER DEVICES INSTALLED BY THEM ARE IN PLACE AND OPERATING 24 HOURS EACH DAY, INCLUDING SUNDAYS AND HOLIDAYS.
- 13. THE TYPE III BARRICADES USED AT POINTS OF CLOSURE TO THROUGH TRAFFIC ONLY SHALL NOT EXCEED 8 FEET IN WIDTH EACH FOR A SINGLE APPROACH LANE. ALL BARRICADES AT THESE LOCATIONS SHALL HAVE REFLECTORIZED STRIPING ON THE BACK SIDES OF THE BARRICADES.
- 14. CONSTRUCTION EQUIPMENT SHALL NOT BE PARKED IMMEDIATELY BEHIND THE TYPE III BARRICADES DURING NON-WORKING HOURS. IN ANY EVENT, ARTICLE 701.11 OF THE STANDARD SPECIFICATIONS SHALL APPLY.
- 15. DURING NON-WORKING HOURS THE CONTRACTOR SHALL PROVIDE A MEANS TO RESTRAIN THE TYPE III BARRICADES FROM EASY MOVEMENT BY VANDALS. THE CHOSEN METHOD SHALL BE APPROVED BY THE
- 16. THE CONTRACTOR SHALL BE RESPONSIBLE FOR MAINTAINING THE VISIBILITY OF ALL DETOUR AND CONSTRUCTION SIGNS, INCLUDING BRUSHING BACK VEGETATION IF DEEMED NECESSARY BY THE ENGINEER.
- 17. THE ENGINEER SHALL BE NOTIFIED AT LEAST 24 HOURS BEFORE THE ROAD IS TO BE REOPENED TO BICYCLE TRAFFIC. THE CONTRACTOR WILL CONTACT THE APPROPRIATE LOCAL AGENCIES AND INTERESTED PARTIES.
- 18. ACCESSIBILITY FOR EMERGENCY VEHICLES MUST BE PROVIDED AT ALL TIMES ON CLOSED ROADS. THE CONTRACTOR SHALL MAINTAIN A MINIMUM 10' WIDE DRIVEABLE SURFACE IS AVAILABLE DURING ALL CONSTRUCTION STAGES.
- 19. THE COST OF WORK SHOWN ON THIS SHEET SHALL BE INCLUDED IN THE UNIT PRICE FOR "TRAFFIC CONTROL AND PROTECTION, (SPECIAL)".

NOTES

- 1. EXISTING SIGNS TO BE COVERED OR BAGGED AS NEEDED.
- 2. CONTRACTOR TO MAINTAIN ACCESS TO DRIVEWAYS AT ALL TIMES.
- 3. CONTRACTOR TO COORDINATE GARBAGE/RECYCLING DISPOSAL ACCESS.

ILE NAME: pv		CDOT
FILE N	ATT ATT THE	70001

AGO	USER NAME = tjc	DESIGNED -	ADDENDUM NO. 1			
	·	DDAMM	REVISED -			
4		DRAWN -	ADDENDUM NO. 2			
	PLOT SCALE = 50.0000 ' / in.	CHECKED -	REVISED -			
	DLOT DATE 5/1/2025	DATE 04/22/2025	ADDENDUM NO. 3			
/.	PLOT DATE = $5/1/2025$	DATE - 04/22/2025	ISSUE TO BID - 5/6/2025			

CITY	OF	CHICAGO
DEPARTMENT	OF	TRANSPORTATION

DETOLID DI ANI					F.A. RTE.	SECTION	COUNTY	TOTAL SHEETS		
DETOUR PLAN						COOK	50	50		
	T									
	SHEET 4	OF 4	SHEETS	STA.	TO STA.		ILLINOIS FED). AID PROJECT		