# **STANDARD SYMBOLS**


| ' <u>'</u>                                       |                 |                                       |
|--|-----------------|---------------------------------------|
| <u>EXISTING</u>                                  | <u>PROPOSED</u> | <u>NAME</u>                           |
| $\bigcirc$                                       |                 | CATCH BASIN                           |
|  | $\odot$         | MANHOLE                               |
|  | _               | INLET                                 |
| -0-  | -               | UTILITY POLE                          |
| ¤  | -               | LIGHT POLE                            |
| 6′′ 💿  |                 | EXISTING TREES WITH DIAMETER          |
|  | 6′′፟፟፟፟፟  ✓     | EXISTING TREES TO BE REMOVED          |
| (X.XX)   | x.xx            | ELEVATION                             |
|  | *               | MATCH EXISTING ELEVATIONS             |
|  |                 | PROPERTY LINE                         |
| <del></del>                                      |                 | RIGHT OF WAY LINE                     |
|  | <del></del>     | CENTER LINE                           |
| ======   |                 | CURB OR CURB AND GUTTER               |
| <b>├</b>   |                 | WATER LINE                            |
| ⊢——— G ⊢———                                      | <b></b>         | GAS LINE                              |
| ├─ <del>/</del>                                  | <b></b> /       | ABANDONED GAS                         |
| F0   | ——— F0 ———      | FIBER OPTIC CABLE                     |
| ——— Е ———  | E               | COMMONWEALTH EDISON                   |
|  |                 | CITY ELECTRIC                         |
| т  |                 | TELEPHONE                             |
| <del>,,,,,,,,,,,,,,,,,,,,,,,,,,,,,,,,,,,,,</del> |                 | COMBINED STORM SEWER                  |
| <del></del>                                      |                 | REMOVAL LINEAR ITEMS                  |
|  | <del></del>     | STORM SEWER                           |
| стv  | сту             | CABLE TV                              |
| A  | A               | AERIAL WIRE                           |
|  | Δ Δ             | PORTLAND CEMENT CONCRETE SIDEWALK     |
| / <u> </u>                                       | <b>A</b>        | PORTLAND CEMENT CONCRETE DRIVEWAY     |
|  |                 | PORTLAND CEMENT CONCRETE GARAGE APRON |
|  |                 | PORTLAND CEMENT CONCRETE ENTRANCE     |
|  |                 | HOT MIX ASPHALT RESTORATION           |
|  |                 | FULL DEPTH PAVEMENT RESTORATION       |
|  |                 | RUBBERIZED SPEED HUMP                 |
|  | W///////        | DEDDECKED CUED AND CUETTED            |

DEPRESSED CURB AND GUTTER

# STANDARD ABBREVIATIONS

ASPHALT SPEED HUMP

| СВ  | CATCH BASIN              |
|-----|--------------------------|
| DIP | DUCTILE IRON PIPE        |
| HP  | HIGH POINT               |
| МН  | MANHOLE                  |
| RCP | REINFORCED CONCRETE PIPE |
| ROW | RIGHT OF WAY             |
| RSH | RUBBERIZED SPEED HUMP    |
| ТВМ | TEMPORARY BENCHMARK      |
| VCP | VITRIFIED CLAY PIPE      |

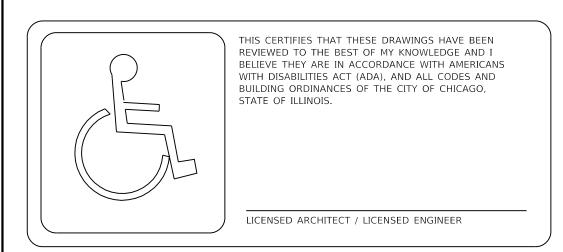

PRIOR TO CONSTRUCTION, THE CONTRACTOR IS REQUIRED TO CALL THE CHICAGO UTILITY ALERT NETWORK (DIGGER/CHICAGO811) AT 312-744-7000 FOR UNDERGROUND UTILITY LOCATIONS.

# STATE OF ILLINOIS CITY OF CHICAGO

**BRANDON JOHNSON, MAYOR** 

# PUBLIC BUILDING COMMISSION

RAY GIDEROF, EXECUTIVE DIRECTOR

# DEPARTMENT OF TRANSPORTATION

CRAIG TURNER, ACTING COMMISSIONER

# **CONTRACT PLANS**

**FOR** 

# PROPOSED IMPROVEMENTS


W. GREENLEAF AVENUE/W. LUNT AVENUE

N. GLENWOOD AVENUE/N. SHERIDAN ROAD

PBC CONTRACT NO.: C1627 CDOT PROJECT NO.: U-5-241 PBC PROJECT NO.: 22926

ISSUED FOR BID: 07/10/2025

CSR NO.: 2306863647

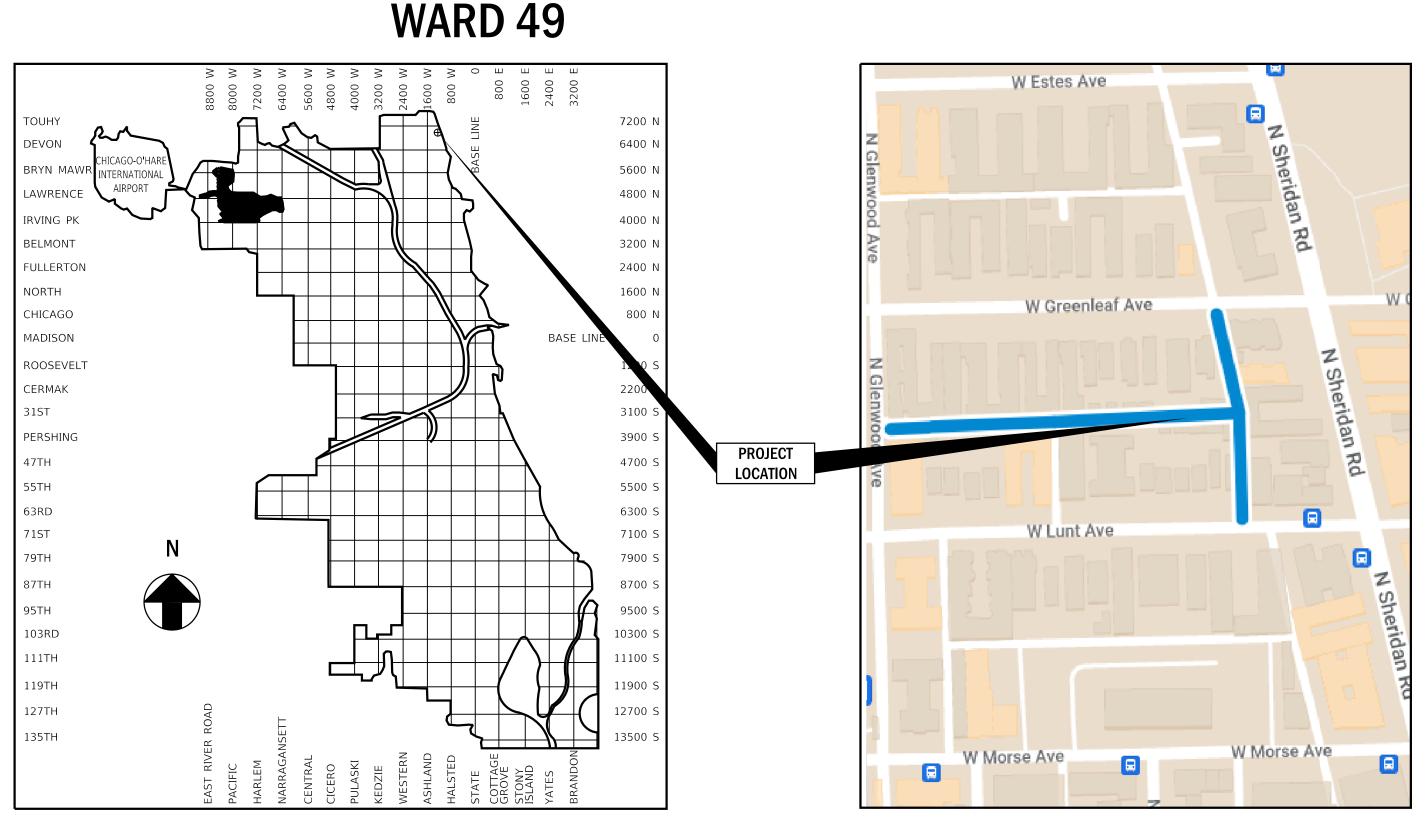



| <u>SHEET</u> | DESCRIPTION                        |
|--------------|------------------------------------|
| 1            | COVER SHEET                        |
| 2            | ALIGNMENT TIES AND BENCHMARKS      |
| 3            | GENERAL NOTES                      |
| 4            | SUMMARY OF QUANTITIES              |
| 5            | PROPOSED CONDITIONS PLAN VIEW      |
| 6-9          | PLAN AND PROFILE                   |
| 10           | ALLEY APRON DETAILS                |
| 11           | TYPICAL SECTIONS                   |
| 12-17        | CDOT STANDARD CONSTRUCTION DETAILS |
| 19-21        | CDWM STANDARD CONSTRUCTION DETAILS |
| 23-24        | IDOT STANDARD DETAILS              |




• OF CHICAGO




**LOCATION MAP** 

**INDEX MAP** 

LENGTH OF IMPROVEMENT = 1088.6 L.F. (0.21 MILES)

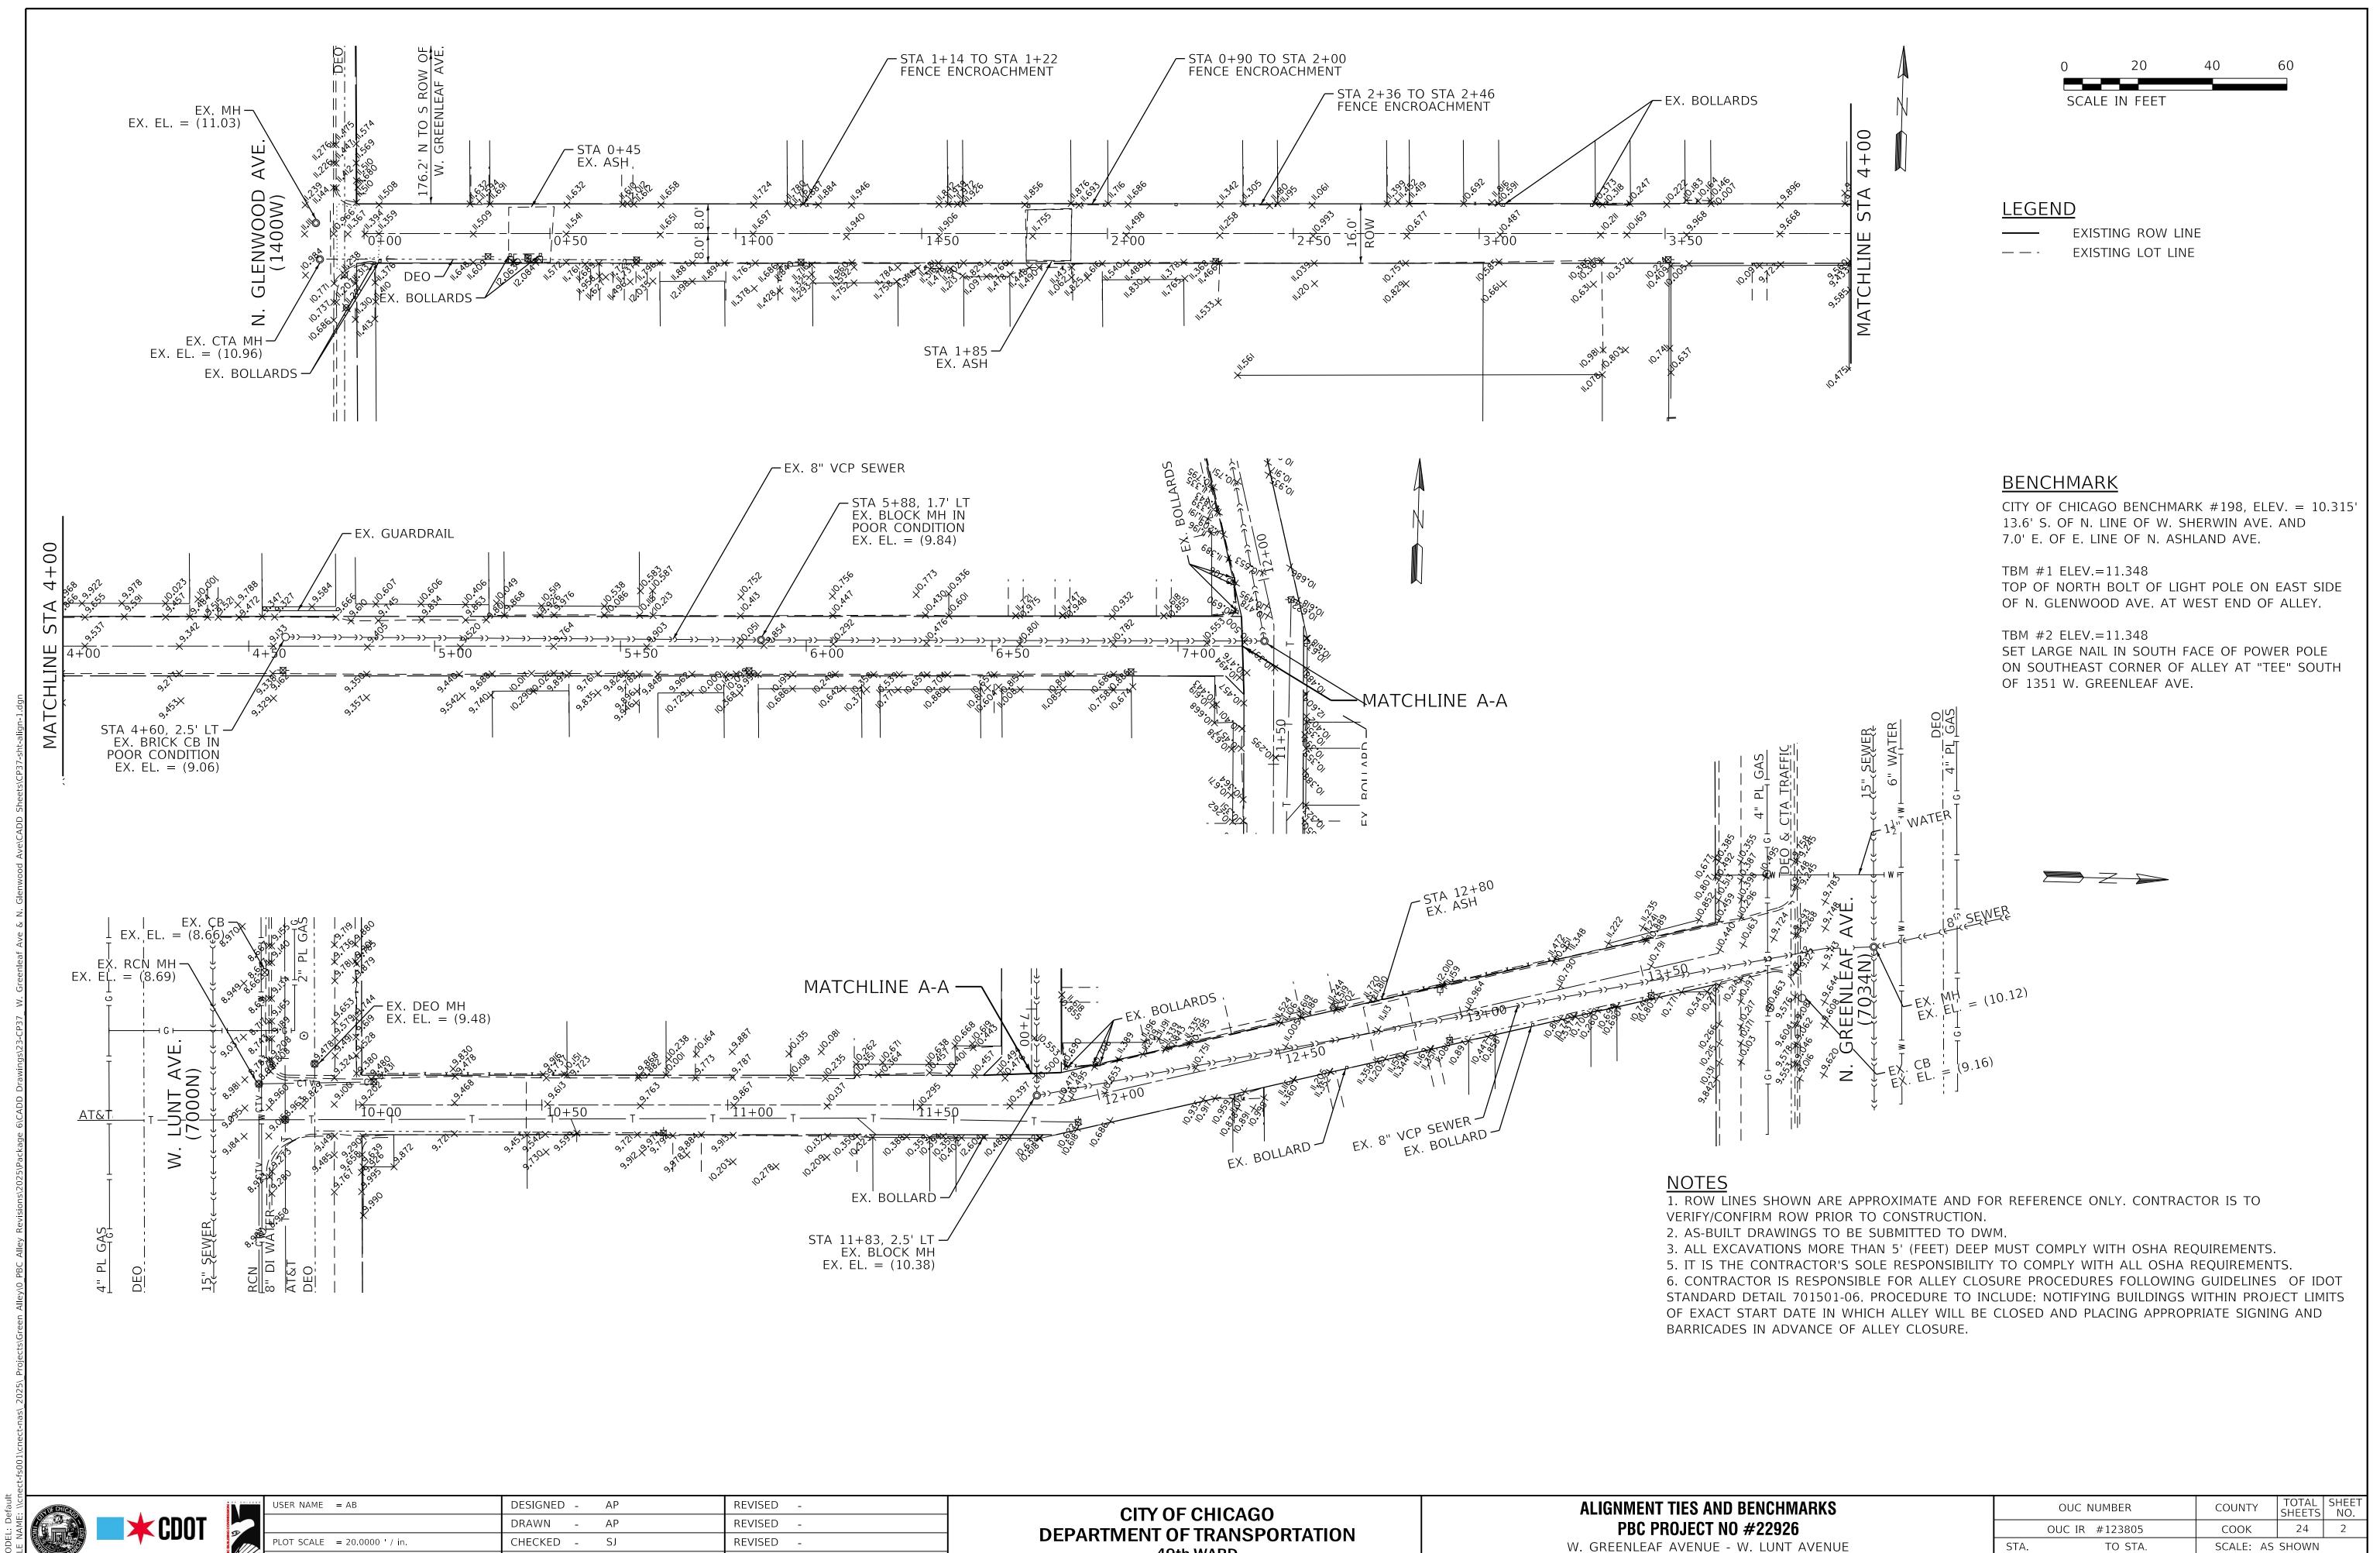



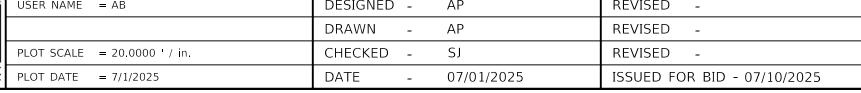

49th WARD

N. GLENWOOD AVENUE - N. SHERIDAN ROAD

|      | OUC NUMBER     | COUNTY    | TOTAL<br>SHEETS | SHEET<br>NO. |
|------|----------------|-----------|-----------------|--------------|
|      | OUC IR #123805 | COOK      | 24              | 2            |
| STA. | TO STA.        | SCALE: AS | SHOWN           |              |
|      | _              | -         |                 |              |

# GENERAL NOTES

- 1. CONTRACTOR WILL BE REQUIRED TO PREPARE A PHASING AND LOGISTICS PLAN WITHIN 30 DAYS OF NTP FOR REVIEW AND APPROVAL BY CDOT AND PBC, PRIOR TO MOBILIZATION AND COMMENCEMENT OF ANY WORK.
- 2. CONTRACTOR SHALL PROVIDE CRITICAL SUBMITTALS, INCLUDING SEWER AND DRAINAGE STRUCTURES, WITHIN 30 DAYS OF ISSUANCE OF THE NTP.
- 3. ON-SITE CONSTRUCTION WORK AT EACH ALLEY LOCATION MUST BE COMPLETED WITHIN 45 CALENDAR DAYS FROM COMMENCEMENT.

| OF CHICAGO | USER NAME = AB               | DESIGNED - | AP         | REVISED -                   |
|------------|------------------------------|------------|------------|-----------------------------|
|            |                              | DRAWN -    | AP         | REVISED -                   |
|            | PLOT SCALE = 20.0000 ' / in. | CHECKED -  | SJ         | REVISED -                   |
|            | PLOT DATE = 7/1/2025         | DATE -     | 07/01/2025 | ISSUED FOR BID - 07/10/2025 |

|      | OUC NUMBER     | COUNTY    | TOTAL<br>SHEETS | SHEET<br>NO. |
|------|----------------|-----------|-----------------|--------------|
|      | OUC IR #123805 | COOK      | 24              | 3            |
| STA. | TO STA.        | SCALE: NT | 5               |              |
|      |                |           |                 |              |

# SUMMARY OF QUANTITIES

| Line     | Code Number   | Description   | Unit   | Estimated<br>Quantity |        | Cost  |
|----------|---------------|---|--------|-----------------------|--------|---|
| 1        | *****         | EARTH EXCAVATION (SOIL TO CCDD FACILITY)  | CU YD  | 414.0                 | \$0.00 | \$0.00  |
| 2        | *****         | EARTH EXCAVATION (SOIL TO LANDFILL)   | CU YD  | 576.0                 | \$0.00 | .00         \$0.00           .00 |
| 3        | *****         | PAVEMENT REMOVAL  | SQ YD  | 34.0                  | \$0.00 | \$0.00  |
| 4        | *****         | DRIVEWAY AND ALLEY RETURN PAVEMENT REMOVAL  | SQ YD  | 92.0                  | \$0.00 | \$0.00  |
| 5        | 44000300      | CURB REMOVAL  | LIN FT | 144.0                 | \$0.00 | \$0.00  |
| 6        | 44000500      | COMBINATION CURB AND GUTTER REMOVAL   | LIN FT | 129.0                 | \$0.00 | \$0.00  |
| 7        | 44000600      | SIDEWALK REMOVAL  | SQ FT  | 420.0                 | \$0.00 | \$0.00  |
| 8        | ******        | ALLEY PAVEMENT REMOVAL  | SQ YD  | 1938.0                | \$0.00 | \$0.00  |
| 9        | *****         | GARAGE APRON REMOVAL  | SQ FT  | 1292.0                | \$0.00 | \$0.00  |
| 10       | ******        | HOT-MIX ASPHALT SURFACE REMOVAL, VARIABLE DEPTH                                       | SQ YD  | 265.0                 | \$0.00 | \$0.00  |
| 11       | 31101100      | SUB-BASE GRANULAR MATERIAL, TYPE B  | CU YD  | 256.0                 | \$0.00 | \$0.00  |
| 12       | *****         | CONCRETE ALLEY FILL, CA-1   | CU YD  | 220.0                 | \$0.00 | \$0.00  |
| 13       | 20800150      | TRENCH BACKFILL   | CU YD  | 53.0                  | \$0.00 | \$0.00  |
| 14       | *****         | PERVIOUS AGGREGATE SUBBASE  | CU YD  | 171.0                 | \$0.00 | \$0.00  |
| 15       | ******        | BEDDING AND VOID OPENING AGGREGATES FOR PERMEABLE PAVERS                              | CU YD  | 25.0                  | \$0.00 | \$0.00  |
| 16       | *****         | CRUSHED STONE (TEMPORARY USE)   | TON    | 60.0                  | \$0.00 | \$0.00  |
| 17       | 35300300      | PORTLAND CEMENT CONCRETE BASE COURSE, 8 IN  | SQ YD  | 34.0                  | \$0.00 | \$0.00  |
| 18       | 35300500      | PORTLAND CEMENT CONCRETE BASE COURSE, 10 IN   | SQ YD  | 0.0                   | \$0.00 | \$0.00  |
| 19       | ******        | HIGH EARLY STRENGTH PORTLAND CEMENT CONCRETE ALLEY PAVEMENT, 8 IN                     | SQ YD  | 1125.0                | \$0.00 | \$0.00  |
| 20       | *****         | HIGH EARLY STRENGTH PORTLAND CEMENT CONCRETE DRIVEWAY AND ALLEY RETURN PAVEMENT, 8 IN | SQ YD  | 0.0                   | \$0.00 | \$0.00  |
| 21       | ******        | HIGH EARLY STRENGTH PORTLAND CEMENT CONCRETE GARAGE APRON, 8 IN                       | SQ FT  | 1292.0                | \$0.00 | \$0.00  |
| 22       | ******        | HIGH EARLY STRENGTH PORTLAND CEMENT CONCRETE SIDEWALK, 8 IN                           | SQ FT  | 247.0                 | \$0.00 | \$0.00  |
| 23       | *****         | HIGH EARLY STRENGTH PORTLAND CEMENT CONCRETE BASE COURSE, 8 IN                        | SQ YD  | 0.0                   | \$0.00 | \$0.00  |
| 24       | *****         | HIGH EARLY STRENGTH PORTLAND CEMENT CONCRETE BASE COURSE, 10 IN                       | SQ YD  | 0.0                   | ·      | ·   |
| 25       | *****         | PORTLAND CEMENT CONCRETE SIDEWALK, 5 IN   | SQ FT  | 240.0                 |        |   |
| 26       | ******        | PORTLAND CEMENT CONCRETE ADA CURB RAMP, 5 IN  | SQ FT  | 180.0                 | \$0.00 |   |
| 27       | *****         | HIGH EARLY STRENGTH PORTLAND CEMENT CONCRETE ADA CURB RAMP, 8 IN                      | SQ FT  | 0.0                   | \$0.00 | · ·   |
| 28       | *****         | DRILL AND GROUT DOWEL AND TIE BARS  | EACH   | 187.0                 | \$0.00 | · ·   |
| 29       |               | PERMEABLE CONCRETE BLOCK PAVERS   | SQ FT  | 7952.0                | \$0.00 |   |
| 30       | 40600290      | BITUMINOUS MATERIALS (TACK COAT)  | POUND  | 136.0                 |        | •   |
| 31       | *****         | HOT-MIX ASPHALT SURFACE COURSE, IL-9.5LH, MIX "C", N30 (CDOT)                         | TON    | 0.0                   | \$0.00 |   |
| 32       | *****         | HOT-MIX ASPHALT SURFACE COURSE, PATCH, N30 (6 FT OR LESS)                             | TON    | 36.0                  |        | ,   |
| 33       | 60600605      | HOT-MIX ASPHALT SURFACE COURSE, PATCH, N70 (6 FT OR LESS)  CONCRETE CURB, TYPE B      | TON    | 0.0                   |        |   |
| 34<br>35 | *****         | HIGH EARLY STRENGTH PORTLAND CEMENT CONCRETE COMBINATION CURB AND GUTTER, TYPE B-V.12 | LIN FT | 261.0<br>94.0         |        |   |
| 36       | *****         | COMBINATION CONCRETE CURB AND GUTTER, TYPE B-V.12                                     | LIN FT | 35.0                  |        | ·   |
| 37       | *****         | MANHOLE, 3 FT DIAMETER, TYPE B, FRAME AND CLOSED LID (CITY OF CHICAGO)                | EACH   | 0.0                   | \$0.00 | •   |
| 38       | *****         | MANHOLE, 3 FT DIAMETER, TYPE A, FRAME AND CLOSED LID (CITY OF CHICAGO)                | EACH   | 0.0                   | ·      | •   |
| 39       | *****         | CATCH BASIN, TYPE A, 4 FT DIAMETER, TYPE 1 FRAME, OPEN LID (CITY OF CHICAGO)          | EACH   | 2.0                   | \$0.00 |   |
| 40       | *****         | INLETS, TYPE A, TYPE 1 FRAME, OPEN LID (CITY OF CHICAGO)                              | EACH   | 0.0                   | \$0.00 |   |
| 41       | *****         | DRAINAGE AND UTILITY STRUCTURES TO BE ADJUSTED  | EACH   | 2.0                   |        |   |
| 42       | *****         | VORTEX RESTRICTOR   | EACH   | 1.0                   |        |   |
| 43       | *****         | STORM SEWERS, EXTRA STRENGTH VITRIFIED CLAY PIPE, 8 IN                                | LIN FT | 5.0                   |        |   |
| 44       | *****         | STORM SEWERS, DUCTILE IRON PIPE, 8 IN   | LIN FT | 0.0                   |        |   |
| 45       | *****         | STORM SEWERS, EXTRA STRENGTH VITRIFIED CLAY PIPE, 10 IN                               | LIN FT | 0.0                   | \$0.00 |   |
| 46       | *****         | STORM SEWERS, EXTRA STRENGTH VITRIFIED CLAY PIPE, 12 IN                               | LIN FT | 0.0                   | \$0.00 |   |
| 47       | *****         | STORM SEWERS, DUCTILE IRON PIPE, 12 IN  | LIN FT | 260.0                 | \$0.00 |   |
| 48       | *****         | STORM SEWERS, REINFORCED CONCRETE PIPE, 30 IN.  | LIN FT | 0.0                   | \$0.00 | \$0.00  |
| 49       | *****         | CIP OR PRECAST CONCRETE REDUCER   | EACH   | 0.0                   | \$0.00 | \$0.00  |
| 50       | CDOT SP 550-3 | ABANDON AND FILL EXISTING COMBINED SEWER  | LIN FT | 0.0                   | \$0.00 | \$0.00  |
| -,       | *****         | E. ((a T.) (a a E.) (E.) (E.)   | l      |                       | ** **  | *   |

|    | *****         |  |        |         |        |        |
|----|---------------|--|--------|---------|--------|--------|
| 51 |               | EXISTING SEWER TO BE REMOVED                           | LIN FT | 260.0   | \$0.00 | \$0.00 |
| 52 | *****         | REMOVING MANHOLES                                      | EACH   | 1.0     | \$0.00 | \$0.00 |
| 53 | ******        | REMOVING CATCH BASINS                                  | EACH   | 1.0     | \$0.00 | \$0.00 |
| 54 | *****         | REMOVING INLETS  | EACH   | 0.0     | \$0.00 | \$0.00 |
| 55 | *****         | SEWER CLEANING AND TELEVISING (24 IN DIAMETER OR LESS) | LIN FT | 229.0   | \$0.00 | \$0.00 |
| 56 | 60100085      | GEOTECHNICAL FABRIC                                    | SQ YD  | 1273.0  | \$0.00 | \$0.00 |
| 57 | *****         | PULVERIZED TOPSOIL MIX                                 | CU YD  | 12.3    | \$0.00 | \$0.00 |
| 58 | *****         | HYDRAULIC SEEDING, CLASS 1A                            | SQ YD  | 21.0    | \$0.00 | \$0.00 |
| 59 | 78000200      | THERMOPLASTIC PAVEMENT MARKING, LINE 4 IN              | LIN FT | 0.0     | \$0.00 | \$0.00 |
| 60 | *****         | CONSTRUCTION SIGNS                                     | SQ FT  | 64.0    | \$0.00 | \$0.00 |
| 61 | *****         | PREMOLDED RUBBER SPEED HUMPS                           | EACH   | 4.0     | \$0.00 | \$0.00 |
| 62 | *****         | REMOVE AND SALVAGE SIGN PANEL AND POLE ASSEMBLY        | EACH   | 0.0     | \$0.00 | \$0.00 |
| 63 | *****         | CURB PAINTING  | LIN FT | 0.0     | \$0.00 | \$0.00 |
| 64 | CDOT SP 905-1 | MEMBRANE WATERPROOFING SYSTEM                          | SQ FT  | 15310.8 | \$0.00 | \$0.00 |



|                              |            | (          | , many 1                    |
|------------------------------|------------|------------|-----------------------------|
| USER NAME = SJackson         | DESIGNED - | AP (       | ADDENDUM 3 - 07/28/2025     |
|                              | DRAWN -    | AP         | REVISED -                   |
| PLOT SCALE = 20.0000 ' / in. | CHECKED -  | SJ         | REVISED -                   |
| PLOT DATE = 7/28/2025        | DATE -     | 07/01/2025 | ISSUED FOR BID - 07/10/2025 |

CITY OF CHICAGO
DEPARTMENT OF TRANSPORTATION
49th WARD

SUMMARY OF QUANTITIES

PBC PROJECT NO #22926

W. GREENLEAF AVENUE - W. LUNT AVENUE
N. GLENWOOD AVENUE - N. SHERIDAN ROAD

OUC NUMBER

OUC NUMBER

OUC NUMBER

COUNTY

TOTAL SHEET NO.

OUC IR #123805

COOK


24

4

STA.

TO STA.

SCALE: NTS

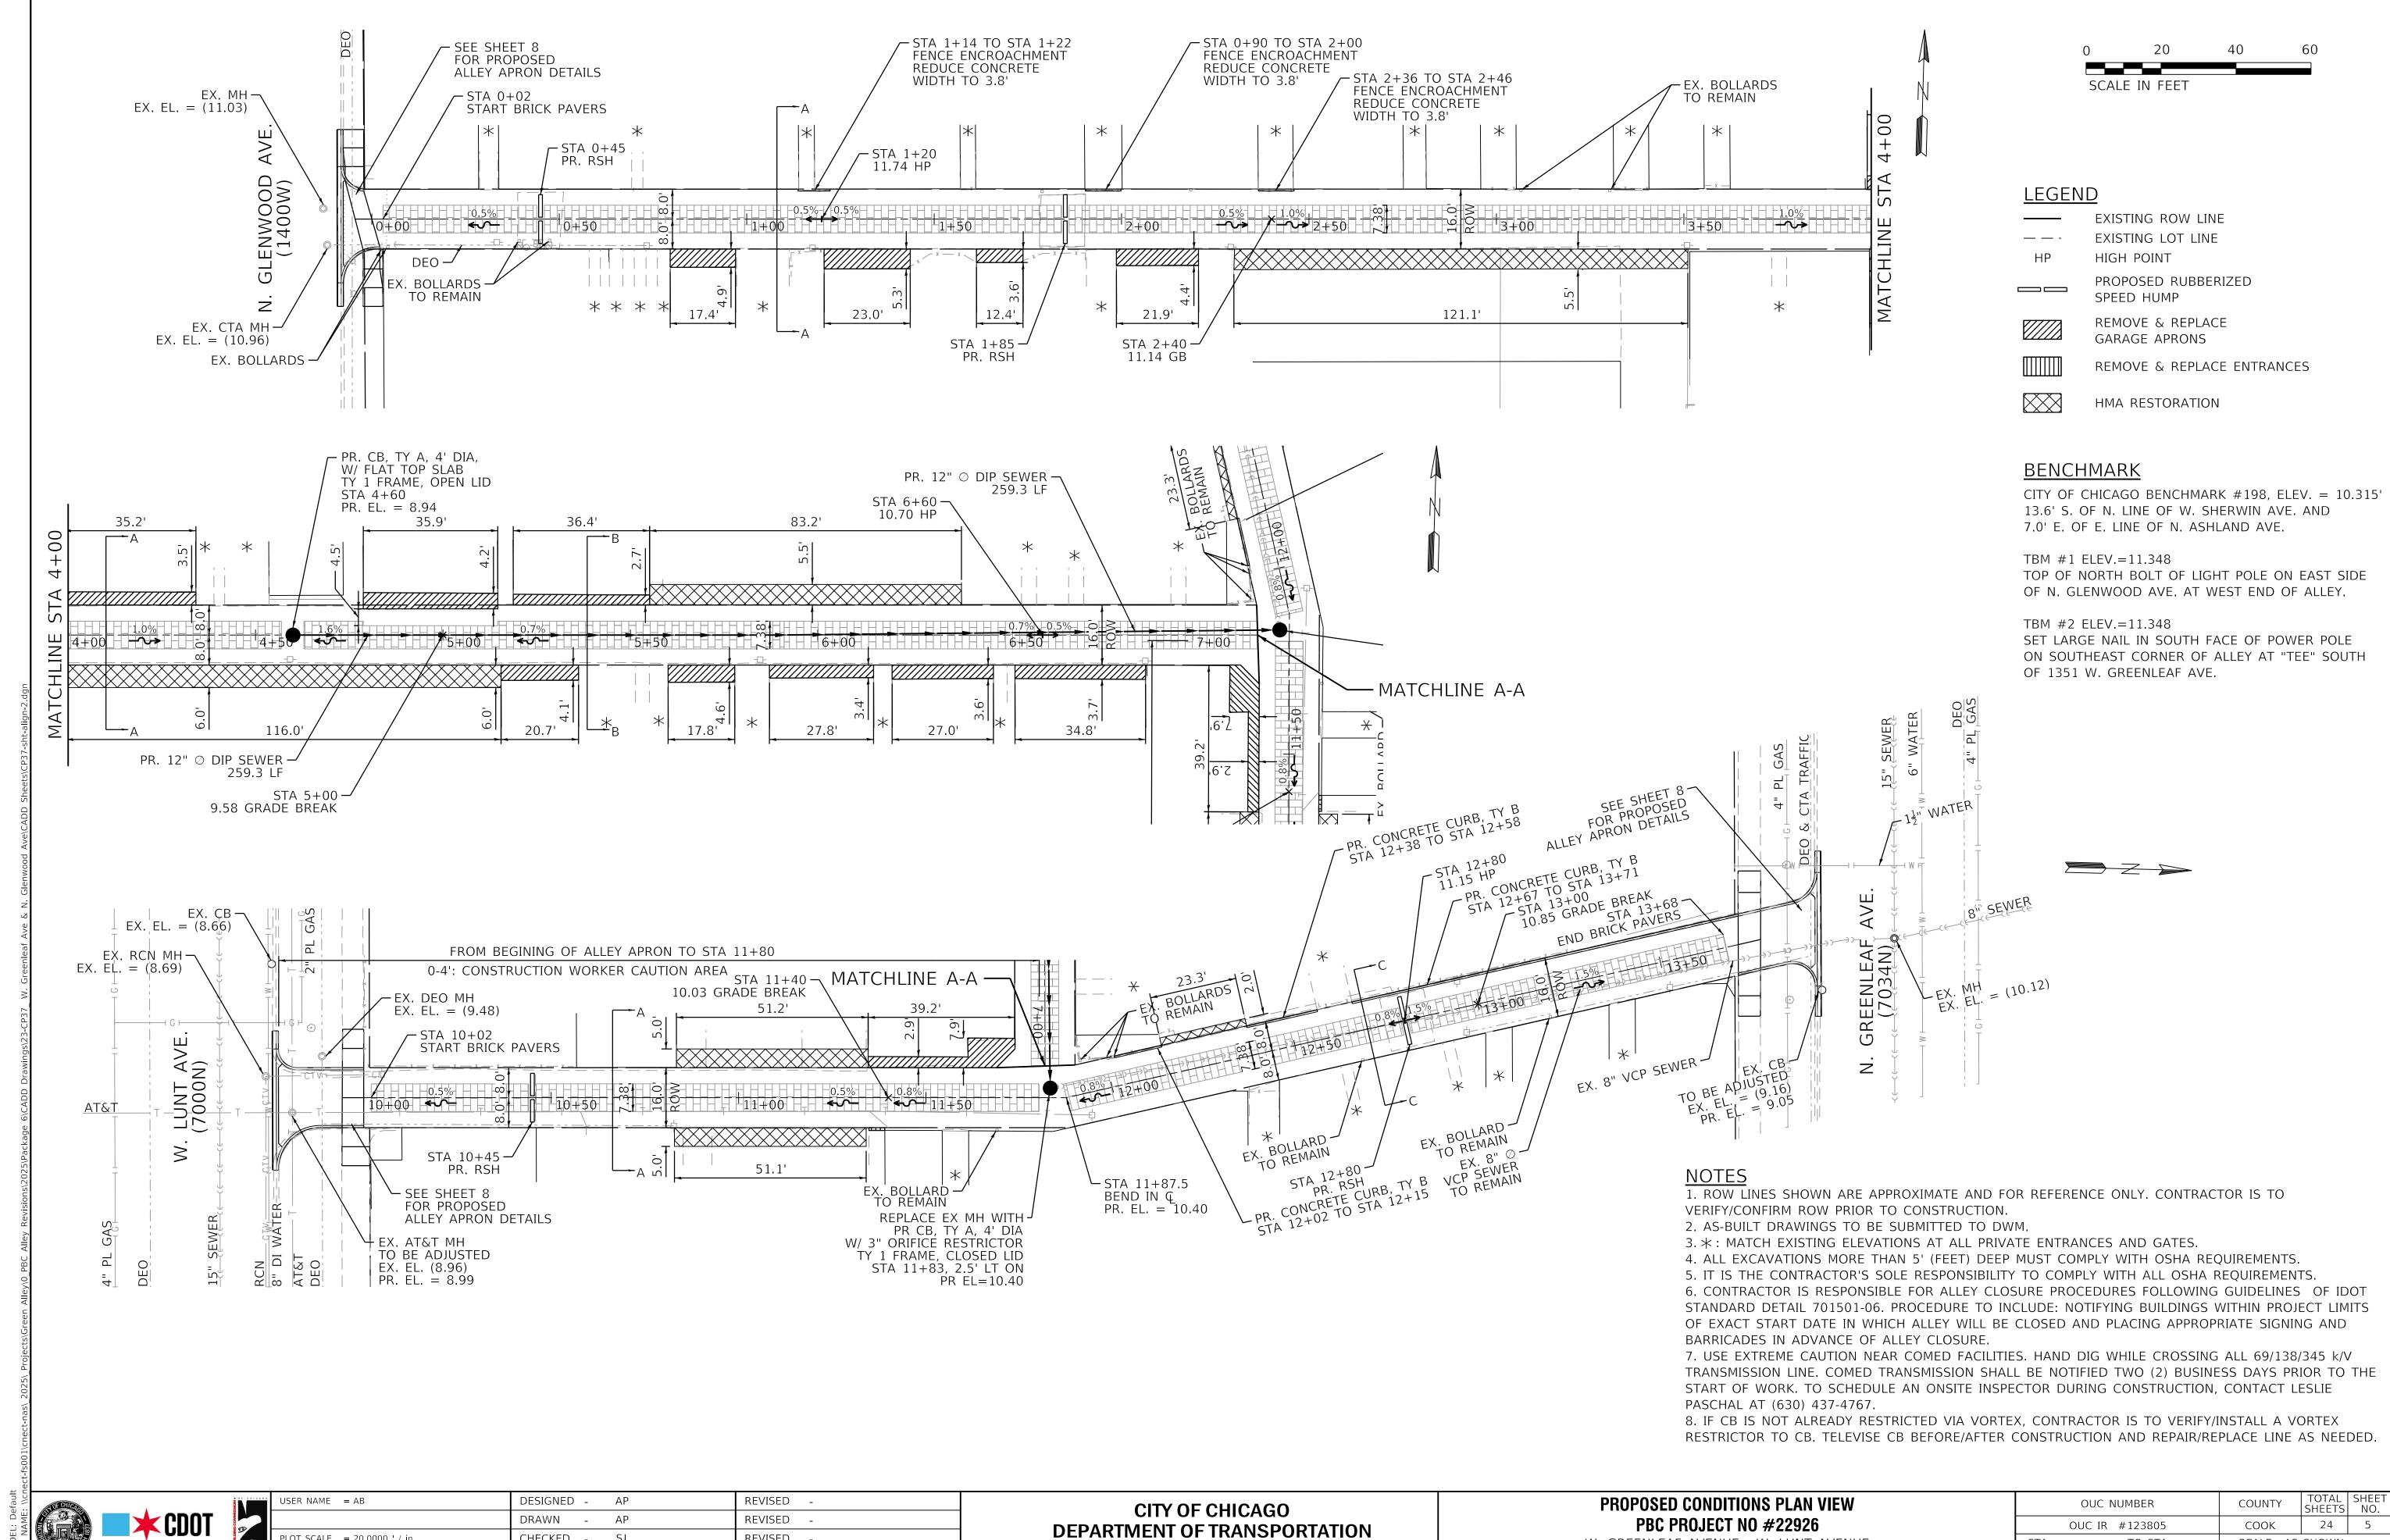



REVISED CHECKED SJ PLOT SCALE = 20.0000 ' / in. PLOT DATE = 7/1/2025DATE - 07/01/2025 ISSUED FOR BID - 07/10/2025


49th WARD


W. GREENLEAF AVENUE - W. LUNT AVENUE N. GLENWOOD AVENUE - N. SHERIDAN ROAD


|      | OUC NUMBER     | COUNTY    | SHEETS | NO. |
|------|----------------|-----------|--------|-----|
|      | OUC IR #123805 | СООК      | 24     | 5   |
| STA. | TO STA.        | SCALE: AS | SHOWN  |     |
|      |                |           |        |     |

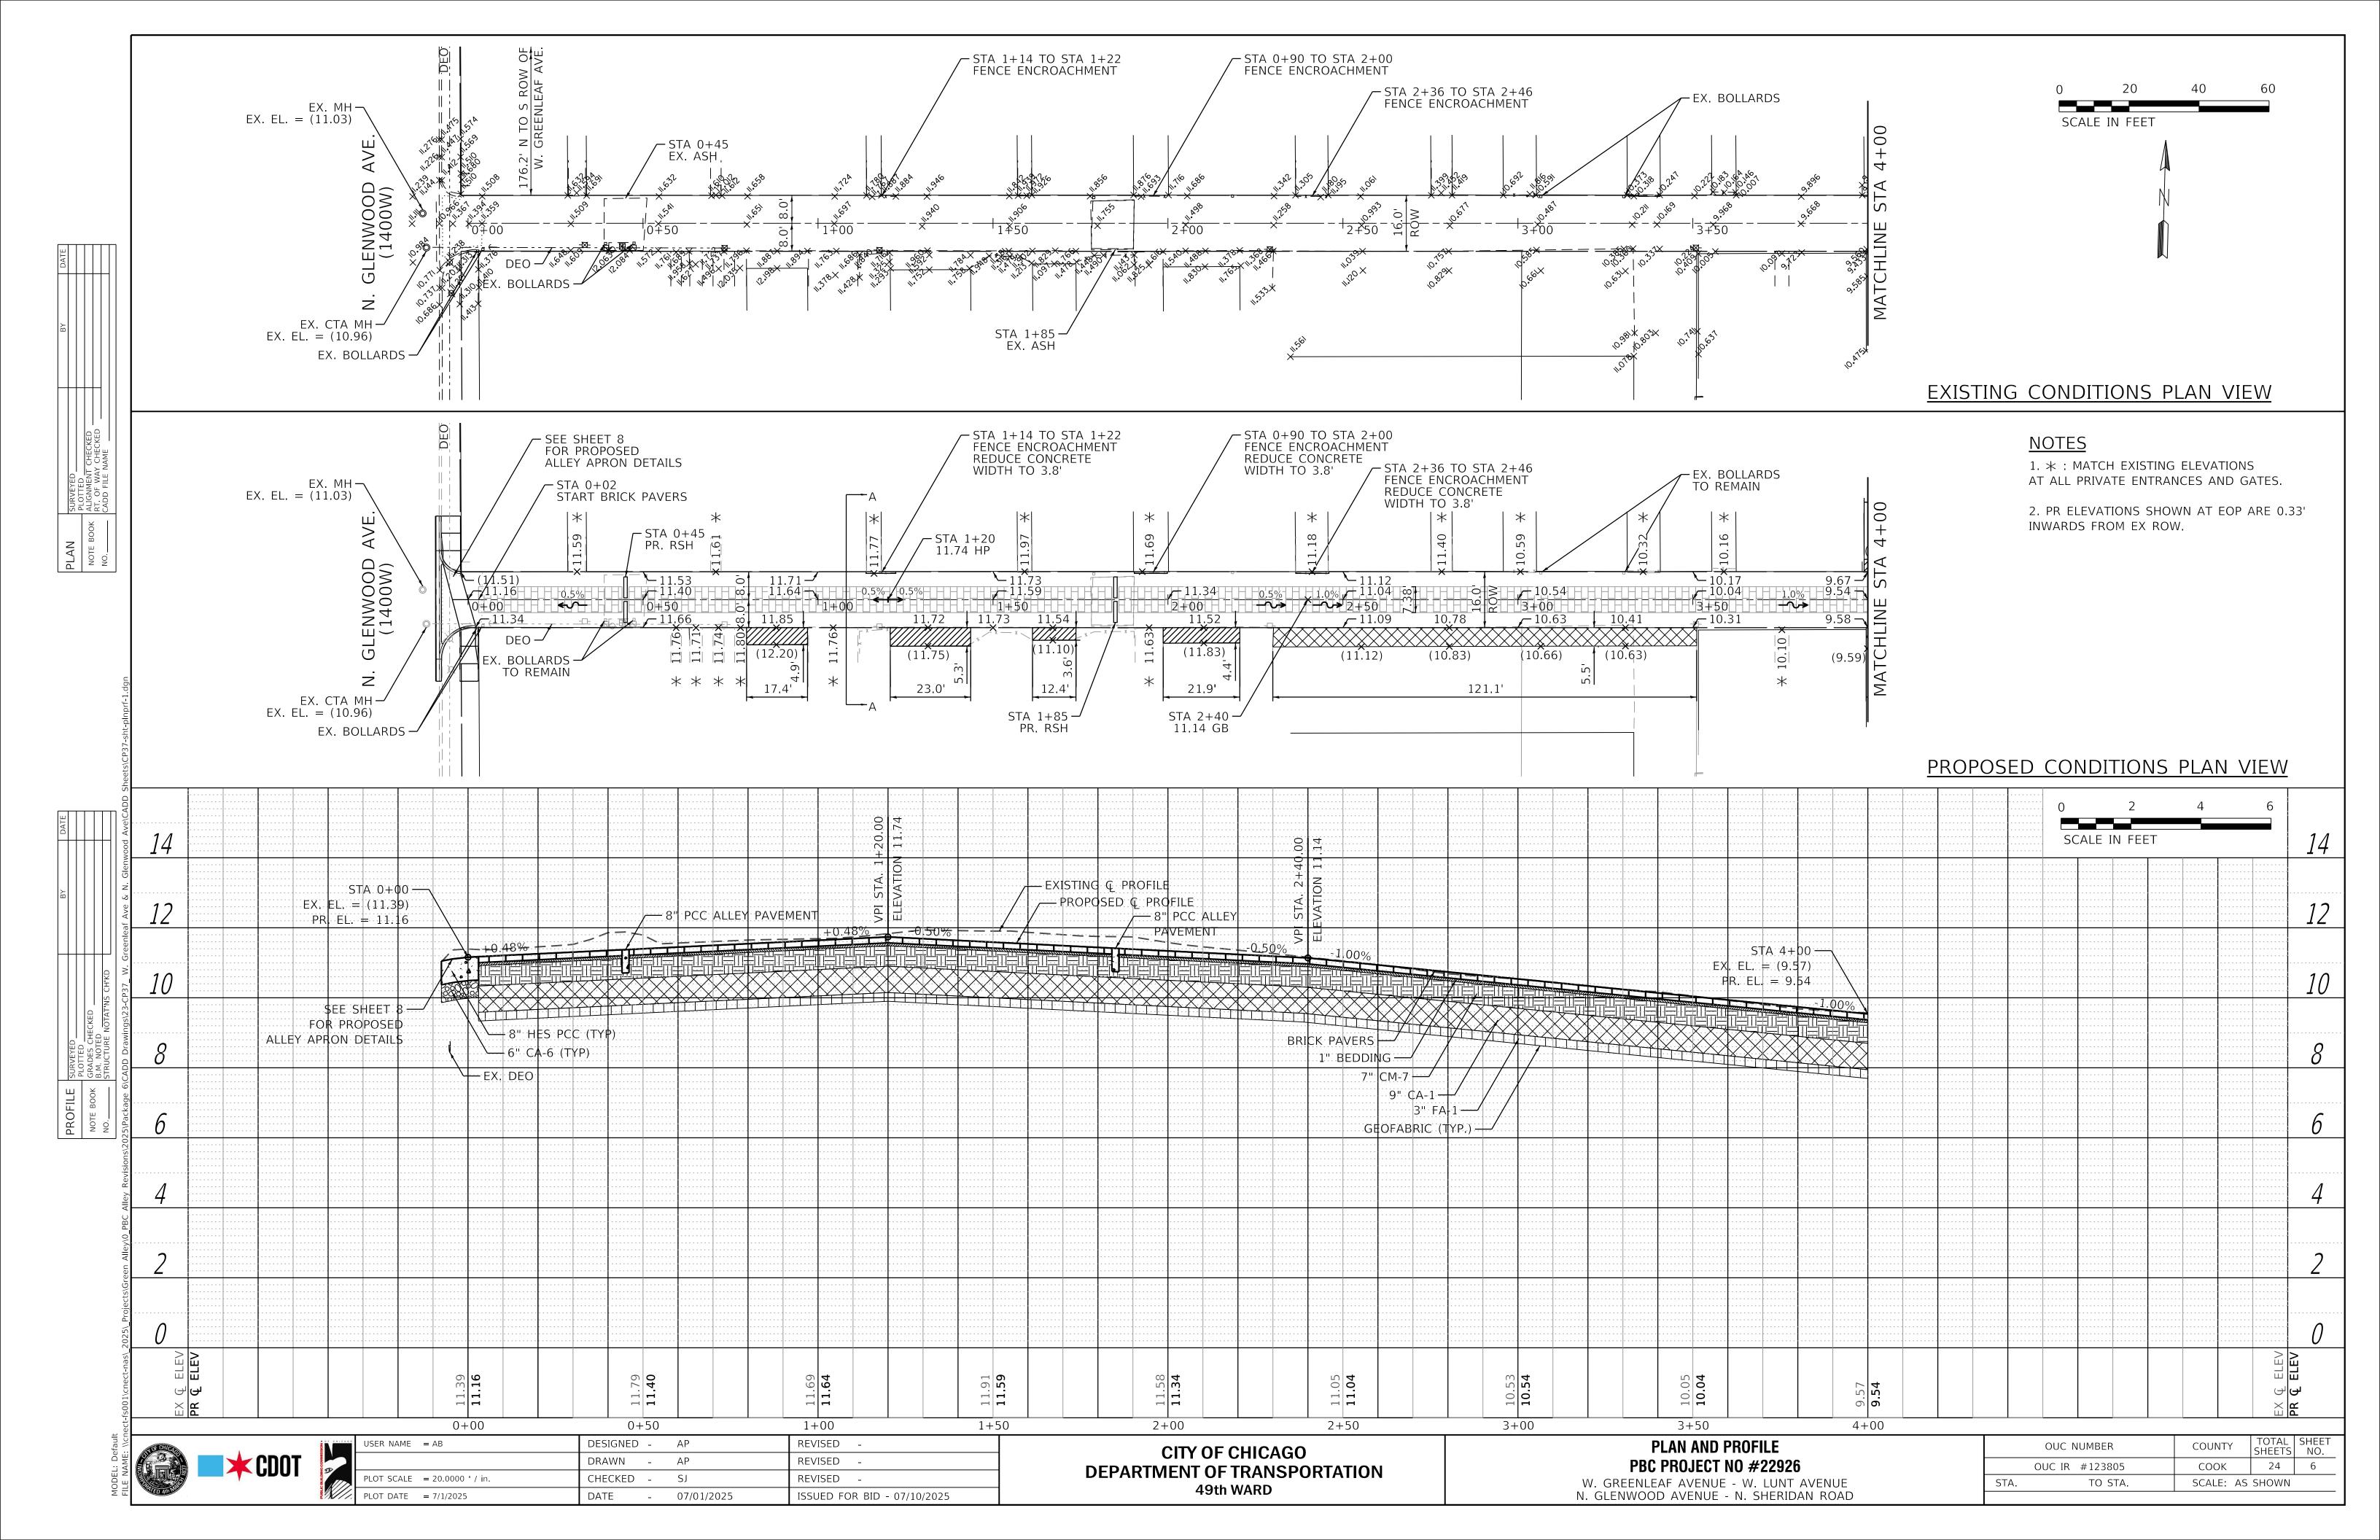

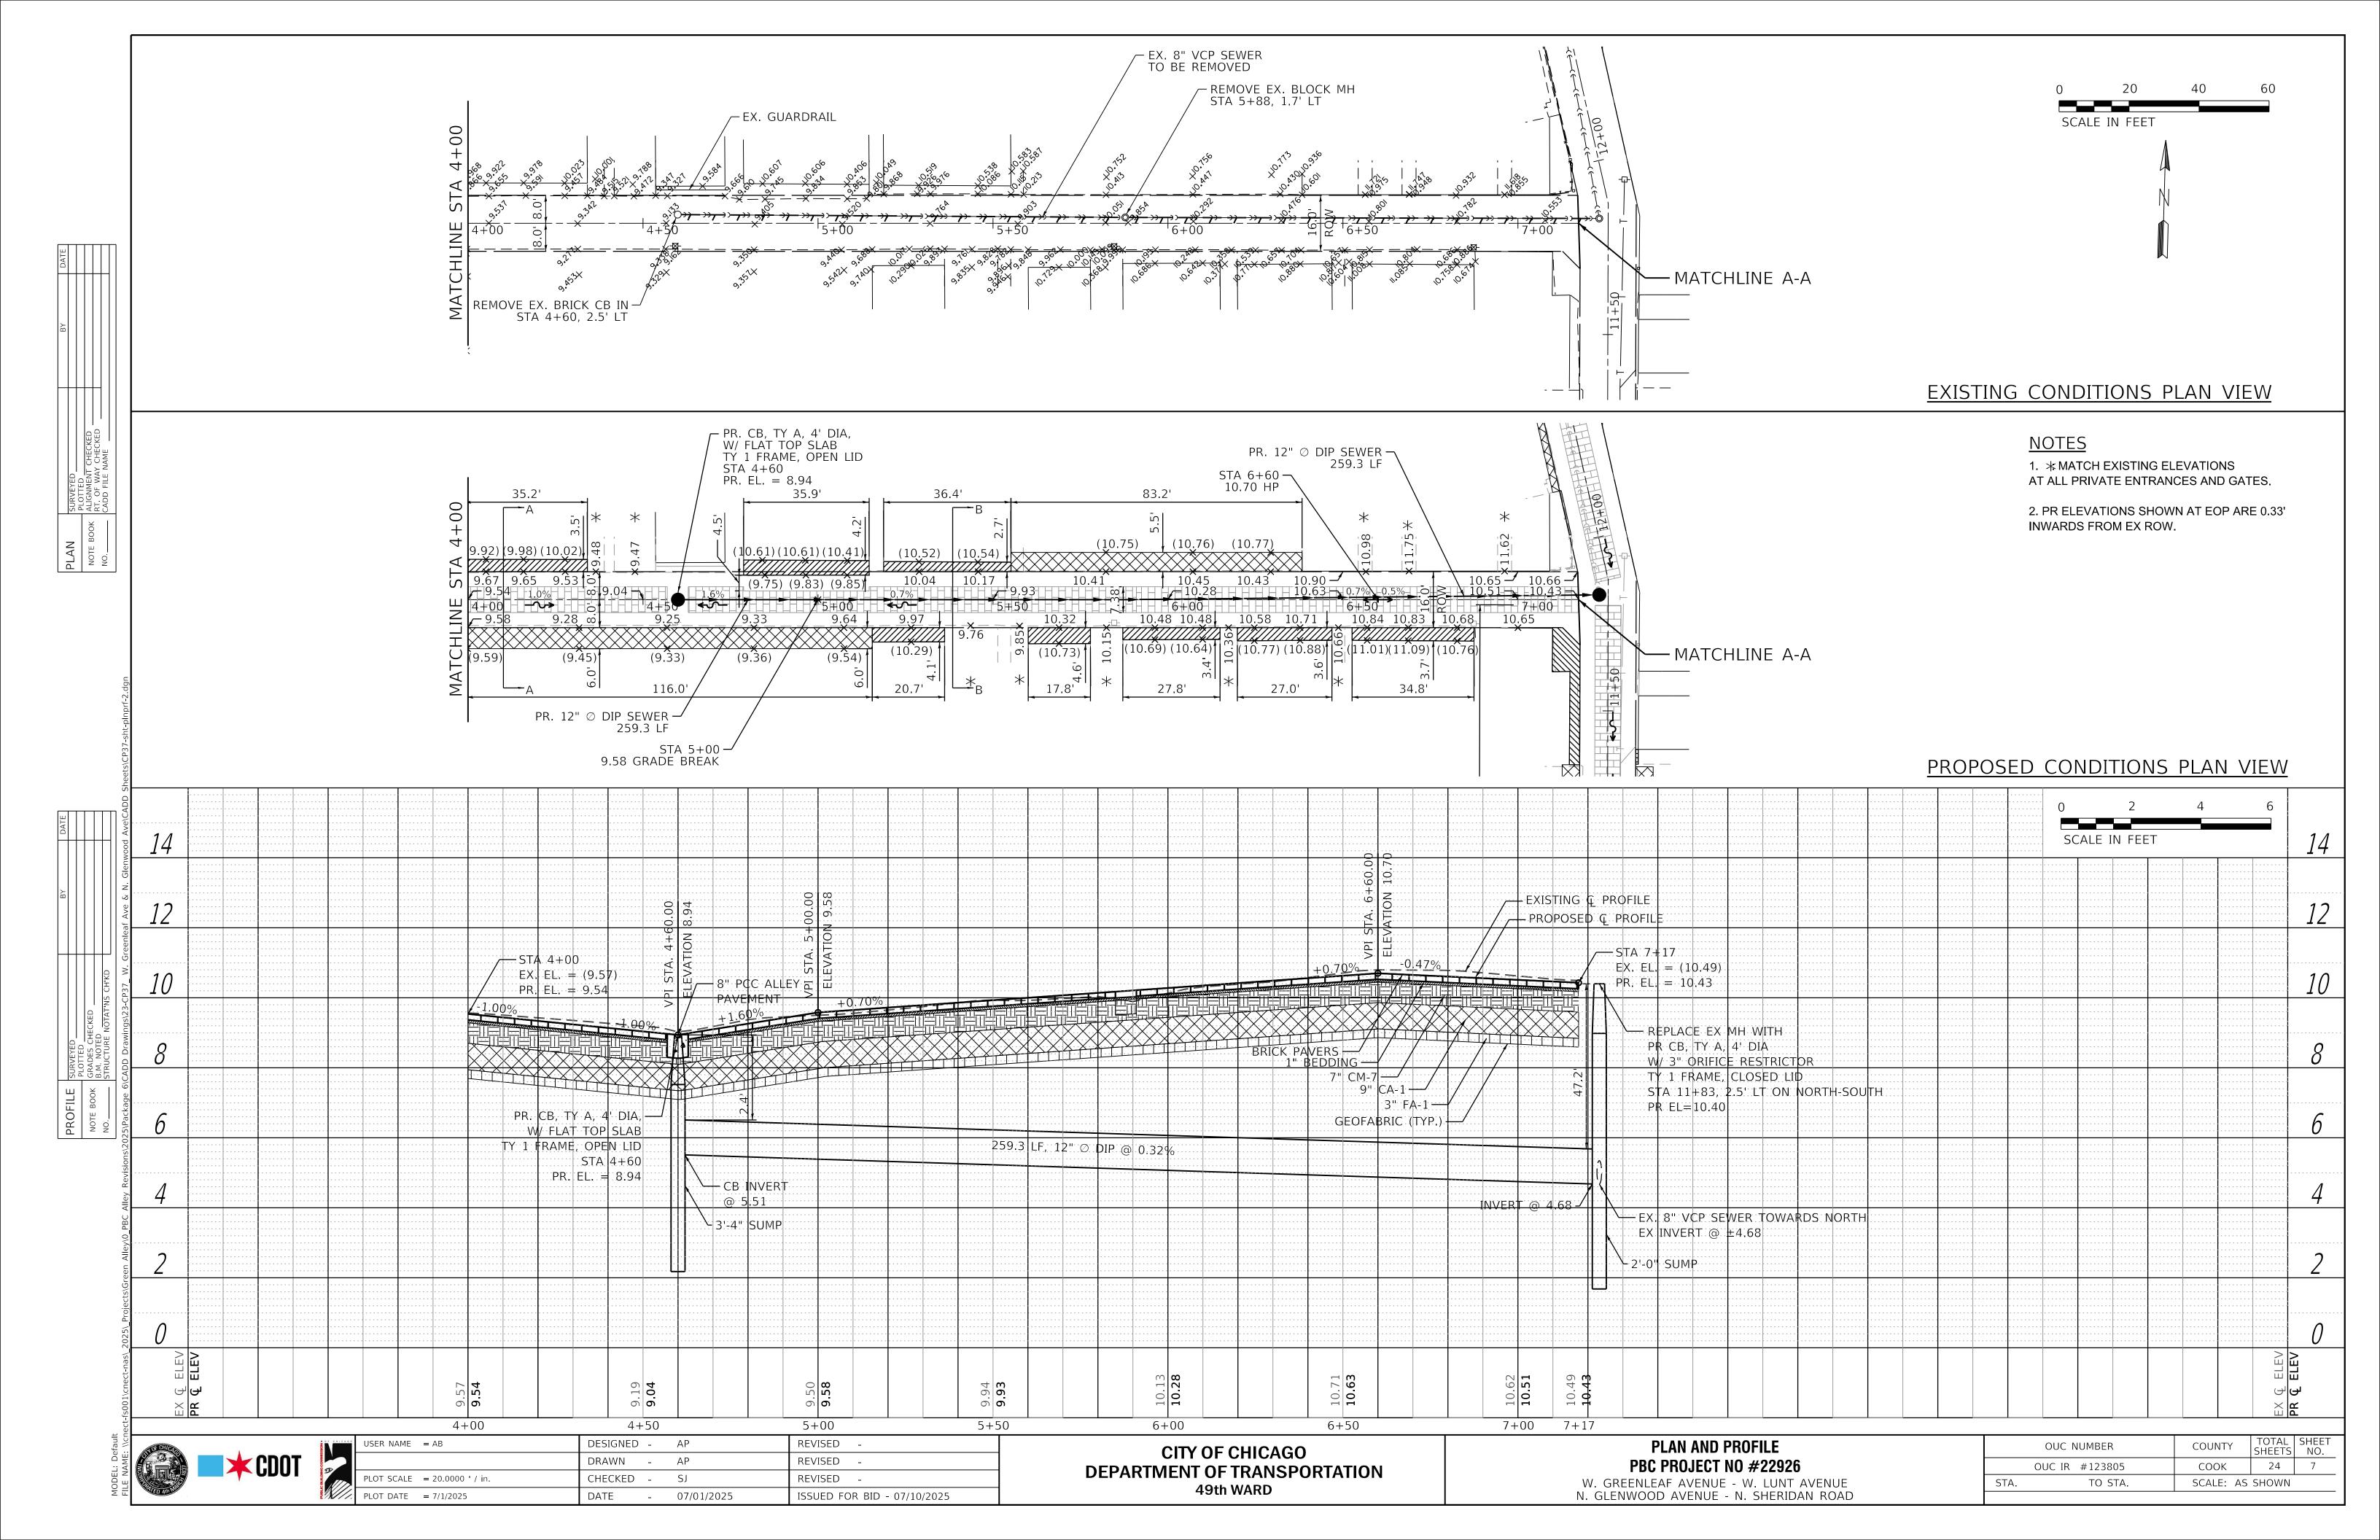

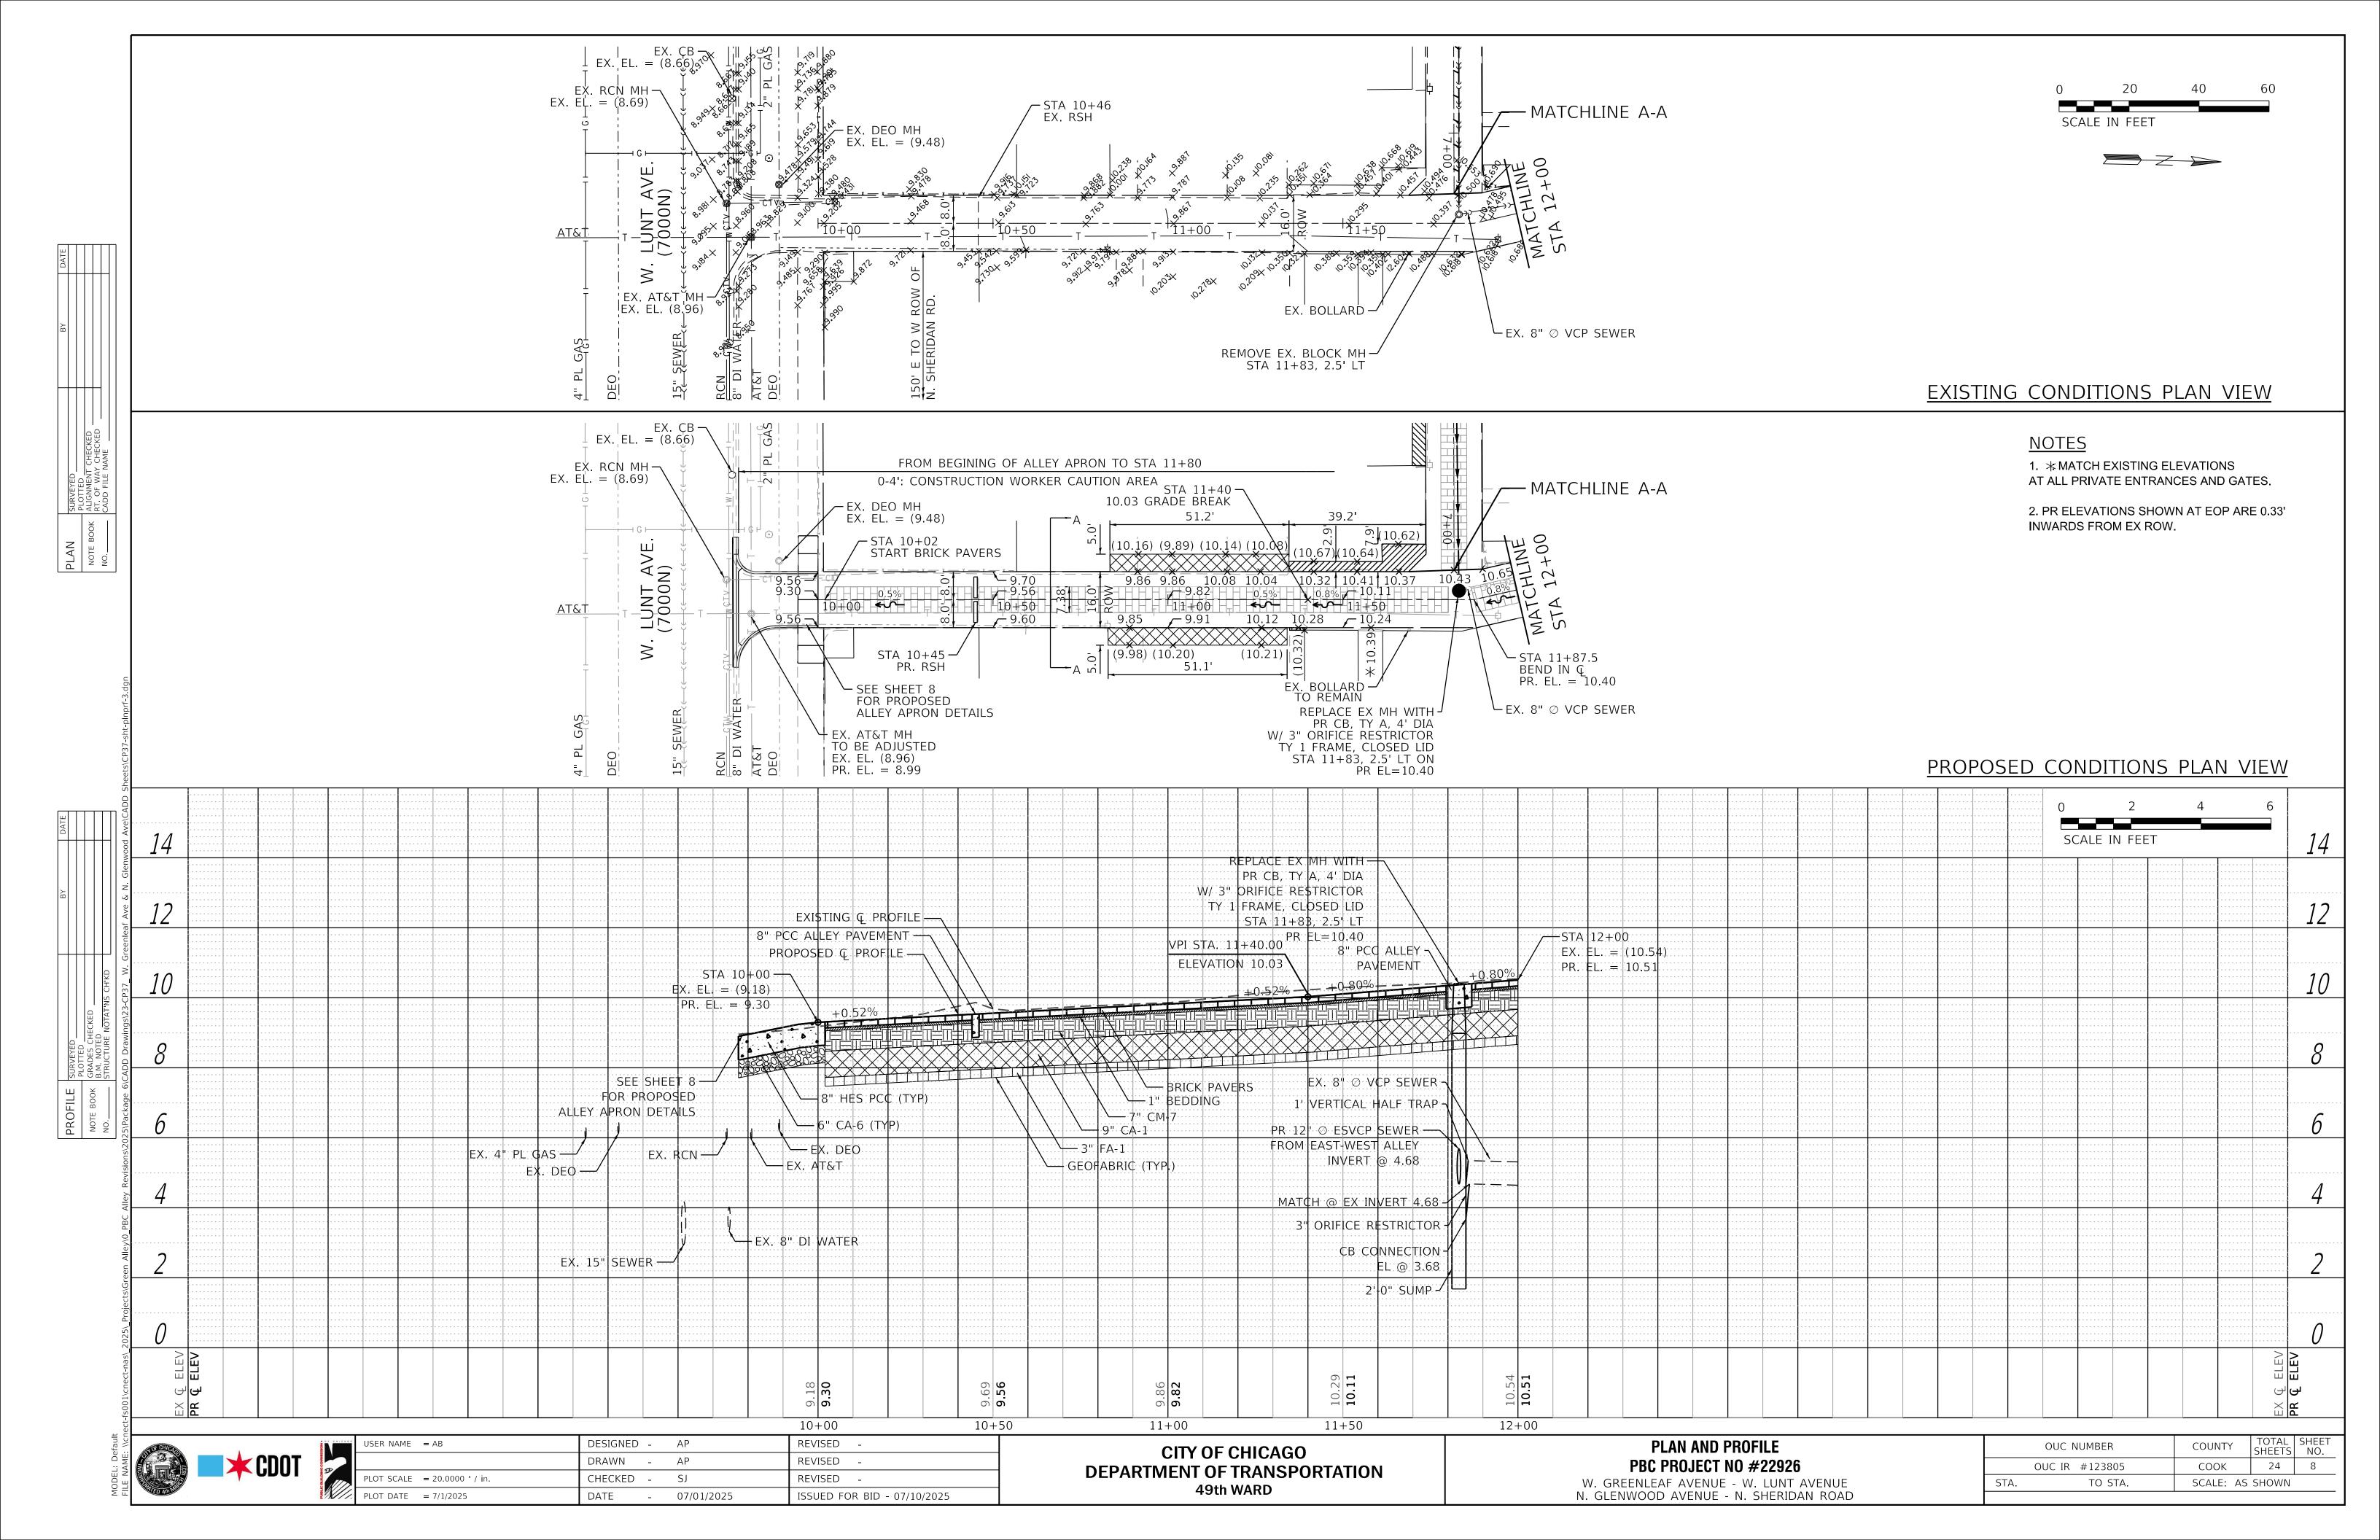


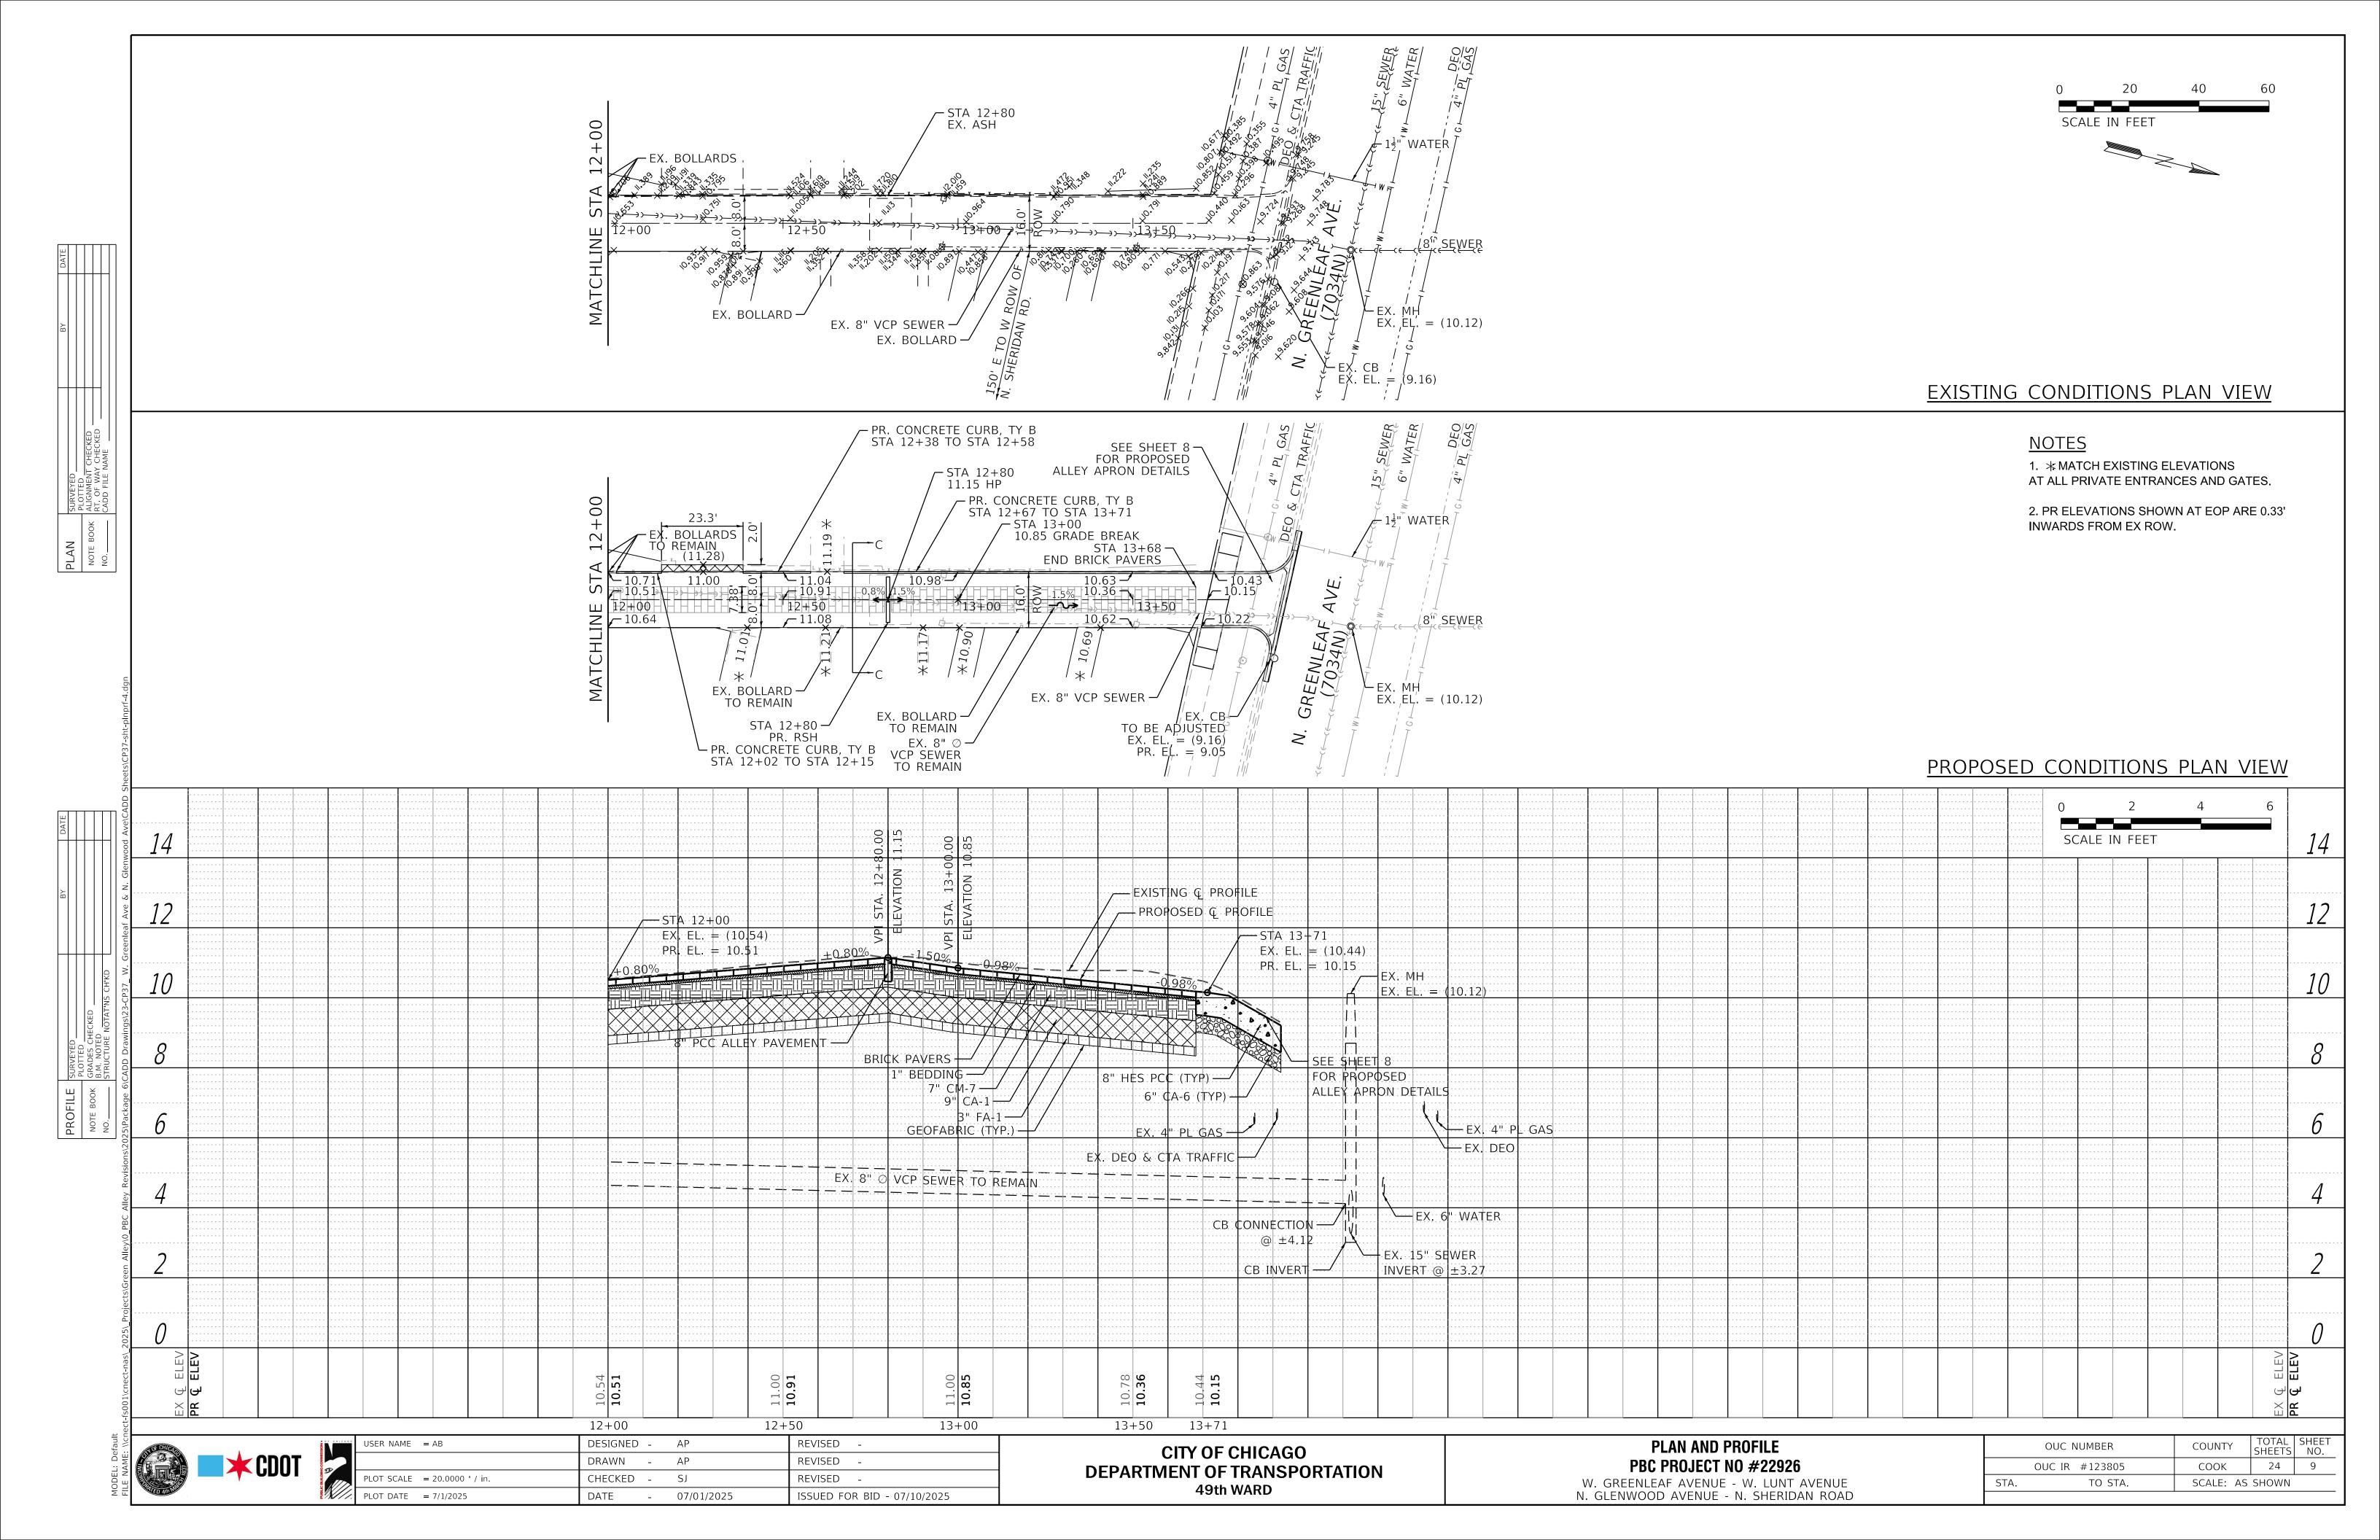

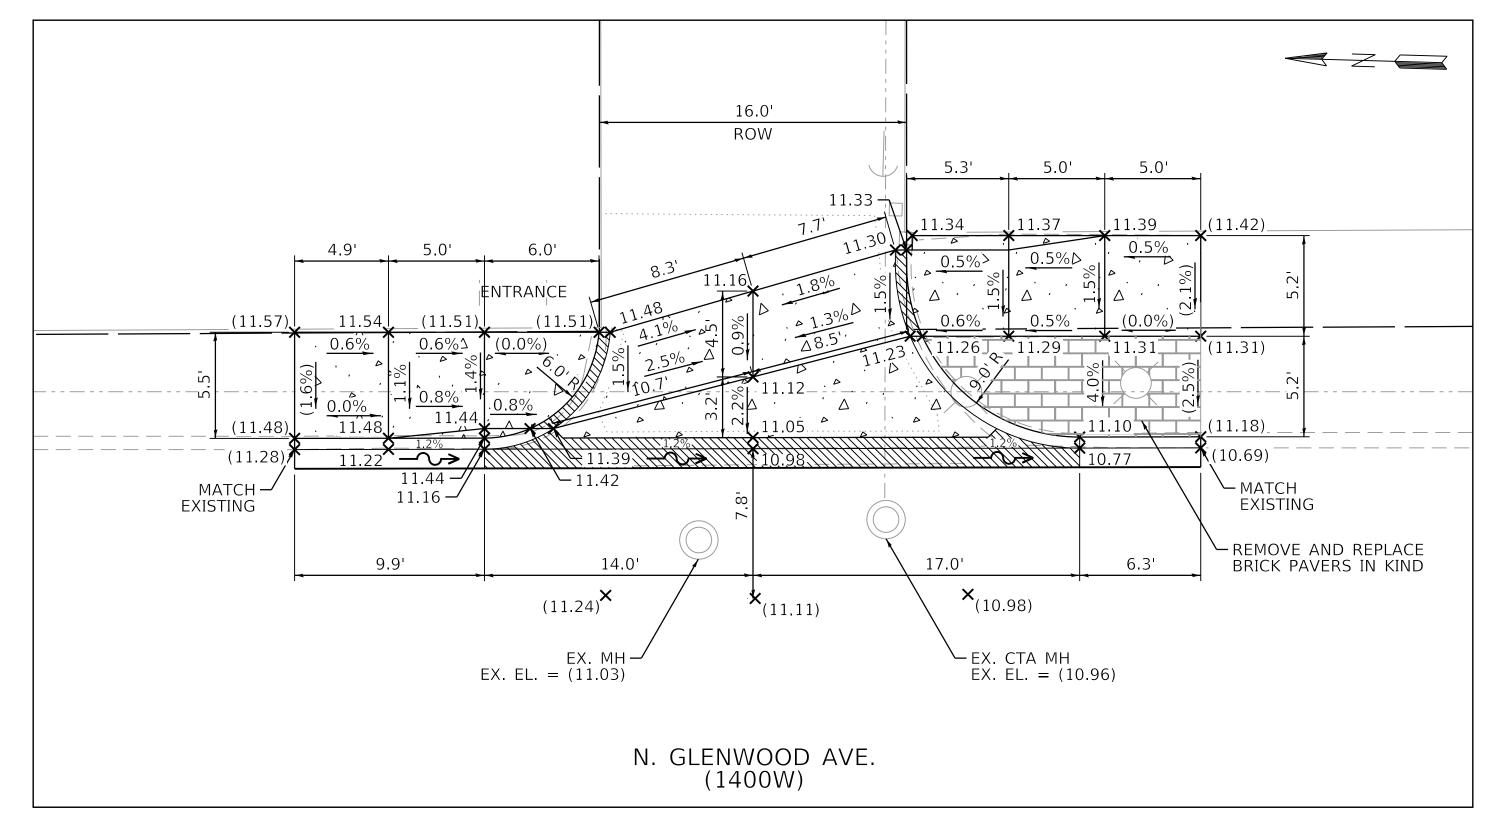


### PROPOSED ALLEY APRON DETAILS

1" = 5'
NOTE: ALLEY RETURN WILL BE CONSTRUCTED IN PCC PAVEMENT.
USE HES PCC BASE COURSE AT T3 ALLEYS/DRIVEWAYS.

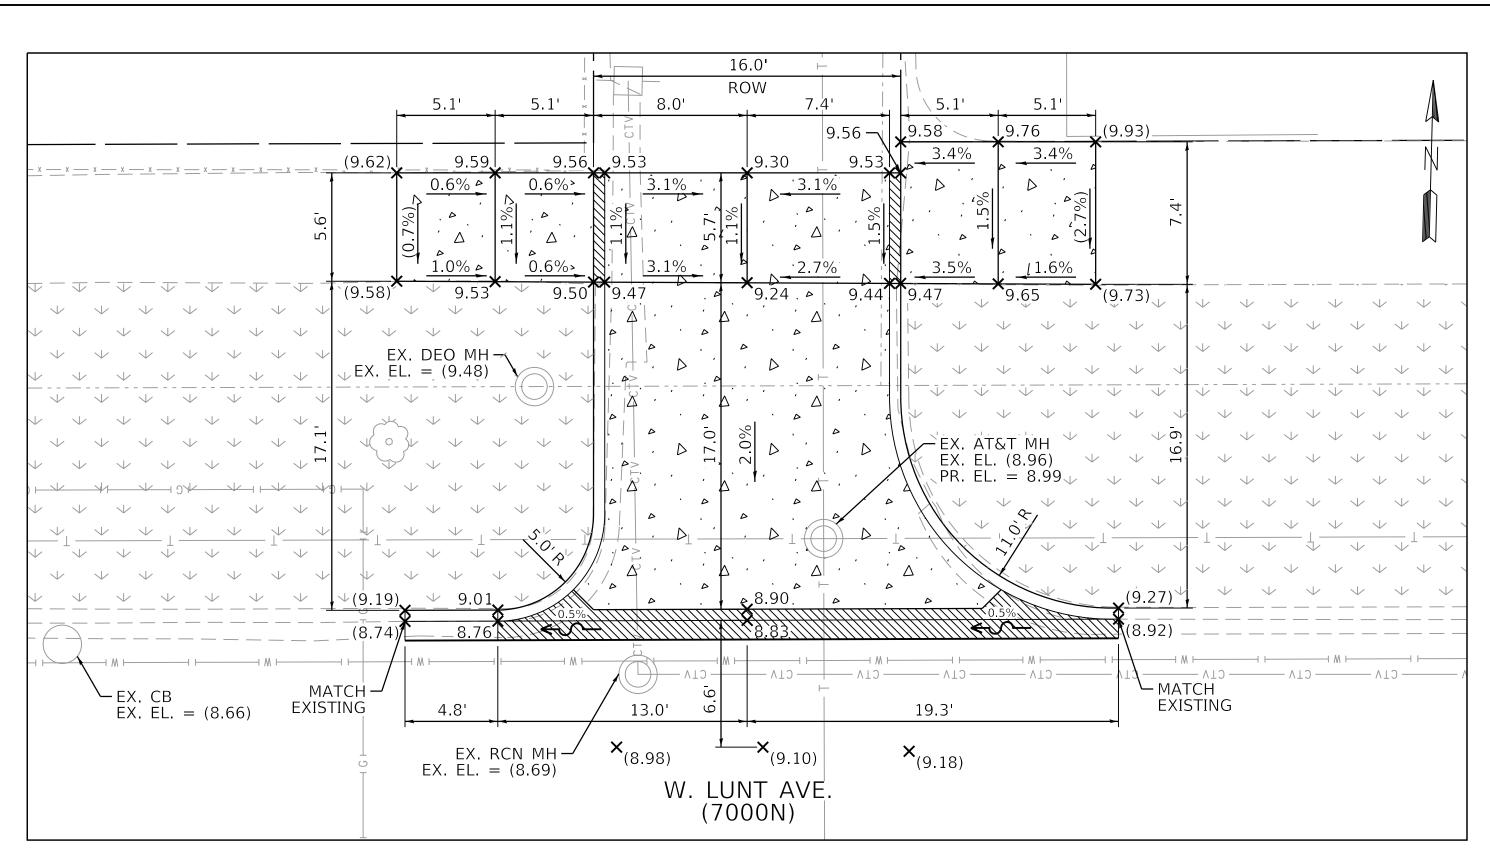

# PROPOSED ALLEY APRON DETAILS

1" = 5' NOTE: ALLEY RETURN WILL BE CONSTRUCTED IN PCC PAVEMENT. USE HES PCC BASE COURSE AT T3 ALLEYS/DRIVEWAYS.

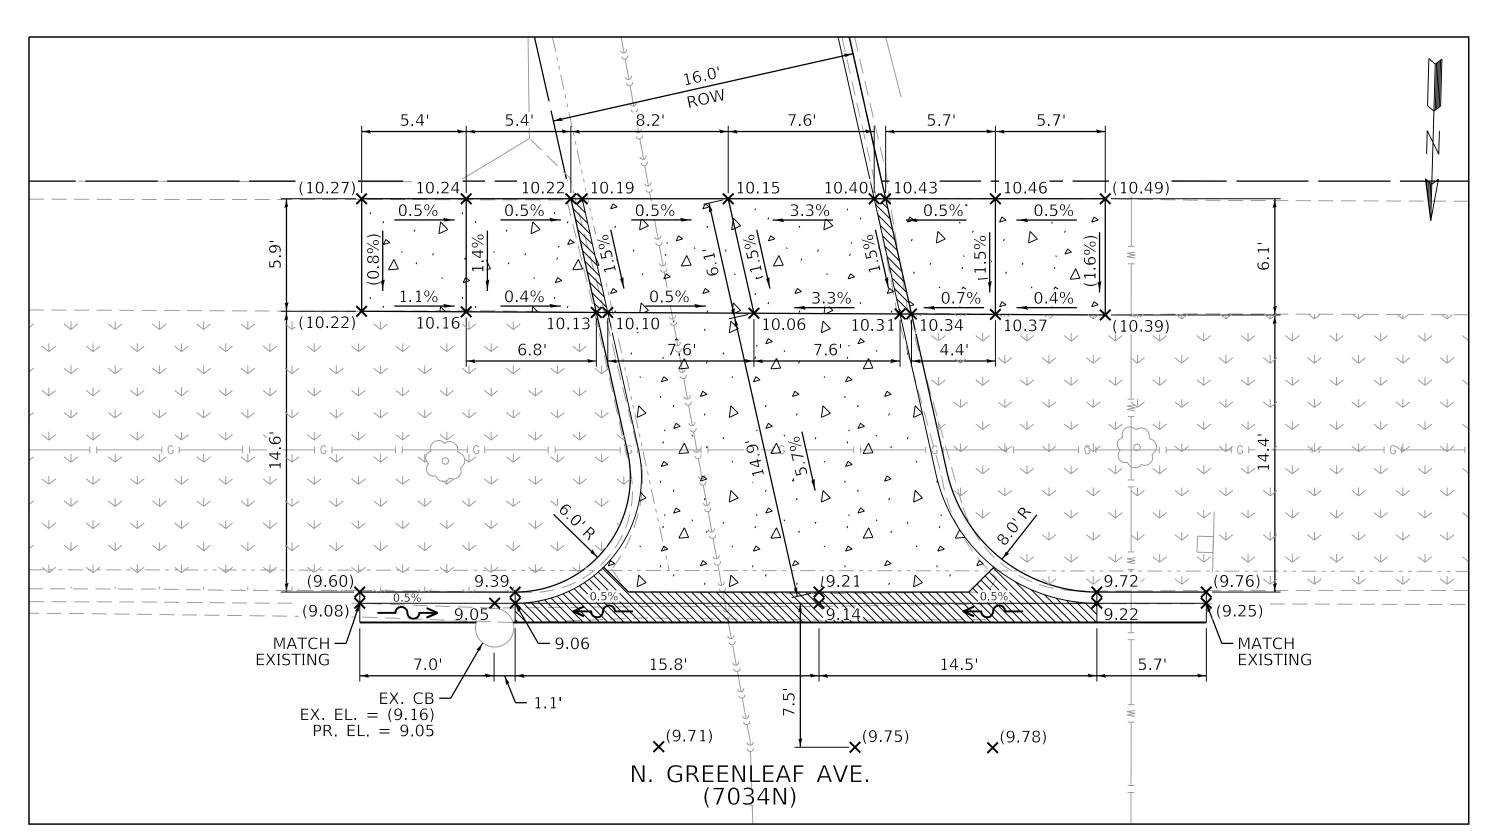

# PROPOSED ALLEY APRON DETAILS


1" = 5' NOTE: ALLEY RETURN WILL BE CONSTRUCTED IN PCC PAVEMENT. USE HES PCC BASE COURSE AT T3 ALLEYS/DRIVEWAYS.



| 0 | USER NAME = AB              | DESIGNED - | AP         | REVISED -                   |
|---|-----------------------------|------------|------------|-----------------------------|
|   |                             | DRAWN -    | AP         | REVISED -                   |
|   | PLOT SCALE = 5.0000 ' / in. | CHECKED -  | SJ         | REVISED -                   |
| ? | PLOT DATE = 7/1/2025        | DATE -     | 07/01/2025 | ISSUED FOR BID - 07/10/2025 |
|   |                             |            |            |                             |


| ALLEY APRON DETAILS   |  |  |  |  |
|---|--|--|--|--|
| PBC PROJECT NO #22926   |  |  |  |  |
| W. GREENLEAF AVENUE - W. LUNT AVENUE<br>N. GLENWOOD AVENUE - N. SHERIDAN ROAD |  |  |  |  |


|      | OUC NUMBER     | COUNTY    | SHEETS | NO. |
|------|----------------|-----------|--------|-----|
|      | OUC IR #123805 | COOK      | 24     | 10  |
| STA. | TO STA.        | SCALE: AS | SHOWN  |     |
|      |                |           |        |     |

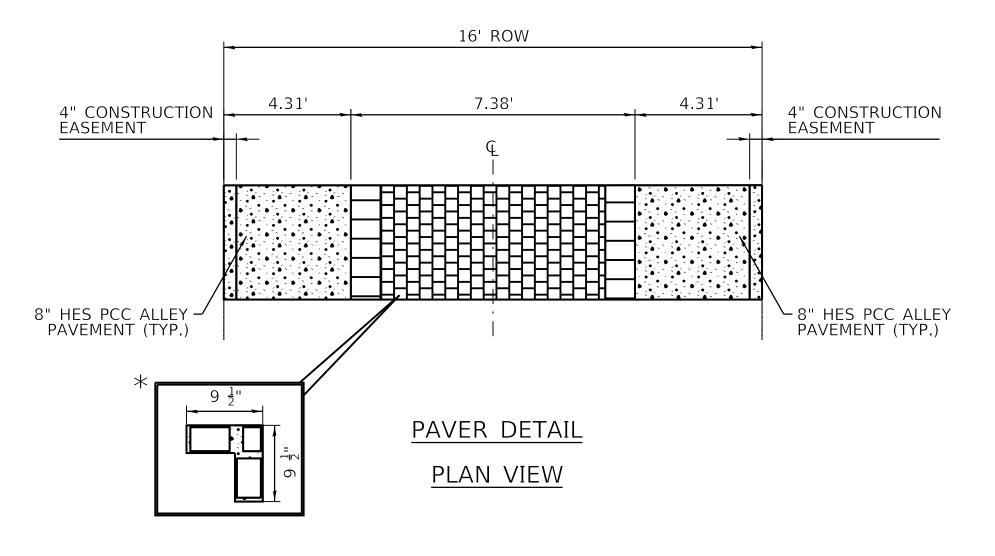

### NOTE:

- ALL DIMENSIONS ARE BASED ON UNILOCK DATA. CONTRACTOR IS TO FIELD VERIFY DIMENSIONS AND TEST LAYOUT PRIOR TO COLLAR CONSTRUCTION.
   \* INDIVIDUAL PREFABRICATED "L"SHAPED UNILOCK PAVER.
   GEOTEXTILE FABRIC SHOULD BE A WOVEN MATERIAL. ALL CA-1, CA-6, AND CM-7 MATERIALS SHOULD BE WASHED AND FREE OF FILES TO PRESERVE INFILTRATION CAPACITY.
   MAXIMUM GAP SIZE BETWEEN BRICK PAVER AND 8" PCC HES PAVEMENT IS ½".
   0.33' FILL OR PCC WILL BE PAID AS ALLEY PAVEMENT.

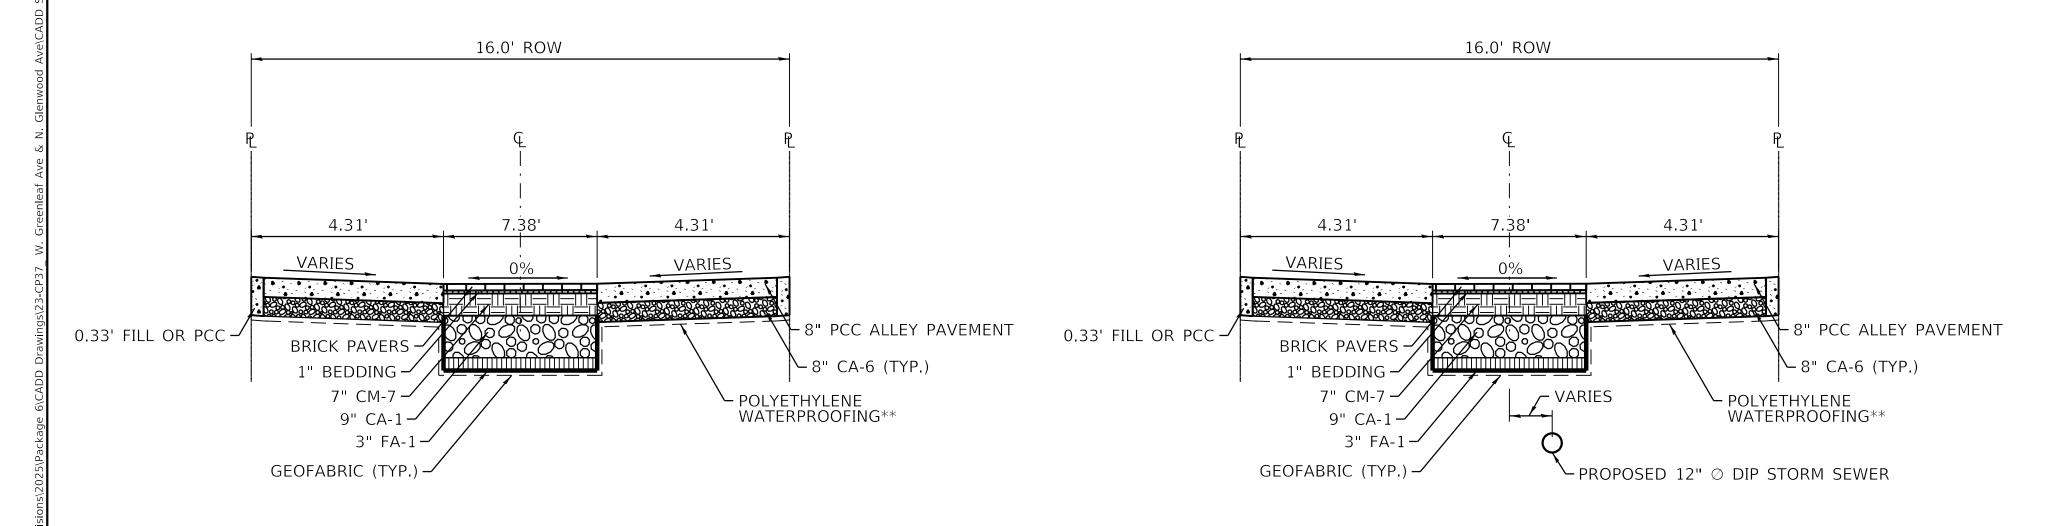

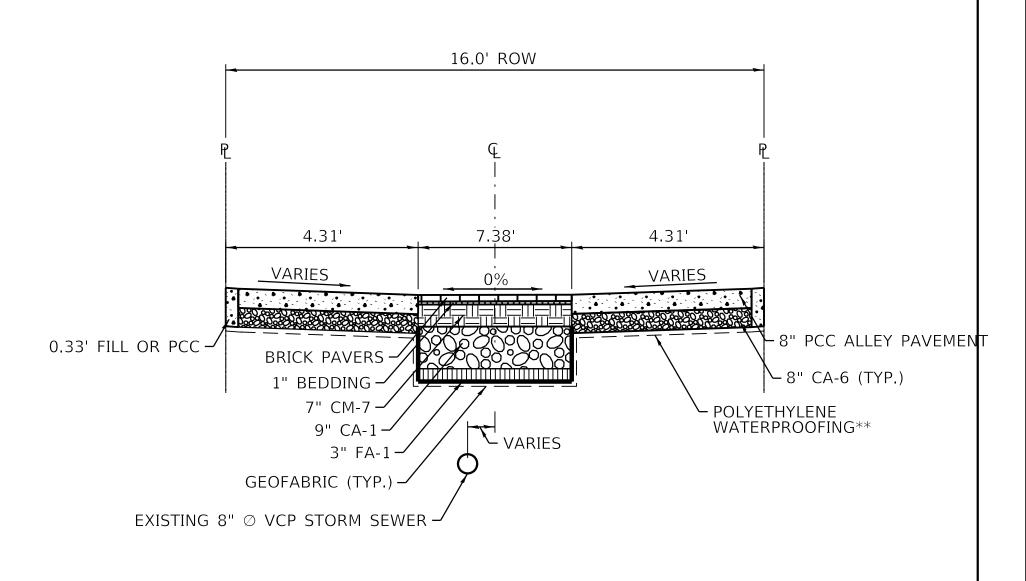

### PROPOSED TYPICAL CROSS SECTION A-A

STA. 0+00 TO STA. 4+60 STA. 10+00 TO STA. 11+83

# NOTE:

\*\* POLYETHYLENE WATERPROOFING LINER IS REQUIRED WHEN PAVER SECTION OF ALLEY IS ADJACENT TO BUILDING FOUNDATION

NOTE: 0.33' FILL OR PCC WILL BE PAID FOR AS 8" ALLEY PAVEMENT, CA-6, OR PULVERIZED TOPSOIL MIX W/ HYDROSEED.

## PROPOSED TYPICAL CROSS SECTION B-B

STA. 4+60 TO STA. 7+17

### PROPOSED TYPICAL CROSS SECTION C-C

STA 11+83 TO STA 13+71


| $\geq$ | OF CHIP |                |
|--------|---------|----------------|
| NAME:  |         | - Anna         |
| Ā      |         | <b>X</b> UUU I |
| ш      |         |                |


| CHICAGO | USER NAME = AB              | DESIGNED - | AP         | REVISED -            |
|---------|-----------------------------|------------|------------|----------------------|
| D D     |                             | DRAWN -    | AP         | REVISED -            |
|         | PLOT SCALE = 5.0000 ' / in. | CHECKED -  | SJ         | REVISED -            |
| X///.   | PLOT DATE = 7/1/2025        | DATE -     | 07/01/2025 | REVISED - 07/10/2025 |


CITY OF CHICAGO **DEPARTMENT OF TRANSPORTATION** 49th WARD

TYPICAL SECTIONS PBC PROJECT NO #22926 W. GREENLEAF AVENUE - W. LUNT AVENUE N. GLENWOOD AVENUE - N. SHERIDAN ROAD

TOTAL SHEET SHEETS NO. OUC NUMBER COUNTY 24 11 OUC IR #123805 COOK SCALE: NTS

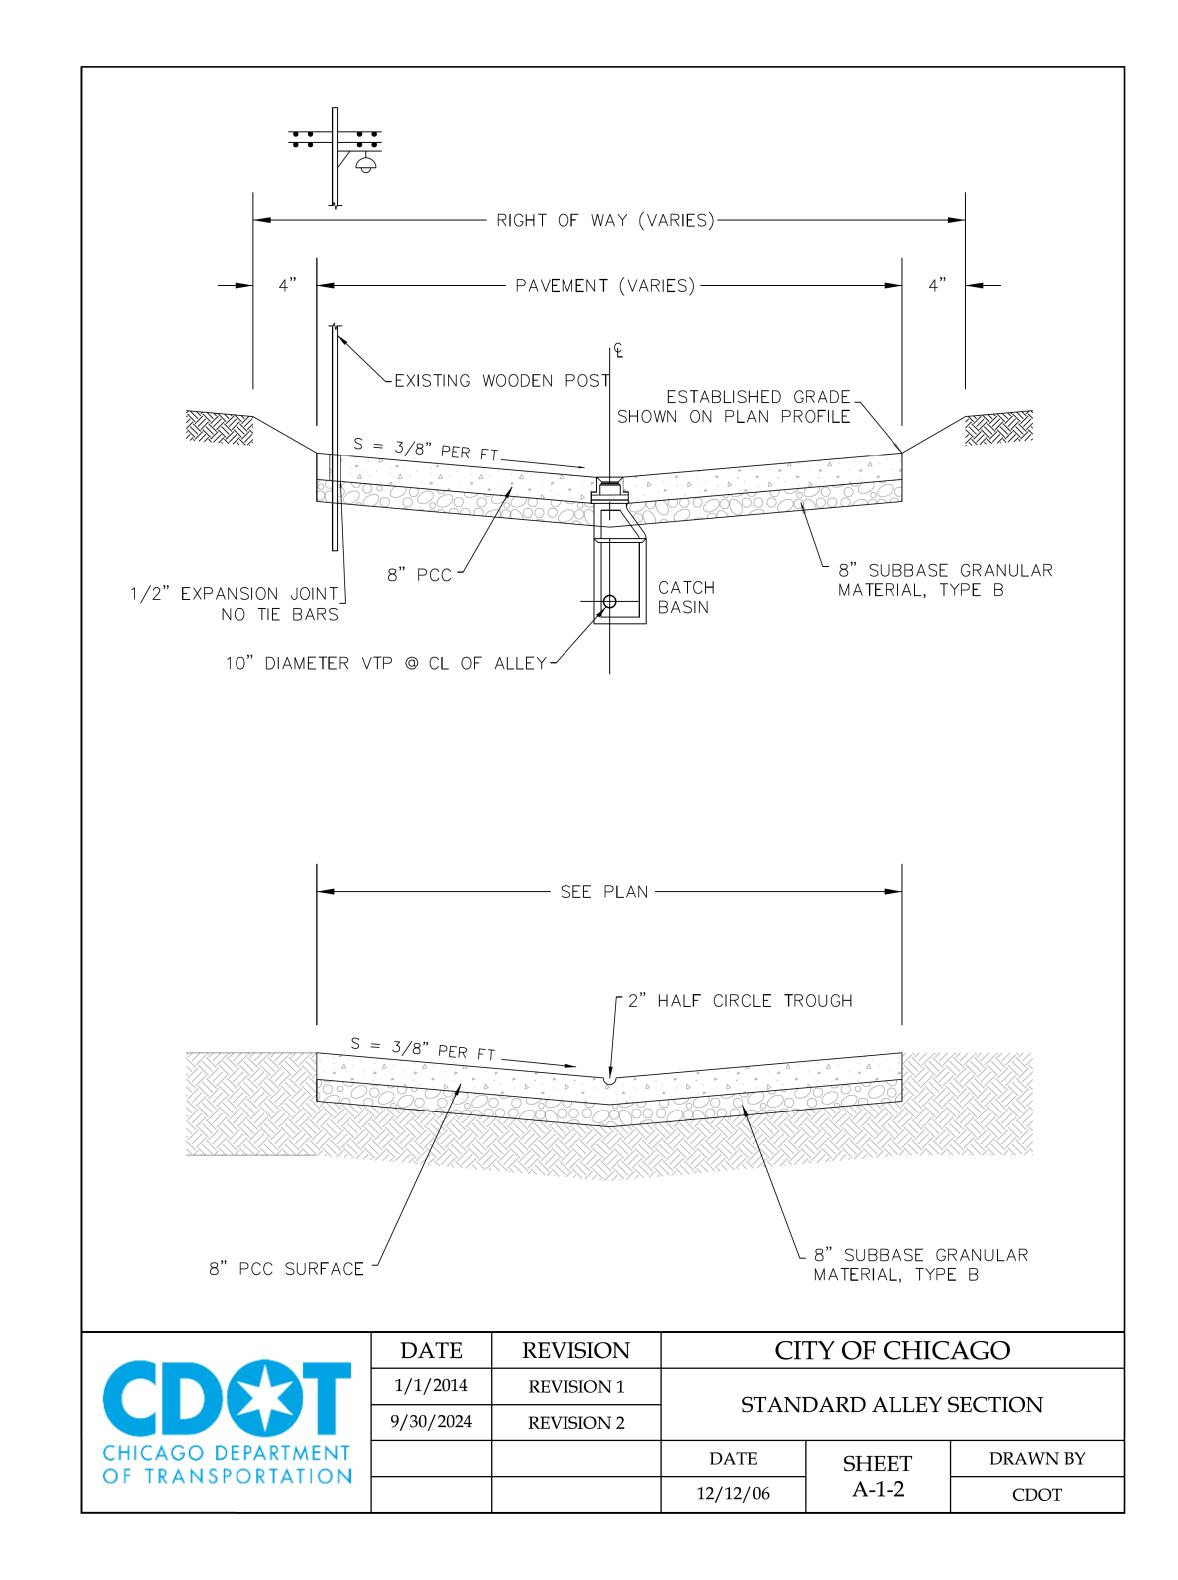

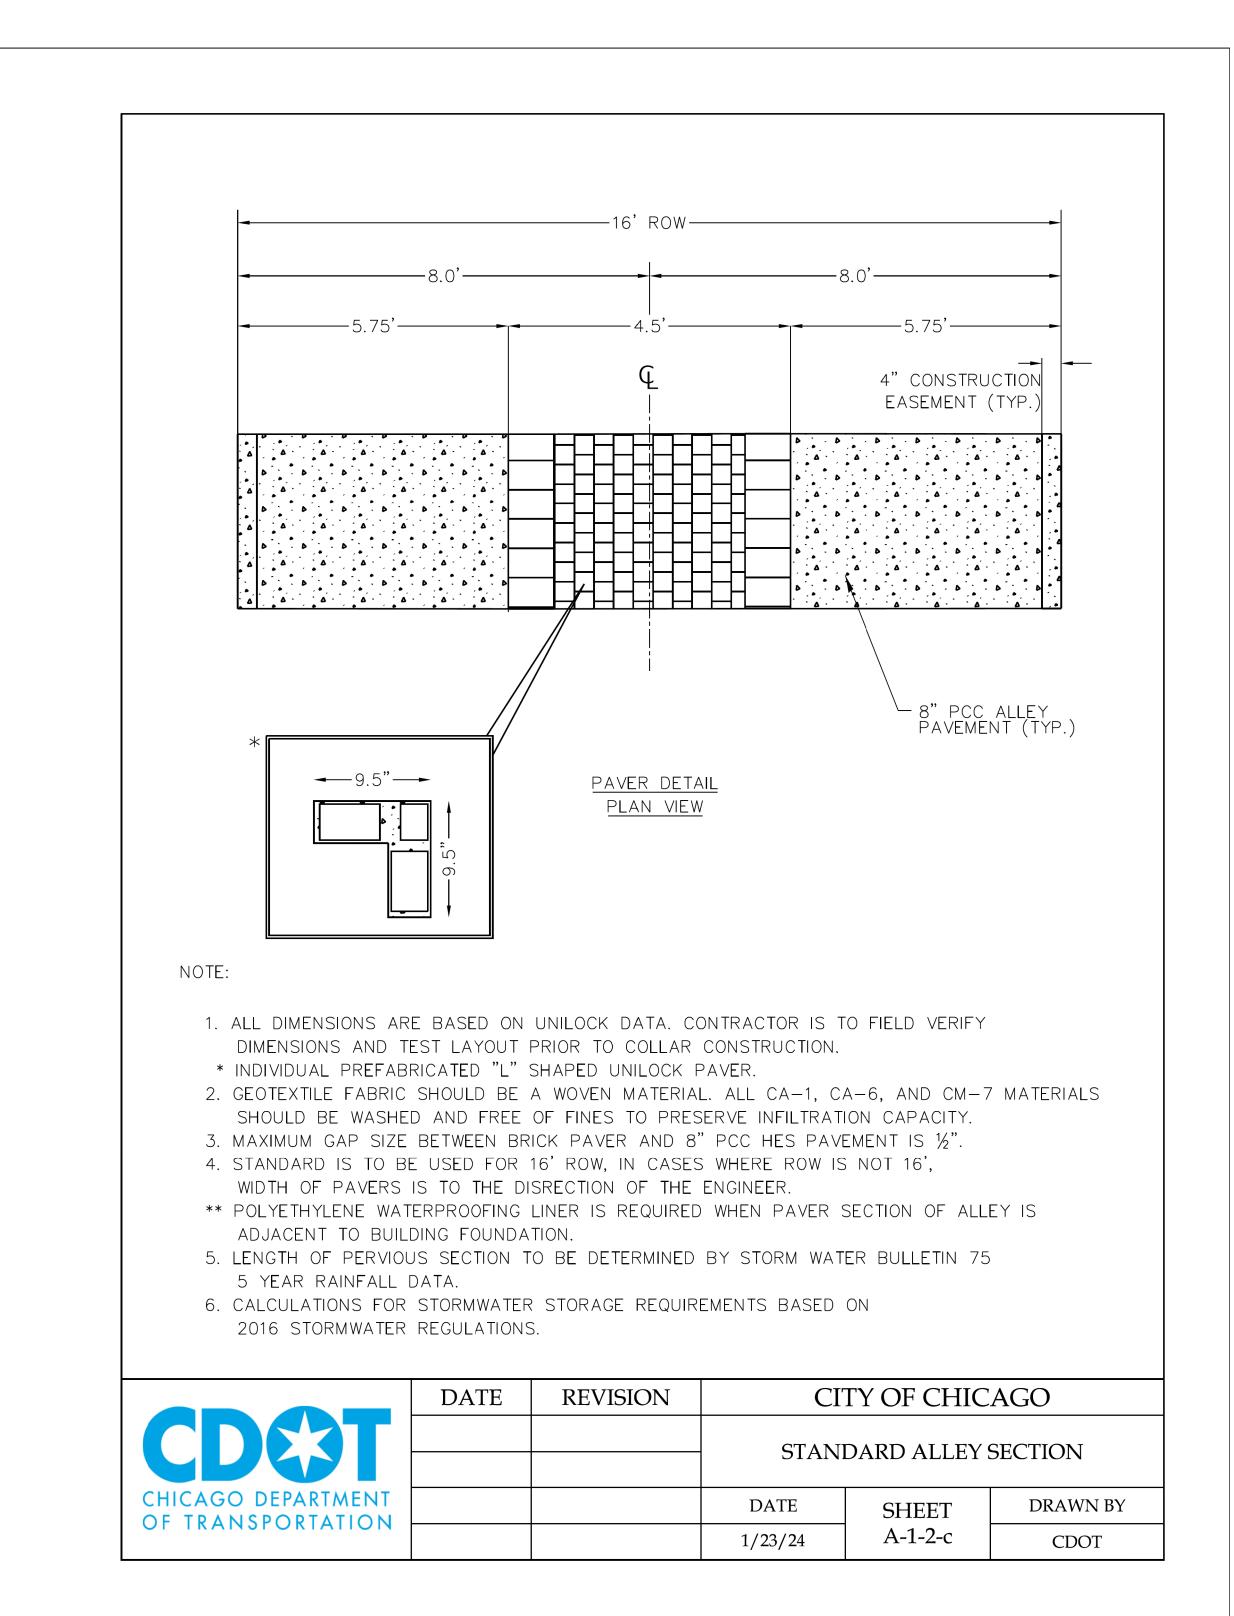

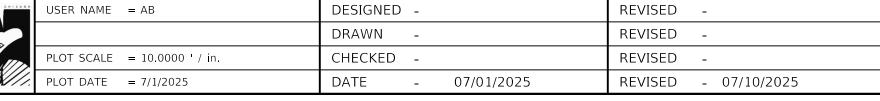

TRANSVERSE JOINTS OF A TYPE SIMILAR TO THAT USED IN THE ADJACENT PAVEMENT SHALL BE INSTALLED IN THE CURB, GUTTER AND COMBINED CURB & GUTTER IN PROLONGATION WITH THE JOINTS IN THE PAVEMENT. THE DETAILS OF THE TRANSVERSE JOINTS IN THE CURB, GUTTER AND COMBINED CURB & GUTTER SHALL BE APPROVED BY THE COMMISSIONER. CURB, GUTTER OR COMBINED CURB & GUTTER IS CONSTRUCTED ADJACENT TO A FLEXIBLE BASE PAVEMENT, 1" THICK EXPANSION JOINTS COMPOSED OF BITUMINOUS PERFORMED JOINT FILLER SHALL BE INSTALLED IN THE CURB AND/OR GUTTER AT POINTS OF CURVATURE AND AT CONSTRUCTION JOINTS. CONTRACTION JOINTS SHALL


JOINTS IN CURB, COMBINED CURB & GUTTER


ALSO BE PLACED BETWEEN THESE EXPANSION JOINTS AT DISTANCES NOT EXCEEDING 20 FEET. ALL TIE BARS SHALL BE DEFORMED-ALL DOWEL BARS SHALL BE SMOOTH.


> NOTE: ALL TIE BARS AND DOWEL BARS TO BE EPOXY COATED.

\*AT LOCATIONS REQUIRING DEPRESSED CURBS SEE THE ADA STANDARDS FOR CONSTRUCTION DETAILS


|                                      | DATE     | REVISION   | CITY OF CHICAGO                  |       |          |
|--------------------------------------|----------|------------|----------------------------------|-------|----------|
| CDC3T                                | 1/1/2014 | REVISION 1 | CONCRETE CURB & GUTTER<br>DETAIL |       | GUTTER   |
|                                      |          |            |                                  |       |          |
| CHICAGO DEPARTMENT OF TRANSPORTATION |          |            | DATE                             | SHEET | DRAWN BY |
|                                      |          |            | 12/12/06                         | A-2-6 | CDOT     |

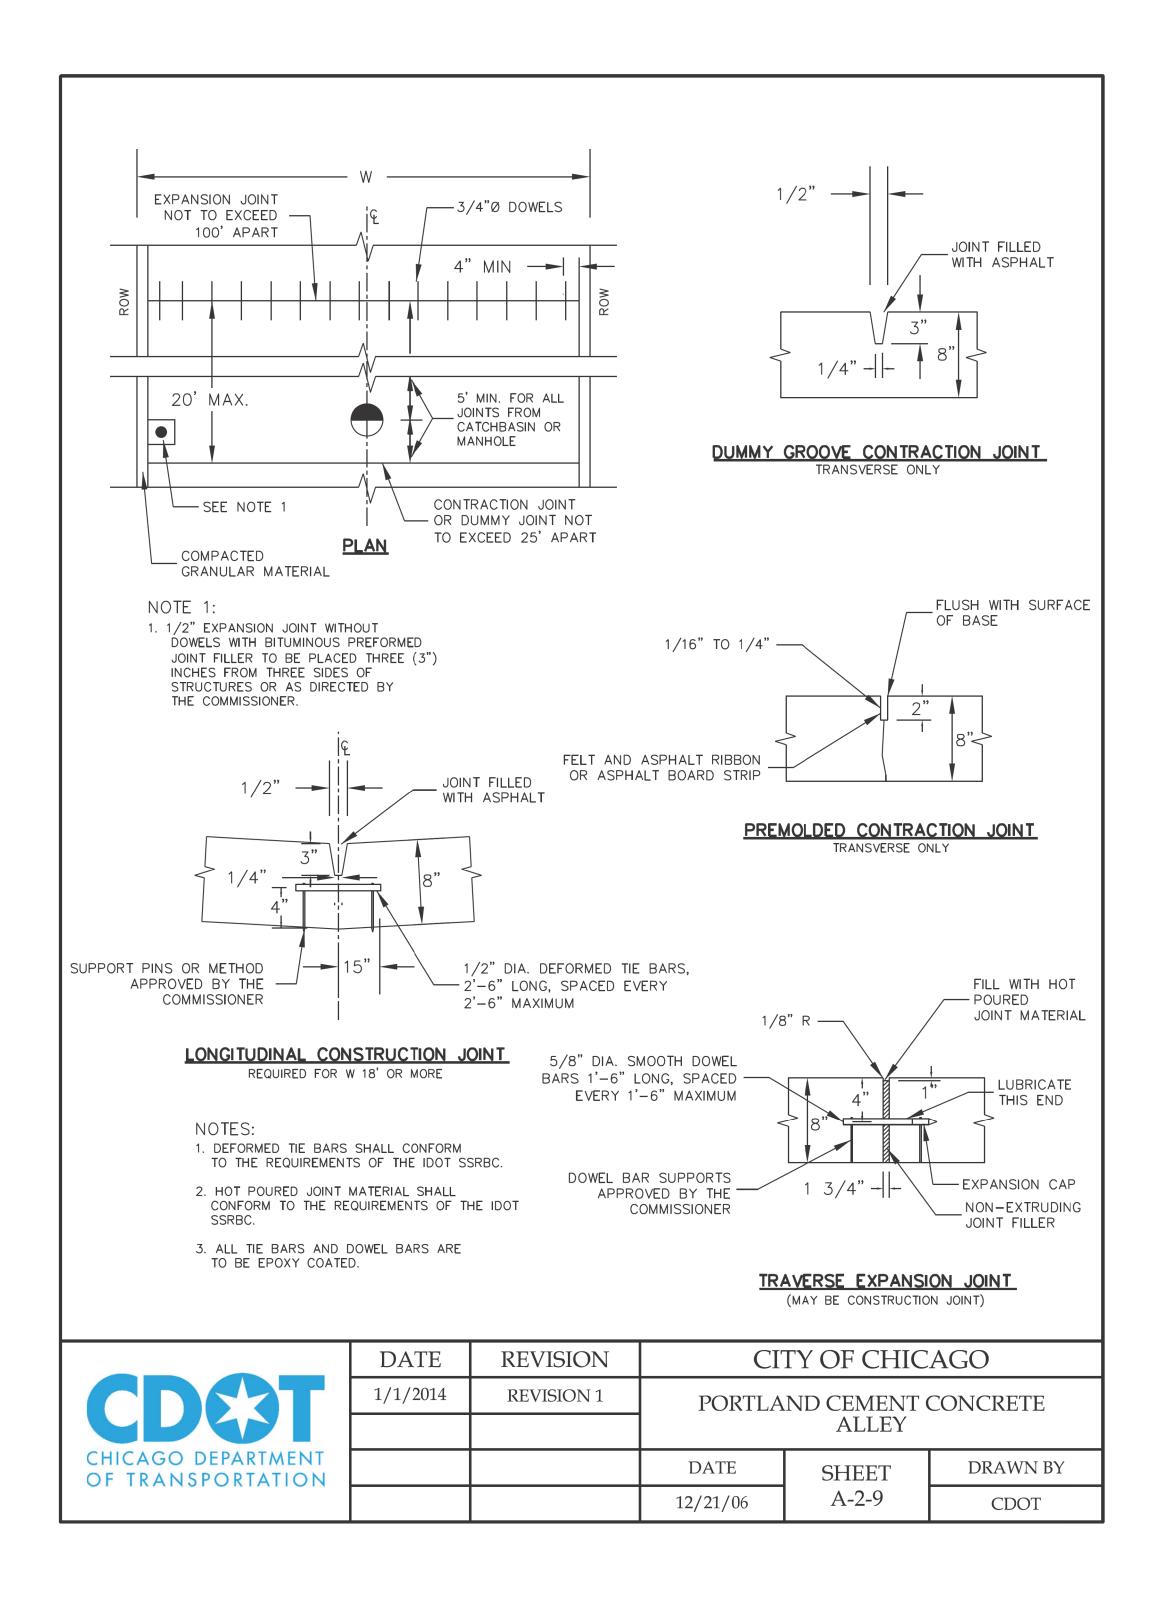


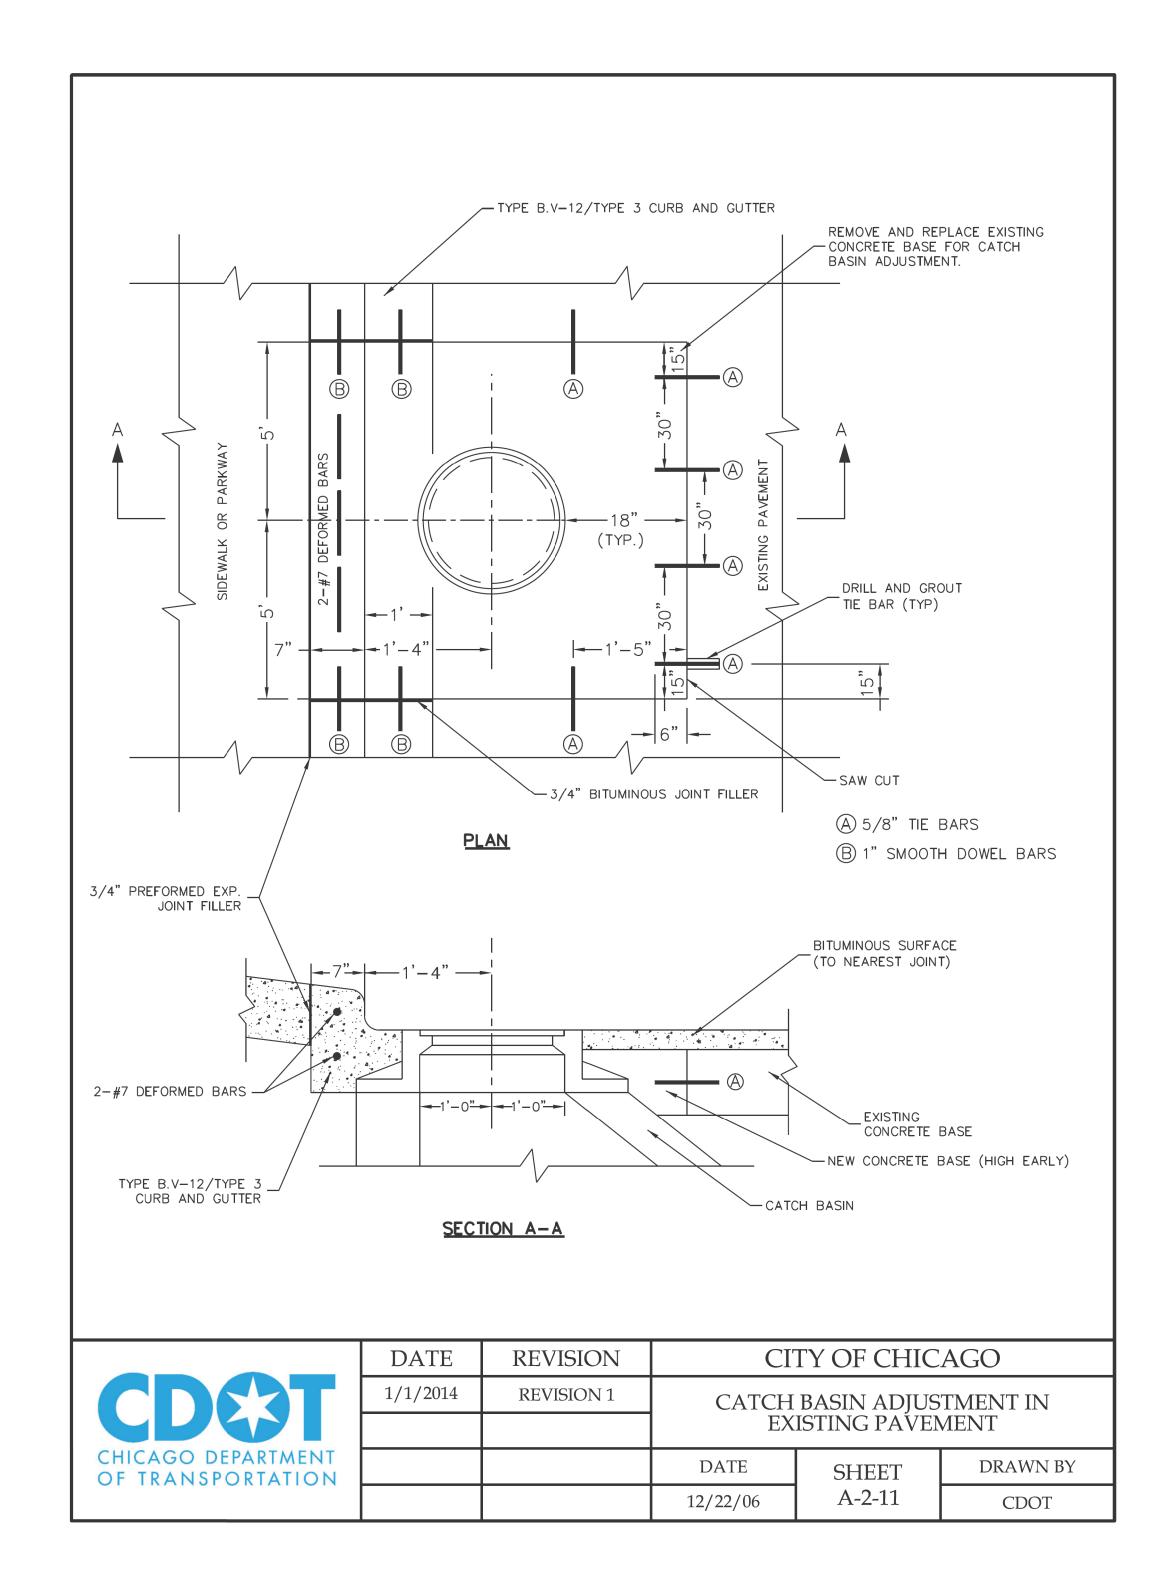


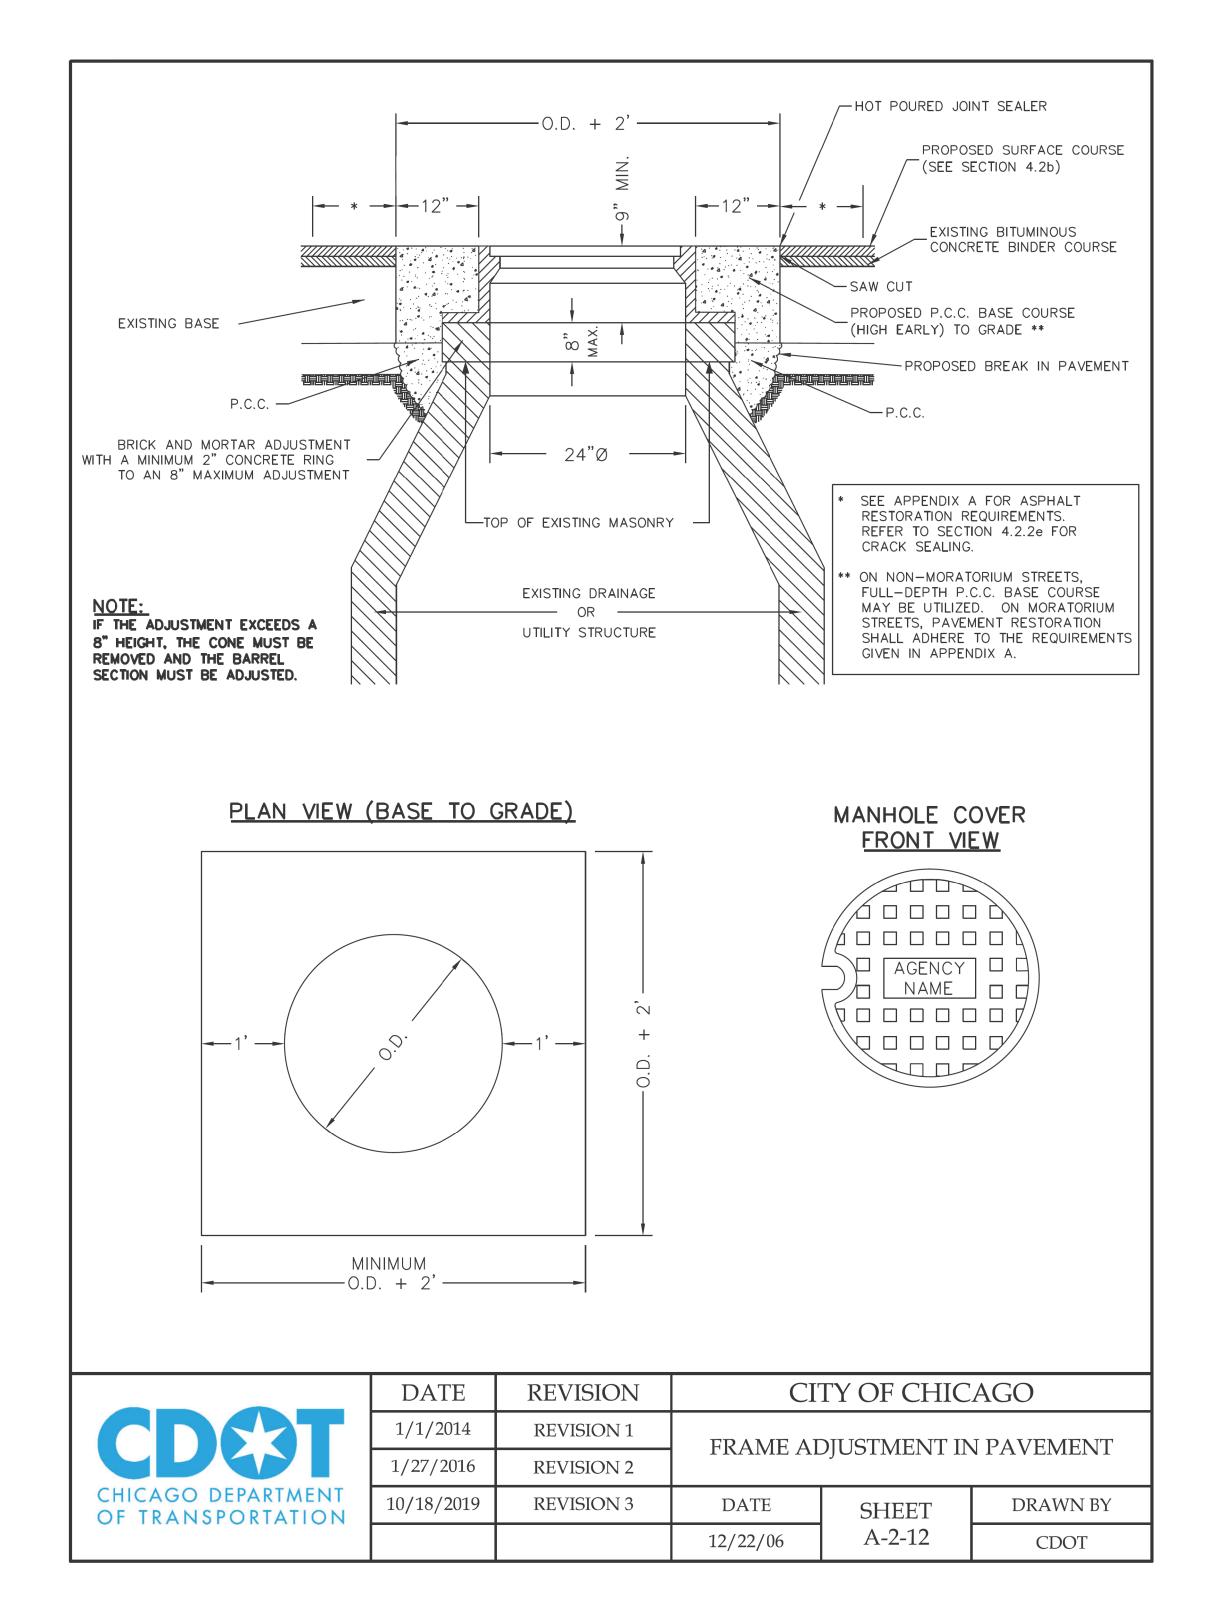



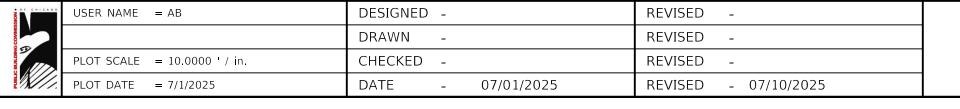


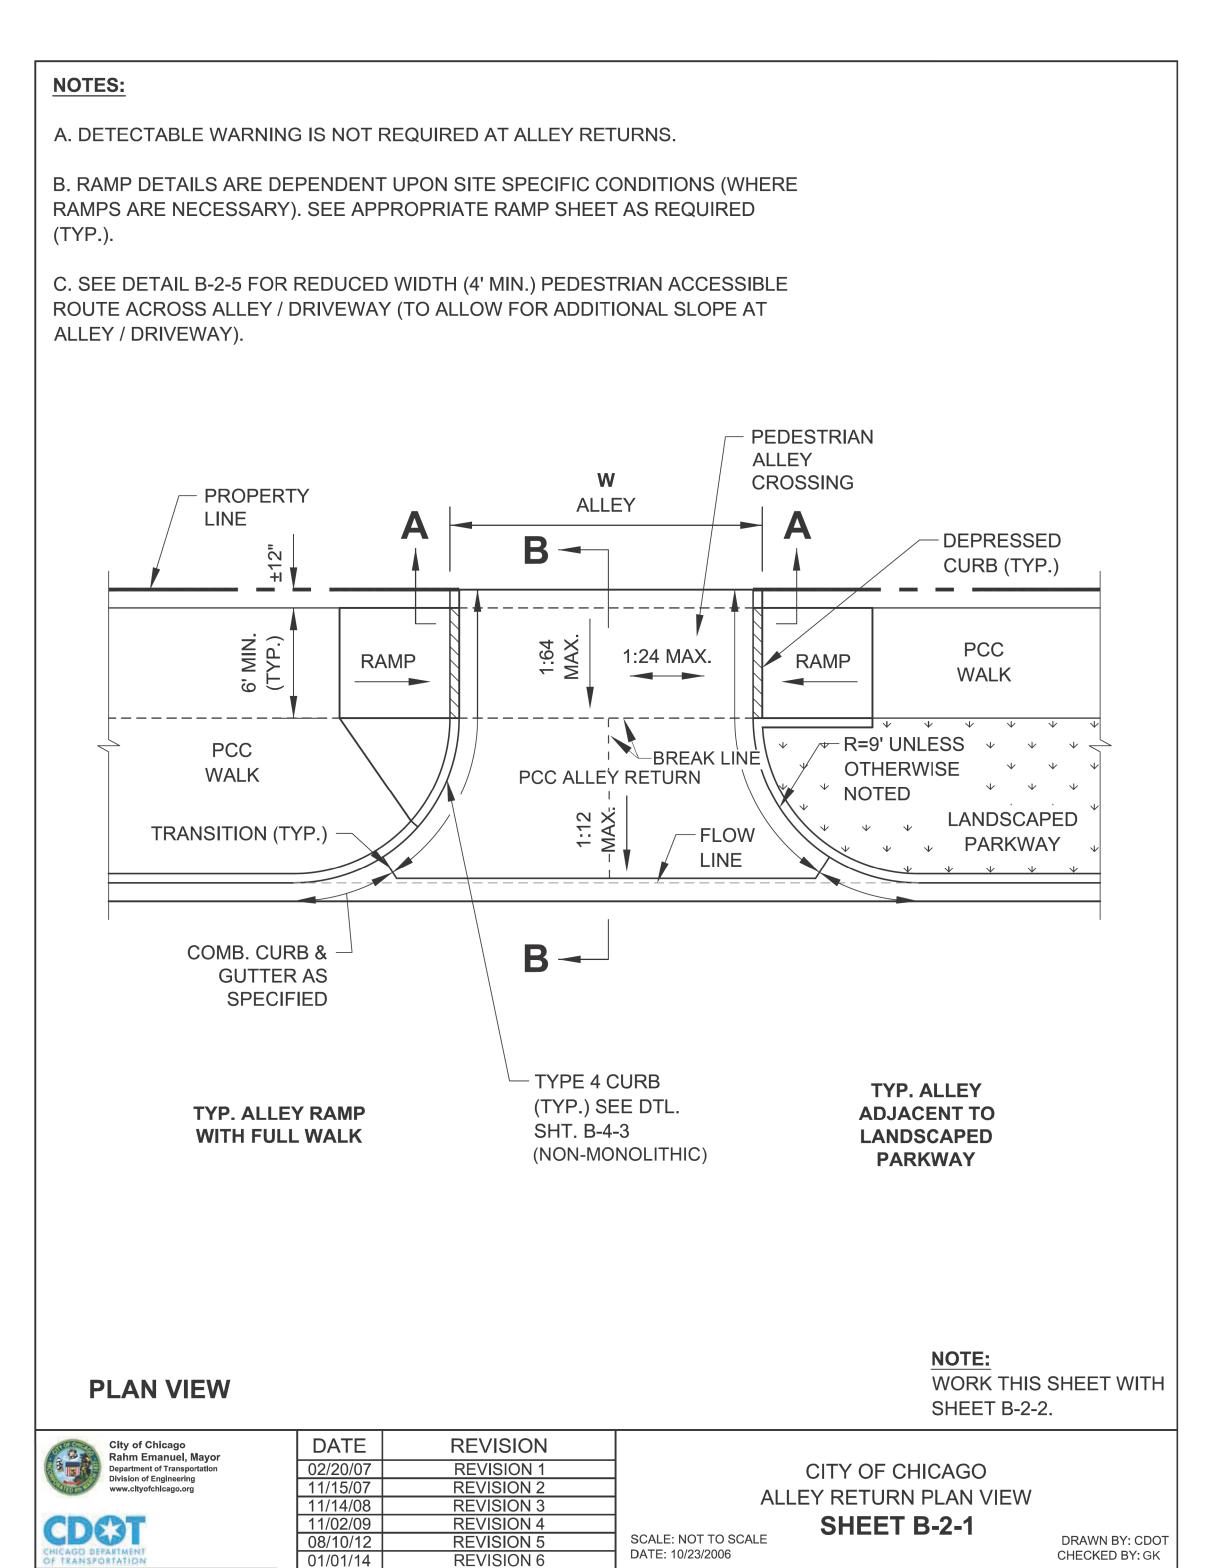

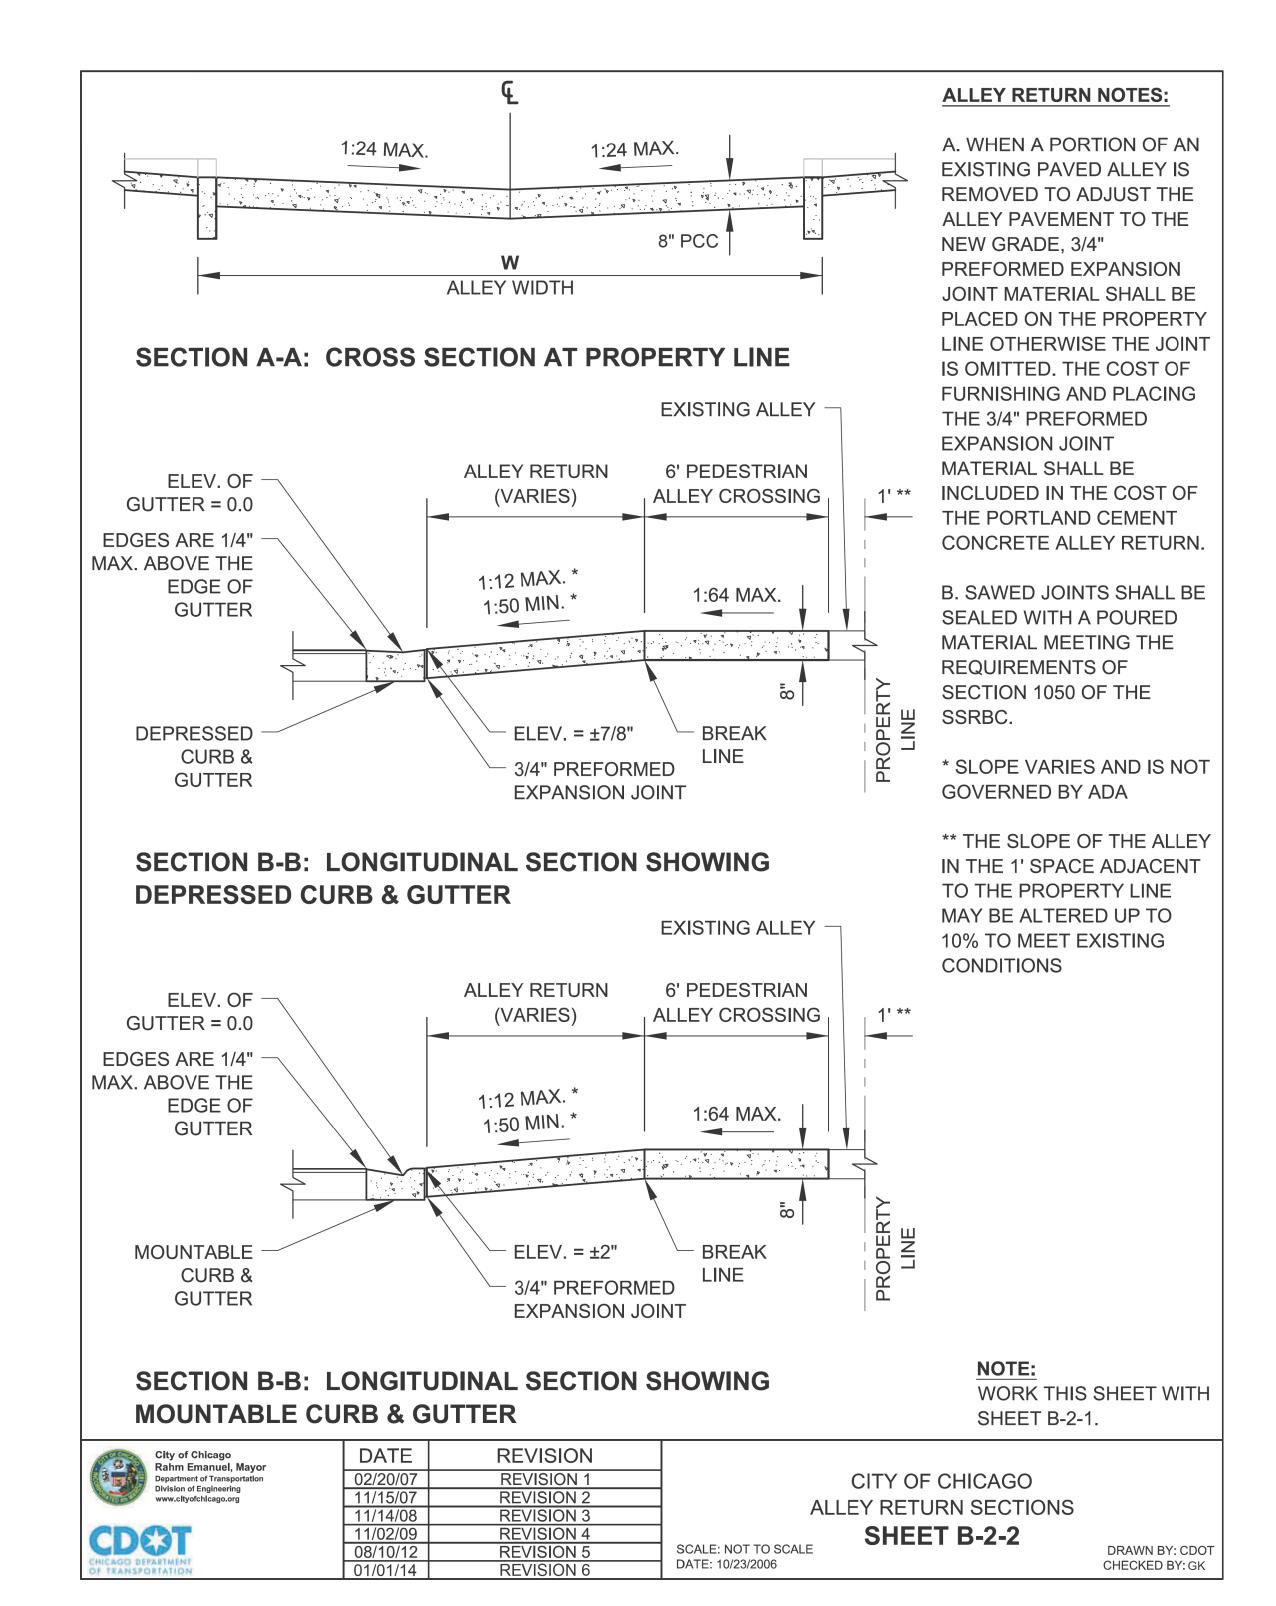


PBC PROJECT NO #22926



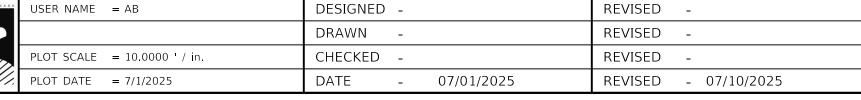

TOTAL SHEET NO. **CDOT STANDARD CONSTRUCTION DETAILS** OUC NUMBER COUNTY 24 15 OUC IR #123805 COOK W. GREENLEAF AVENUE - W. LUNT AVENUE SCALE: NTS N. GLENWOOD AVENUE - N. SHERIDAN ROAD

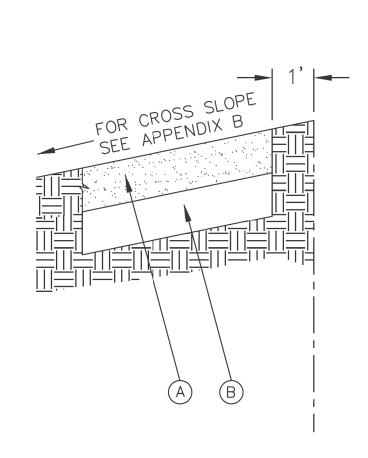

#### LEGEND:

- (A) PROPOSED 5" P.C.C. SIDEWALK \*
- B) SUBBASE GRANULAR MATERIAL, TYPE B OR C, 4"
  - \* CURB RAMP & KEYSTONE 8" P.C.C. AT SIGNALIZED AND INDUSTRIAL STREET INTERSECTIONS

|                                      | DATE     | REVISION   | CITY OF CHICAGO                                |       |          |  |
|--------------------------------------|----------|------------|--|-------|----------|--|
| CDC3T                                | 1/1/2014 | REVISION 1 | ADA COMPLIANT SIDEWALK<br>CONSTRUCTION DETAILS |       | DEWALK   |  |
|                                      |          |            |  |       | DETAILS  |  |
| CHICAGO DEPARTMENT OF TRANSPORTATION |          |            | DATE   | SHEET | DRAWN BY |  |
|                                      |          |            | 12/20/06 A-3-1                                 |       | CDOT     |  |

DESIGNED REVISED USER NAME = AB DRAWN REVISED CHECKED REVISED LOT SCALE = 10.0000 ' / in. PLOT DATE = 7/1/2025DATE - 07/01/2025 REVISED - 07/10/2025

# **CITY OF CHICAGO** 49th WARD

#### **CDOT STANDARD CONSTRUCTION DETAILS** PBC PROJECT NO #22926 W. GREENLEAF AVENUE - W. LUNT AVENUE N. GLENWOOD AVENUE - N. SHERIDAN ROAD

#### TOTAL SHEET SHEET NO. OUC NUMBER 24 16 COOK OUC IR #123805 SCALE: NTS

#### ADA COMPLIANCE AND TRANSITION GUIDELINES

POLICY STATEMENT: ANY ALTERATION OF THE PUBLIC WAY MUST BE RESTORED IN AN ADA COMPLIANT MANNER

#### I. STREET/ALLEY RESTORATION

FOR ANY PROJECT WHERE, WITHIN THE PROJECT LIMITS, A CROSSWALK IS ENCOUNTERED OR WHERE THE PROJECT LIMITS TERMINATE WITHIN 4' OR LESS OF A CROSSWALK, THOSE CROSSWALKS AND THE ASSOCIATED CURB RAMPS MUST BE IMPROVED TO CURRENT ADA STANDARDS IF THEY ARE NOT COMPLIANT (SEE APPENDIX A.)

WHEN A PROJECT CALLS FOR ONLY AN INTERSECTION TO BE REPAVED, THE INTERSECTION LIMITS AS DEFINED BY THE AREA OUTLINED BY OUTERMOST CROSSWALK LINES AND ADJACENT CURB FACES AND ALL ADJOINING CROSSWALKS AND CURB RAMPS MUST BE IMPROVED TO CURRENT ADA STANDARDS IF THEY ARE NOT COMPLIANT (SEE APPENDIX A).

WHEN WORK IS LIMITED TO A SINGLE CORNER OF AN INTERSECTION, THE CURB RAMP MUST BE IMPROVED TO CURRENT ADA STANDARDS AND THE ADJACENT PAVEMENT MUST BE RESURFACED, AS NECESSARY TO PROVIDE FOR A FLUSH TRANSITION (SEE APPENDIX A).

WHEN ADA WORK IS LIMITED TO A SINGLE CORNER OF AN INTERSECTION, THE ADJACENT PAVEMENT MUST BE RESTORED (SEE APPENDIX A).

FOR ANY CONSTRUCTION WHERE, WITHIN THE PROJECT LIMITS, AN ALLEY APRON IS ENCOUNTERED, THE ASSOCIATED CURB RAMPS, ALLEY APRON, AND SIDEWALKS MUST BE IMPROVED TO CURRENT ADA STANDARDS IF THEY ARE NOT COMPLIANT (SEE APPENDIX A).

#### II. SIDEWALK INSTALLATION / REPAIRS / RECONSTRUCTION

THE LIMITS OF ANY MAINLINE SIDEWALK REPLACEMENT, GREATER THAN TEN FEET (10') IN LENGTH, THAT ABUT AN EXISTING RAMP, KEYSTONE, TRANSITION PANEL, AND/OR LANDING AREA (THIS TOTAL LENGTH INCLUDES THE PRIOR ELEMENTS), SHALL BE EXTENDED TO INCLUDE THE AFFECTED RAMPS AND THESE RAMPS SHALL BE RECONSTRUCTED TO CURRENT ADA STANDARDS. IN ADDITION, ALL NEWLY PLACED SIDEWALK TEN FEET (10') OR MORE IN LENGTH SHALL BE CONSTRUCTED IN ACCORDANCE WITH ALL CURRENT APPLICABLE STANDARDS WHICH INCLUDE PROVIDING A MINIMUM FOUR FEET (4') WIDTH ACCESSIBLE PATHWAY WITH A CROSS SLOPE NOT TO EXCEED 1:64 (SEE APPENDIX A).

#### III. GUIDELINES FOR TRANSITIONING TO EXISTING NON-COMPLIANT CONDITION

NEW SIDEWALK PLACEMENTS GREATER THAN TEN FEET IN CONTIGUOUS LENGTH:

THE LIMITS OF ANY MAINLINE SIDEWALK REPLACEMENT, GREATER THAN TEN FEET (10') IN LENGTH, MUST BE EXTENDED FOR A MINIMUM FIVE ADDITIONAL FEET (5') EITHER SIDE IN ORDER TO PROVIDE A TRANSITION TO MATCH THE EXISTING SIDEWALK. THE LENGTH OF TRANSITION SHALL BE LENGTHENED AS NECESSARY TO ENSURE THAT THE RUNNING SLOPE OF THE TRANSITION DOES NOT EXCEED A SLOPE OF 1:24 (PREFERRED) OR 1:14 (MAXIMUM) AT ANY POINT.

NEW SIDEWALK REPLACEMENTS TEN FEET OR LESS IN CONTIGUOUS LENGTH (REPAIRS):

IT IS ACCEPTABLE PRACTICE TO MATCH ADJACENT SIDEWALKS AT THE EXISTING SLOPE.

#### **CURB RAMP REPLACEMENTS**

WHEN REPLACING AN ADA RAMP. THE SIDEWALK REPLACEMENT MUST EXTEND BEYOND THE LIMITS OF THE LANDING AREA AND/OR THE "KEYSTONE" A MINIMUM OF AN ADDITIONAL FIVE FEET (5') ON EITHER SIDE IN ORDER TO PROVIDE A TRANSITION TO MATCH THE EXISTING SIDEWALK. THE TRANSITION PANEL SHALL BE LENGTHENED AS NECESSARY TO ENSURE THAT THE RUNNING SLOPE OF THE TRANSITION PANEL DOES NOT EXCEED A SLOPE OF 1:24 (PREFERRED) OR 1:14 (MAXIMUM) AT ANY POINT.

NO EXCEPTIONS TO THE ABOVE WILL BE ALLOWED WITHOUT WRITTEN APPROVAL FROM THE COMMISSIONER.

City of Chicago
Rahm Emanuel, Mayor
Department of Transportation
Division of Engineering
www.cityofchicago.org



| DATE     | REVISION   |
|----------|------------|
| 02/20/07 | REVISION 1 |
| 11/15/07 | REVISION 2 |
| 11/14/08 | REVISION 3 |
| 11/02/09 | REVISION 4 |
| 08/10/12 | REVISION 5 |
| 01/01/14 | REVISION 6 |
|          |            |


CITY OF CHICAGO ADA COMPLIANCE AND TRANSITION GUIDELINES

**SHEET B-3-4** SCALE: NOT TO SCALE


DATE: 10/23/2006

DRAWN BY: CDOT CHECKED BY: GK

**DEPARTMENT OF TRANSPORTATION** 

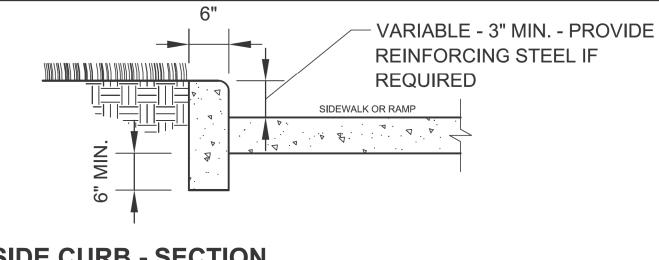

### **SIDE CURB - SECTION**

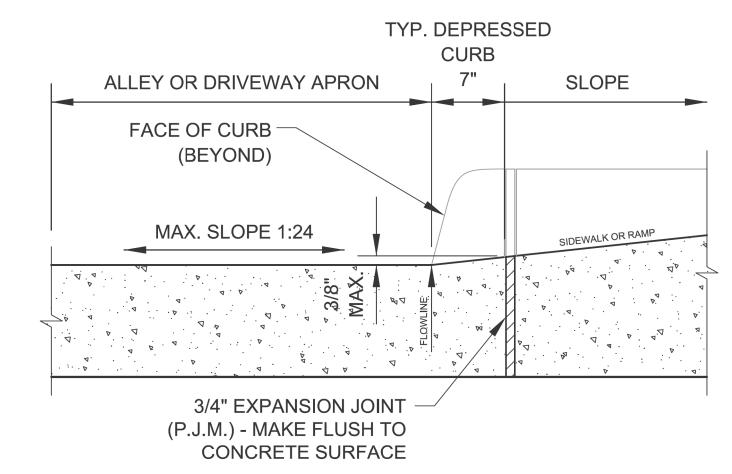

# **DEPRESSED CURB & GUTTER**

AT ALLEY/DRIVEWAY APRON (TYPE 4 OR B CURB)

#### **NOTES FOR CURB & GUTTER DETAILS THIS SHEET:**


A. CROSS SLOPE AT DEPRESSED CURB & GUTTER NOT TO EXCEED 1:64.

B. DETECTABLE WARNING SURFACE AT DRIVEWAYS REQUIRED ONLY FOR COMMERCIAL DRIVEWAYS WITH TRAFFIC CONTROL DEVICES, I.E. SIGNALS.

C. REFER TO REGULATIONS FOR OPENINGS, CONSTRUCTION AND REPAIR IN THE PUBLIC WAY (CDOT) FOR ADDITIONAL REQUIREMENTS FOR CURB AND GUTTER INSTALLATION.

D. RAMP SIDE FLARES SHALL BE INSTALLED AT ANY LOCATION WHERE THE SURFACE ADJACENT TO THE RAMP SURFACE IS INTENDED FOR PEDESTRIAN USE. TRIPPING HAZARDS, INCLUDING STEPS, DROP-OFFS, OR SIDE CURBS SHALL NOT BE LOCATED WITHIN THE LIMITS OF THE SIDEWALK.

E. 'P.J.M.' THIS SHEET REFERS TO PREFORMED JOINT MATERIAL.

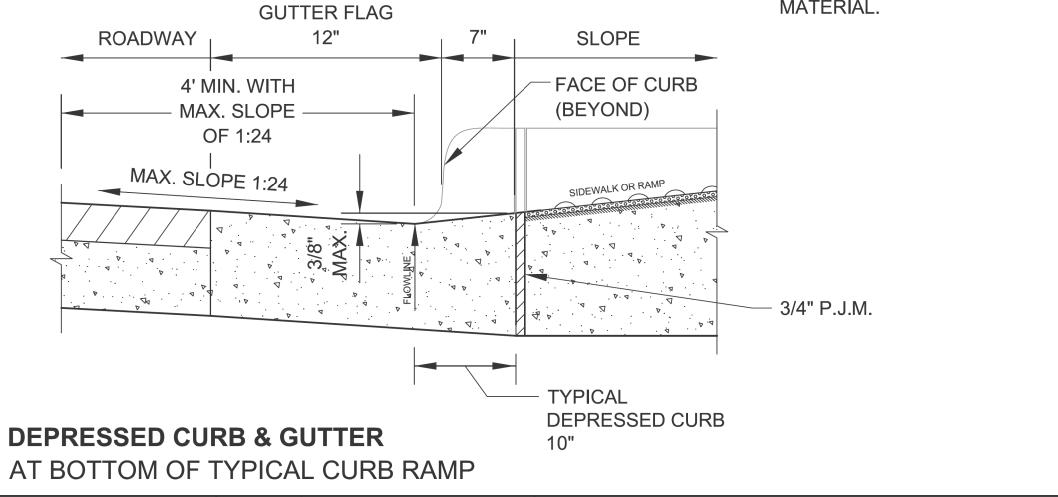

DATE: 10/23/2006

| E                             | City of Chicago Rahm Emanuel, Mayor Department of Transportation Division of Engineering www.cityofchicago.org |
|-------------------------------|--|
| CD<br>CHICAGO BI<br>OF TRANSP | PARTMENT ORTATION  |


| DATE     | REVISION   |
|----------|------------|
| 02/20/07 | REVISION 1 |
| 11/15/07 | REVISION 2 |
| 11/14/08 | REVISION 3 |
| 11/02/09 | REVISION 4 |
| 08/10/12 | REVISION 5 |
|          |            |


CITY OF CHICAGO **CURB & GUTTER DETAILS SHEET B-4-3** SCALE: NOT TO SCALE

DRAWN BY: CDOT CHECKED BY: LCM

| CHICAGO | USER NAME = AB               | DESIGNED -        |
|---------|------------------------------|-------------------|
|         |                              | DRAWN -           |
|         | PLOT SCALE = 10.0000 ' / in. | CHECKED -         |
| ///.    | PLOT DATE = 7/1/2025         | DATE - 07/01/2025 |
|         |                              |                   |

REVISED REVISED REVISED REVISED - 07/10/2025

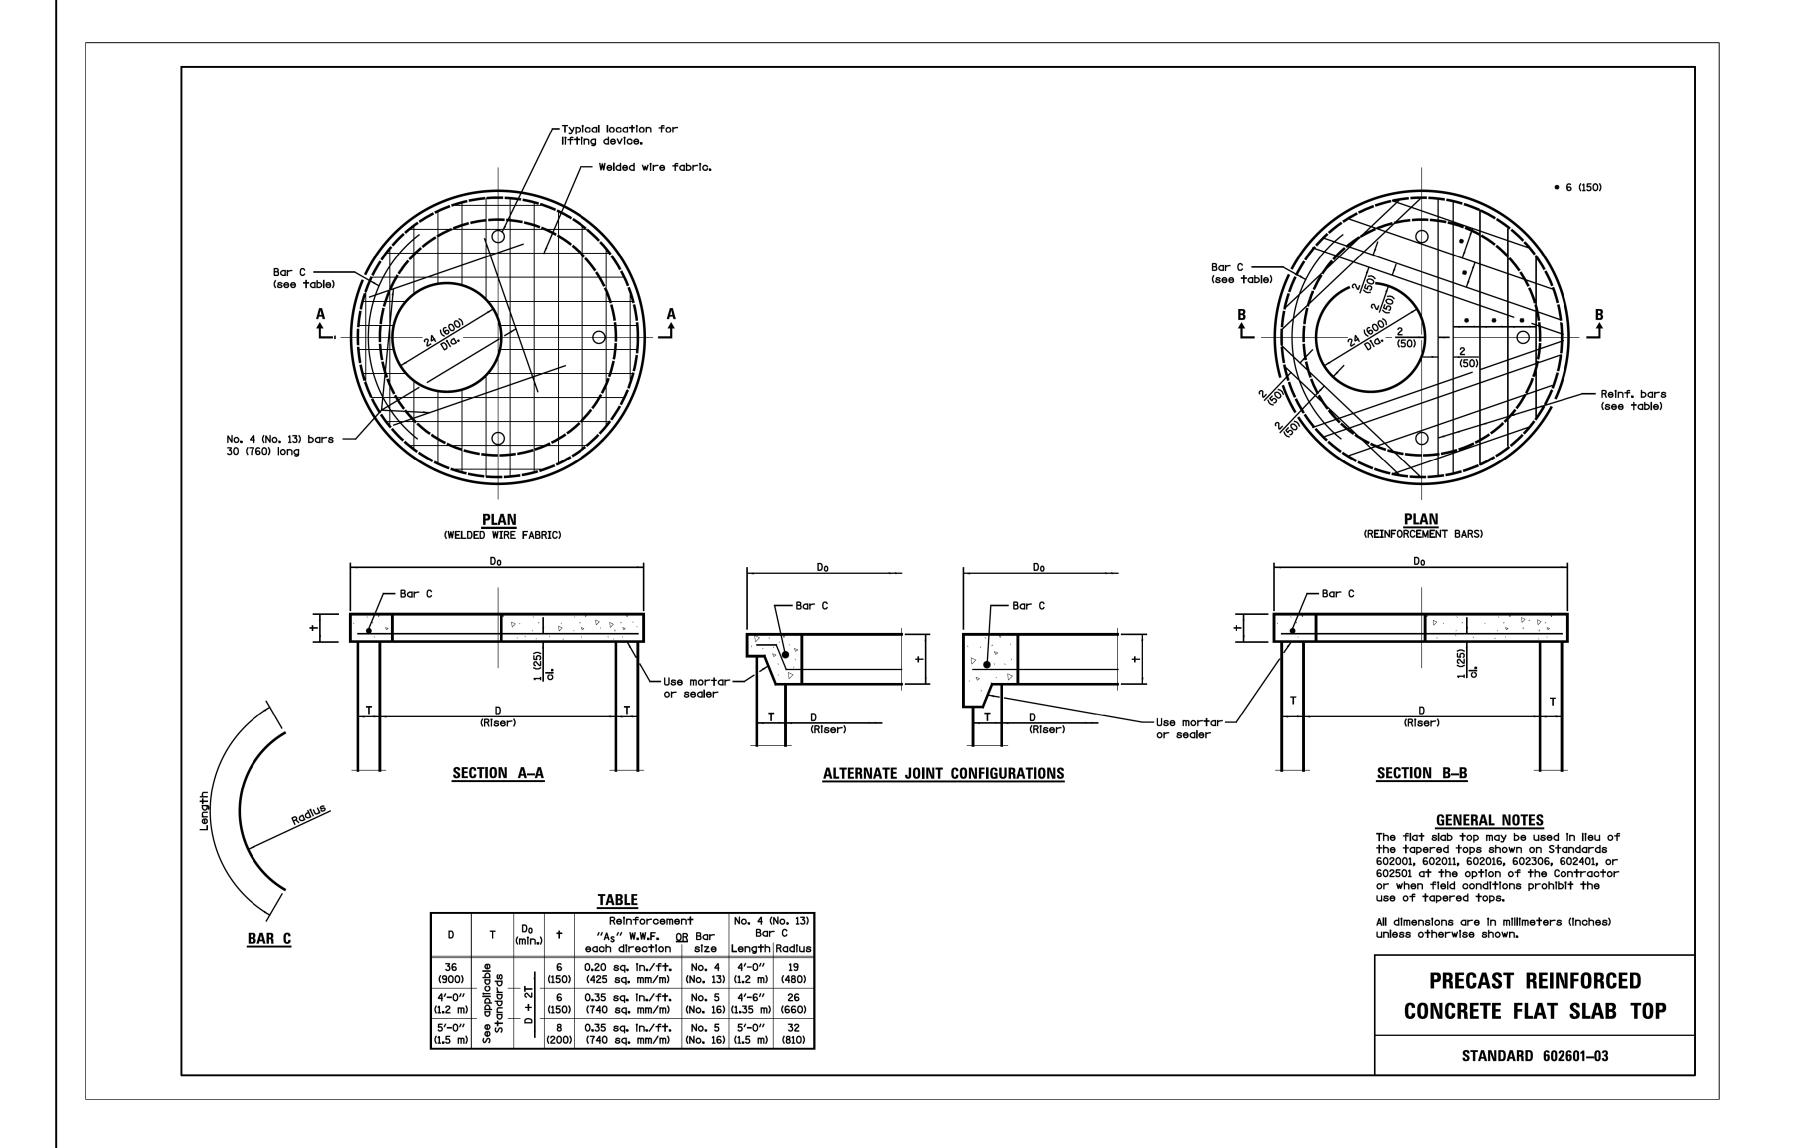

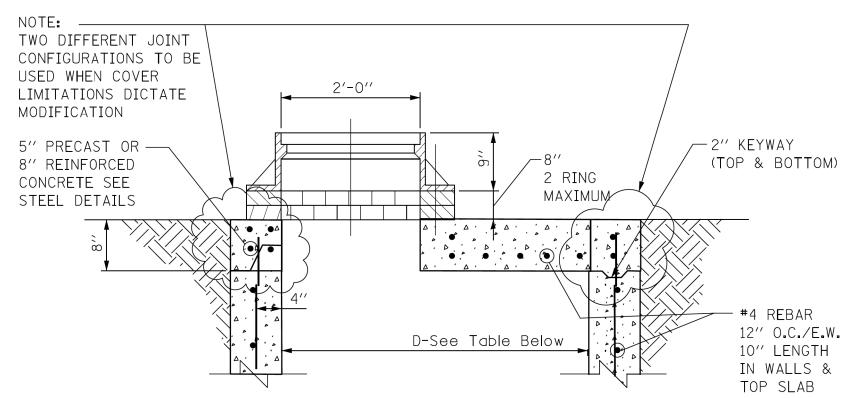

STANDARD FLAT TOP SLAB
FOR CATCH BASINS

FLAT TOP SLAB AAPLICATION CAN ONLY BE USED WITH WRITTEN PERMISSION FROM CDWM. USE LATEST IDOT DETAIL, #602601

|                    |        |                      | _                |       |      |                         |
|--------------------|--------|----------------------|------------------|-------|------|-------------------------|
| STANDARD REVISIONS |        |                      | PERCENT COMPLETE | DATE  | CITY |                         |
| D                  | ATE    | DESCRIPTION          |                  | 70    |      | DEPARTMENT<br>BUREAU OF |
|                    | /5 /45 | ADDDOVED DI AN       | 1                | 30    |      | BUNEAU OF               |
|                    | ./5/15 | <u>APPROVED_PLAN</u> |                  | 60    |      |                         |
|                    |        |                      | ]                | 75    |      | FLAT TO                 |
|                    |        |                      |                  | 90    |      |                         |
|                    |        |                      |                  | 100   |      |                         |
|                    |        |                      | 1                | S === |      |                         |

DRAWN: SBW
DESIGNED: CHECKED: Y OF CHICAGO NT OF WATER MANAGEMENT OF ENGINEERING SERVICES TOP SLAB DETAILS BULLETIN


CDWM\_Details.cel 8/5/2015 10:30:51 AM


DESIGNED REVISED DRAWN REVISED CHECKED REVISED PLOT SCALE = 10.0000 ' / in. DATE REVISED - 07/10/2025 PLOT DATE = 7/1/2025- 07/01/2025

CITY OF CHICAGO 49th WARD

CDWM STANDARD CONSTRUCTION DETAILS PBC PROJECT NO #22926 W. GREENLEAF AVENUE - W. LUNT AVENUE N. GLENWOOD AVENUE - N. SHERIDAN ROAD

TOTAL SHEET NO. OUC NUMBER COOK 24 18 OUC IR #123805 SCALE: NTS

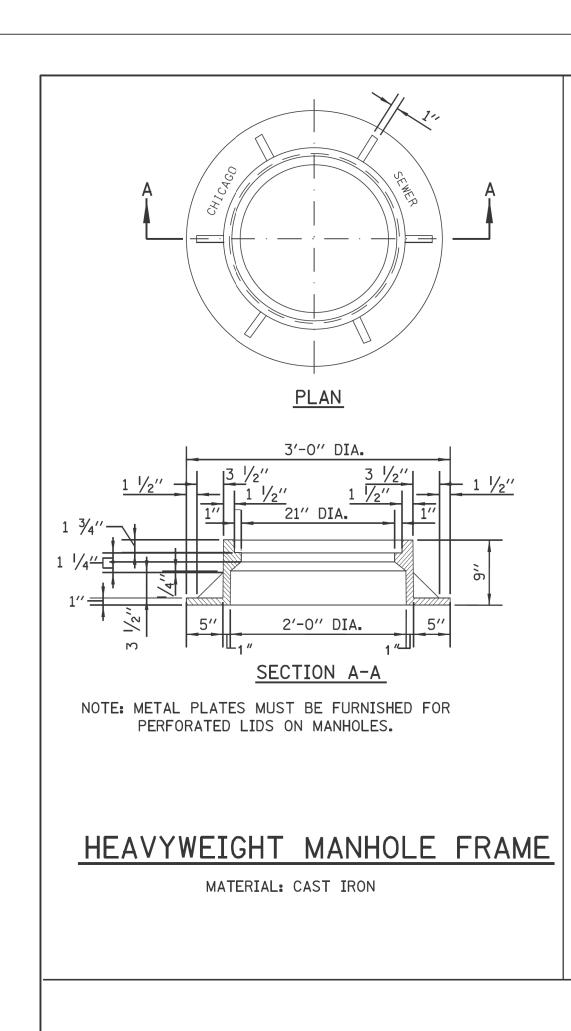

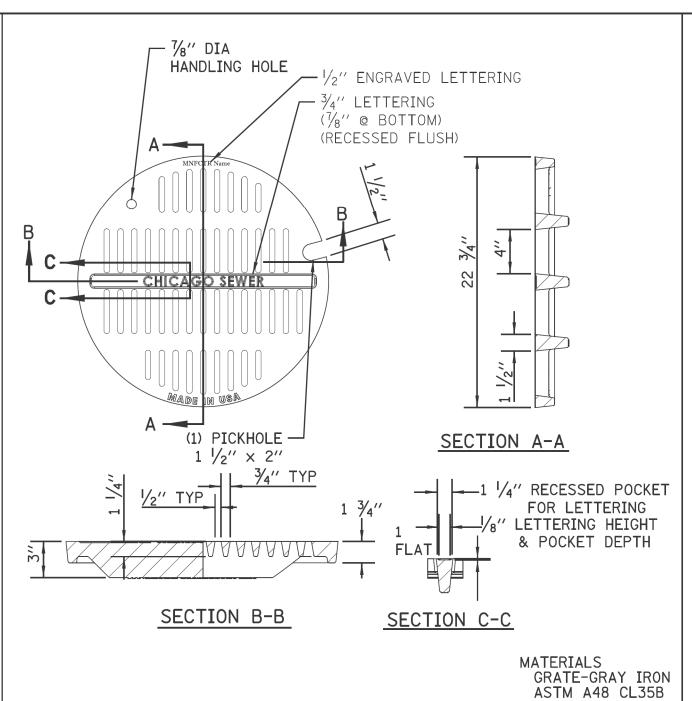

STANDARD CB/MH LID

NOTES: IF THE ADJUSTMENT EXCEEDS AN 8" HEIGHT, THE CONE MUST BE REMOVED AND THE BARREL SECTION MUST BE ADJUSTED. THE CONTRACTOR IS REQUIRED TO REPLACE ANY BROKEN FRAMES AND LIDS OF SEWER STRUCTURES WITH STANDARD MATERIALS GRATE-GRAY IRON ASTM A48 CL35B FRAMES AND LIDS OF THE DWM. IN ADJUSTMENT OR RECONSTRUCTION OF SEWER STRUCTURES, ANY NON-STANDARD FRAMES AND LIDS MUST BE REPLACED WITH STANDARD FRAMES AND LIDS. IN ADJUSTMENT OR RECONSTRUCTION OF INLETS, ANY NON-STANDARD INLETS (GUTTER BOXES) MUST BE DESIGN LOAD HEAVY DUTY REPLACED WITH DWM STANDARD INLETS. COATING THE FRAMES AND LIDS OF SEWER STRUCTURES TO BE ABANDONED, REMOVED, OR FILLED MUST BE SALVAGED AND THE DWM NOTIFIED FOR PICK UP.

UNDIPPED

OPEN AREA 85.6 SQ. IN.


A 5/8" TIE BARS 1" SMOOTH DOWEL BARS 3/4" PREFORMED EXP.\_ JOINT FILLER -NEW CONCRETE BASE (HIGH EARLY) TYPE B.V-12/TYPE 3\_ CURB AND GUTTER SECTION A-A

MANHOLES, CATCH BASINS AND INLETS MUST BE PROTECTED FROM THE ENTRY OF ASPHALT/DEBRIS

INTO THE SEWER SYSTEM DURING CONSTRUCTION. THE CONTRACTOR MUST MARK LOCATIONS OF ALL

SEWER STRUCTURES ON THE SIDEWALK BEFORE STARTING PAVEMENT REMOVAL/REPLACEMENT.

ADJUSTMENT OF FRAMES AND LIDS OF SEWER STRUCTURES MUST BE COMPLETED PRIOR TO STREET RESURFACING.

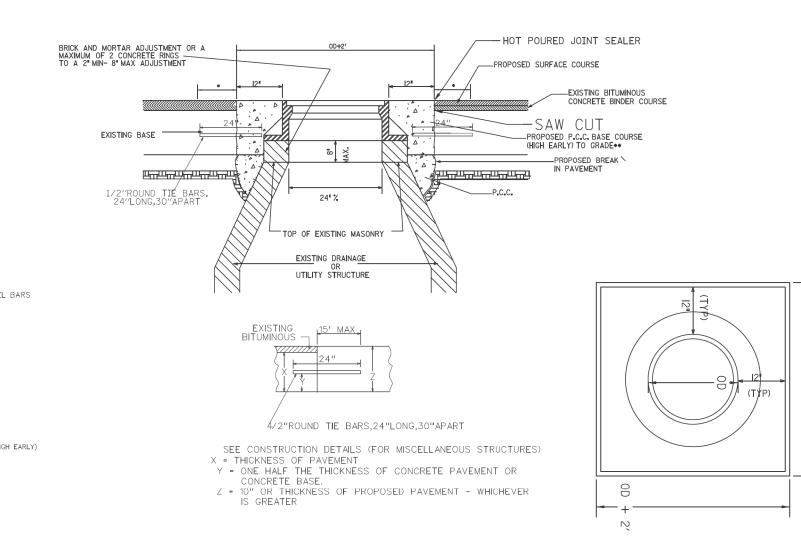


PLAN VIEW (BASE TO GRADE)


\*REFER TO CDOT FOR ASPHALT RESTORATION REQUIREMENTS & CRACK SEALING.


\*\* ON NON-MORATORIUM STREETS, FULL-DEPTH PCC BASE COURSE MAY BE UTILIZED. ON MORATORIUM

STREETS, PAVEMENT RESTORATION SHALL ADHERE T CDOT REQUIREMENTS.

# DETAIL OF FRAME ADJUSTMENT

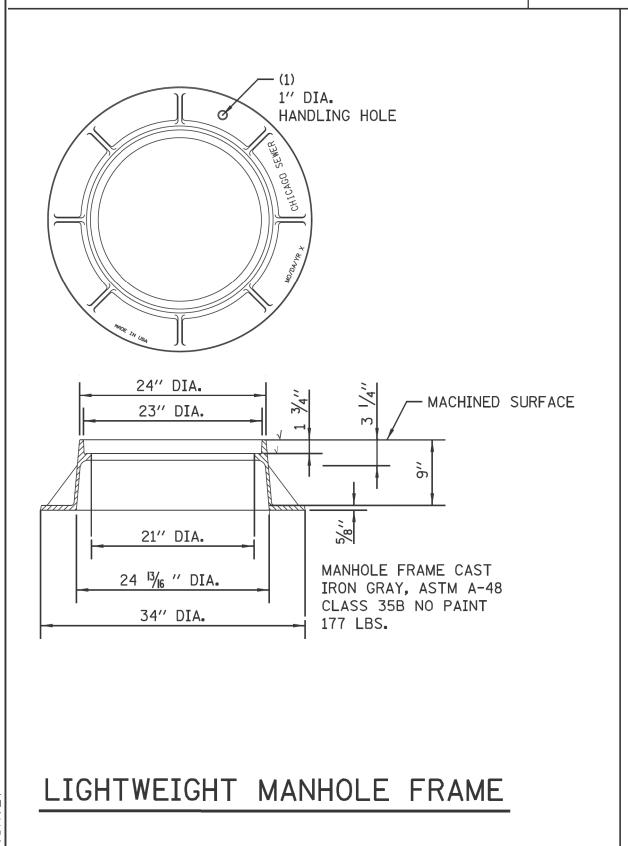

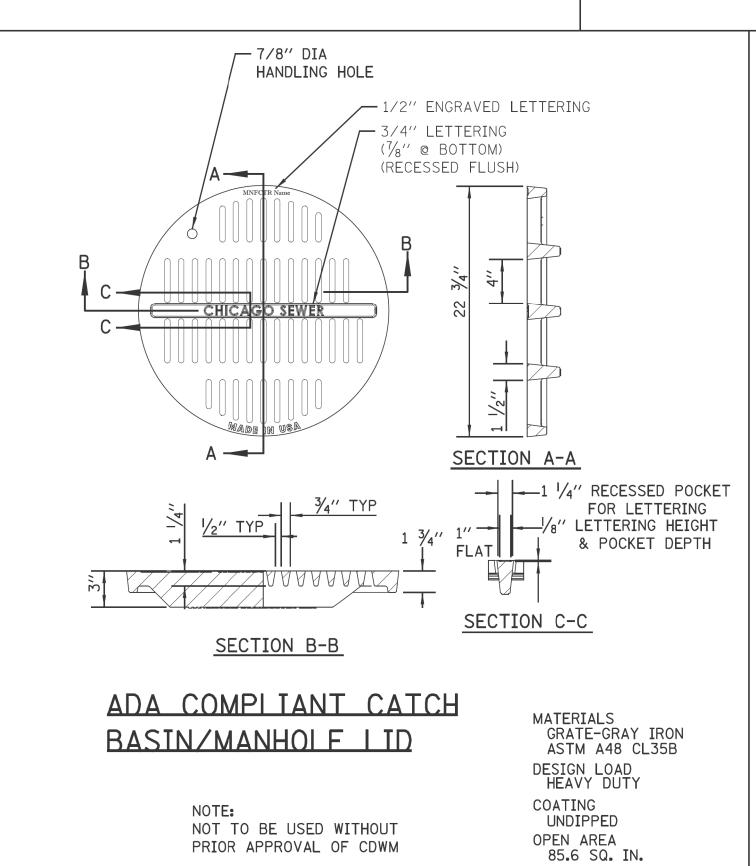

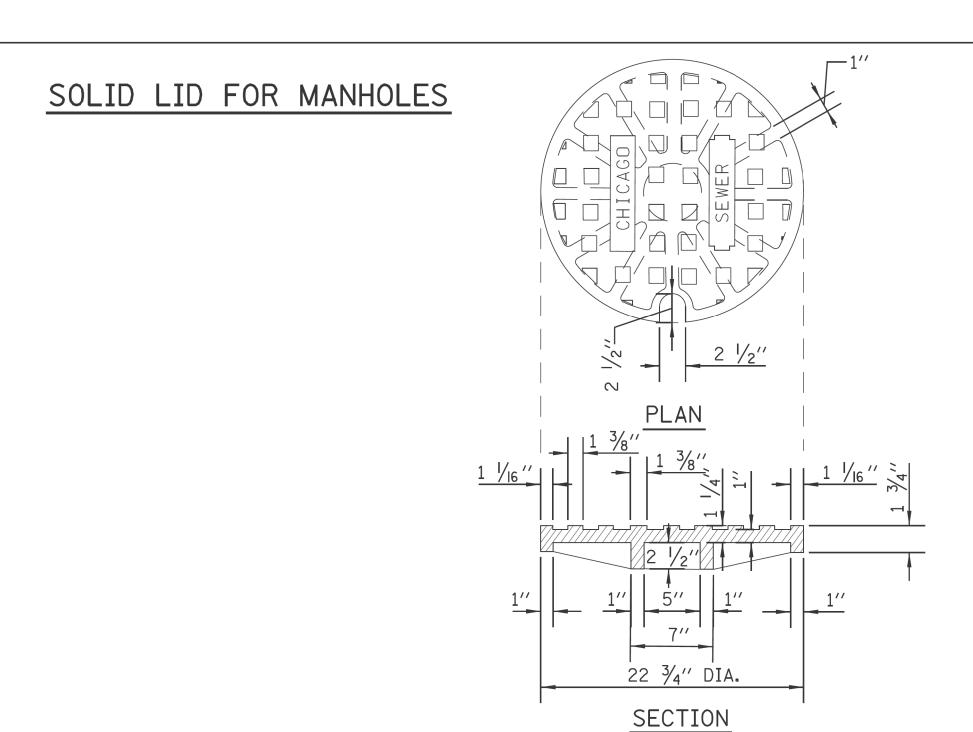

| STAND  | PERCENT     |   |
|--------|-------------|---|
| DATE   | DESCRIPTION |   |
| 2/5/21 | Approved    |   |
|        |             |   |
|        |             | 1 |

| PERCENT COMPLETE | DATE | CITY OF CHICAGO<br>Department of water management | DRAWN: SBW DESIGNED: CHECKED: | Δ 21                             |
|------------------|------|---|-------------------------------|----------------------------------|
| 30               |      | BUREAU OF ENGINEERING SERVICES                    | GD, GC, SO                    | $  \bigcirc \circ \bigcirc \top$ |
| 60               |      |   | REVIEWED:                     |                                  |
| 75               |      | MANHOLE   | _                             | \_                               |
| 90               |      | LIDS AND FRAMES                                   |                               | )F                               |
| 100              |      |   | DNI                           |                                  |
| BULLETIN         |      |   | FIN _                         |                                  |



| HICAGO | USER NAME = AB               | DESIGNED - |            | REVISED | -            |
|--------|------------------------------|------------|------------|---------|--------------|
|        |                              | DRAWN -    |            | REVISED | -            |
|        | PLOT SCALE = 10.0000 ' / in. | CHECKED -  |            | REVISED | -            |
|        | PLOT DATE = 7/1/2025         | DATE -     | 07/01/2025 | REVISED | - 07/10/2025 |
|        |                              |            |            |         |              |

CITY OF CHICAGO 49th WARD

CDWM STANDARD CONSTRUCTION DETAILS PBC PROJECT NO #22926 W. GREENLEAF AVENUE - W. LUNT AVENUE N. GLENWOOD AVENUE - N. SHERIDAN ROAD

TOTAL SHEET NO. OUC NUMBER 24 19 OUC IR #123805 COOK SCALE: NTS

#### STANDARD DRAINAGE STRUCTURES FOR PUBLIC STREETS #5 DOWEL BAR @ — — TYPE B CURB & GUTTER CONSTRUCTION JOINT TYPE B-V.12 Per CDOT Details CURB AND GUTTER\_ Note: Positive Summit - 1/2" ROUND TIE BARS Per CDOT Details for Drainage 30" LONG, 30" C/C CHICAGO 4" MAXIMUM (TYP) Note: Positive Summit -FRAME & LID CHICAGO for Drainage FRAME & LID 4" MAXIMUM(TYP)-PRECAST 8" MAX CONCRETE 2 RING PRECAST-8" VIT. CLAY, ADJUSTEMNT MAXIMUM CONCRETE 1' VERTICAL RING ADJUSTEMNT HALF TRAP 2" MIN RING 8" MAX 2'-0'' DIA. 2 RING 8" VIT. CLAY,-2'-0" DIA. MAXIMUM PRECAST 1' VERTICAL REINF. CONC. HALF TRAP PRECAST OFFSET CONE REINF. CONC. OFFSET CONE -SWIRL CHAMBER VORTEX or ORIFICE VORTEX or ORIFICE RESTRICTOR RESTRICTOR (SEE MISC DETAILS (SEE MISC DETAILS SHEET A.26) SHEET A.26) 4'-0'' DIA. 3'-0" DIA. PRECAST REINFORCED BASE AND PRECAST REINFORCED BASE AND-RISER WITH MINIMUMN 6" EMBEDMENT RISER WITH MINIMUMN 6" EMBEDMENT STANDARD CATCH BASIN-4' DIA. STANDARD CATCH BASIN-3' DIA. CHICAGO STANDARD MANHOLE FRAME AND

CURB & -

GUTTER

24" DIA-PRECAST

RING

6" MIN. GRANULAR-

EMBEDMENT UNDER

ALL INLETS

CONCRETE A

\_2′′ R

STANDARD INLET-2' DIA.

<u>PLAN</u>

(FRAME & LID NOT SHOWN)

DUCTILE

IRON PIPE

—PERFORATED LID

2'-0'' DIA.

#5 @-

12''

REINFORCED CONCRETE —

BASE CAST AS INTEGRAL

PRECAST CONCRETE RING

PART OF 24" DIA.

3" MAXIMUM\* (TYPICAL)

-8" DUCTILE IRON

PIPE MUST BE

CONNECTION TO


PIPE TO BE LAID

CATCH BASIN.

ON A MINIMUM GRADE OF 1%

USED FOR

# STANDARD DRAINAGE STRUCTURES FOR PUBLIC ALLEYS

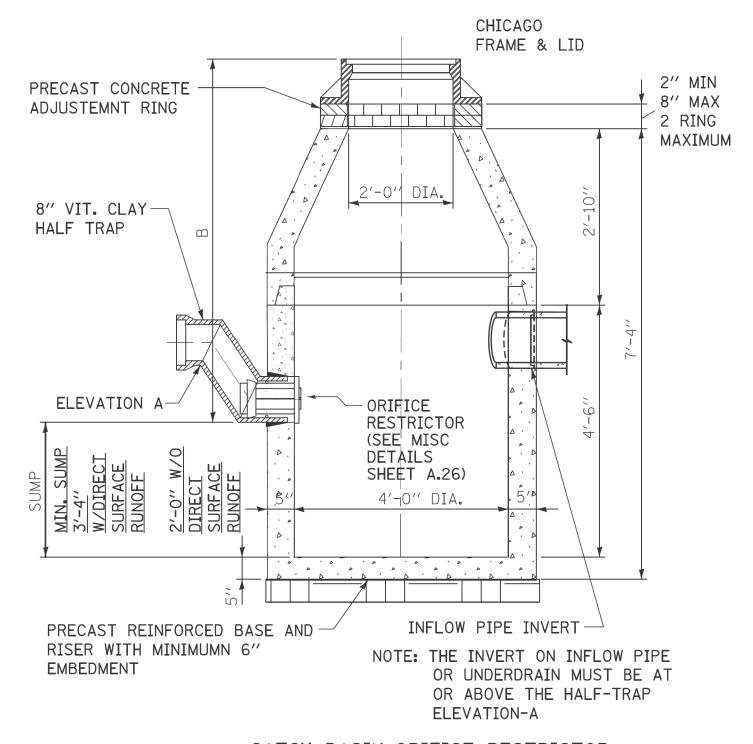

## CATCH BASIN-ORIFICE RESTRICTOR

N.T.S.

GENERAL NOTES: 1. CATCH BASIN TO CATCH BASIN CONNECTIONS ARE ALLOWED IN PRIVATE SITES & ALLEYS. ONLY THE DOWNSTREAM CATCH BASIN IS REQUIRED TO HAVE A HALF-TRAP.

2. IF B < 4 FEET, THEN USE A FLAT TOP SLAB CATCH BASIN AS NECESSARY.

3. FOR TRENCH BACKFILL, REFER TO IDOT SSRBC, ARTICLE 1003.04.

4. FOR GRANULAR EMBEDMENT, USE CA-11, CRUSHED GRAVEL, CRUSHED STONE, OR CRUSHED CONCRETE.

5. FOR STABILIZATION STONE, 12" OF CA-1 STONE IS ONLY REQUIRED WHEN UNSTABLE MATERIAL IS ENCOUNTERED AT TRENCH BOTTOM.

6. INLETS AND 3' DIAMETER CATCH BASINS ARE TO BE USED ONLY WITH PRIOR APPROVAL OF THE DEPT OF WATER MANAGEMENT- ENGINEERING SERVICES, SEWER SECTION, AND THE DEPT. OF BUILDINGS STORMWATER REVIEWER.

7. IF COVER OVER VCP IS LESS THAN 3', USE 45 DEGREE DIP BENDS WITH 1 FOOT DROP AS HALF TRAPS AS NEEDED FOR IEPA CLEARANCE REQUIREMENTS

|   | ARD REVISIONS | STAND  |
|---|---------------|--------|
| ] | DESCRIPTION   | DATE   |
| 1 | APPROVED      | 2/5/21 |
| 4 |               |        |
| ┨ |               |        |
| + |               |        |

| PERCENT COMPLETE | DATE | CITY OF CHICAGO<br>Department of water management | DRAWN: <u>SBW</u> DESIGNED: CHECKED: | Λ 21                      |
|------------------|------|---|--------------------------------------|---------------------------|
| 30               |      | BUREAU OF ENGINEERING SERVICES                    |                                      | $\neg \circ \angle \circ$ |
| 60               |      |   | REVIEWED:                            |                           |
| 75               |      | DRAINAGE STRUCTURE DETAILS                        |                                      | _                         |
| 90               |      |   |                                      | <u> </u>                  |
| 100              |      |   | DNI                                  |                           |
| BULLETIN         |      |   | FIN                                  |                           |

**CDOT** 

| CHICAGO | USER NAME = AB               | DESIGNED -        | REVISED -            |  |  |  |
|---------|------------------------------|-------------------|----------------------|--|--|--|
|         |                              | DRAWN -           | REVISED -            |  |  |  |
|         | PLOT SCALE = 10.0000 ' / in. | CHECKED -         | REVISED -            |  |  |  |
|         | PLOT DATE = 7/1/2025         | DATE - 07/01/2025 | REVISED - 07/10/2025 |  |  |  |

CITY OF CHICAGO 49th WARD


CDWM STANDARD CONSTRUCTION DETAILS PBC PROJECT NO #22926 W. GREENLEAF AVENUE - W. LUNT AVENUE

N. GLENWOOD AVENUE - N. SHERIDAN ROAD

TOTAL SHEET NO. OUC NUMBER COUNTY 24 20 OUC IR #123805 COOK SCALE: NTS


CDWM Details.cel 2/5/2021 2:00:11 PM

# DRAINAGE STRUCTURES RESTRICTORS

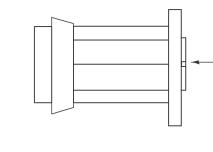

—ORIFICE RESTRICTOR

INSERT THE RESTRICTOR INTO THE HALF-TRAP. UPON TIGHTENING OF THE CENTER NUT ON THE FACE OF THE RESTRICTOR, THE RUBBER O-RINGS WILL EXPAND INSIDE THE HALF TRAP, PROVIDING A WATER- TIGHT SEAL. PULL ON RESTRICTOR TO VERIFY THAT A TIGHT FIT IS MADE.

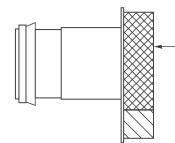

-VORTEX RESTRICTOR

PULL ON RESTRICTOR TO VERIFY THAT A TIGHT FIT IS MADE.

INSERT THE RESTRICTOR WITH THE OPENING DOWN. UPON TIGHTENING OF THE 2 BOLTS ON THE FACE OF THE RESTRICTOR, THE RUBBER O-RINGS WILL PROVIDE A WATER- TIGHT SEAL.

#### GENERAL NOTES:

1. CATCH BASIN TO CATCH BASIN CONNECTIONS ARE ALLOWED IN PRIVATE SITES & ALLEYS. ONLY THE DOWNSTREAM CATCH BASIN IS REQUIRED TO HAVE A HALF-TRAP.

2. IF B < 4 FEET, THEN USE A DUCTILE IRON PIPE HALF TRAP AND FLAT TOP SLAB CATCH BASIN AS NECESSARY.

3. INLETS AND 3' DIAMETER CATCH BASINS ARE TO BE WITH PRIOR APPROVAL OF DWM FIELD INSPECTOR.

#### RESTRICTOR NOTES:


THE DWM'S RAIN BLOCKER RESTRICTOR PROGRAM MUST BE MAINTAINED WITH ANY ROADWAY IMPROVEMENT.

THE DESIGN OF ANY ROADWAY IMPROVEMENT MUST CONSIDER LIMITING THE NUMBER OF CATCH BASINS TO THE EXTENT PRACTICAL. THE NUMBER OF EXISTING STRUCTURES SHOULD NOT BE INCREASED.

THE RESTRICTORS CAN BE OBTAINED FROM DWM CENTRAL DISTRICT AT 3901 S. ASHLAND AVE. THE CONTRACTOR SHOULD ARRANGE FOR PICK UP BY CONTACTING 312-747-8736 (7AM TO 3PM, M-F). CONTRACTOR MUST CALL 48 HOURS IN ADVANCE OF PICK UP DATE AND TIME.

FLOW RESTRICTORS MUST BE INSTALLED IN ALL CATCH BASINS OUTSIDE OF THE CENTRAL BUSINESS DISTRICT(LIMITS: NORTH AVE, CERMAK AVE, HALSTED AVE, LAKE MICHIGAN). RESTRICTORS MUST NOT BE INSTALLED IN CATCH BASINS IN CLOSE PROXIMITY TO VIADUCT AREAS, BUS STOPS, OR EMERGENCY ENTRANCES. THE DWM MUST APPROVE THE NON-INSTALLATION OR REMOVAL OF ANY RESTRICTOR. REQUIREMENTS FOR RESTRICTOR INSTALLATION ARE AS FOLLOWS:

\*ARTERIAL STREETS: 3-INCH ORIFICE RESTRICTOR \*BUS ROUTES: 3-INCH ORIFICE RESTRICTOR \*RESIDENTIAL STREETS: 3-INCH VORTEX RESTRICTOR \*ALLEYS: 3-INCH ORIFICE RESTRICTOR IN THE LAST CB. \*CLOSED LIDS ARE REQUIRED ON ALL MANHOLES EXCEPT AT INTERSECTIONS WHERE A PERFORATED LID SHALL BE

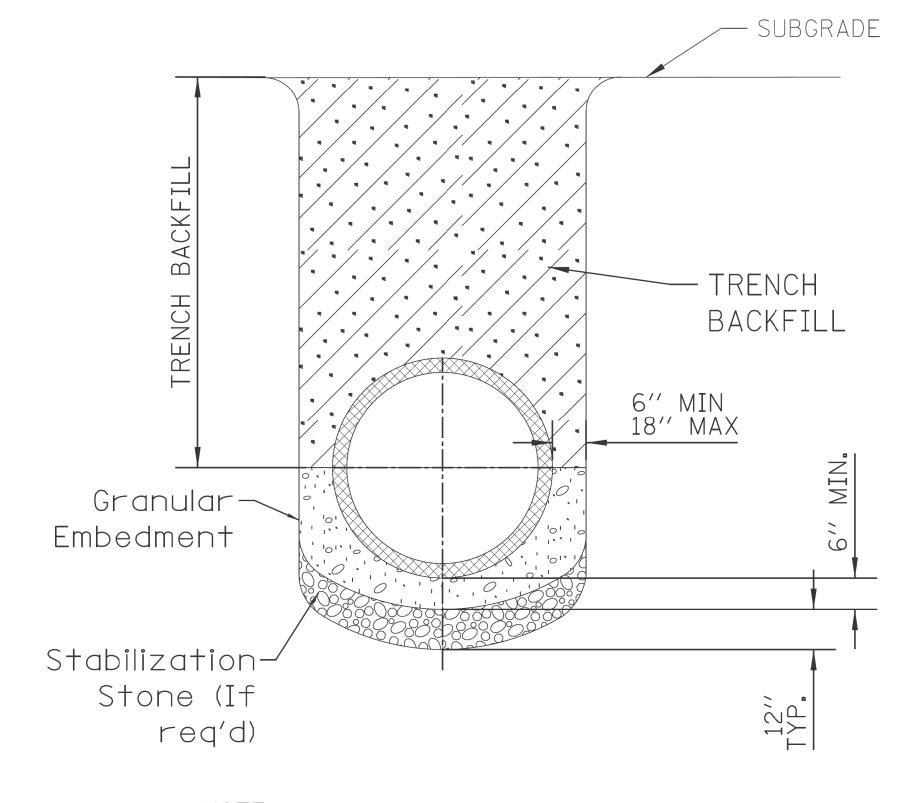


NOTE: 1. FOR TRENCH BACKFILL, REFER TO IDOT SSRBC, ARTICLE 1003.04.


2. FOR GRANULAR EMBEDMENT, USE CA-11, CRUSHED GRAVEL, CRUSHED STONE, OR CRUSHED CONCRETE.

3. FOR STABILIZATION STONE, 12" OF CA-1 STONE IS ONLY REQUIRED WHEN UNSTABLE MATERIAL IS ENCOUNTERED AT TRENCH BOTTOM.

4. AGGREGATE PLACED FOR TEMPORARY SURFACE RESTORATION WILL NOT BE PAID SEPARATELY AND SHALL BE INCIDENTAL TO THE CONTRACT.

SEWER TRENCH DETAIL

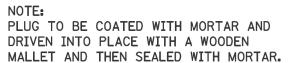

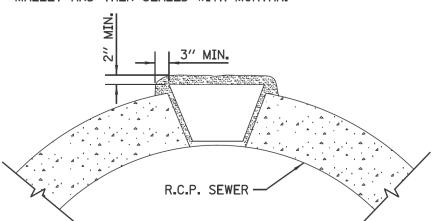

# LIFTING HOLE PLUG DETAIL FOR CONCRETE PIPE

1. ALL PLUG MATERIALS MUST COMPLY WITH 1042.16 OF THE IDOT SSRBC.

2. LIFT HOLES ON COMBINED SEWERS ARE PROHIBITED WHEN THE WATER TABLE IS WITHIN 2 FEET OF THE PIPE INVERT, OR IF THE PIPE IS FULLY SUBMERGED UNDER NORMAL CONDITIONS.


| STAND  | ARD REVISIONS |
|--------|---------------|
| DATE   | DESCRIPTION   |
| 2/5/21 | APPROVED PLAN |
|        |               |
|        |               |

|   | PERCENT COMPLETE | DATE | CITY OF CHICAGO<br>Department of water management | DRAWN: SBW DESIGNED: CHECKED: | ۸ 26 |
|---|------------------|------|---|-------------------------------|------|
|   | 30               |      | BUREAU OF ENGINEERING SERVICES                    | GD. GC. SO                    | 7.29 |
| ] | 60               |      |   | REVIEWED:                     |      |
|   | 75               |      | MISCELLANEOUS                                     |                               | \_   |
|   | 90               |      | DETAILS ———                                       | ,05 <u> </u>                  |      |
|   | 100              |      |   | PN                            |      |
| Т | DULLETIN         |      |   | N                             |      |


CDWM Details.cel 2/5/2021 2:07:40 PM

| 60 | USER NAME = AB               | DESIGNED -        | REVISED -            |
|----|------------------------------|-------------------|----------------------|
|    |                              | DRAWN -           | REVISED -            |
|    | PLOT SCALE = 10.0000 ' / in. | CHECKED -         | REVISED -            |
| /  | PLOT DATE = 7/1/2025         | DATE - 07/01/2025 | REVISED - 07/10/2025 |
|    |                              |                   |                      |

PN \_\_\_\_\_

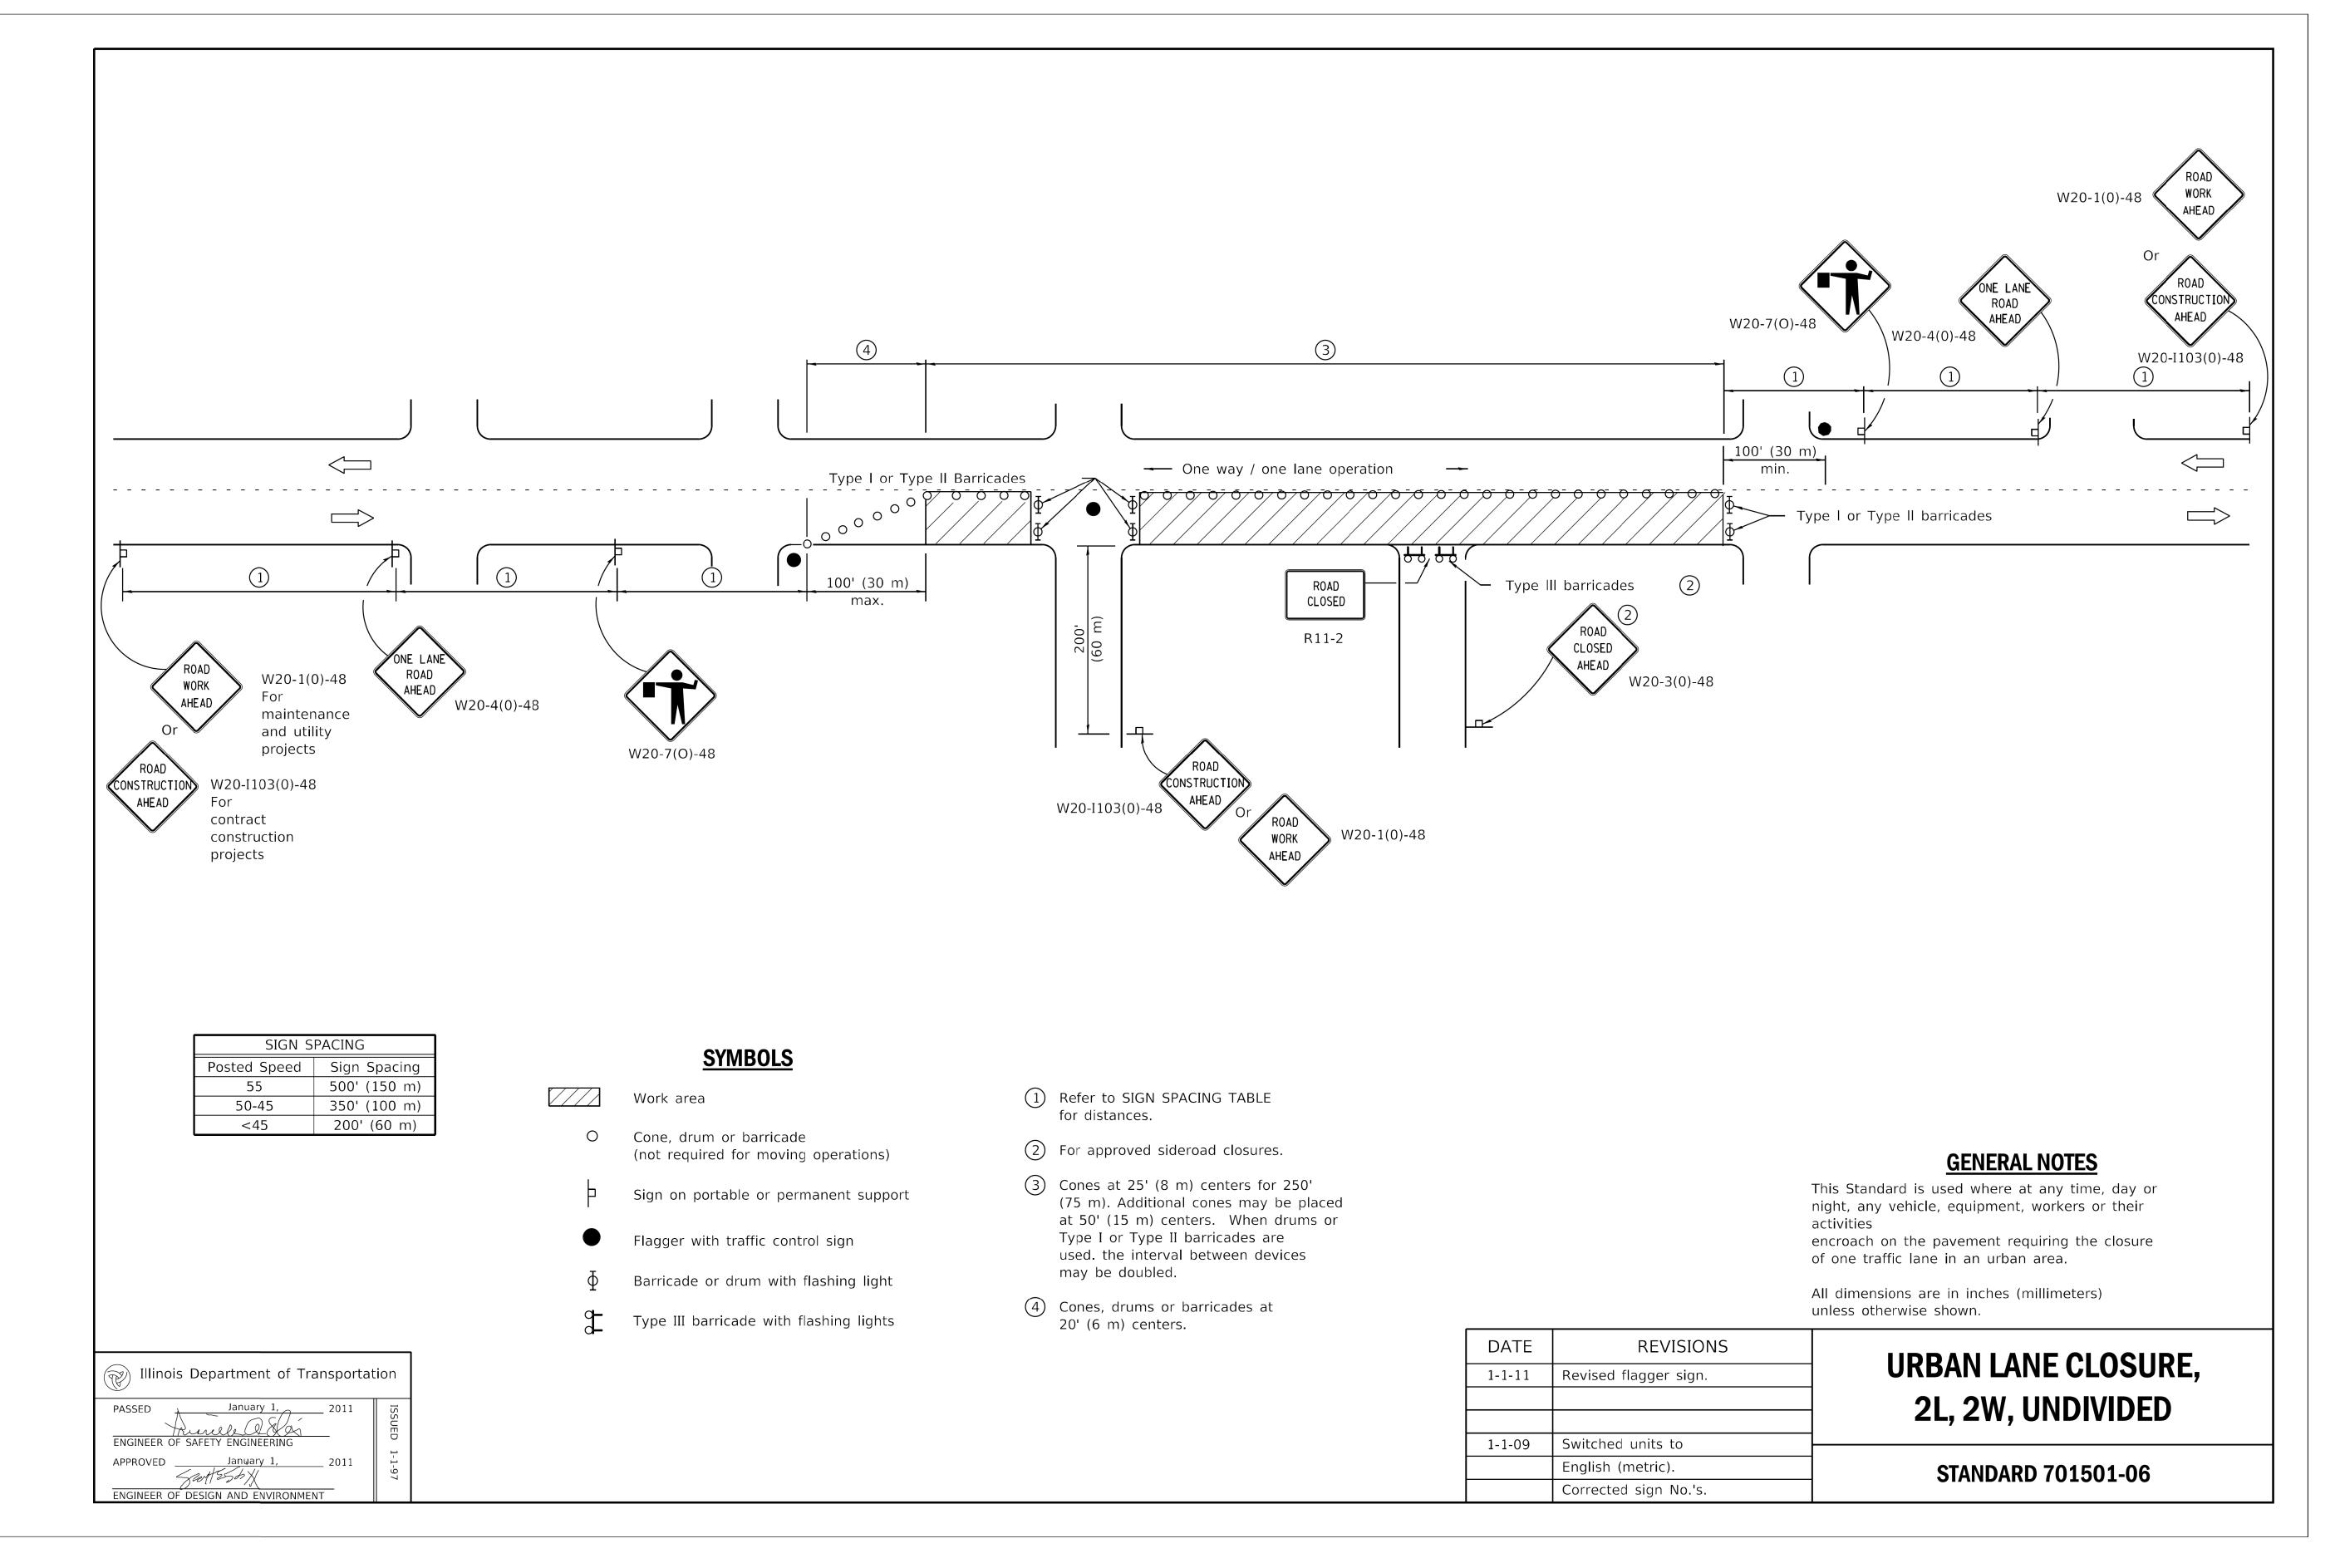




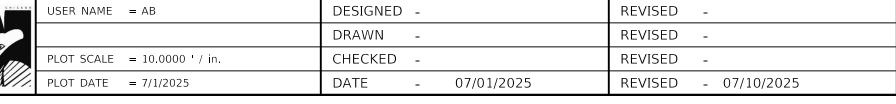

CITY OF CHICAGO **DEPARTMENT OF TRANSPORTATION** 49th WARD

**IDOT STANDARD DETAILS** PBC PROJECT NO #22926 W. GREENLEAF AVENUE - W. LUNT AVENUE N. GLENWOOD AVENUE - N. SHERIDAN ROAD

TOTAL SHEET NO. OUC NUMBER 24 22 OUC IR #123805 COOK SCALE: NTS

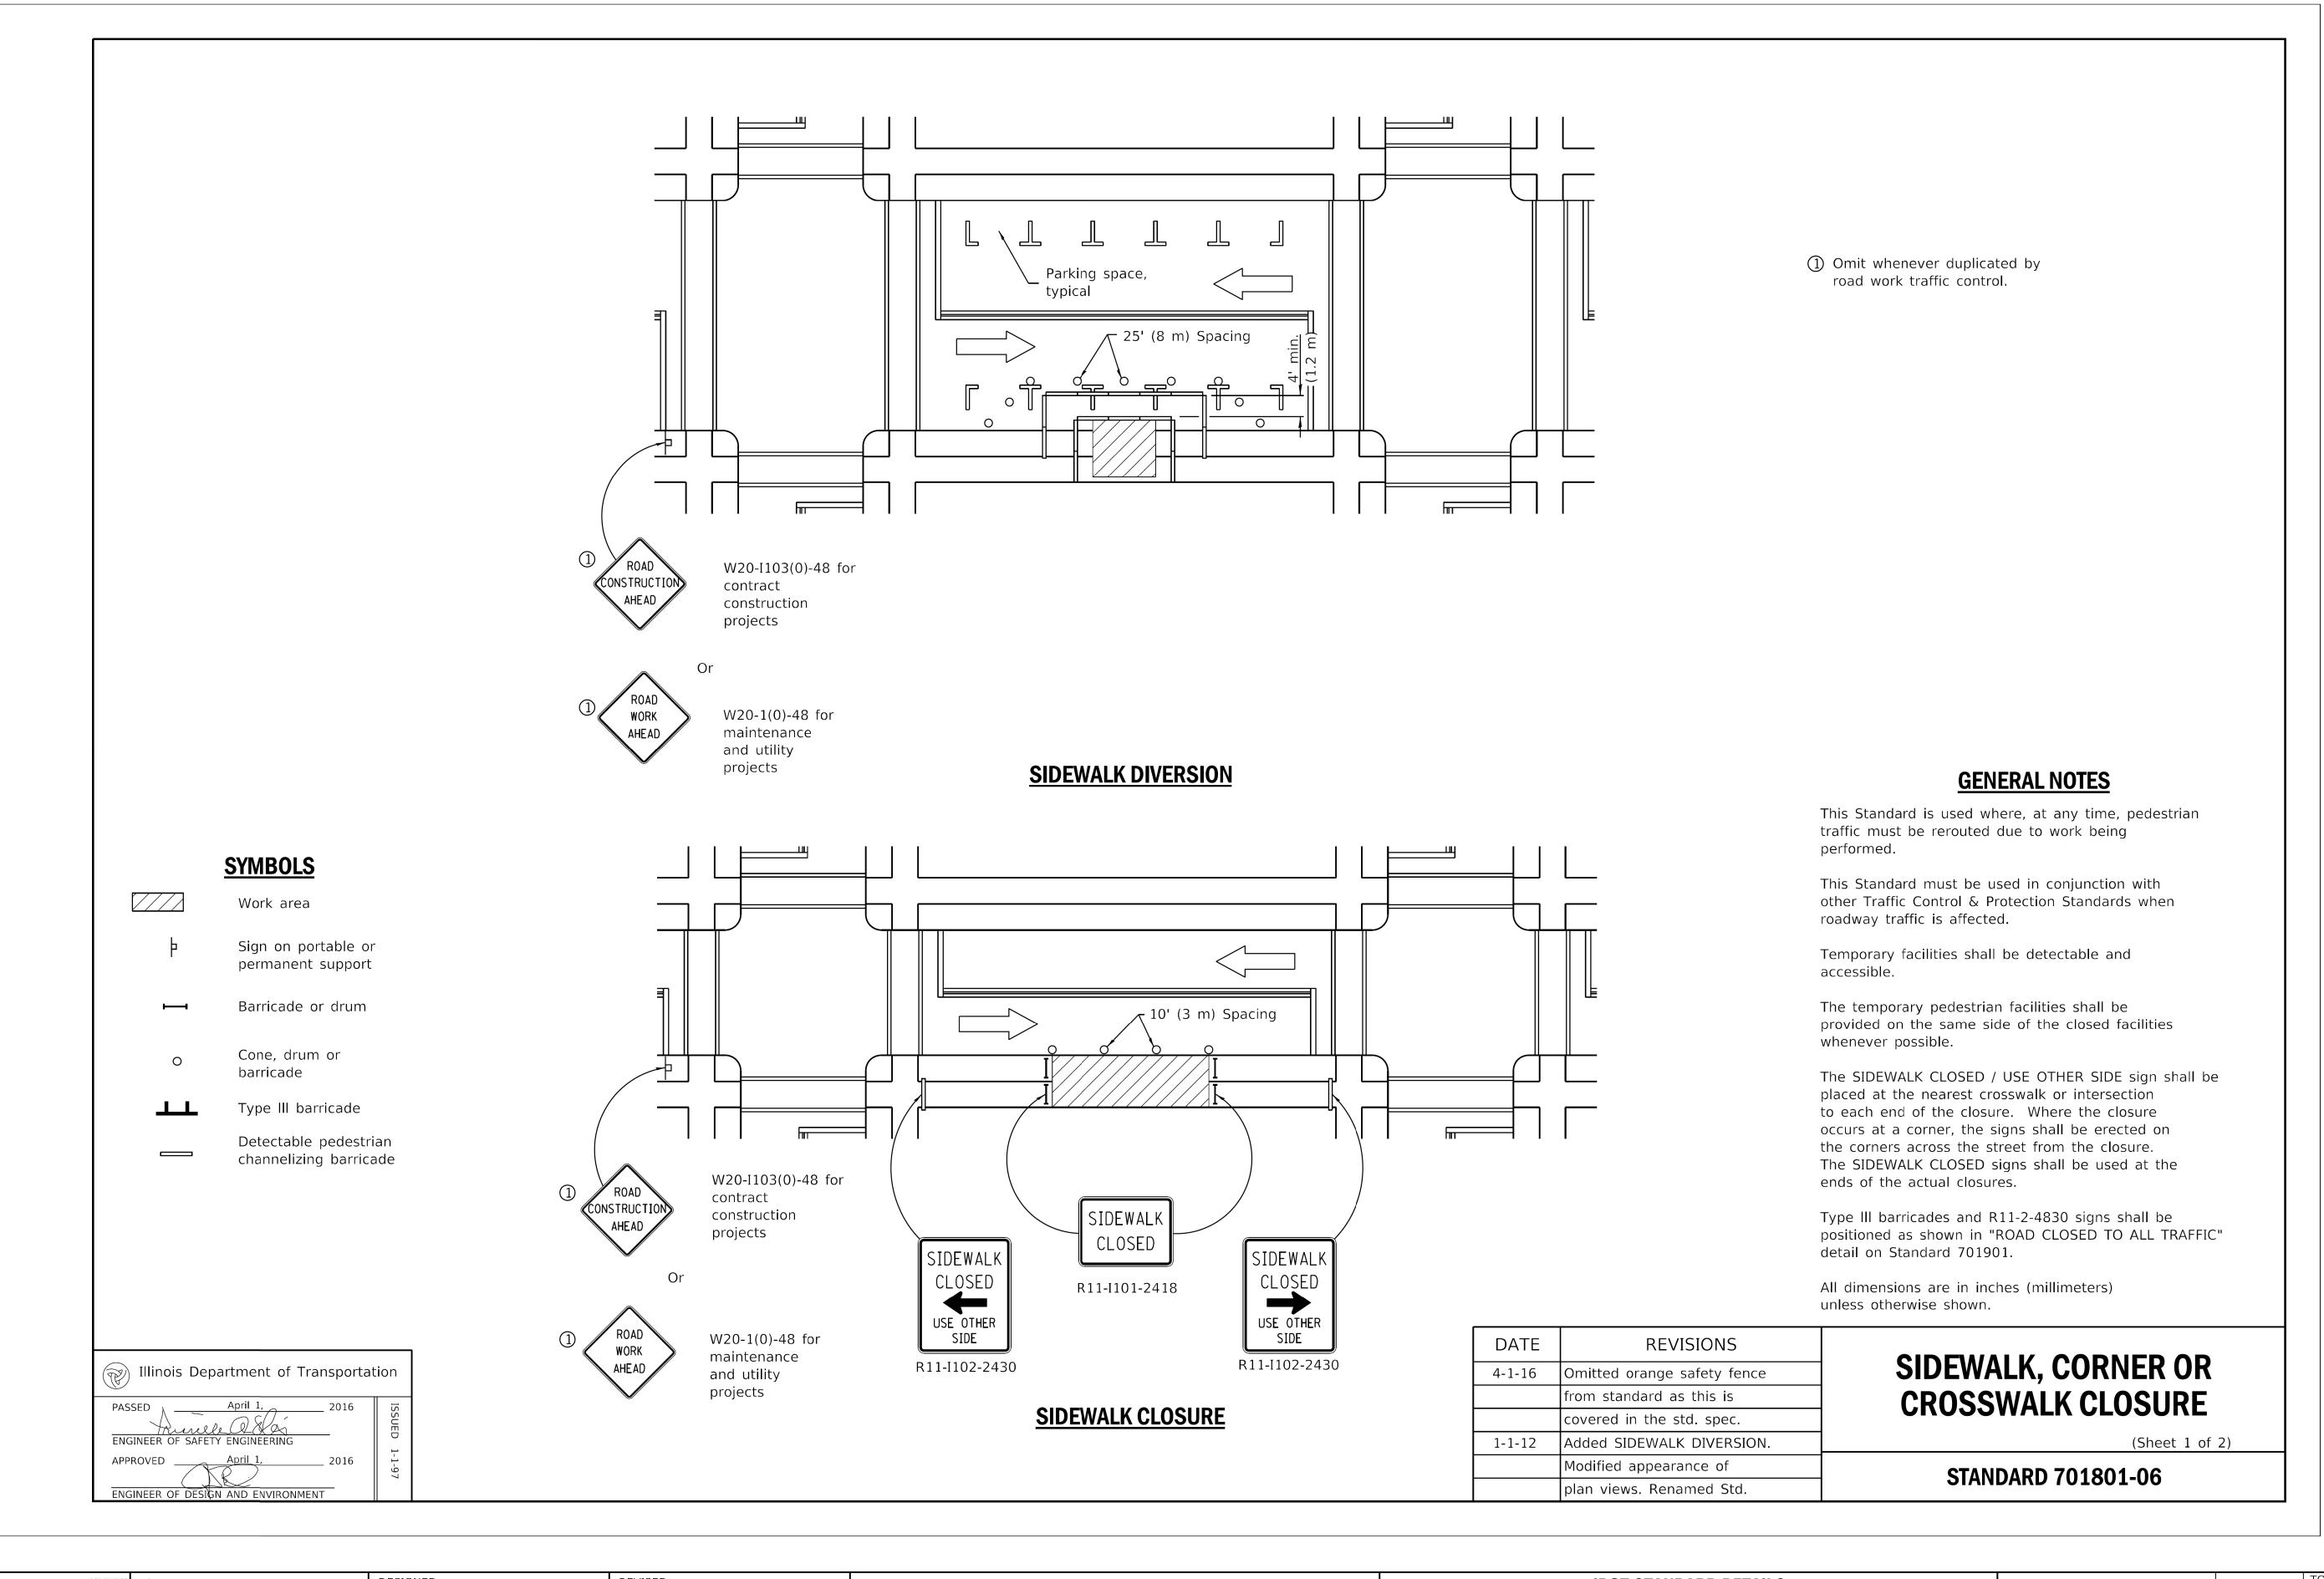

\*CDOT

 USER NAME
 = AB
 DESIGNED
 REVISED

 PLOT SCALE
 = 10.0000 ' / in.
 CHECKED
 REVISED

 PLOT DATE
 = 7/14/2025
 DATE
 07/01/2025
 REVISED
 07/10/2025

CITY OF CHICAGO
DEPARTMENT OF TRANSPORTATION
49th WARD

IDOT STANDARD DETAILS
PBC PROJECT NO #22926
W. GREENLEAF AVENUE - W. LUNT AVENUE
N. GLENWOOD AVENUE - N. SHERIDAN ROAD

OUC NUMBER

COUNTY

TOTAL SHEET NO.


OUC IR #123805

COOK

24

23

SCALE: NTS

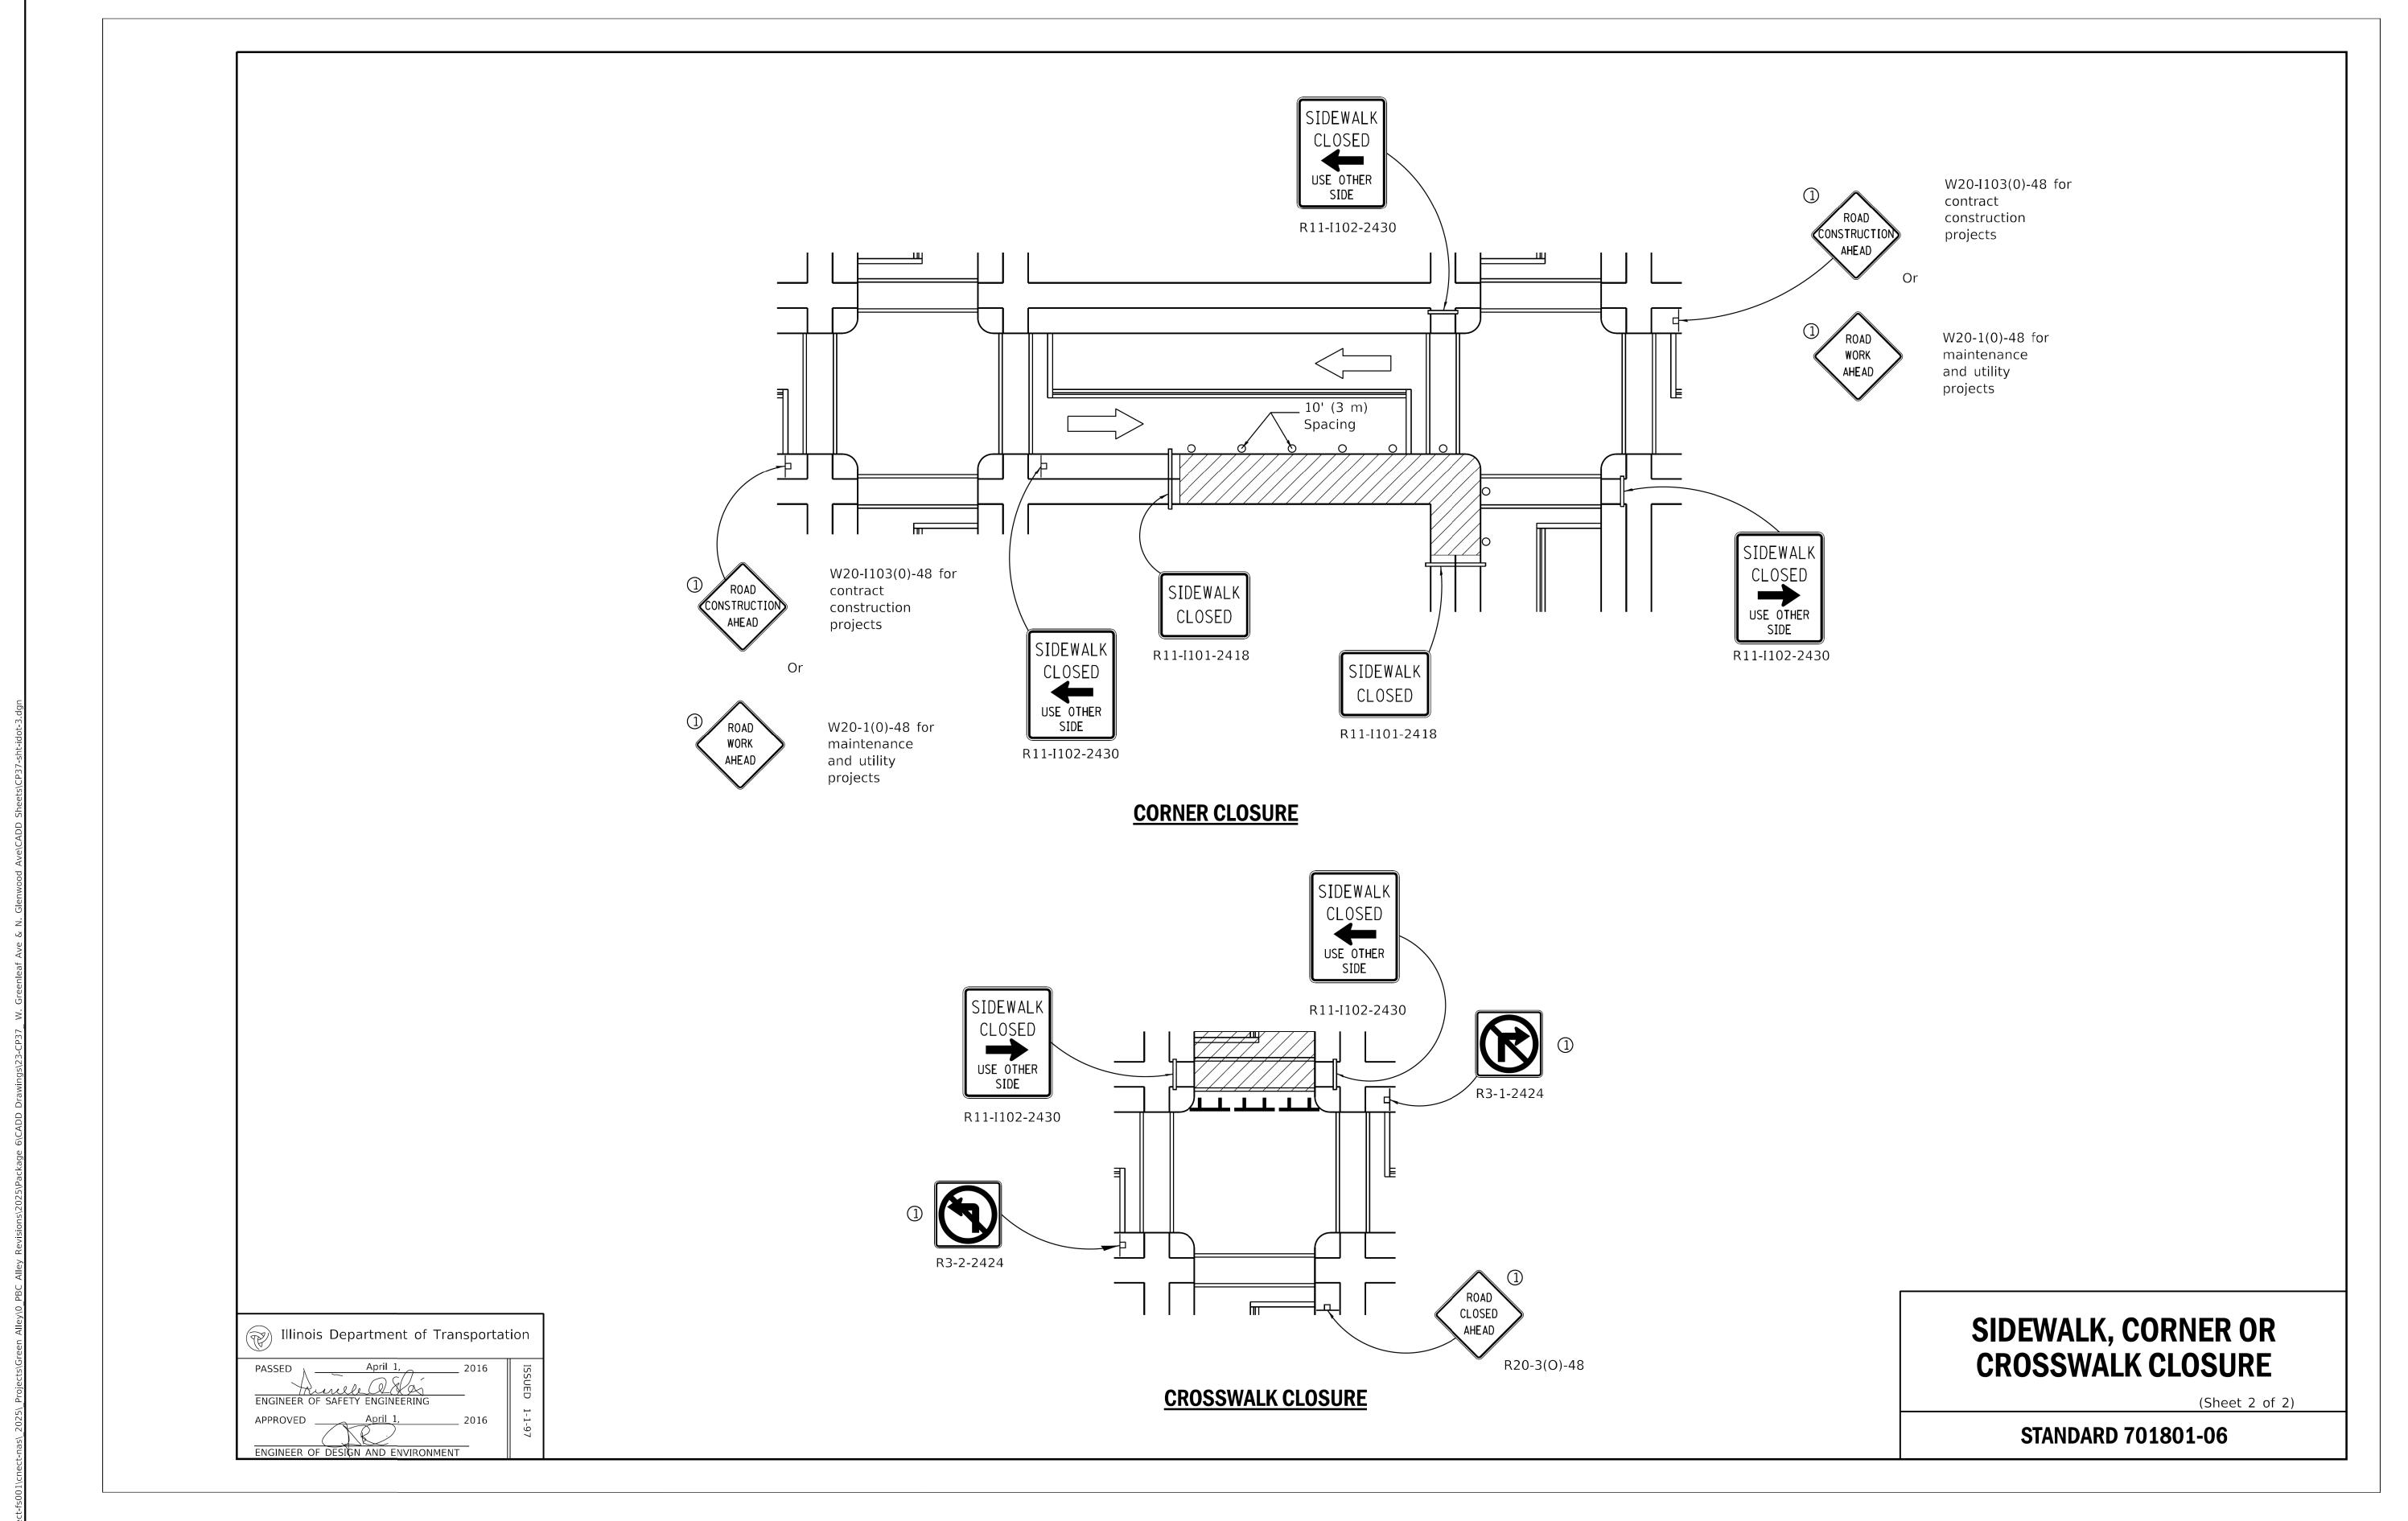

\*CDOT

 USER NAME
 = AB
 DESIGNED
 REVISED

 PLOT SCALE
 = 10.0000 ' / in.
 CHECKED
 REVISED

 PLOT DATE
 = 7/1/2025
 DATE
 07/01/2025
 REVISED
 07/10/2025

CITY OF CHICAGO DEPARTMENT OF TRANSPORTATION 49th WARD IDOT STANDARD DETAILS
PBC PROJECT NO #22926
W. GREENLEAF AVENUE - W. LUNT AVENUE
N. GLENWOOD AVENUE - N. SHERIDAN ROAD

OUC NUMBER

COUNTY

TOTAL SHEETS
NO.

OUC IR #123805

COOK

24

24

SCALE: NTS