
#### **STANDARD SYMBOLS**

<u>EXISTING</u>	<u>PROPOSED</u>	NAME
$\bigcirc$		CATCH BASIN
	$\odot$	MANHOLE
	_	INLET
-0-	-	UTILITY POLE
¤	-	LIGHT POLE
6" 🕥		EXISTING TREES WITH DIAMETER
	6" 💢	EXISTING TREES TO BE REMOVED
(X <sub>*</sub> XX)	x.xx	ELEVATION
	*	MATCH EXISTING ELEVATIONS
		PROPERTY LINE
		RIGHT OF WAY LINE
		CENTER LINE
=====		CURB OR CURB AND GUTTER
	·	WATER LINE
⊢——— G ⊢———	G	GAS LINE
⊢		ABANDONED GAS
F0	——— F0 ———	FIBER OPTIC CABLE
E	——Е—	COMMONWEALTH EDISON
		CITY ELECTRIC
т	т	TELEPHONE
→>>>>>>>		COMBINED STORM SEWER
<del></del>		REMOVAL LINEAR ITEMS
	<del></del>	STORM SEWER
стv	СТУ	CABLE TV
A	A	AERIAL WIRE
	Δ΄ Δ΄	PORTLAND CEMENT CONCRETE SIDEWALK
/ <u> </u>		PORTLAND CEMENT CONCRETE DRIVEWAY
		PORTLAND CEMENT CONCRETE GARAGE APRON
		PORTLAND CEMENT CONCRETE ENTRANCE
		HOT MIX ASPHALT RESTORATION
		FULL DEPTH PAVEMENT RESTORATION
		RUBBERIZED SPEED HUMP
	WIIIII	DEDDECCED CUDD AND CUTTED

DEPRESSED CURB AND GUTTER

#### **STANDARD ABBREVIATIONS**

<u>ABBREVIATION</u>	<u>DEFINITION</u>
ASH	ASPHALT SPEED HUMP
СВ	CATCH BASIN
DIP	DUCTILE IRON PIPE
HP	HIGH POINT
MH	MANHOLE
RCP	REINFORCED CONCRETE PIPE
ROW	RIGHT OF WAY
RSH	RUBBERIZED SPEED HUMP
TBM	TEMPORARY BENCHMARK
VCP	VITRIFIED CLAY PIPE

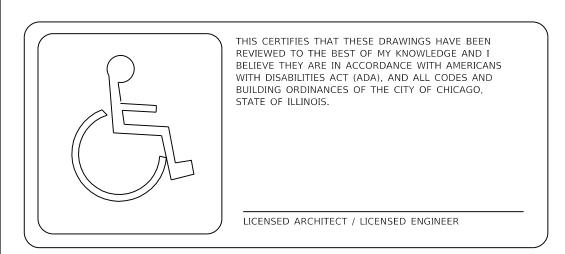

PRIOR TO CONSTRUCTION, THE CONTRACTOR IS REQUIRED TO CALL THE CHICAGO UTILITY ALERT NETWORK (DIGGER/CHICAGO811) AT 312-744-7000 FOR UNDERGROUND UTILITY LOCATIONS.

# STATE OF ILLINOIS CITY OF CHICAGO

**BRANDON JOHNSON, MAYOR** 

## PUBLIC BUILDING COMMISSION

RAY GIDEROF, EXECUTIVE DIRECTOR

# DEPARTMENT OF TRANSPORTATION

CRAIG TURNER, ACTING COMMISSIONER

# **CONTRACT PLANS**

**FOR** 


### PROPOSED IMPROVEMENTS

W. ARGYLE STREET/W. AINSLIE STREET N. HOYNE AVENUE/N. SEELEY AVENUE

PBC CONTRACT NO.: C1627 CDOT PROJECT NO.: U-5-241 PBC PROJECT NO.: 22925

ISSUED FOR BID: 07/10/2025 CSR NO.: 2306332037

**WARD 40** 

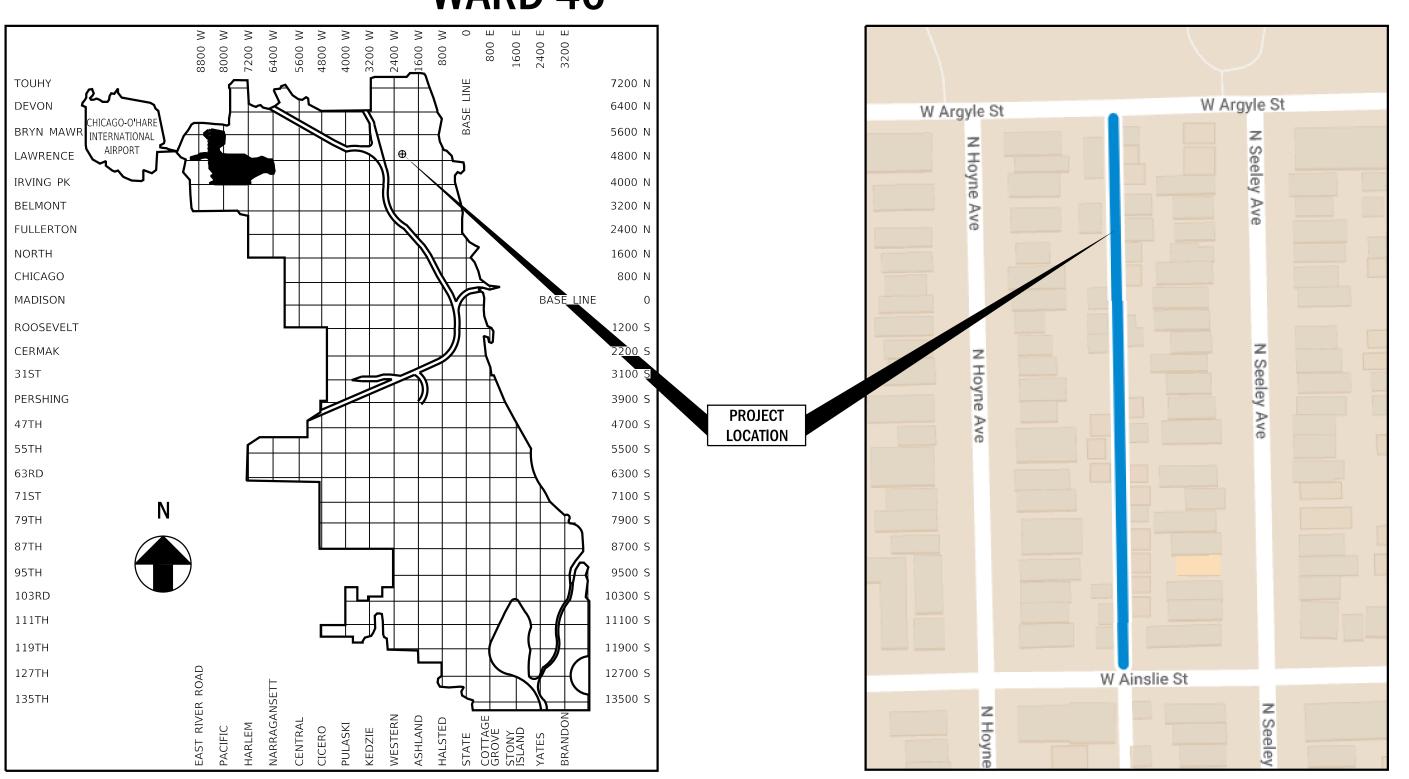



<u>SHEET</u>	DESCRIPTION
1	COVER SHEET
2	ALIGNMENT TIES AND BENCHMARKS
3	GENERAL NOTES
4	SUMMARY OF QUANTITIES
5	PROPOSED CONDITIONS PLAN VIEW
6-7	PLAN AND PROFILE
8	ALLEY APRON DETAILS
9	TYPICAL SECTIONS
10-17	CDOT STANDARD CONSTRUCTION DETAILS
18-22	CDWM STANDARD CONSTRUCTION DETAILS
23-25	IDOT STANDARD DETAILS






**LOCATION MAP** 

**INDEX MAP** 

LENGTH OF IMPROVEMENT = 599.2 L.F. (0.11 MILES)

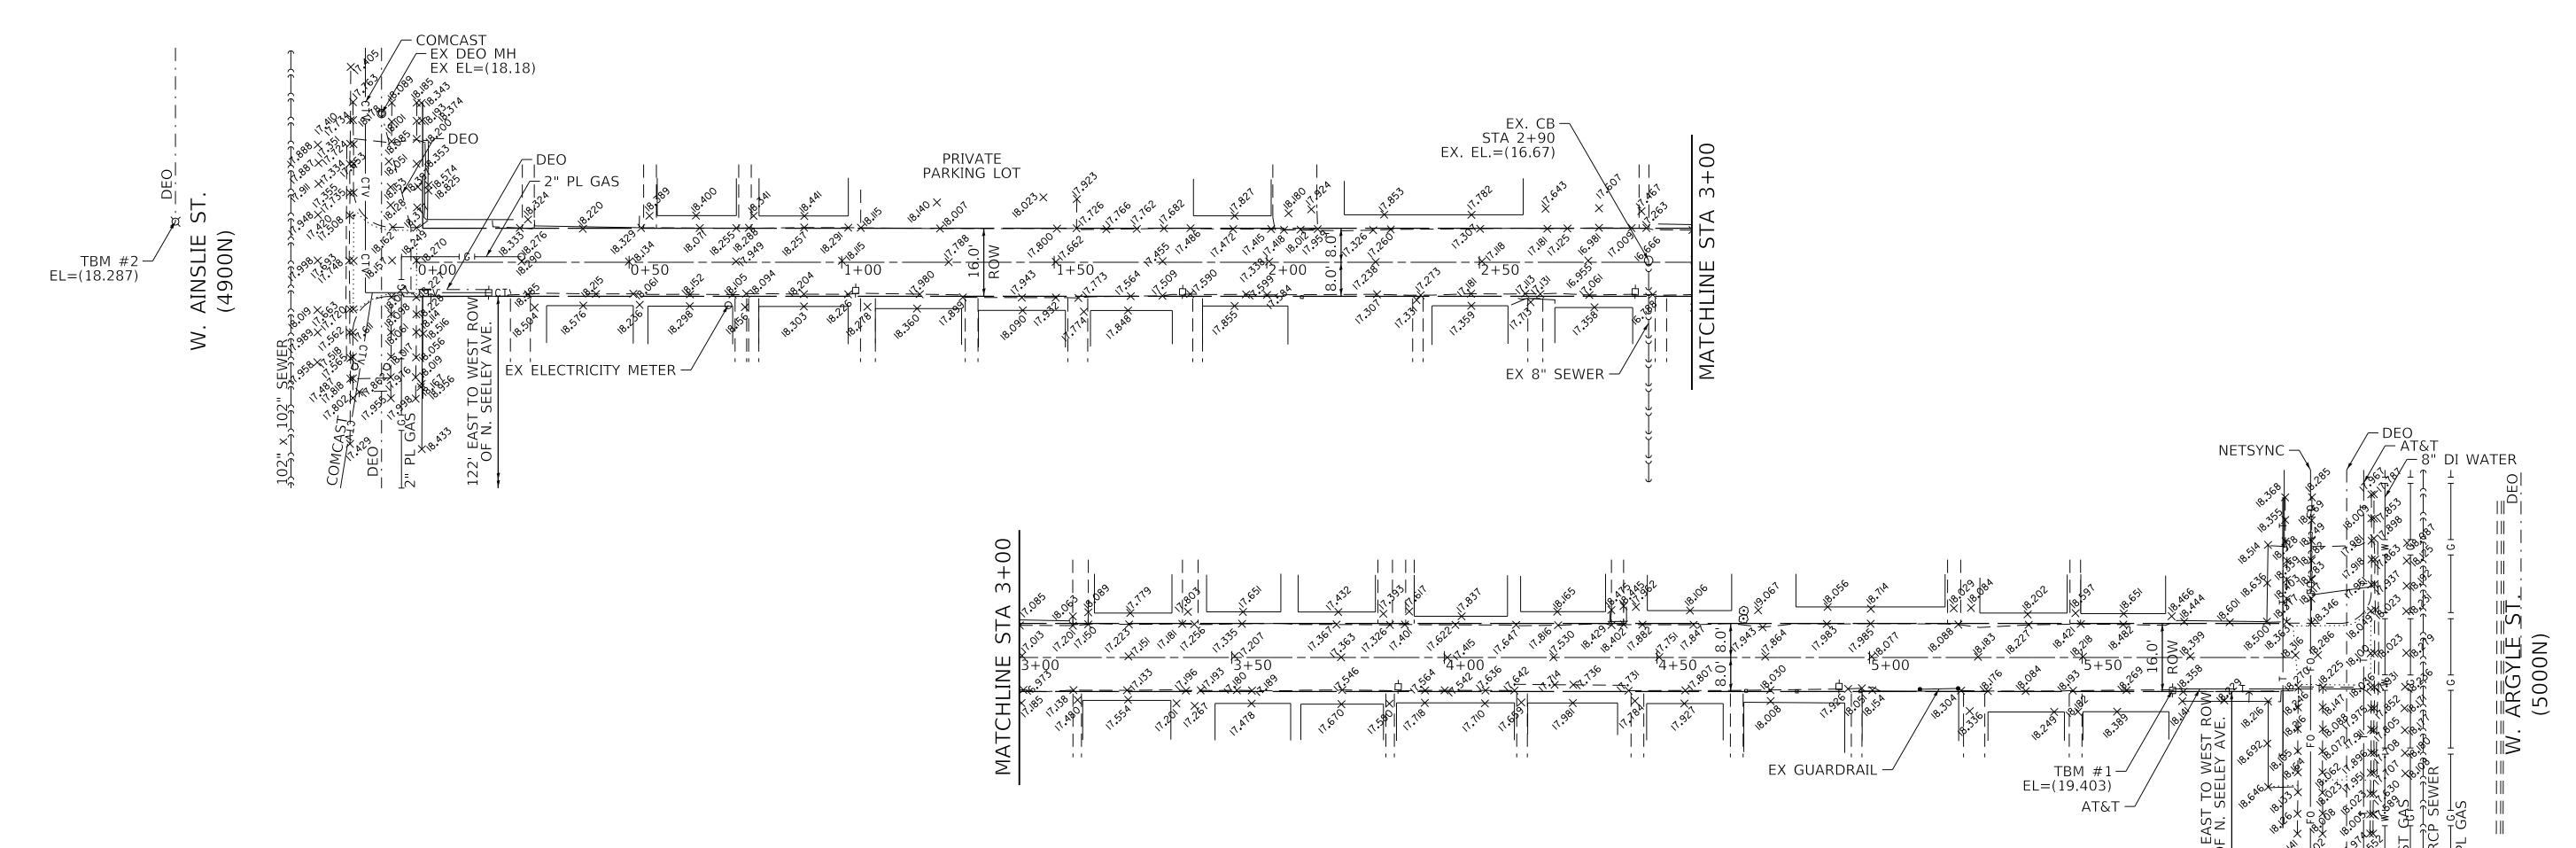

#### <u>NOTES</u>

- 1. ROW LINES SHOWN ARE APPROXIMATE AND FOR REFERENCE ONLY. CONTRACTOR IS TO VERIFY/CONFIRM ROW PRIOR TO CONSTRUCTION.
- 2. AS-BUILT DRAWING TO BE SUBMITTED TO DWM.
- 3. ALL EXCAVATIONS MORE THAN 5' (FEET) DEEP MUST COMPLY WITH OSHA REQUIREMENTS.
- 4. IT IS THE CONTRACTOR'S SOLE RESPONSIBILITY TO COMPLY WITH ALL OSHA REQUIREMENTS.
- 5. CONTRACTOR IS RESPONSIBLE FOR ALLEY CLOSURE PROCEDURES FOLLOWING GUIDELINES OF IDOT STANDARD DETAIL 701501-06. PROCEDURE TO INCLUDE: NOTIFYING BUILDINGS WITHIN PROJECT LIMITS OF EXACT START DATE IN WHICH ALLEY WILL BE CLOSED AND PLACING APPROPRIATE SIGNING AND BARRICADES IN ADVANCE OF ALLEY CLOSURE.
- 6. TELEVISE SEWER AND DRAINAGE STRUCTURES BEFORE CONSTRUCTION AND REPAIR/REPLACE/LINE AS NEEDED.

#### **BENCHMARK**

CITY OF CHICAGO BENCHMARK #319, ELEV. = 15.629' 11.1' N. OF S. LINE OF W. LELAND AVE AND 64.6' E. OF E. LINE OF THE FIRST ALLEY W. OF N. WESTERN AVE.

TBM #1 ELEV.=19.403' SET LARGE NAIL IN WEST FACE OF FIRST POWER POLE FROM NORTH,  $\pm$  30' SOUTH OF S. LINE OF W. ARGYLE ST.

TBM #2 ELEV.=18.287' TOP OF EAST BOLT OF LIGHT POLE AT SOUTHWEST CORNER OF W. AINSLIE ST AND SOUTH END OF NORTH-SOUTH ALLEY.

#### <u>LEGEND</u>

----- EXISTING ROW LINE — — - EXISTING LOT LINE

0 0	USER NAME = AB	DESIGNED -	JS	REVISED -
		DRAWN -	JS	REVISED -
	PLOT SCALE = 20.0000 ' / in.	CHECKED -	SJ/LM	REVISED -
11.	PLOT DATE = 7/1/2025	DATE -	07/01/2025	ISSUED FOR BID - 07/10/2025
	-	·	·	

CITY OF CHICAGO
DEPARTMENT OF TRANSPORTATION
40th WARD

ALIGNMENT TIES AND BENCHMARKS	OUC NUMBER		COUNTY	TOTAL SHEETS
PBC PROJECT NO # 22925	OUC IR #122194		СООК	25
W. ARGYLE STREET - W. AINSLIE STREET	STA. 0+00	TO STA. 5+99	SCALE: AS	SHOWN
N. HOYNE AVENUE - N. SEELEY AVENUE				

# SUMMARY OF QUANTITIES

Line	Code Number	Description	Unit	Estimated Quantity	Unit Price	Cost
1	*****	EARTH EXCAVATION (SOIL TO CCDD FACILITY)	CU YD	313.0	\$0.00	
2	*****	EARTH EXCAVATION (SOIL TO LANDFILL)	CU YD	255.0	\$0.00	·
3	*****	PAVEMENT REMOVAL	SQ YD	29.0	\$0.00	
4	*****	DRIVEWAY AND ALLEY RETURN PAVEMENT REMOVAL	SQ YD	194.0	\$0.00	
5	44000300	CURB REMOVAL	LIN FT	92.0	\$0.00	
6	44000500	COMBINATION CURB AND GUTTER REMOVAL	LIN FT	131.0	\$0.00	·
7	44000600	SIDEWALK REMOVAL	SQ FT	107.0	\$0.00	·
8	*****	ALLEY PAVEMENT REMOVAL	SQ YD	1066.0	\$0.00	·
9	*****	GARAGE APRON REMOVAL	SQ FT	2134.0	\$0.00	
10	*****	HOT-MIX ASPHALT SURFACE REMOVAL, VARIABLE DEPTH	SQ YD	84.0	\$0.00	·
11	31101100	SUB-BASE GRANULAR MATERIAL, TYPE B	CU YD	205.0	\$0.00	
12	*****	CONCRETE ALLEY FILL, CA-1	CU YD	75.0	\$0.00	·
13	20800150	TRENCH BACKFILL	CU YD	131.0	\$0.00	·
14	*****	PERVIOUS AGGREGATE SUBBASE	CU YD	58.0	\$0.00	·
15	*****	BEDDING AND VOID OPENING AGGREGATES FOR PERMEABLE PAVERS	CU YD	9.0	\$0.00	·
16	*****	CRUSHED STONE (TEMPORARY USE)	TON	80.0	\$0.00	·
17	35300300	PORTLAND CEMENT CONCRETE BASE COURSE, 8 IN	SQ YD	29.0		
18		PORTLAND CEMENT CONCRETE BASE COURSE, 10 IN	SQ YD	0.0	\$0.00	
19		HIGH EARLY STRENGTH PORTLAND CEMENT CONCRETE ALLEY PAVEMENT, 8 IN	SQ YD	1105.0	\$0.00	·
20	*****	HIGH EARLY STRENGTH PORTLAND CEMENT CONCRETE DRIVEWAY AND ALLEY RETURN PAVEMENT, 8 IN	SQ YD	94.0	\$0.00	
21	*****	HIGH EARLY STRENGTH PORTLAND CEMENT CONCRETE GARAGE APRON, 8 IN	SQ FT	2134.0	\$0.00	·
22	*****	HIGH EARLY STRENGTH PORTLAND CEMENT CONCRETE SIDEWALK, 8 IN	SQ FT	426.0	\$0.00	·
23	*****	HIGH EARLY STRENGTH PORTLAND CEMENT CONCRETE BASE COURSE, 8 IN	SQ YD	5.0	\$0.00	·
24	*****	HIGH EARLY STRENGTH PORTLAND CEMENT CONCRETE BASE COURSE, 10 IN	SQ YD	0.0	\$0.00	
25	*****	PORTLAND CEMENT CONCRETE SIDEWALK, 5 IN	SQ FT	107.0	\$0.00	·
26	*****	PORTLAND CEMENT CONCRETE ADA CURB RAMP, 5 IN	SQ FT	0.0	\$0.00	
27	*****	HIGH EARLY STRENGTH PORTLAND CEMENT CONCRETE ADA CURB RAMP, 8 IN	SQ FT	118.0	\$0.00	
28	*****	DRILL AND GROUT DOWEL AND TIE BARS	EACH	181.0	\$0.00	
29	*****	PERMEABLE CONCRETE BLOCK PAVERS	SQ FT	2678.0	\$0.00	·
30	40600290	BITUMINOUS MATERIALS (TACK COAT)	POUND	53.0	\$0.00	
31	*****	HOT-MIX ASPHALT SURFACE COURSE, IL-9.5LH, MIX "C", N30 (CDOT)	TON	10.0	\$0.00	·
32	*****	HOT-MIX ASPHALT SURFACE COURSE, PATCH, N30 (6 FT OR LESS)	TON	5.0	\$0.00	
33	*****	HOT-MIX ASPHALT SURFACE COURSE, PATCH, N70 (6 FT OR LESS)	TON	0.0	\$0.00	
34	60600605	CONCRETE CURB, TYPE B	LIN FT	92.0	\$0.00	
35		HIGH EARLY STRENGTH PORTLAND CEMENT CONCRETE COMBINATION CURB AND GUTTER, TYPE B-V.12	LIN FT	119.0	\$0.00	
36		COMBINATION CONCRETE CURB AND GUTTER, TYPE B-V.12	LIN FT	13.0	\$0.00	
37	*****	MANHOLE, 3 FT DIAMETER, TYPE B, FRAME AND CLOSED LID (CITY OF CHICAGO)	EACH	0.0	\$0.00	
38	*****	MANHOLE, 3 FT DIAMETER, TYPE A, FRAME AND CLOSED LID (CITY OF CHICAGO)	EACH	0.0	\$0.00	·
39	*****	CATCH BASIN, TYPE A, 4 FT DIAMETER, TYPE 1 FRAME, OPEN LID (CITY OF CHICAGO)	EACH	2.0	\$0.00	
40	*****	INLETS, TYPE A, TYPE 1 FRAME, OPEN LID (CITY OF CHICAGO)	EACH	0.0	\$0.00	
41	*****	DRAINAGE AND UTILITY STRUCTURES TO BE ADJUSTED	EACH	1.0	\$0.00	
42	*****	VORTEX RESTRICTOR	EACH	1.0	\$0.00	
43	*****	STORM SEWERS, EXTRA STRENGTH VITRIFIED CLAY PIPE, 8 IN	LIN FT	0.0	\$0.00	
44	*****	STORM SEWERS, DUCTILE IRON PIPE, 8 IN	LIN FT	74.0	\$0.00	
45	*****	STORM SEWERS, EXTRA STRENGTH VITRIFIED CLAY PIPE, 10 IN	LIN FT	0.0	\$0.00	
46	*****	STORM SEWERS, EXTRA STRENGTH VITRIFIED CLAY PIPE, 12 IN	LIN FT	261.0	\$0.00	
47	*****	STORM SEWERS, DUCTILE IRON PIPE, 12 IN	LIN FT	0.0	\$0.00	
48	*****	STORM SEWERS, REINFORCED CONCRETE PIPE, 30 IN.	LIN FT	0.0	\$0.00	
49	*****	CIP OR PRECAST CONCRETE REDUCER	EACH	0.0	\$0.00	
50	CDOT SP 550-3	ABANDON AND FILL EXISTING COMBINED SEWER	LIN FT	165.0		
	1	·	1	1	·	<u> </u>

	*****	EXISTING SEWER TO BE REMOVED	LIN FT	0.0	\$0.00	\$0.00
	*****	REMOVING MANHOLES	EACH	0.0	\$0.00	\$0.00
	*****	REMOVING CATCH BASINS	EACH	0.0	\$0.00	\$0.00
	*****	REMOVING INLETS	EACH	0.0	\$0.00	\$0.00
	*****	SEWER CLEANING AND TELEVISING (24 IN DIAMETER OR LESS)	LIN FT	0.0	\$0.00	\$0.00
	60100085	GEOTECHNICAL FABRIC	SQ YD	519.0	\$0.00	\$0.00
	*****	PULVERIZED TOPSOIL MIX	CU YD	6.7	\$0.00	\$0.00
	*****	HYDRAULIC SEEDING, CLASS 1A	SQ YD	12.0	\$0.00	\$0.00
	78000200	THERMOPLASTIC PAVEMENT MARKING, LINE 4 IN	LIN FT	0.0	\$0.00	\$0.00
	*****	CONSTRUCTION SIGNS	SQ FT	64.0	\$0.00	\$0.00
	*****	PREMOLDED RUBBER SPEED HUMPS	EACH	0.0	\$0.00	\$0.00
	*****	REMOVE AND SALVAGE SIGN PANEL AND POLE ASSEMBLY	EACH	0.0	\$0.00	\$0.00
	*****	CURB PAINTING	LIN FT	0.0	\$0.00	\$0.00
I	CDOT SP 905-1	MEMBRANE WATERPROOFING SYSTEM	SQ FT	0.0	\$0.00	\$0.00


# GENERAL NOTES

- 1. CONTRACTOR WILL BE REQUIRED TO PREPARE A PHASING AND LOGISTICS PLAN WITHIN 30 DAYS OF NTP FOR REVIEW AND APPROVAL BY CDOT AND PBC, PRIOR TO MOBILIZATION AND COMMENCEMENT OF ANY WORK.
- 2. CONTRACTOR SHALL PROVIDE CRITICAL SUBMITTALS, INCLUDING SEWER AND DRAINAGE STRUCTURES, WITHIN 30 DAYS OF ISSUANCE OF THE NTP.
- 3. ON-SITE CONSTRUCTION WORK AT EACH ALLEY LOCATION MUST BE COMPLETED WITHIN 45 CALENDAR DAYS FROM COMMENCEMENT.

z	OF CHIO	
FILE NAME:		<b>CDOT</b>

CHICAGO	USER NAME = AB	DESIGNED -	JS	REVISED -
		DRAWN -	JS	REVISED -
	PLOT SCALE = 20.0000 ' / in.	CHECKED -	SJ/LM	REVISED -
	PLOT DATE = 7/1/2025	DATE -	07/01/2025	ISSUED FOR BID - 07/10/2025

	OUC NUMBER	COUNTY	TOTAL SHEETS	SHEET NO.
	OUC IR #122194	COOK	25	3
STA.	TO STA.	SCALE: AS	SHOWN	

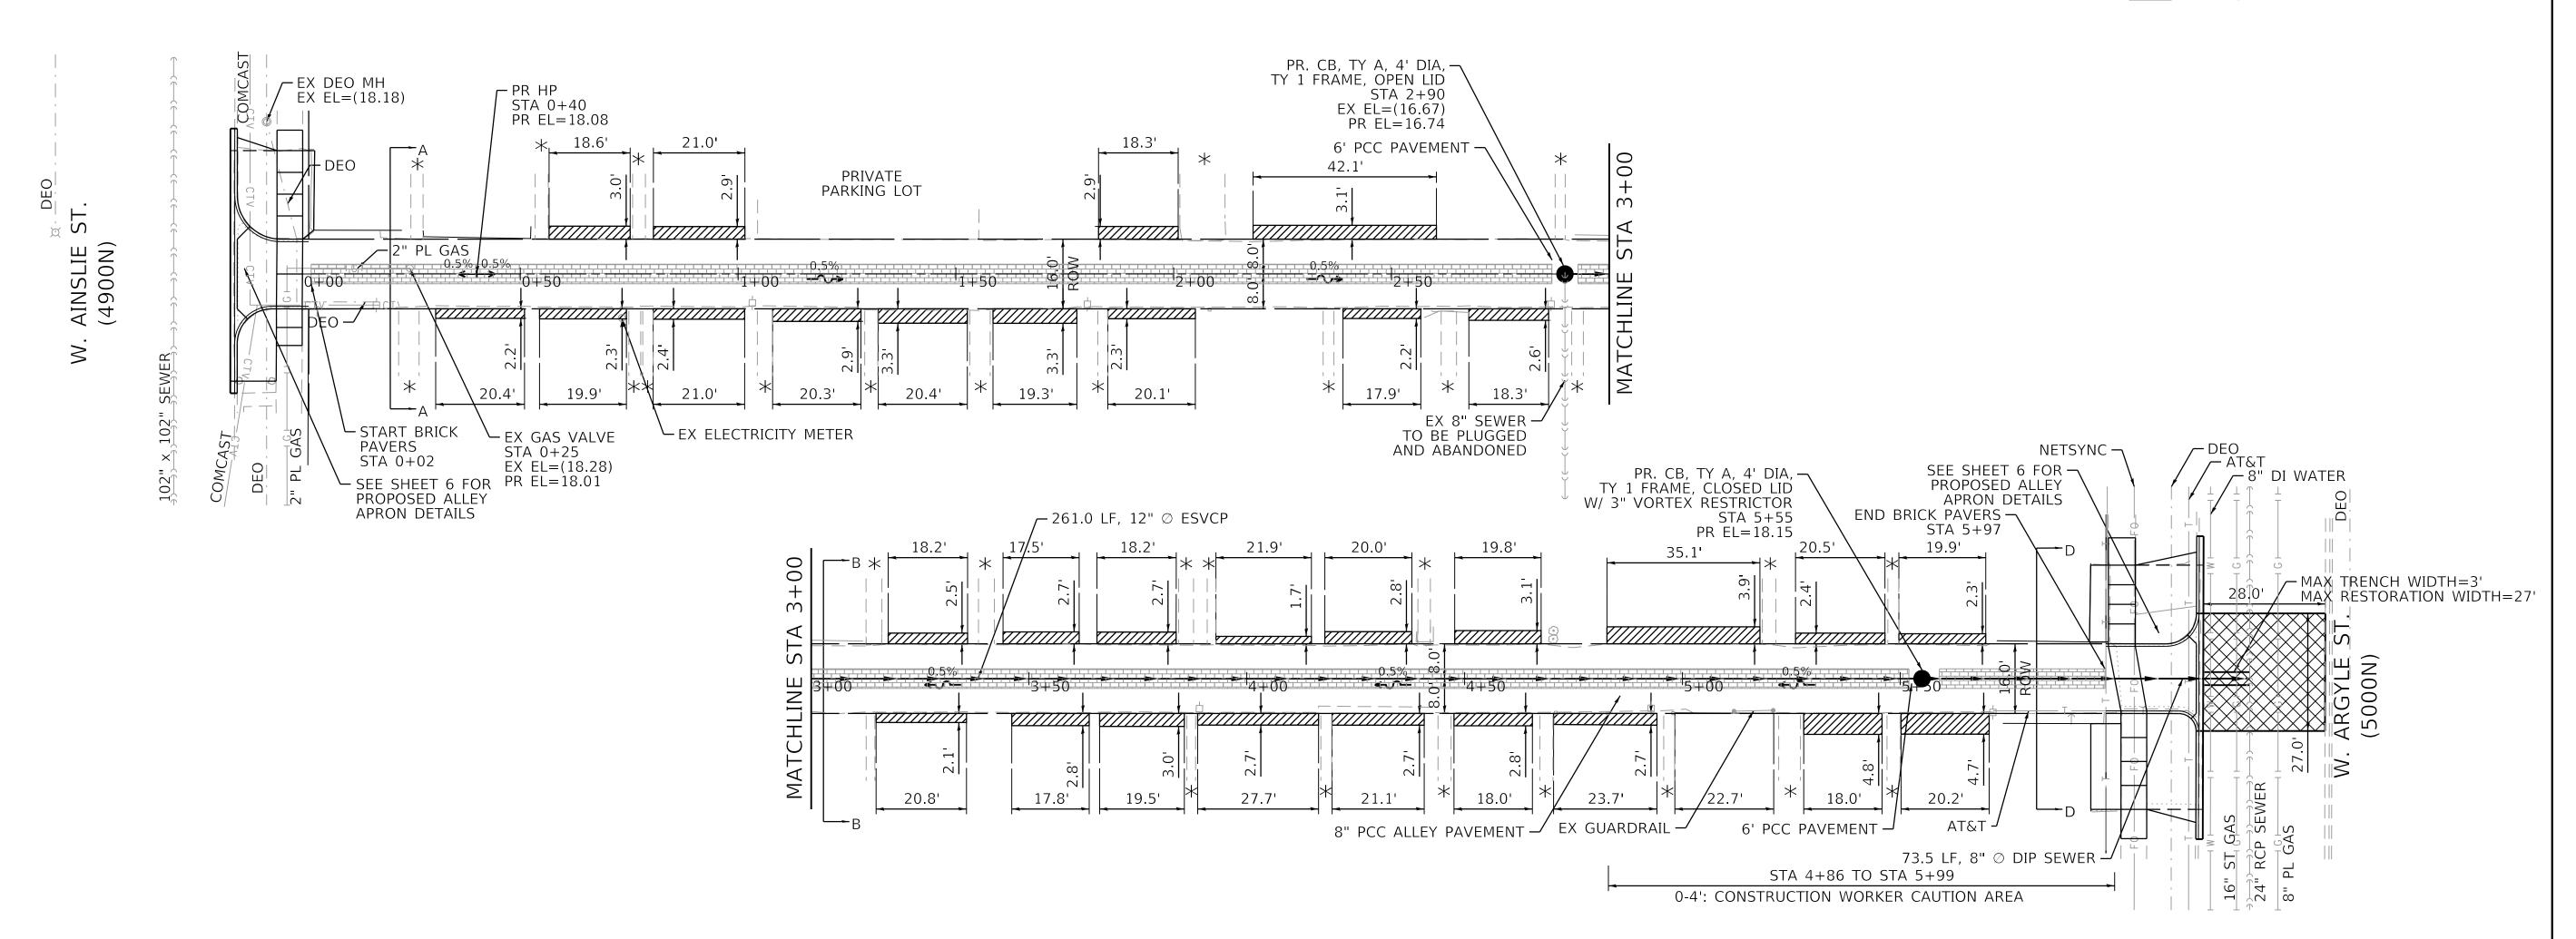

#### **NOTES**

- 1. ROW LINES SHOWN ARE APPROXIMATE AND FOR REFERENCE ONLY. CONTRACTOR IS TO
- VERIFY/CONFIRM ROW PRIOR TO CONSTRUCTION.
- 2.  $\times$  MATCH EXISTING ENTRANCES AND GATES.
- 3. AS-BUILT DRAWING TO BE SUBMITTED TO DWM.
- 4. ALL EXCAVATIONS MORE THAN 5' (FEET) DEEP MUST COMPLY WITH OSHA REQUIREMENTS.
- 5. IT IS THE CONTRACTOR'S SOLE RESPONSIBILITY TO COMPLY WITH ALL OSHA REQUIREMENTS.
- 6. CONTRACTOR IS RESPONSIBLE FOR ALLEY CLOSURE PROCEDURES FOLLOWING GUIDELINES OF IDOT STANDARD DETAIL 701501-06. PROCEDURE TO INCLUDE: NOTIFYING BUILDINGS WITHIN PROJECT LIMITS OF EXACT START DATE IN WHICH ALLEY WILL BE CLOSED AND PLACING APPROPRIATE SIGNING AND BARRICADES IN ADVANCE OF ALLEY CLOSURE.

#### **BENCHMARK**

CITY OF CHICAGO BENCHMARK #319, ELEV. = 15.629' 11.1' N. OF S. LINE OF W. LELAND AVE AND 64.6' E. OF E. LINE OF THE FIRST ALLEY W. OF N. WESTERN AVE.

TBM #1 ELEV.=19.403' SET LARGE NAIL IN WEST FACE OF FIRST POWER POLE FROM NORTH,  $\pm$  30' SOUTH OF S. LINE OF W. ARGYLE ST.

TBM #2 ELEV.=18.287' TOP OF EAST BOLT OF LIGHT POLE AT SOUTHWEST CORNER OF W. AINSLIE ST AND SOUTH END OF NORTH-SOUTH ALLEY.


#### <u>LEGEND</u>

---- EXISTING ROW LINE EXISTING LOT LINE (X.XX) EXISTING ELEV PROPOSED ELEV HIGH POINT REMOVE & REPLACE

GARAGE APRONS HMA RESTORATION





OF CHICAGO	
SCOMMIS	
PUBLIC BUILDING COMMISSION	

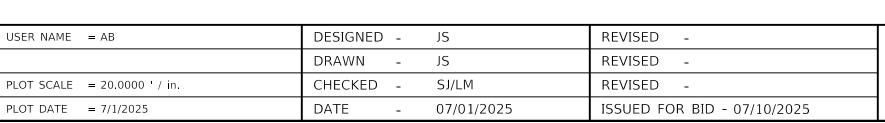

CITY OF CHICAGO
DEPARTMENT OF TRANSPORTATION
40th WARD


PROPOSED CONDITIONS PLAN VIEW	OUC NUMBER		COUNTY	TOTAL SHEETS	SHE
PBC PROJECT NO # 22925	OUC IR	#122194	СООК	25	5
W. ARGYLE STREET - W. AINSLIE STREET	STA. 0+00	TO STA. 5+99	SCALE: AS	SHOWN	
N. HOYNE AVENUE - N. SEELEY AVENUE					

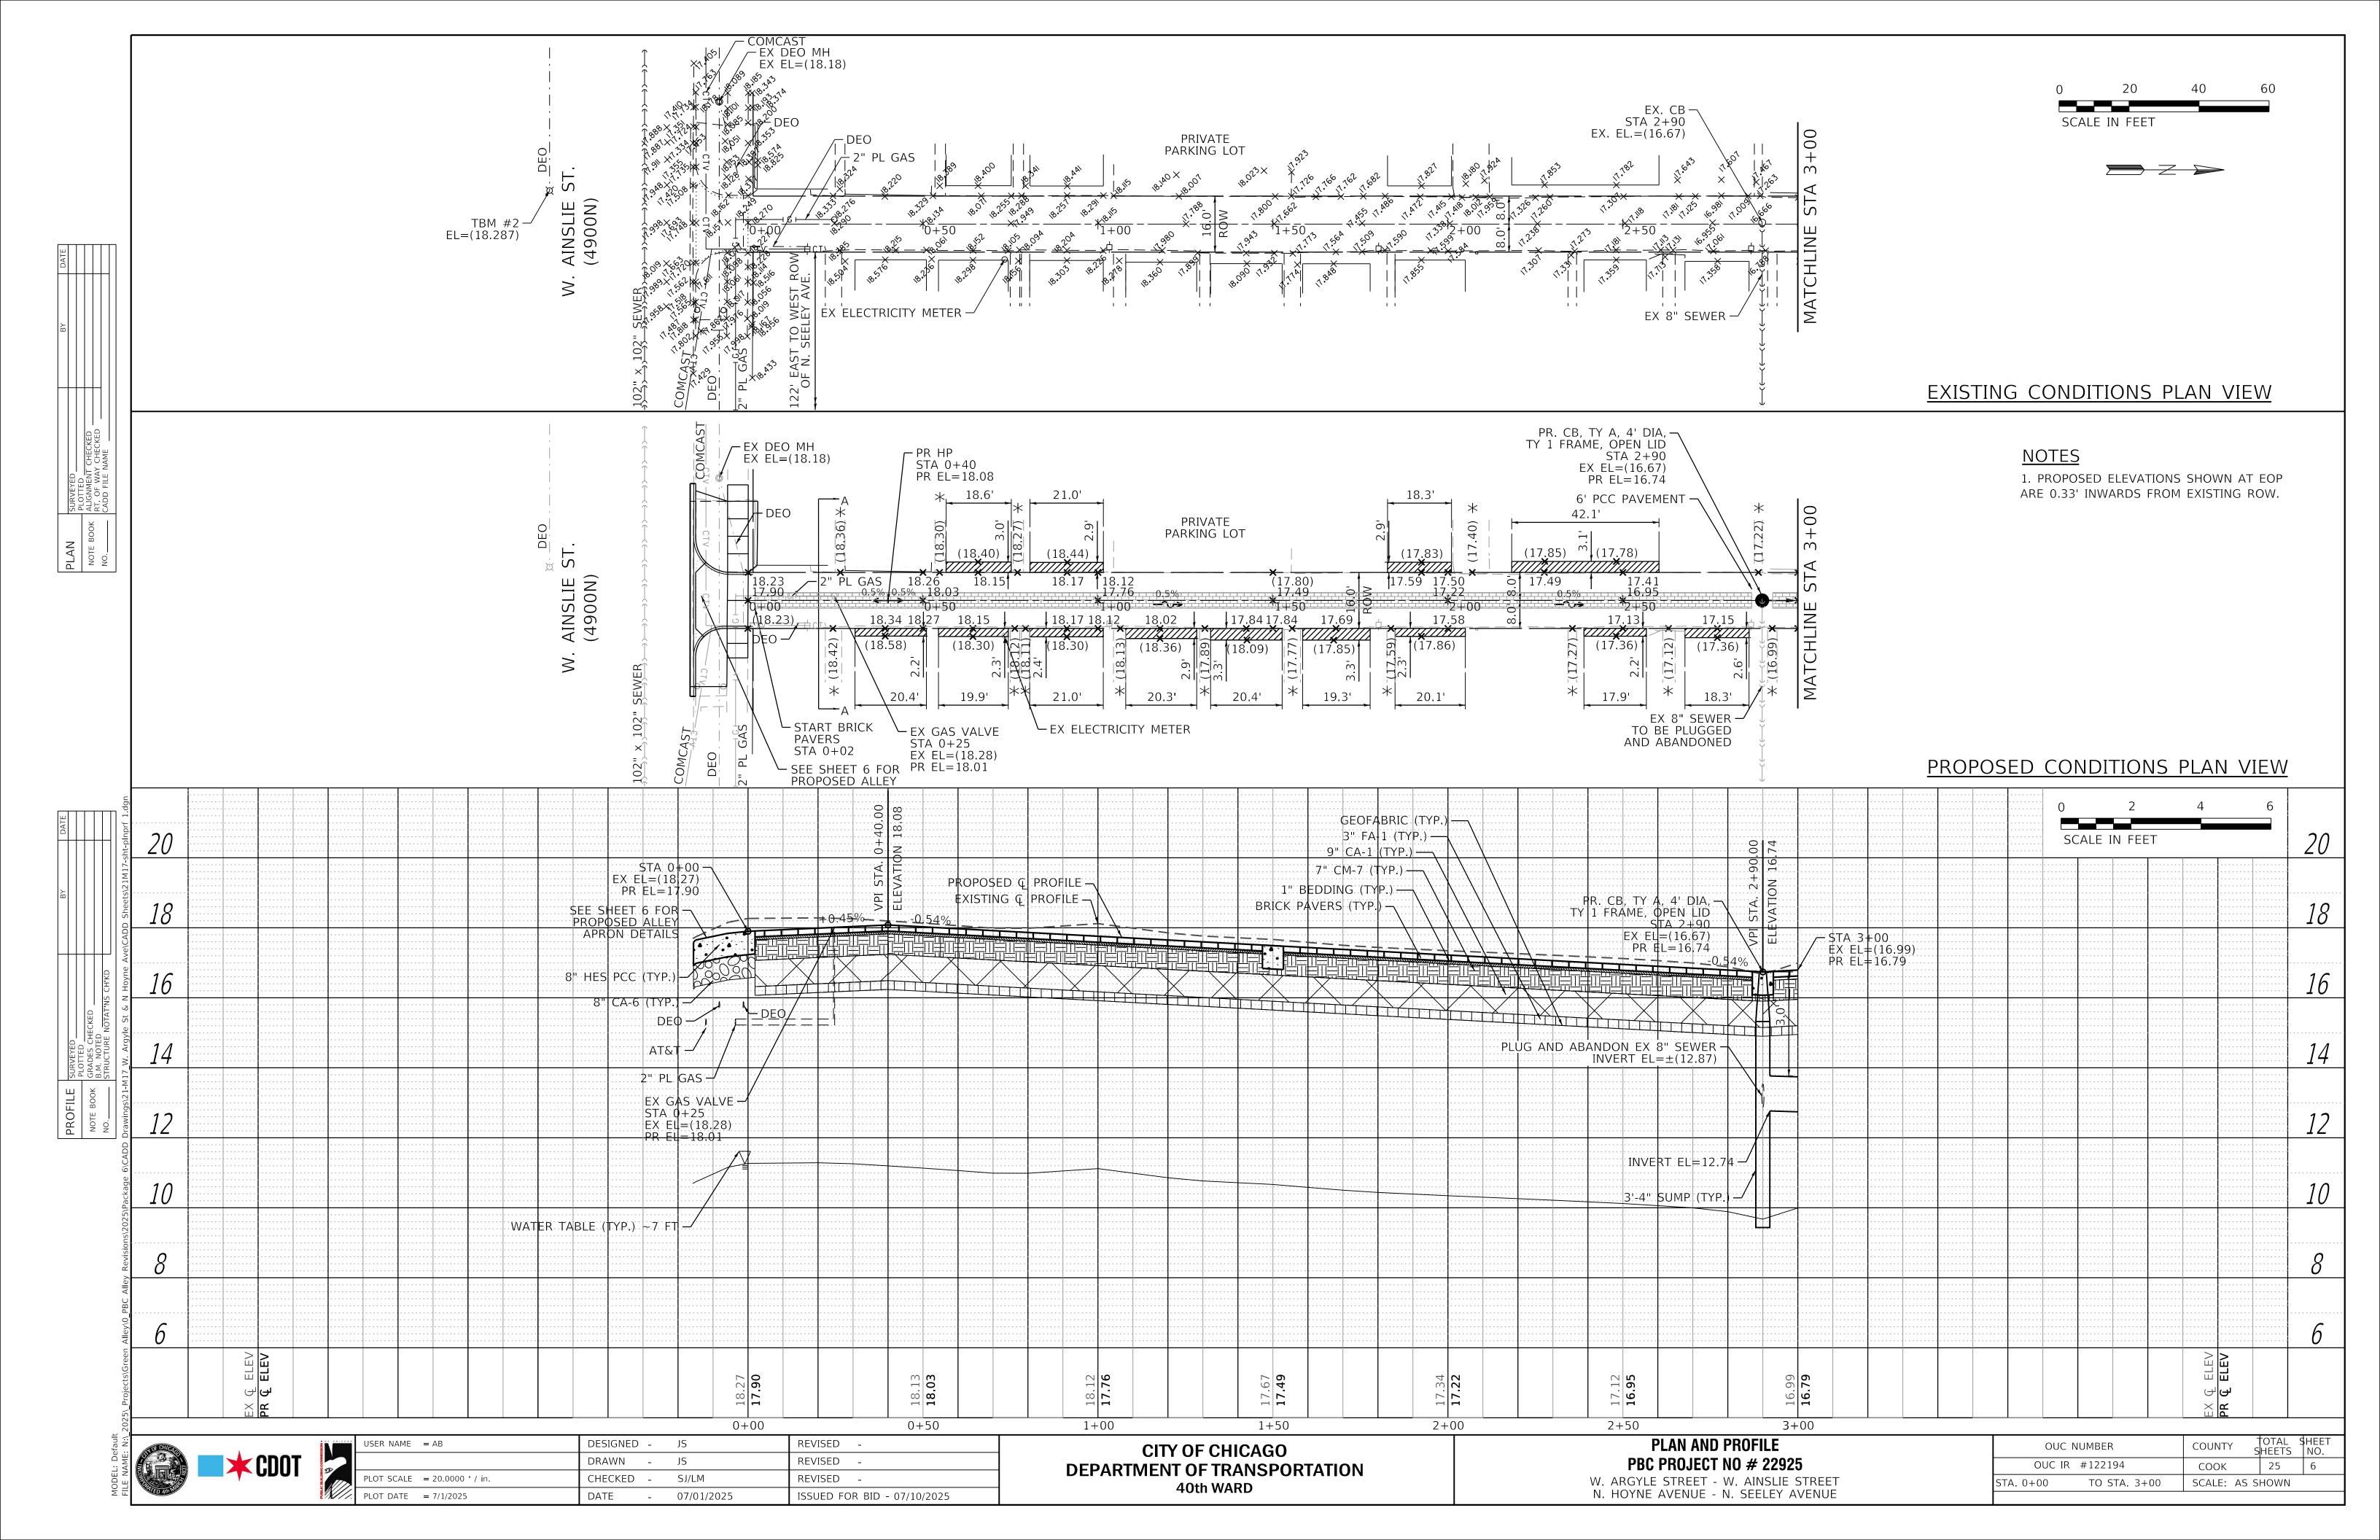

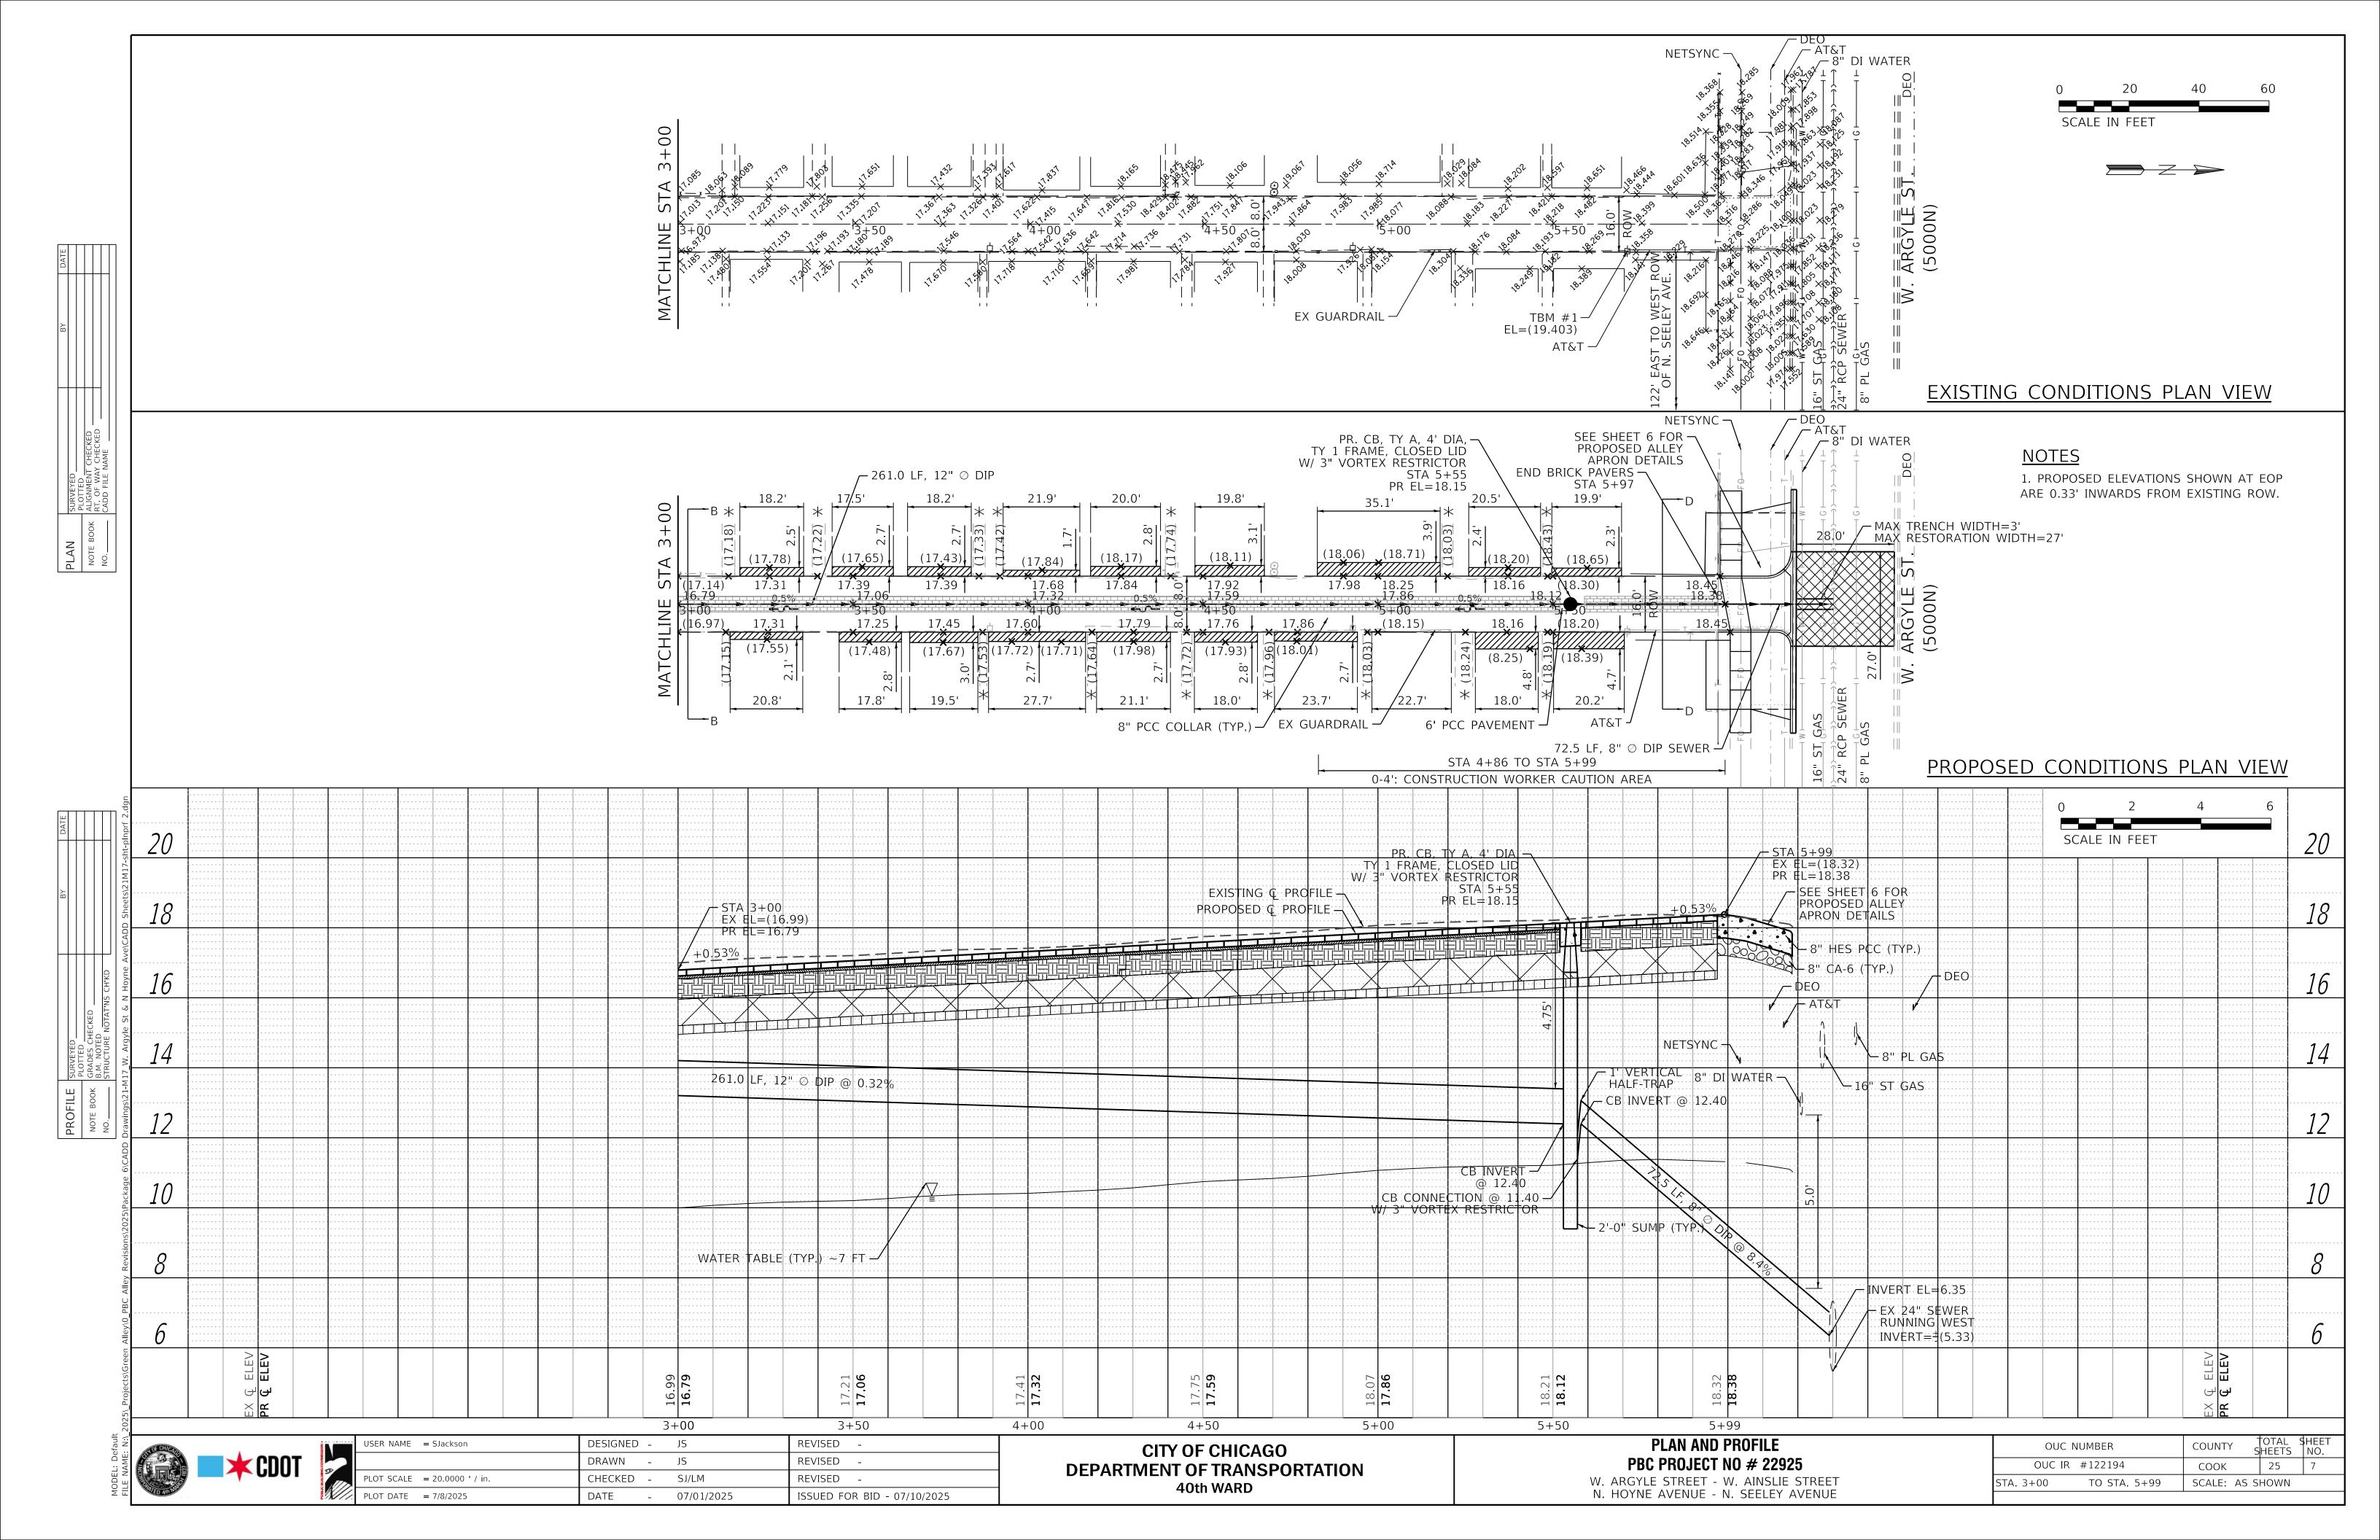

### PROPOSED ALLEY APRON DETAILS 1" = 5'

NOTE: ALLEY RETURN WILL BE CONSTRUCTED IN PCC PAVEMENT USE HES PCC BASE COURSE AT ALL T3 ALLEYS/DRIVEWAYS

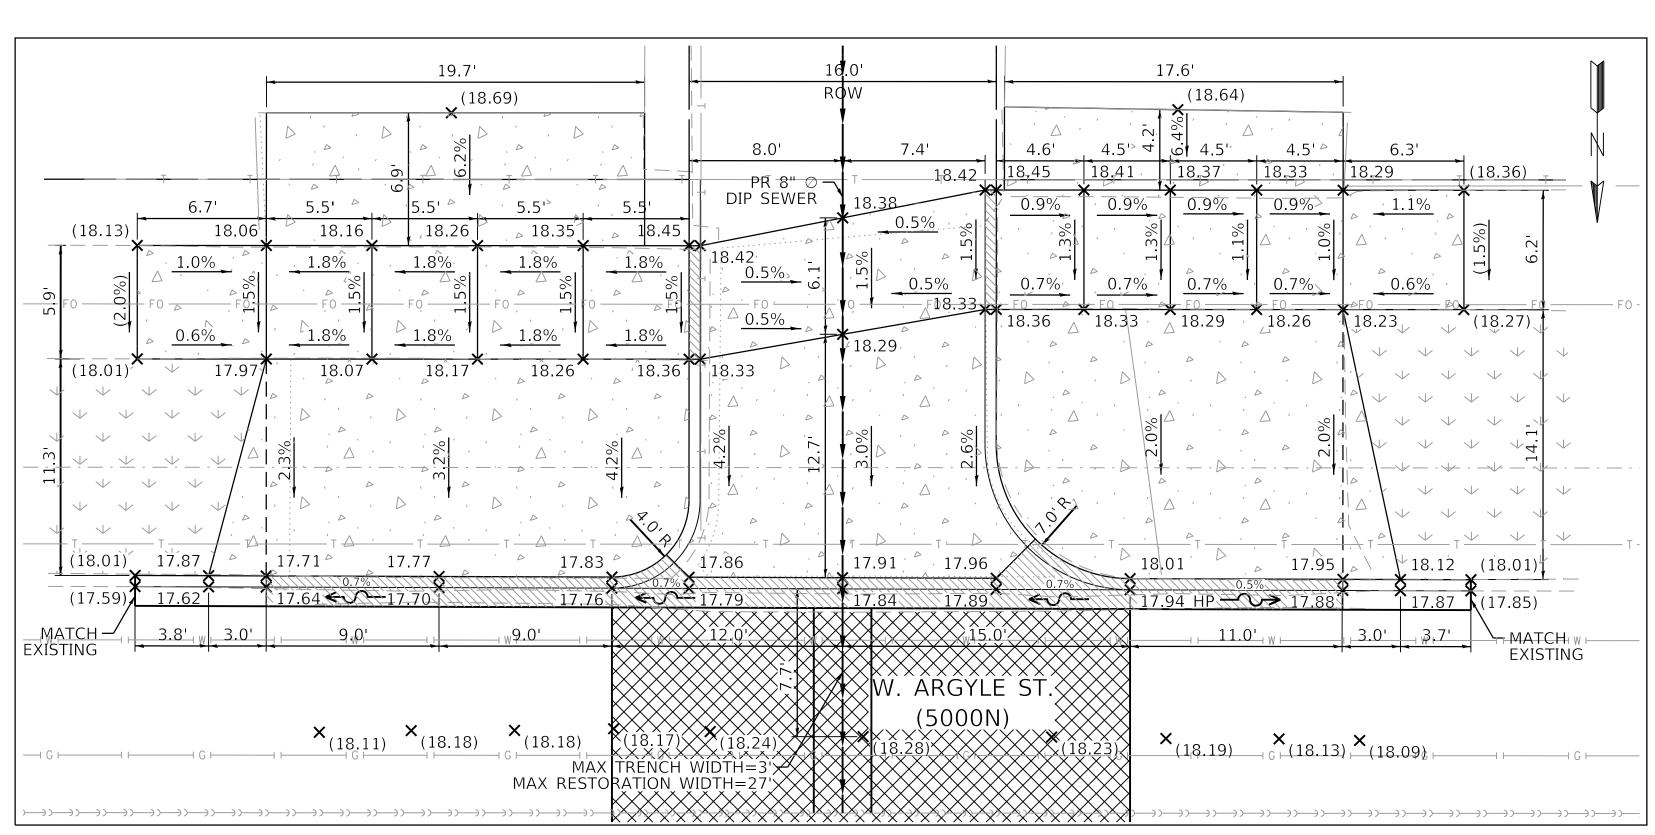

PROPOSED ALLEY APRON DETAILS

1" = 5'

NOTE: ALLEY RETURN WILL BE CONSTRUCTED IN PCC PAVEMENT USE HES PCC BASE COURSE AT ALL T3 ALLEYS/DRIVEWAYS

\*CDOT

 USER NAME
 = AB
 DESIGNED
 JS
 REVISED

 PLOT SCALE
 = 5.0000 ' / in.
 CHECKED
 SJ/LM
 REVISED


 PLOT DATE
 = 7/1/2025
 DATE
 07/01/2025
 ISSUED FOR BID - 07/10/2025

CITY OF CHICAGO DEPARTMENT OF TRANSPORTATION 40th WARD ALLEY APRON DETAILS
PBC PROJECT NO # 22925
W. ARGYLE STREET - W. AINSLIE STREET
N. HOYNE AVENUE - N. SEELEY AVENUE

OUC NUMBER
COUNTY
SHEETS
NO.

OUC IR #122194
COOK
25
8


STA.
TO STA.
SCALE: AS SHOWN

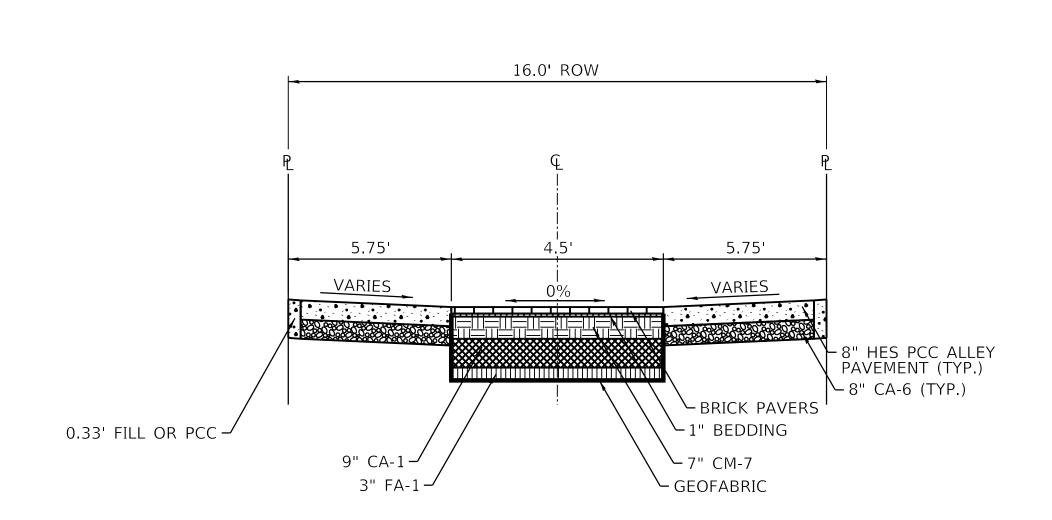

#### PROPOSED TYPICAL CROSS SECTION B-B

STA. 0.02 TO STA. 2+90


NOTE: 0.33' FILL OR PCC WILL BE PAID FOR AS 8" ALLEY PAVEMENT, CA-6, OR PULVERIZED TOPSOIL MIX W/ HYDROSEED.

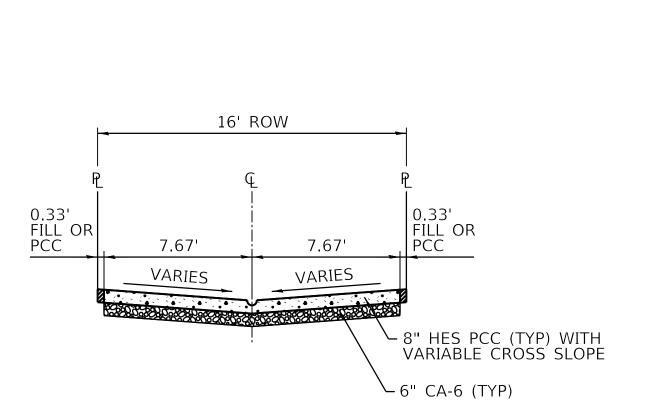

#### PROPOSED TYPICAL CROSS SECTION C-C

STA. 0+00 TO STA. 0+02

NOTE: 0.33' FILL OR PCC WILL BE PAID FOR AS 8" ALLEY PAVEMENT, CA-6, OR PULVERIZED TOPSOIL MIX W/ HYDROSEED.

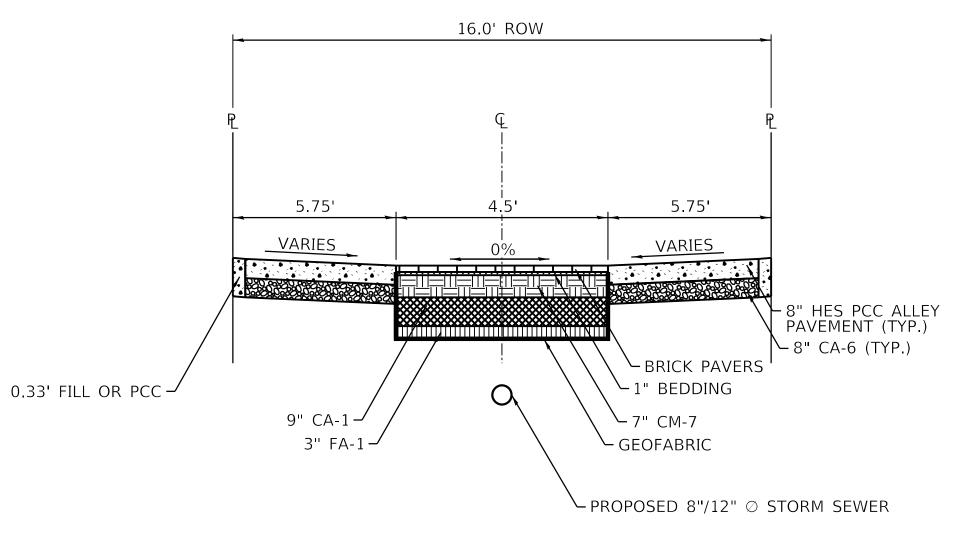

#### PROPOSED TYPICAL CROSS SECTION B-B


STA. 2+90 TO STA. 5+97


NOTE: 0.33' FILL OR PCC WILL BE PAID FOR AS 8" ALLEY PAVEMENT, CA-6, OR PULVERIZED TOPSOIL MIX W/ HYDROSEED.




ICAGO	USER NAME = AB	DESIGNED -	JS	REVISED -
		DRAWN -	JS	REVISED -
	PLOT SCALE = 20.0000 ' / in.	CHECKED -	SJ/LM	REVISED -
//.	PLOT DATE = 7/1/2025	DATE -	07/01/2025	ISSUED FOR BID - 07/10/2025

	OUC NUMBER	COUNTY	TOTAL SHEETS	SHEET NO.
	OUC IR #122194	COOK	25	9
STA.	TO STA.	SCALE: NT	5	

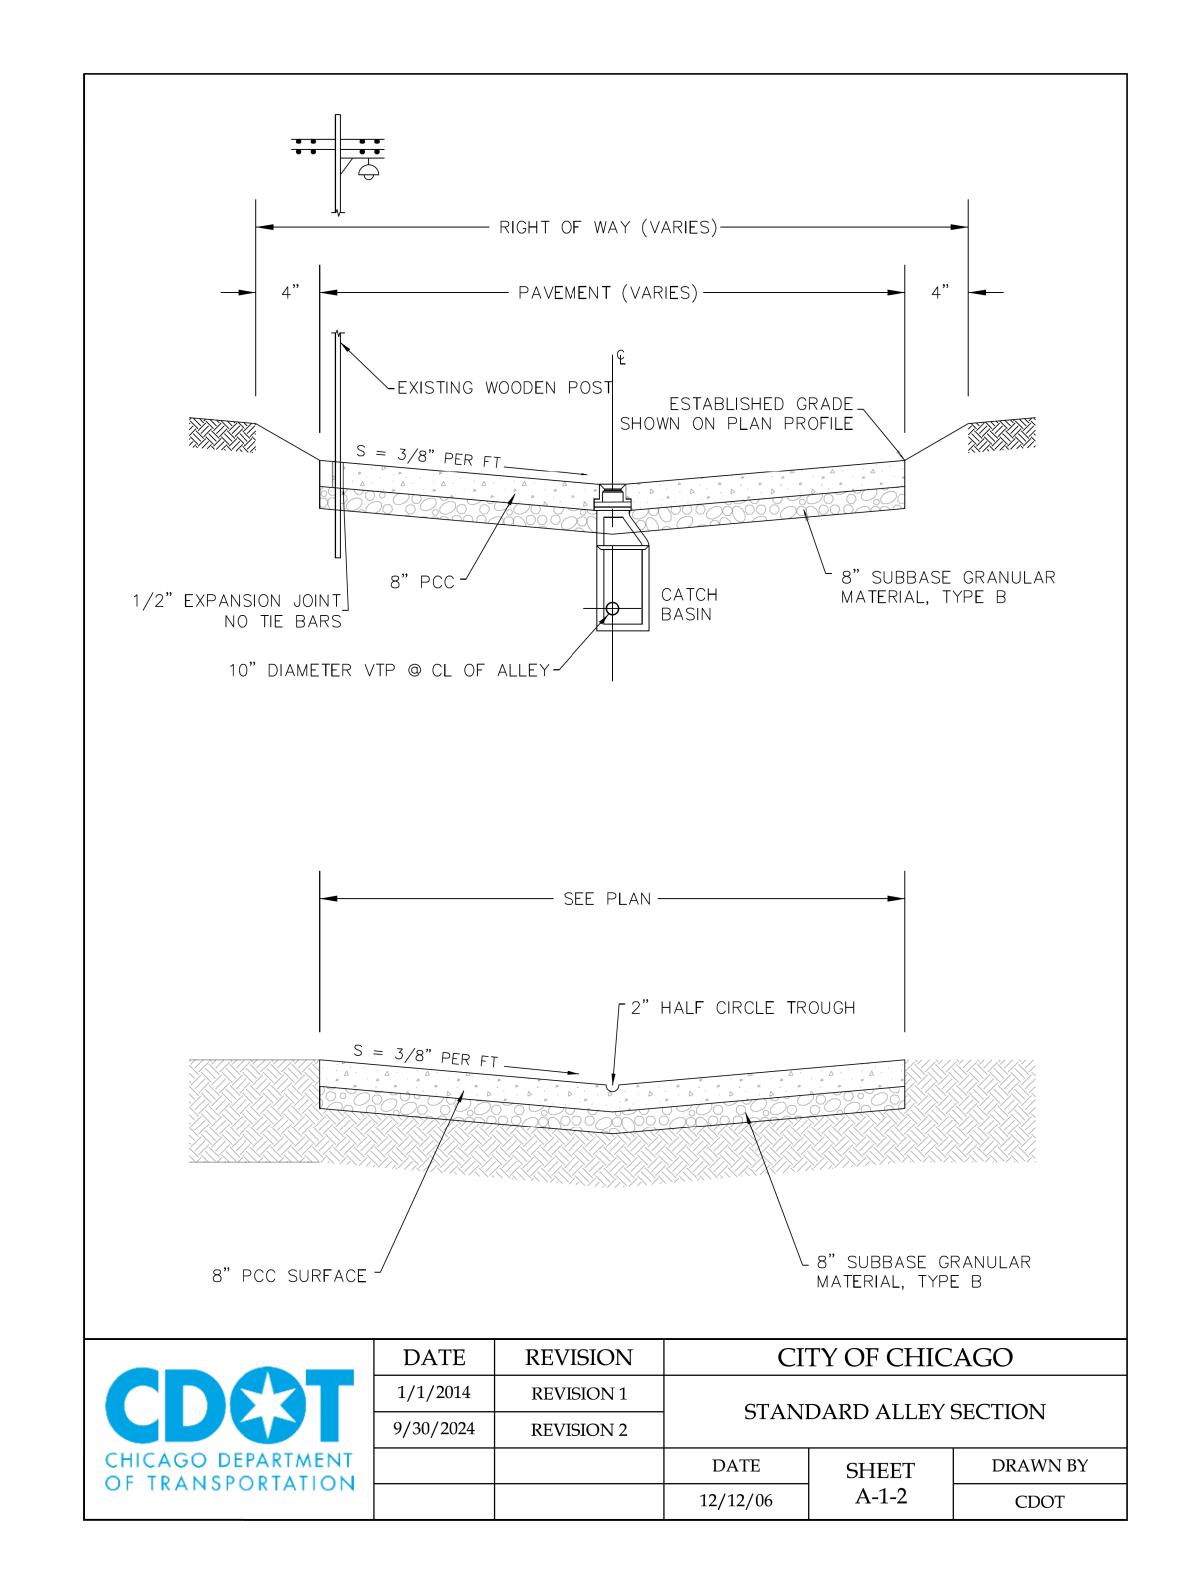

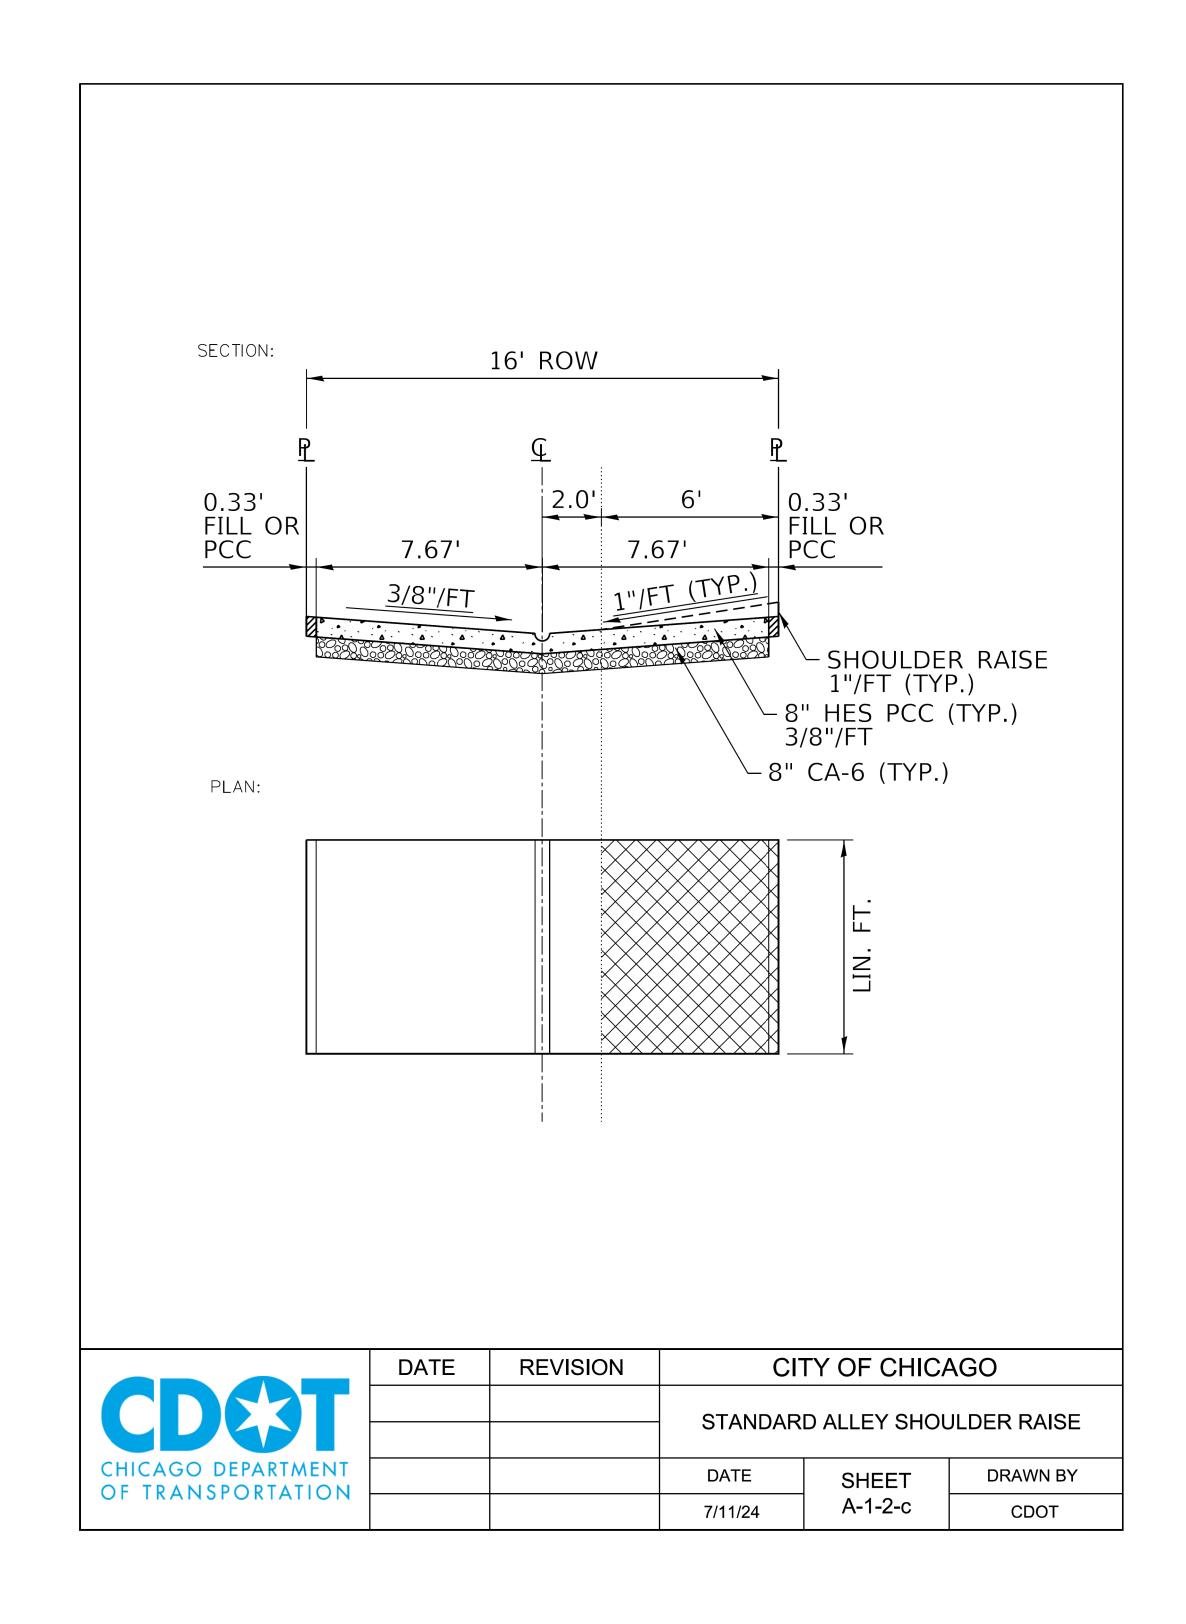




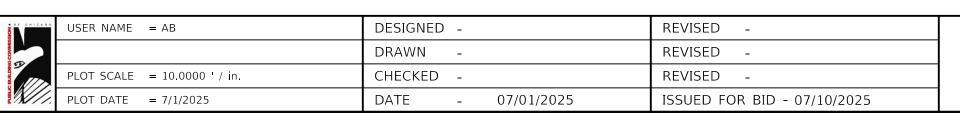

CITY OF CHICAGO
DEPARTMENT OF TRANSPORTATION
40th WARD


CDOT STANDARD CONSTRUCTION DETAILS
PBC PROJECT NO # 22925
W. ARGYLE STREET - W. AINSLIE STREET
N. HOYNE AVENUE - N. SEELEY AVENUE

OUC NUMBER
COUNTY
SHEETS NO.
OUC IR #122194
COOK
25
10
STA.
TO STA.
SCALE:

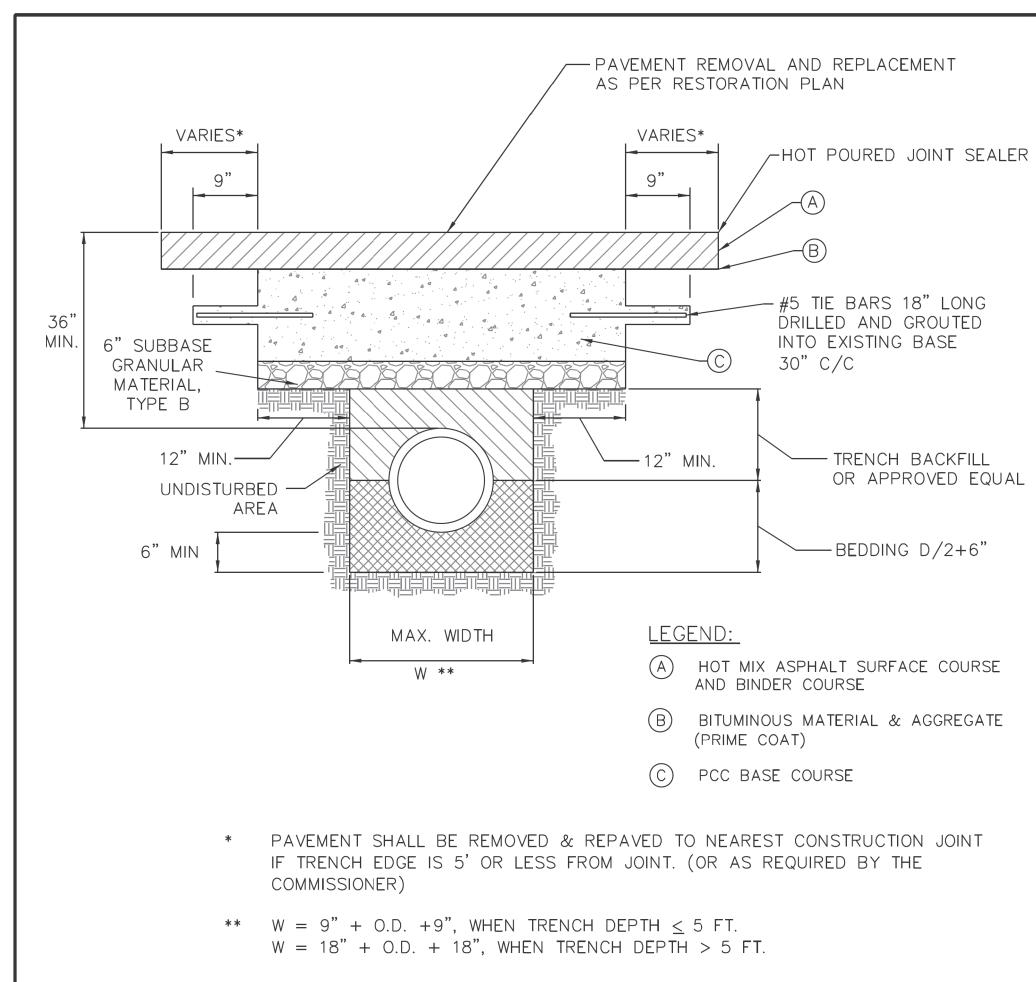

#### NOTES:

- 1. THE PORTLAND CEMENT CONCRETE BASE SHALL BE 8" OR MORE (SEE SECTION 4.2b FOR REQUIRED THICKNESS). FOR CONCRETE STREETS THE CONCRETE SHALL BE BROUGHT TO GRADE (INCLUDING 1'-0" OVERLAP) AND FINISHED AS REQUIRED IN THE IDOT SSRBC.
- 2. ALL EXISTING PAVEMENTS SHALL BE SAW CUT 1'-0" ON BOTH SIDES OF THE TRENCH OR PAVEMENT OPENING. UNDER NO CIRCUMSTANCES SHOULD EXISTING PAVEMENT, WHICH HAS BEEN UNDERMINED OR OTHERWISE DISTURBED, BE LEFT IN PLACE AND NOT RESTORED.
- 3. ALL STREET PAVEMENT WILL REQUIRE PLACEMENT OF #5 TIE BARS, 18 INCHES LONG DRILLED AND GROUTED (NON SHRINK) AT 30" CENTERS ON ALL SIDES. A MINIMUM OF TWO TIE BARS WILL BE REQUIRED ON EACH SIDE OF SAW CUT BOUNDARIES.
- 4. ALL TIE BARS AND DOWEL BARS ARE TO BE EPOXY COATED (INCIDENTAL).

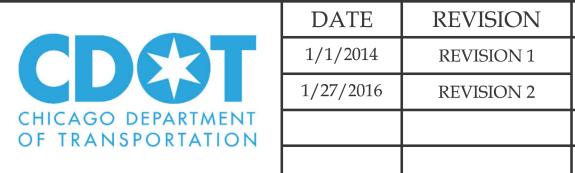

DATE	REVISION	CI	AGO				
1/1/2014	REVISION 1	STREET PAVEMENT RESTORATION			STREET PAVEMENT RESTORATIO		STORATION
1/27/2016	REVISION 2	DETAIL WITH TRENCH BACKFIL					
		DATE	SHEET	DRAWN BY			
		12/12/06	A-2-2A	CDOT			



ICAGO	USER NAME = AB	DESIGNED -		REVISED -
		DRAWN -		REVISED -
	PLOT SCALE = 10.0000 ' / in.	CHECKED -		REVISED -
//.	PLOT DATE = 7/1/2025	DATE -	07/01/2025	ISSUED FOR BID - 07/10/2025

	OUC NUMBER	COUNTY	TOTAL SHEETS	SHEET NO.
	OUC IR #122194	COOK	25	11
STA.	TO STA.	SCALE:		


#### JOINTS IN CURB, COMBINED CURB & GUTTER


TRANSVERSE JOINTS OF A TYPE SIMILAR TO THAT USED IN THE ADJACENT PAVEMENT SHALL BE INSTALLED IN THE CURB, GUTTER AND COMBINED CURB & GUTTER IN PROLONGATION WITH THE JOINTS IN THE PAVEMENT. THE DETAILS OF THE TRANSVERSE JOINTS IN THE CURB, GUTTER AND COMBINED CURB & GUTTER SHALL BE APPROVED BY THE COMMISSIONER. CURB, GUTTER OR COMBINED CURB & GUTTER IS CONSTRUCTED ADJACENT TO A FLEXIBLE BASE PAVEMENT, 1" THICK EXPANSION JOINTS COMPOSED OF BITUMINOUS PERFORMED JOINT FILLER SHALL BE INSTALLED IN THE CURB AND/OR GUTTER AT POINTS OF CURVATURE AND AT CONSTRUCTION JOINTS. CONTRACTION JOINTS SHALL ALSO BE PLACED BETWEEN THESE EXPANSION JOINTS AT DISTANCES NOT EXCEEDING 20 FEET. ALL TIE BARS SHALL BE DEFORMED-ALL DOWEL BARS SHALL BE SMOOTH.

> NOTE: ALL TIE BARS AND DOWEL BARS TO BE EPOXY COATED.

\*AT LOCATIONS REQUIRING DEPRESSED CURBS SEE THE ADA STANDARDS FOR CONSTRUCTION DETAILS

CDEST CHICAGO DEPARTMENT OF TRANSPORTATION	DATE	REVISION	CITY OF CHICAGO			
	1/1/2014	REVISION 1	CONCRETE CURB & GUTTER			
				DETAIL		
			DATE	SHEET	DRAWN BY	
			12/12/06	A-2-6	CDOT	

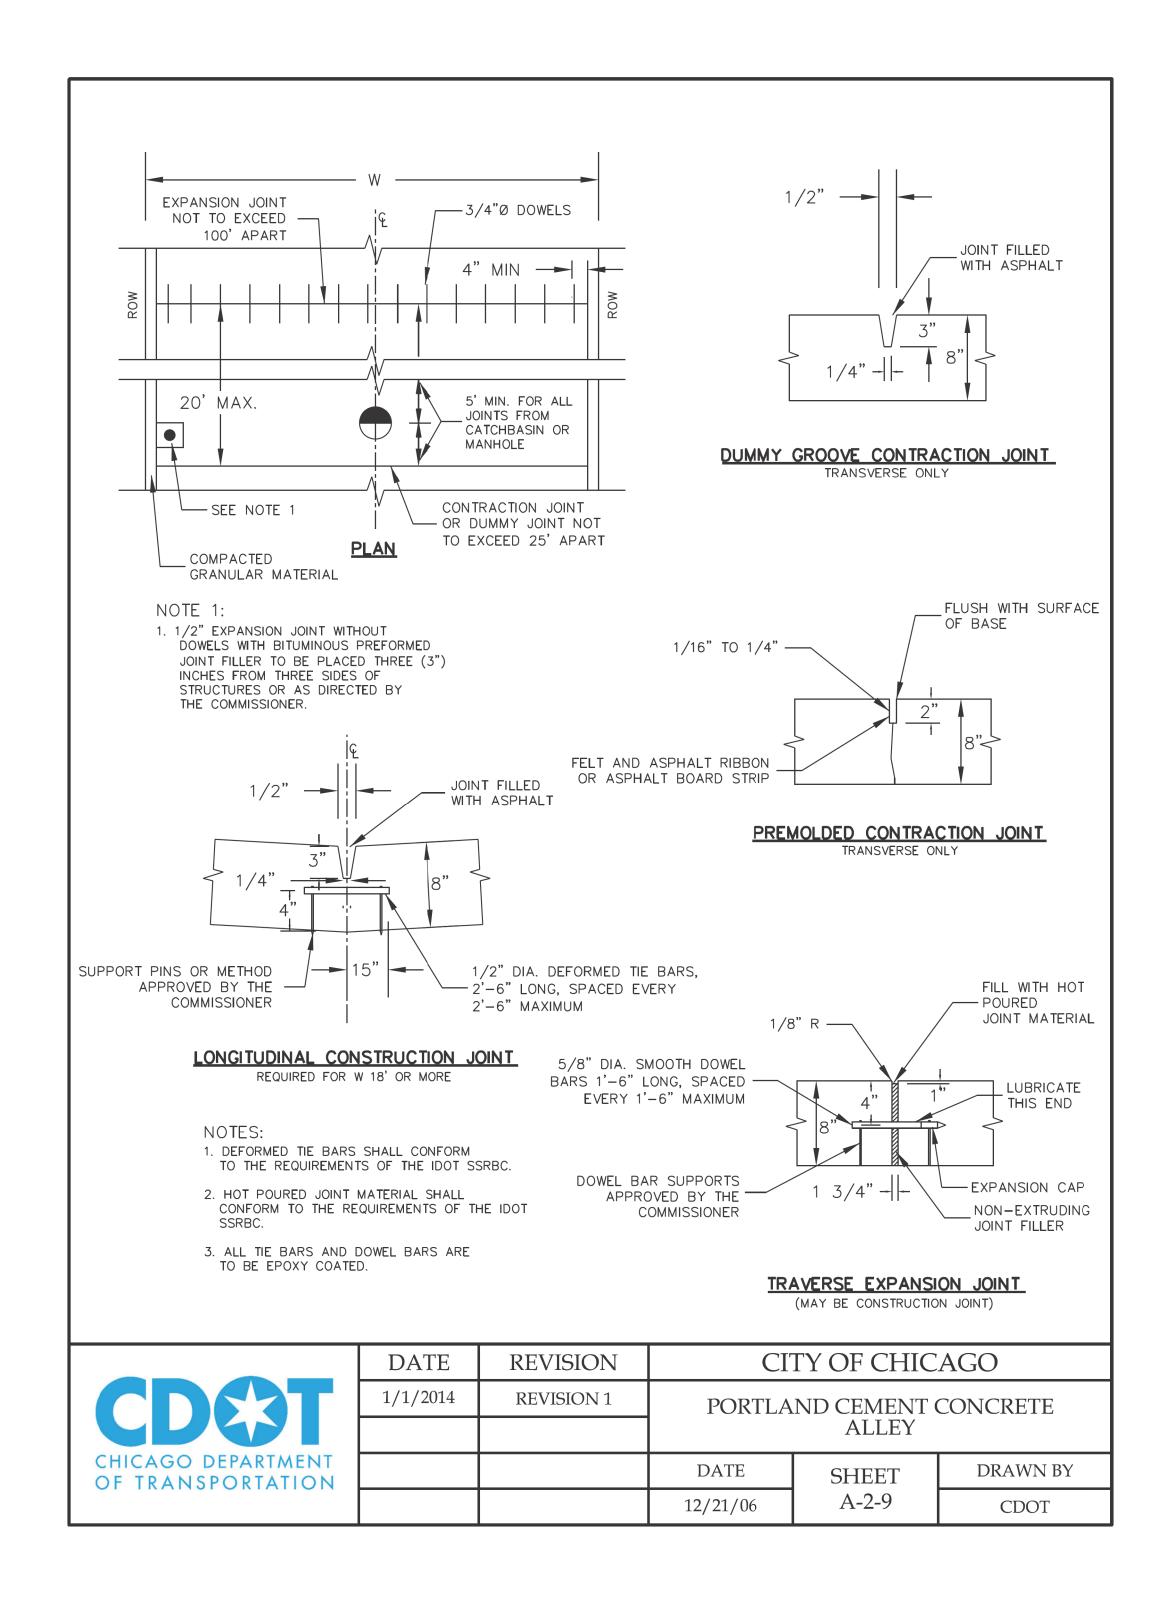

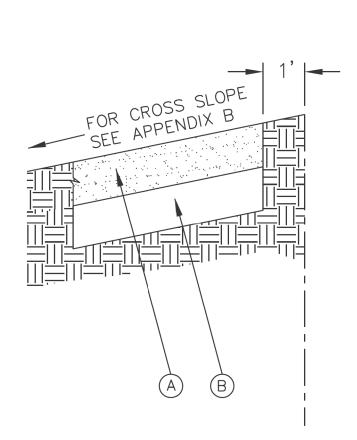

#### LEGEND:

- A PROPOSED 5" P.C.C. SIDEWALK \*
- B SUBBASE GRANULAR MATERIAL, TYPE B OR C, 4"
  - \* CURB RAMP & KEYSTONE 8" P.C.C. AT SIGNALIZED AND INDUSTRIAL STREET INTERSECTIONS

CDOT	DATE	REVISION	CITY OF CHICAGO			
	1/1/2014	REVISION 1	ADA COMPLIANT SIDEWALK			
			CON	ETAILS		
CHICAGO DEPARTMENT OF TRANSPORTATION			DATE	SHEET	DRAWN BY	
			12/20/06	A-3-1	CDOT	

₩ CDO


PL PL

0	USER NAME = AB	DESIGNED	-		REVISED -
		DRAWN	-		REVISED -
	PLOT SCALE = 10.0000 ' / in.	CHECKED	-		REVISED -
1	PLOT DATE = 7/1/2025	DATE	-	07/01/2025	ISSUED FOR BID - 07/10/2025


CITY OF CHICAGO
<b>DEPARTMENT OF TRANSPORTATION</b>
40th WARD

<b>100</b>	OT STANDARD CONSTRUCTION DETAILS							
PBC PROJECT NO # 22925								
W.	ARGYLE STREET - W. AINSLIE STREET							
Ν.	HOYNE AVENUE - N. SEELEY AVENUE							

	OUC NUMBER	COUNTY	TOTAL SHEETS	SHEE NO.
	OUC IR #122194	COOK	25	13
STA.	TO STA.	SCALE:		

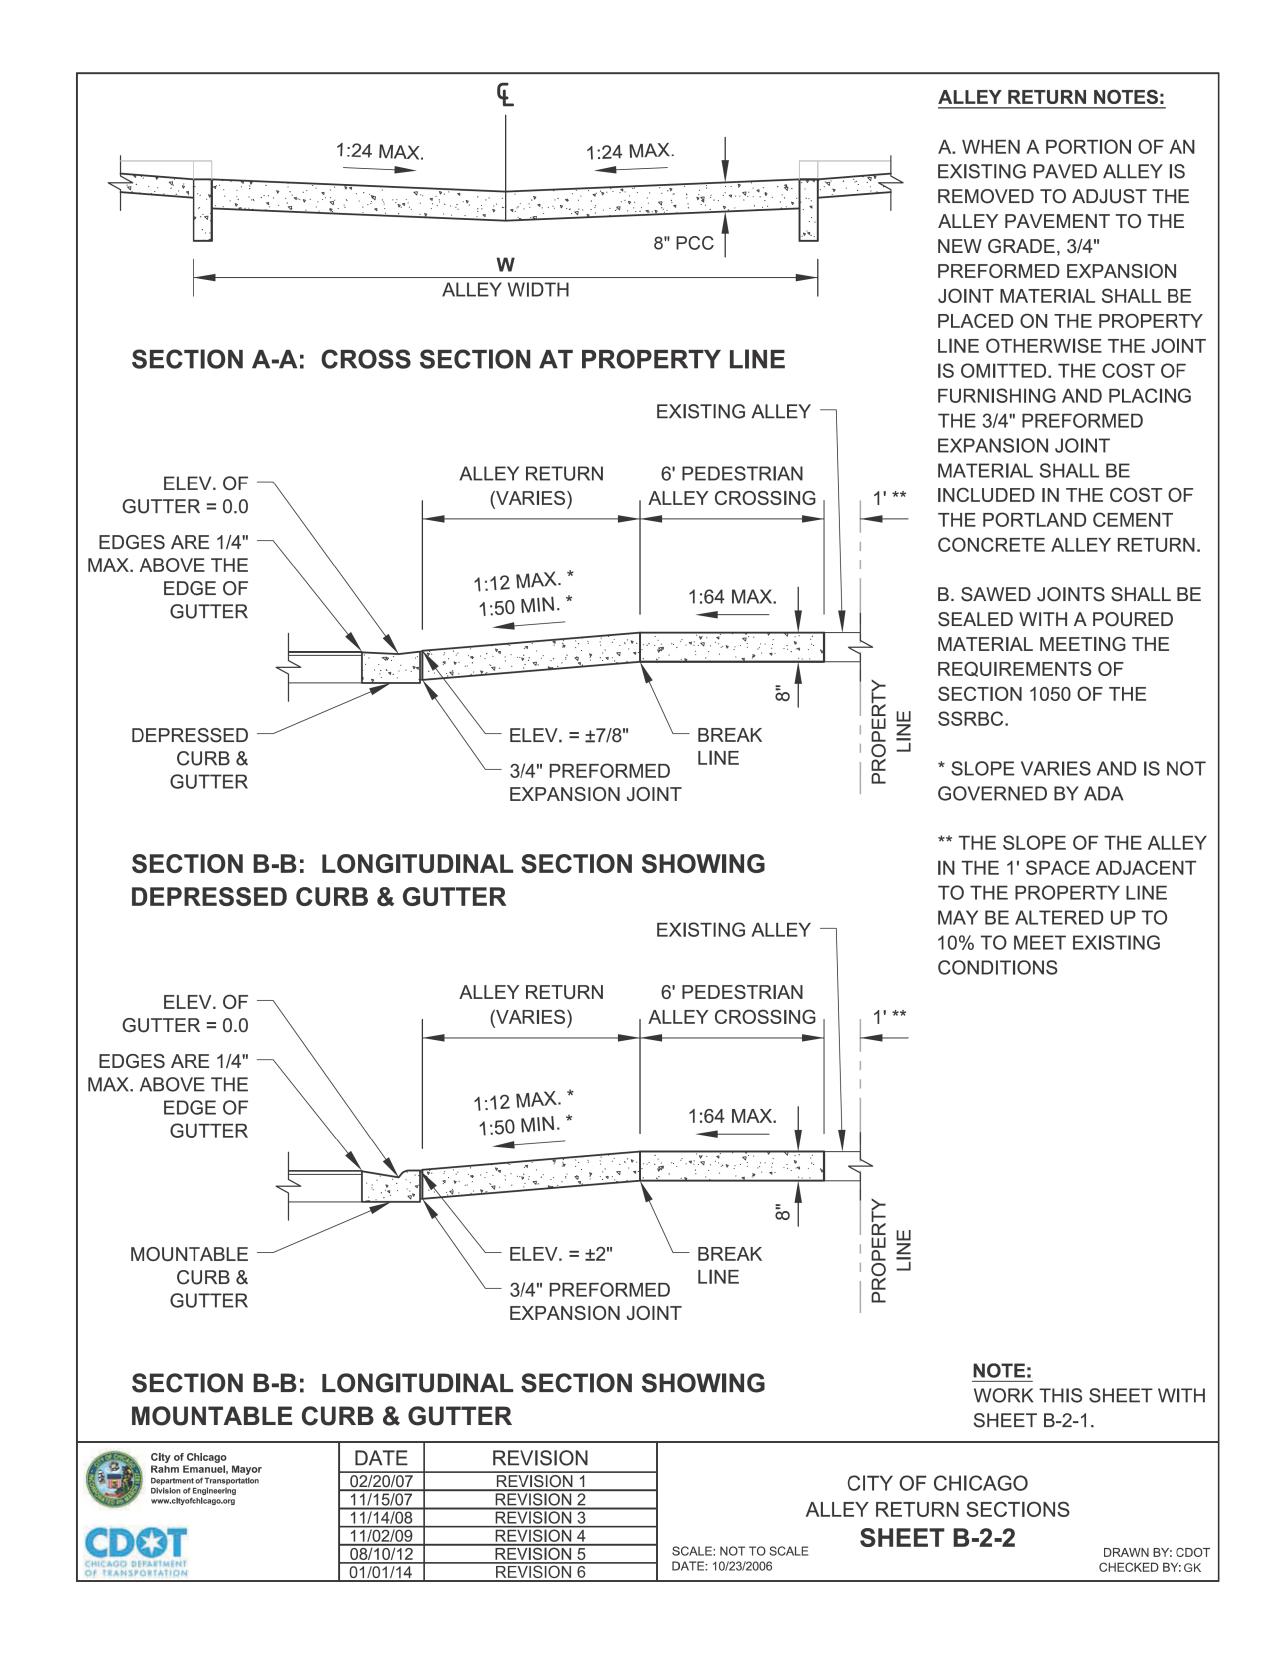



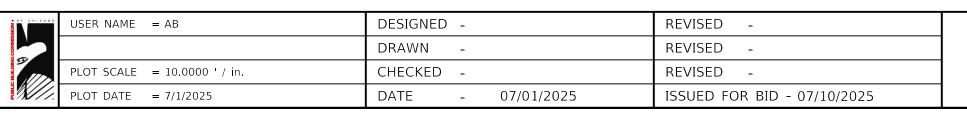

**REVISION 6** 


01/01/14


DATE: 10/23/2006

CHECKED BY: GK


TOTAL SHEET NO.

25 14

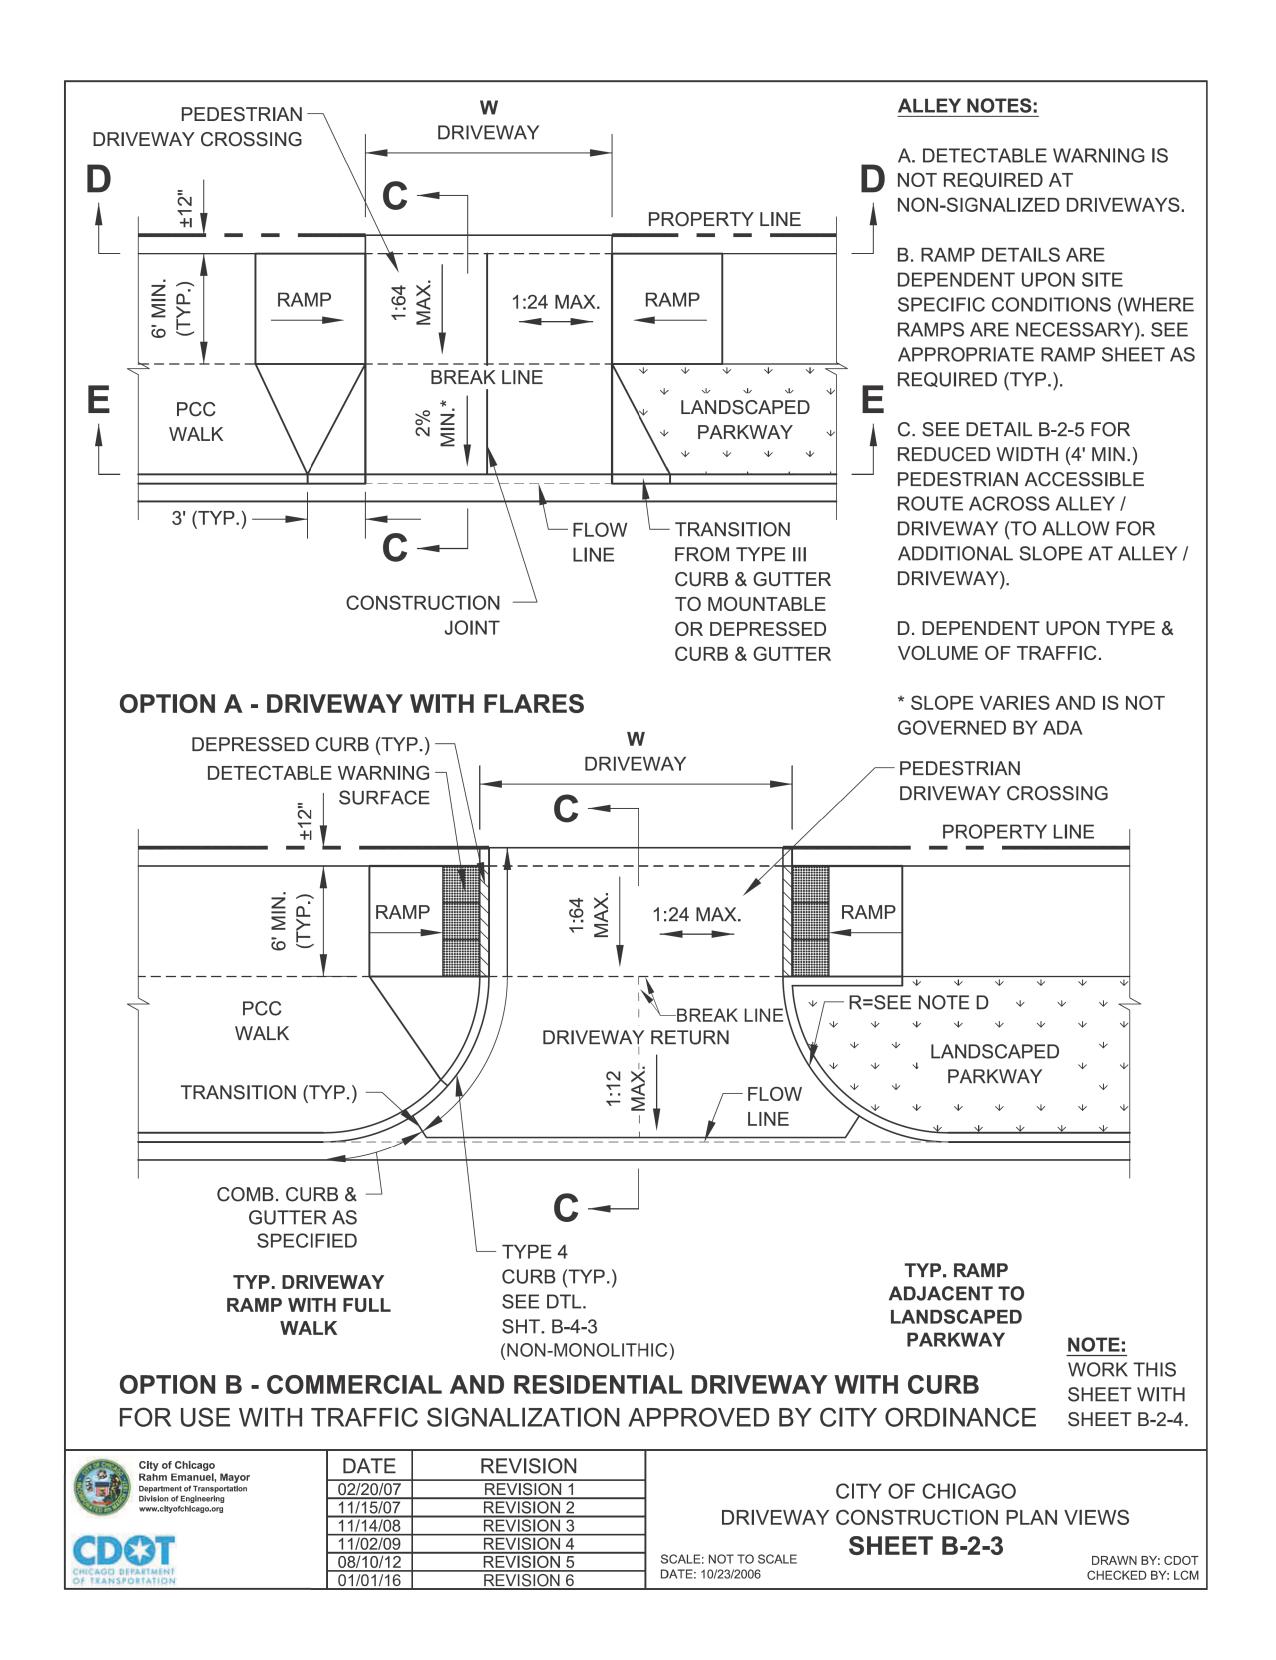

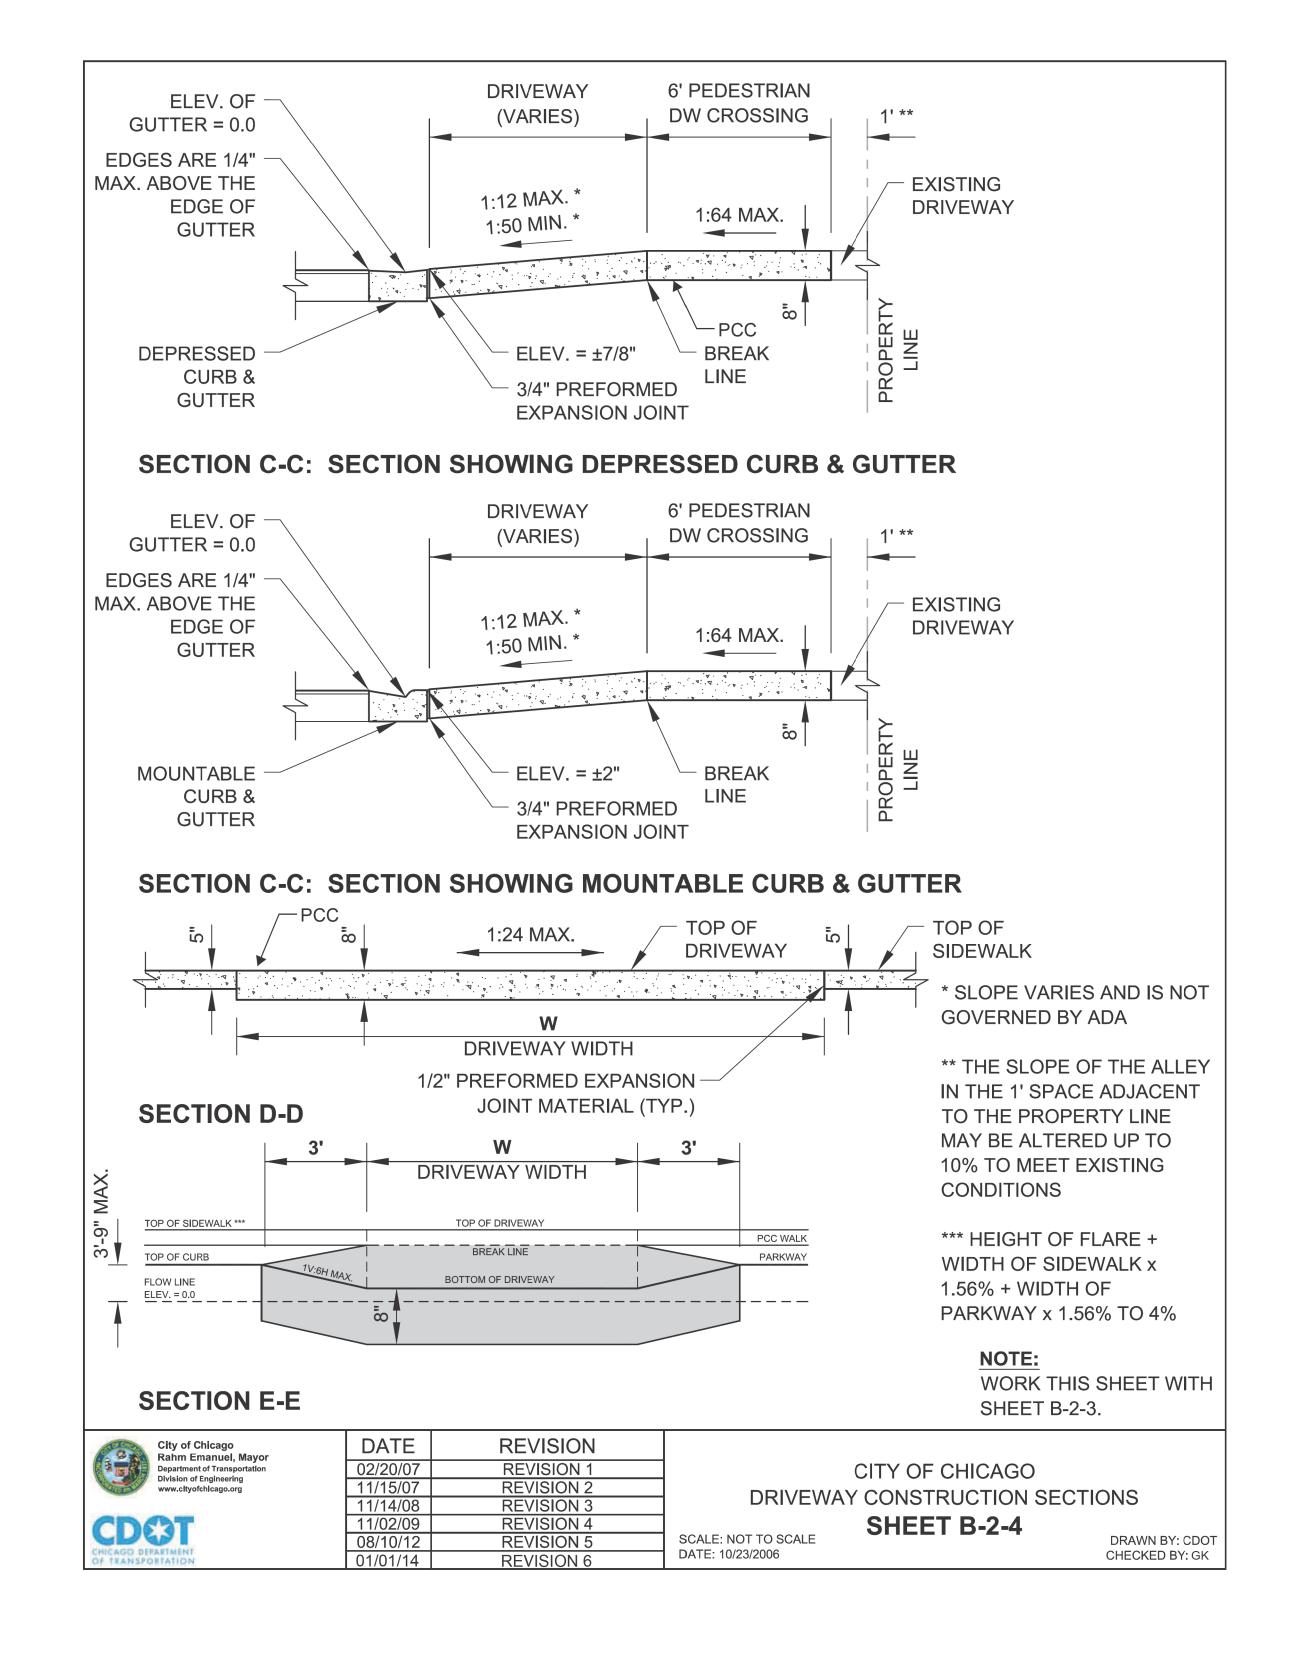



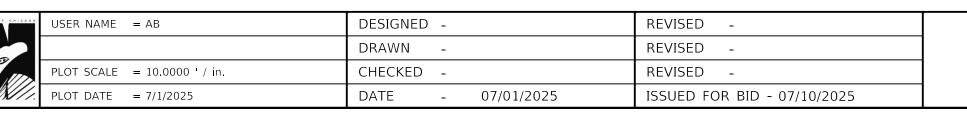

POLICY STATEMENT: ANY ALTERATION OF THE PUBLIC WAY MUST BE RESTORED IN AN ADA COMPLIANT MANNER

#### I. STREET/ALLEY RESTORATION

FOR ANY PROJECT WHERE, WITHIN THE PROJECT LIMITS, A CROSSWALK IS ENCOUNTERED OR WHERE THE PROJECT LIMITS TERMINATE WITHIN 4' OR LESS OF A CROSSWALK, THOSE CROSSWALKS AND THE ASSOCIATED CURB RAMPS MUST BE IMPROVED TO CURRENT ADA STANDARDS IF THEY ARE NOT COMPLIANT (SEE APPENDIX A.)

WHEN A PROJECT CALLS FOR ONLY AN INTERSECTION TO BE REPAVED, THE INTERSECTION LIMITS AS DEFINED BY THE AREA OUTLINED BY OUTERMOST CROSSWALK LINES AND ADJACENT CURB FACES AND ALL ADJOINING CROSSWALKS AND CURB RAMPS MUST BE IMPROVED TO CURRENT ADA STANDARDS IF THEY ARE NOT COMPLIANT (SEE APPENDIX A).

WHEN WORK IS LIMITED TO A SINGLE CORNER OF AN INTERSECTION. THE CURB RAMP MUST BE IMPROVED TO CURRENT ADA STANDARDS AND THE ADJACENT PAVEMENT MUST BE RESURFACED, AS NECESSARY TO PROVIDE FOR A FLUSH TRANSITION (SEE APPENDIX A).

WHEN ADA WORK IS LIMITED TO A SINGLE CORNER OF AN INTERSECTION, THE ADJACENT PAVEMENT MUST BE RESTORED (SEE APPENDIX A).

FOR ANY CONSTRUCTION WHERE, WITHIN THE PROJECT LIMITS, AN ALLEY APRON IS ENCOUNTERED, THE ASSOCIATED CURB RAMPS, ALLEY APRON, AND SIDEWALKS MUST BE IMPROVED TO CURRENT ADA STANDARDS IF THEY ARE NOT COMPLIANT (SEE APPENDIX A).

#### II. SIDEWALK INSTALLATION / REPAIRS / RECONSTRUCTION

THE LIMITS OF ANY MAINLINE SIDEWALK REPLACEMENT, GREATER THAN TEN FEET (10') IN LENGTH, THAT ABUT AN EXISTING RAMP, KEYSTONE, TRANSITION PANEL, AND/OR LANDING AREA (THIS TOTAL LENGTH INCLUDES THE PRIOR ELEMENTS), SHALL BE EXTENDED TO INCLUDE THE AFFECTED RAMPS AND THESE RAMPS SHALL BE RECONSTRUCTED TO CURRENT ADA STANDARDS. IN ADDITION, ALL NEWLY PLACED SIDEWALK TEN FEET (10') OR MORE IN LENGTH SHALL BE CONSTRUCTED IN ACCORDANCE WITH ALL CURRENT APPLICABLE STANDARDS WHICH INCLUDE PROVIDING A MINIMUM FOUR FEET (4') WIDTH ACCESSIBLE PATHWAY WITH A CROSS SLOPE NOT TO EXCEED 1:64 (SEE APPENDIX A).

#### III. GUIDELINES FOR TRANSITIONING TO EXISTING NON-COMPLIANT CONDITION

#### NEW SIDEWALK PLACEMENTS GREATER THAN TEN FEET IN CONTIGUOUS LENGTH:

THE LIMITS OF ANY MAINLINE SIDEWALK REPLACEMENT, GREATER THAN TEN FEET (10') IN LENGTH, MUST BE EXTENDED FOR A MINIMUM FIVE ADDITIONAL FEET (5') EITHER SIDE IN ORDER TO PROVIDE A TRANSITION TO MATCH THE EXISTING SIDEWALK. THE LENGTH OF TRANSITION SHALL BE LENGTHENED AS NECESSARY TO ENSURE THAT THE RUNNING SLOPE OF THE TRANSITION DOES NOT EXCEED A SLOPE OF 1:24 (PREFERRED) OR 1:14 (MAXIMUM) AT ANY POINT.

NEW SIDEWALK REPLACEMENTS TEN FEET OR LESS IN CONTIGUOUS LENGTH (REPAIRS):

IT IS ACCEPTABLE PRACTICE TO MATCH ADJACENT SIDEWALKS AT THE EXISTING SLOPE.

#### CURB RAMP REPLACEMENTS

WHEN REPLACING AN ADA RAMP, THE SIDEWALK REPLACEMENT MUST EXTEND BEYOND THE LIMITS OF THE LANDING AREA AND/OR THE "KEYSTONE" A MINIMUM OF AN ADDITIONAL FIVE FEET (5') ON EITHER SIDE IN ORDER TO PROVIDE A TRANSITION TO MATCH THE EXISTING SIDEWALK. THE TRANSITION PANEL SHALL BE LENGTHENED AS NECESSARY TO ENSURE THAT THE RUNNING SLOPE OF THE TRANSITION PANEL DOES NOT EXCEED A SLOPE OF 1:24 (PREFERRED) OR 1:14 (MAXIMUM) AT ANY POINT.

DATE: 10/23/2006

NO EXCEPTIONS TO THE ABOVE WILL BE ALLOWED WITHOUT WRITTEN APPROVAL FROM THE COMMISSIONER.

City of Chicago Rahm Emanuel, Mayor Department of Transportation


CDOT

DATE REVISION 02/20/07 **REVISION 1** 11/15/07 **REVISION 2** 11/14/08 **REVISION 3** 11/02/09 **REVISION 4** 08/10/12 **REVISION 5 REVISION 6** 01/01/14


CITY OF CHICAGO ADA COMPLIANCE AND TRANSITION GUIDELINES

**SHEET B-3-4** SCALE: NOT TO SCALE


DRAWN BY: CDOT CHECKED BY: GK

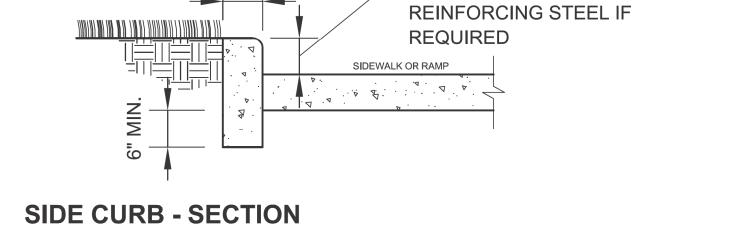

VARIABLE - 3" MIN. - PROVIDE

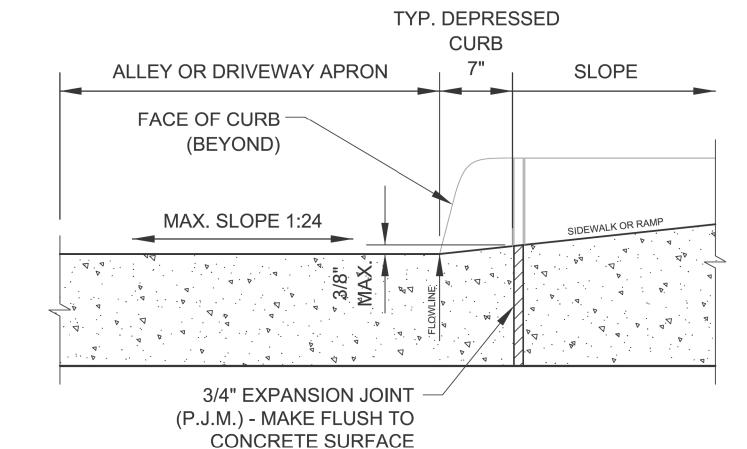

#### **DEPRESSED CURB & GUTTER** AT ALLEY/DRIVEWAY APRON (TYPE 4 OR B CURB)

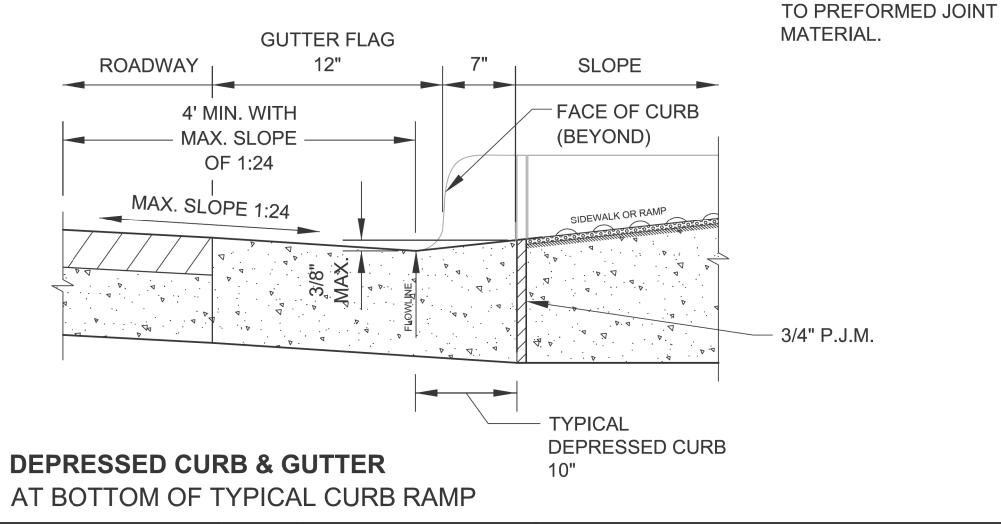

SCALE: NOT TO SCALE

DATE: 10/23/2006



DATE	REVISION
02/20/07	REVISION 1
11/15/07	REVISION 2
11/14/08	REVISION 3
11/02/09	REVISION 4
08/10/12	REVISION 5

CITY OF CHICAGO **CURB & GUTTER DETAILS** 

**NOTES FOR CURB & GUTTER** 

DEPRESSED CURB & GUTTER

B. DETECTABLE WARNING

SURFACE AT DRIVEWAYS

DRIVEWAYS WITH TRAFFIC

C. REFER TO REGULATIONS

CONSTRUCTION AND REPAIR IN

THE PUBLIC WAY (CDOT) FOR

ADDITIONAL REQUIREMENTS

D. RAMP SIDE FLARES SHALL

SURFACE ADJACENT TO THE

RAMP SURFACE IS INTENDED

TRIPPING HAZARDS, INCLUDING

**CURBS SHALL NOT BE LOCATED** 

E. 'P.J.M.' THIS SHEET REFERS

STEPS, DROP-OFFS, OR SIDE

WITHIN THE LIMITS OF THE

FOR CURB AND GUTTER

BE INSTALLED AT ANY

LOCATION WHERE THE

FOR PEDESTRIAN USE.

REQUIRED ONLY FOR

DEVICES, I.E. SIGNALS.

COMMERCIAL

FOR OPENINGS,

INSTALLATION.

SIDEWALK.

CONTROL

**DETAILS THIS SHEET:** 

A. CROSS SLOPE AT

NOT TO EXCEED 1:64

**SHEET B-4-3** 

DRAWN BY: CDOT CHECKED BY: LCM

DESIGNED REVISED USER NAME = AB DRAWN REVISED CHECKED REVISED PLOT SCALE = 10.0000 ' / in. PLOT DATE = 7/1/2025DATE 07/01/2025 ISSUED FOR BID - 07/10/2025


CITY OF CHICAGO DEPARTMENT OF TRANSPORTATION 40th WARD

CDOT STANDARD CONSTRUCTION DETAILS PBC PROJECT NO # 22925 W. ARGYLE STREET - W. AINSLIE STREET N. HOYNE AVENUE - N. SEELEY AVENUE

	OUC NUMBER	COUNTY	TOTAL SHEETS	SHEE NO.	
	OUC IR #122194	COOK	25	16	
STA.	TO STA.	SCALE:			

- 1. ALL DIMENSIONS ARE BASED ON UNILOCK DATA. CONTRACTOR IS TO FIELD VERIFY DIMENSIONS AND TEST LAYOUT PRIOR TO COLLAR CONSTRUCTION.
- \* INDIVIDUAL PREFABRICATED "L" SHAPED UNILOCK PAVER.
- 2. GEOTEXTILE FABRIC SHOULD BE A WOVEN MATERIAL. ALL CA-1 AND CM-7 MATERIALS SHOULD BE WASHED AND FREE OF FINES TO PRESERVE INFILTRATION CAPACITY.
- 3. MAXIMUM GAP SIZE BETWEEN BRICK PAVER AND 8" PCC COLLAR IS 1/2".
- 4. STANDARD IS TO BE USED FOR 16' ROW, IN CASES WHERE ROW IS NOT 16', WIDTH OF PAVERS IS TO THE DISRECTION OF THE ENGINEER.
- \*\* POLYETHYLENE WATERPROOFING LINER IS REQUIRED WHEN PAVER SECTION OF ALLEY IS ADJACENT TO BUILDING FOUNDATION.
- 5. LENGTH OF PERVIOUS SECTION TO BE DETERMINED BY STORM WATER BULLETIN 75 5 YEAR RAINFALL DATA.
- 6. CALCULATIONS FOR STORMWATER STORAGE REQUIREMENTS BASED ON 2016 STORMWATER REGULATIONS.

	DATE	REVISION	Cl	TY OF CHICA	AGO
CDC3T			STANDAE	RD PAVER ALL	EV SECTION
			STANDAR	ND PAVER ALL	ET SECTION
CHICAGO DEPARTMENT OF TRANSPORTATION			DATE	SHEET	DRAWN BY
			7/11/24	A-1-2-e	CDOT

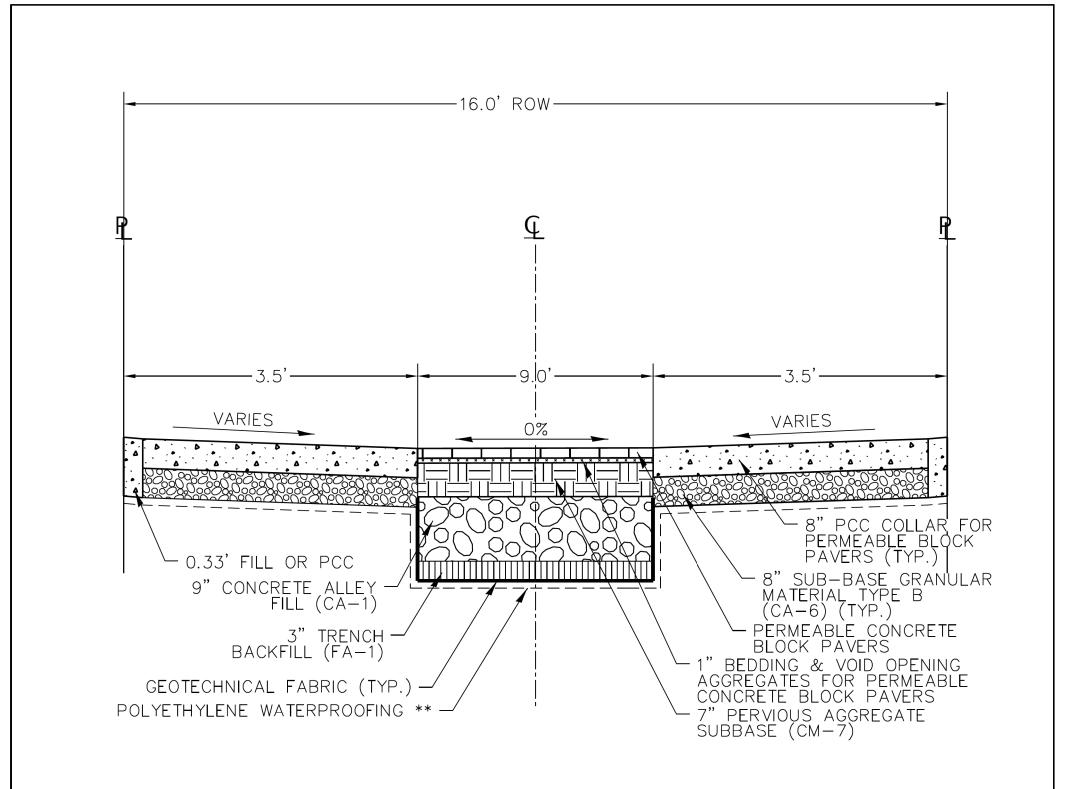


### PAVER DETAIL TYPICAL CROSS SECTION

#### NOTE:


- 1. ALL DIMENSIONS ARE BASED ON UNILOCK DATA. CONTRACTOR IS TO FIELD VERIFY DIMENSIONS AND TEST LAYOUT PRIOR TO COLLAR CONSTRUCTION.
- \* INDIVIDUAL PREFABRICATED "L" SHAPED UNILOCK PAVER.
- 2. GEOTEXTILE FABRIC SHOULD BE A WOVEN MATERIAL. ALL CA-1 AND CM-7 MATERIALS SHOULD BE WASHED AND FREE OF FINES TO PRESERVE INFILTRATION CAPACITY.
- 3. MAXIMUM GAP SIZE BETWEEN BRICK PAVER AND 8" PCC COLLAR IS ½".
- 4. STANDARD IS TO BE USED FOR 16' ROW, IN CASES WHERE ROW IS NOT 16', WIDTH OF PAVERS IS TO THE DISRECTION OF THE ENGINEER.
- \*\* POLYETHYLENE WATERPROOFING LINER IS REQUIRED WHEN PAVER SECTION OF ALLEY IS ADJACENT TO BUILDING FOUNDATION.
- 5. LENGTH OF PERVIOUS SECTION TO BE DETERMINED BY STORM WATER BULLETIN 75 5 YEAR RAINFALL DATA.
- 6. CALCULATIONS FOR STORMWATER STORAGE REQUIREMENTS BASED ON 2016 STORMWATER REGULATIONS.

	DATE	REVISION	CI <sup>-</sup>	TY OF CHICA	AGO
CDS3T			STANDAR	RD PAVER ALL	EV SECTION
			STANDAI	VOI AVEIVALL	LI SECTION
CHICAGO DEPARTMENT OF TRANSPORTATION			DATE	SHEET	DRAWN BY
			7/11/24	A-1-2-f	CDOT



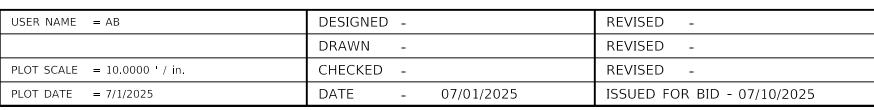

	OUC NUMBER	COUNTY	TOTAL SHEETS	SHEET NO.
	OUC IR #122194	COOK	25	17
STA.	TO STA.	SCALE:		

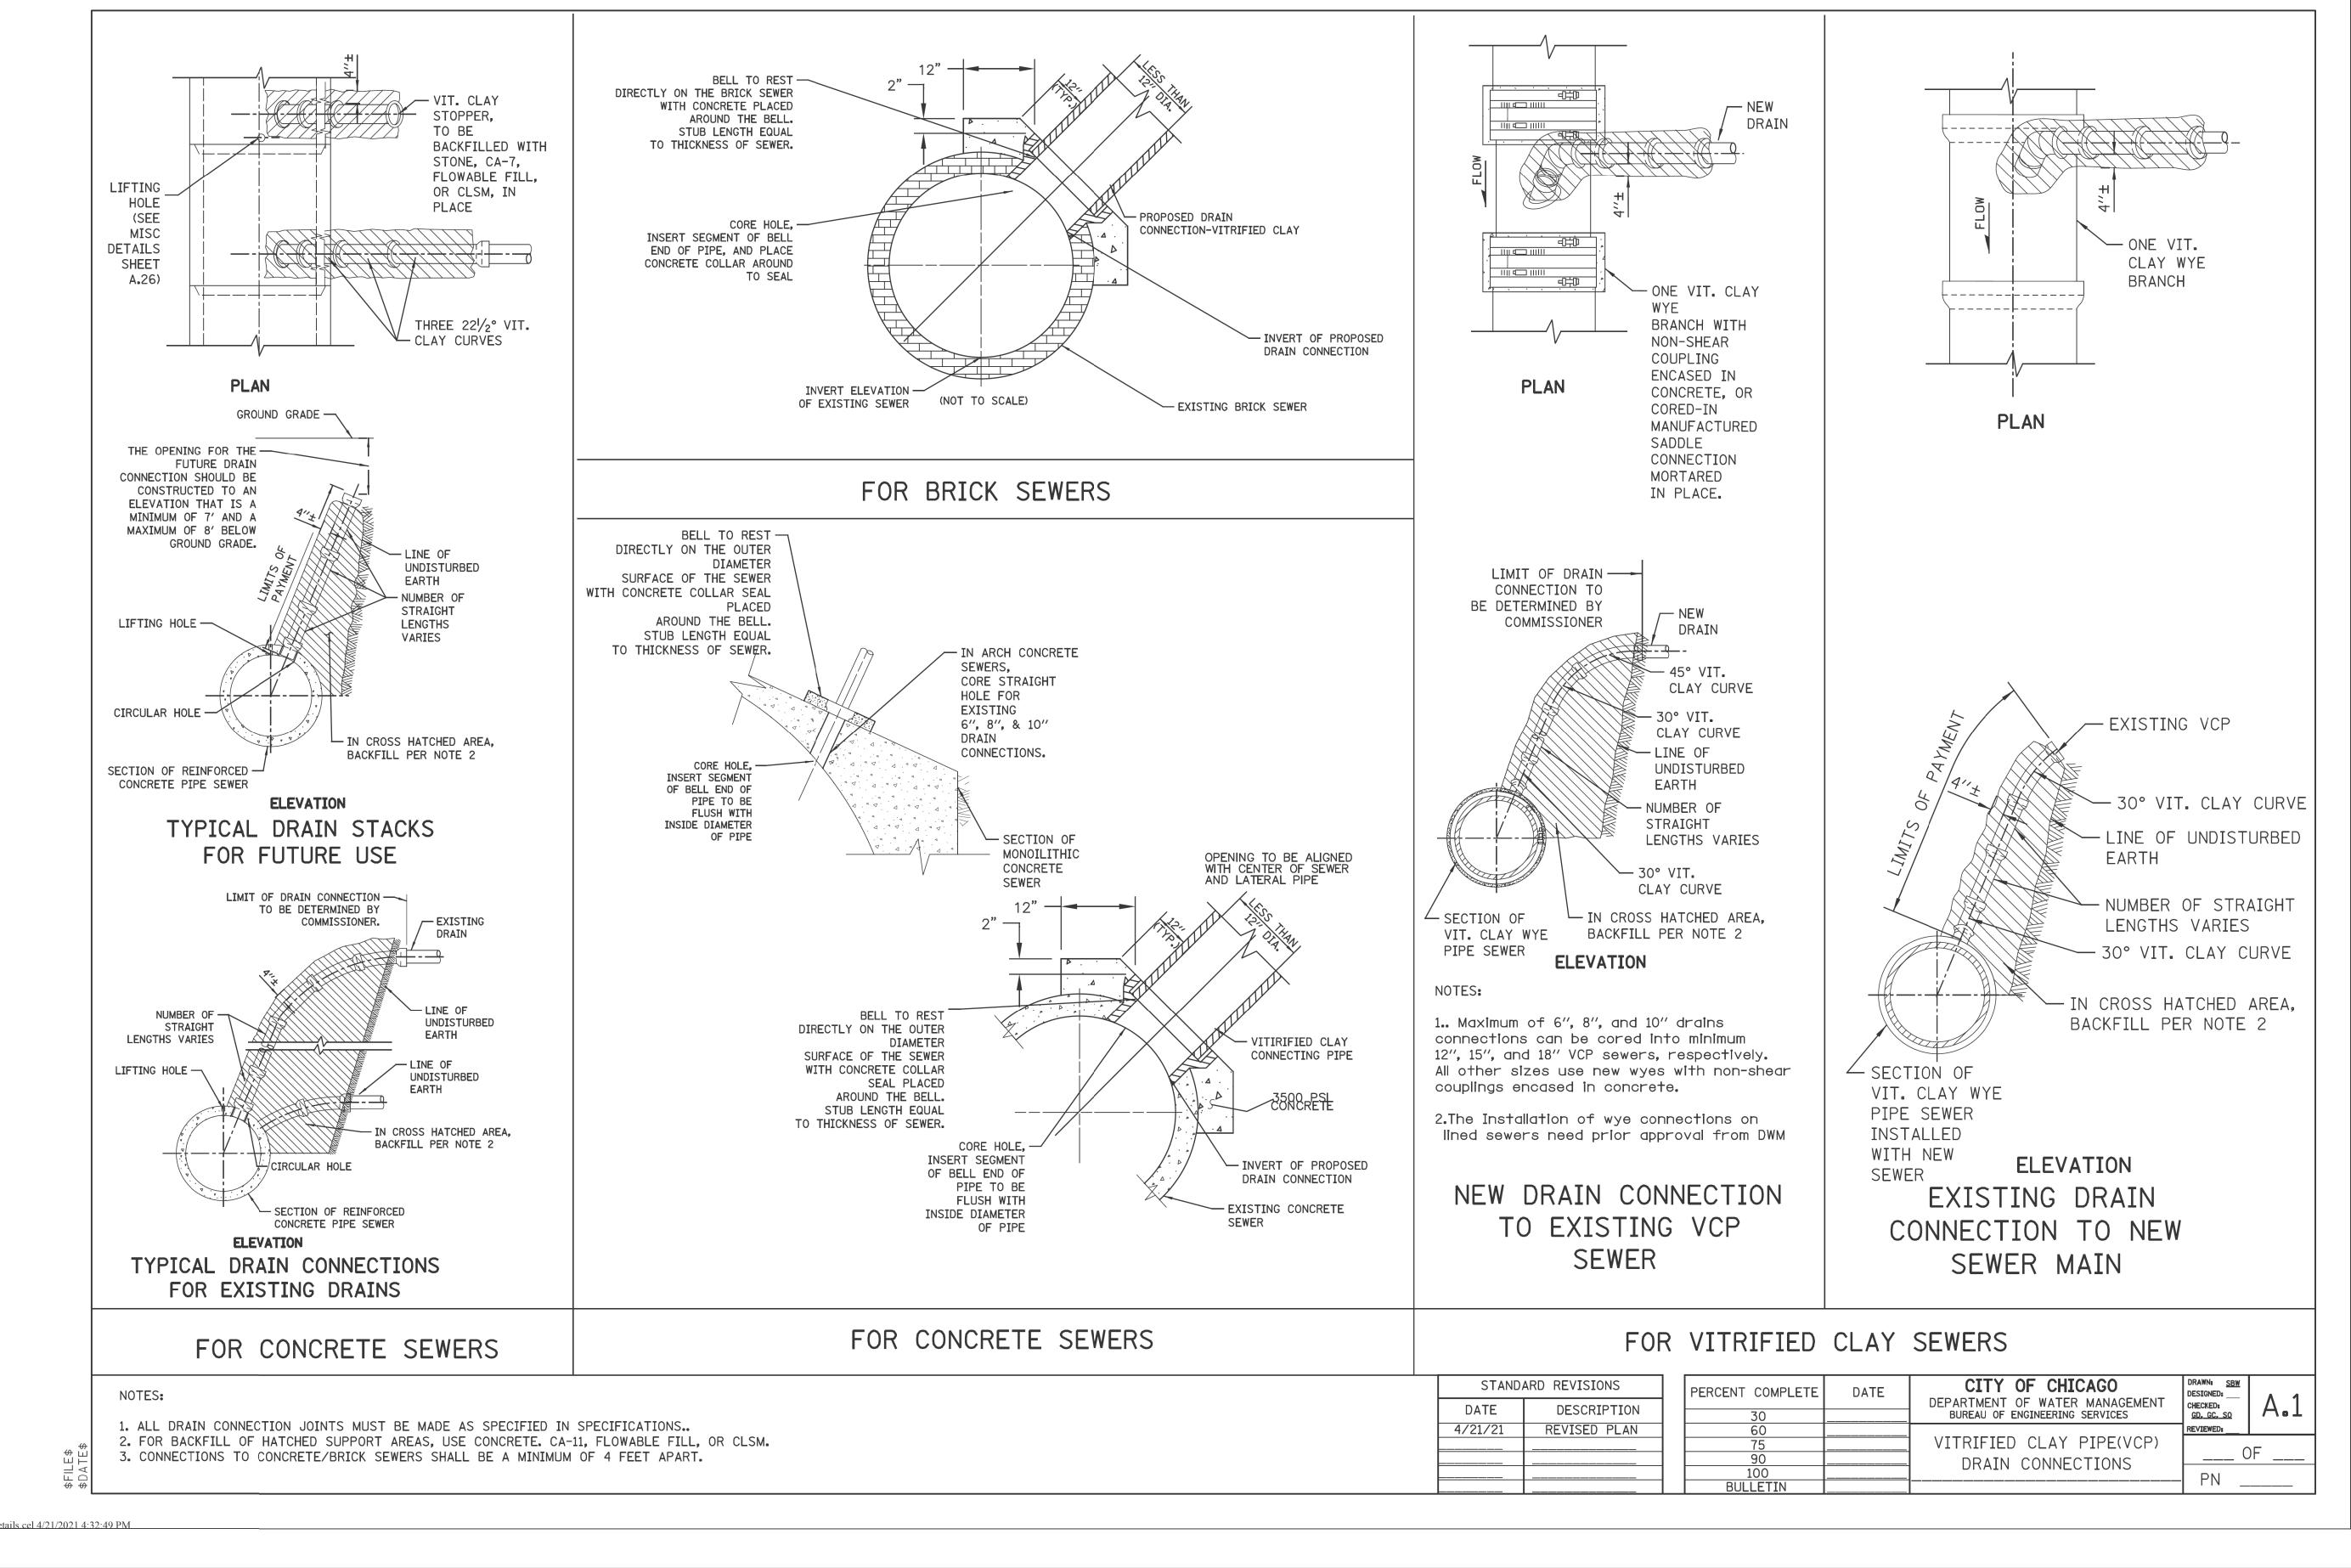

\*CDOT

 USER NAME
 = AB
 DESIGNED
 REVISED

 PLOT SCALE
 = 10.0000 ' / in.
 CHECKED
 REVISED


 PLOT DATE
 = 7/1/2025
 DATE
 07/01/2025
 ISSUED FOR BID - 07/10/2025

CITY OF CHICAGO
DEPARTMENT OF TRANSPORTATION
40th WARD

CDWM STANDARD CONSTRUCTION DETAILS
PBC PROJECT NO # 22925


W. ARGYLE STREET - W. AINSLIE STREET
N. HOYNE AVENUE - N. SEELEY AVENUE

	OUC NUMBER	COUNTY	TOTAL SHEETS	SHEET NO.
	OUC IR #122194	COOK	25	18
STA.	TO STA.	SCALE:		

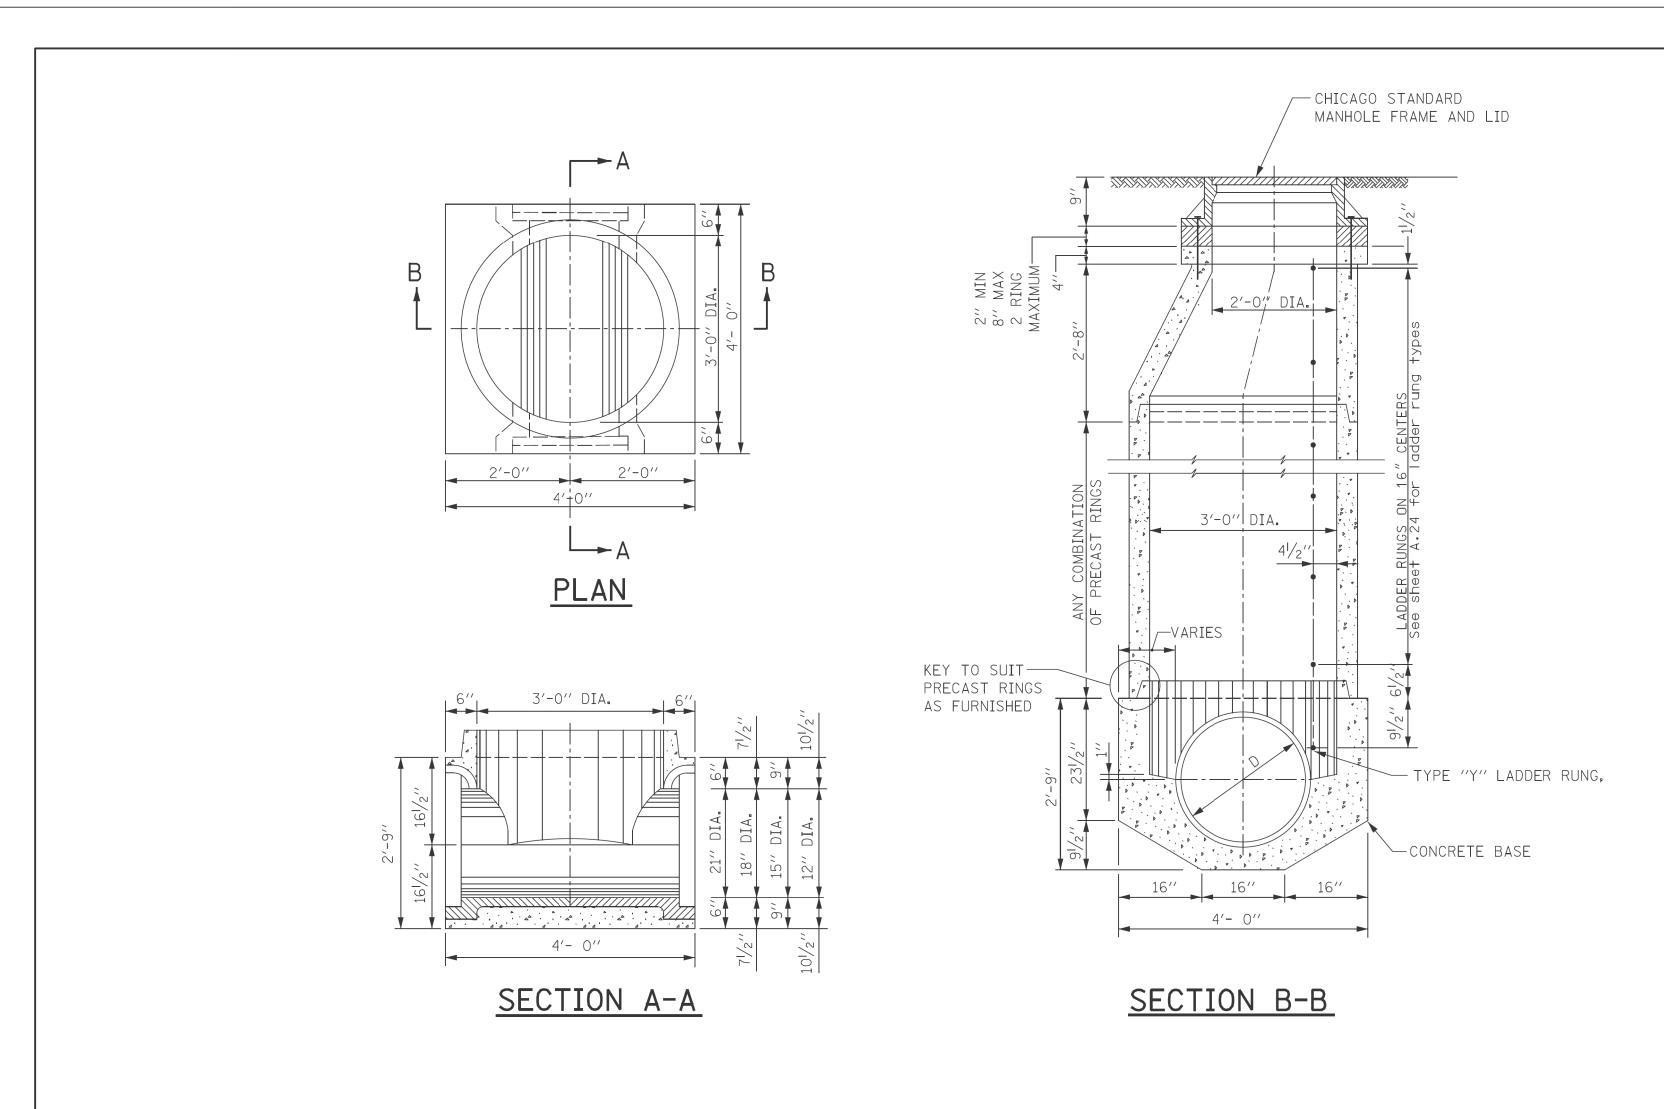

3", 6", 5-A3 @ 6", 6", 3"	2-A4 @ 3" 2-A2 @ 3" 2-A2 @ 3" 2-A4	3"
	PI AN	

# <u>PLAN</u> <u>PRECAST BASE</u>

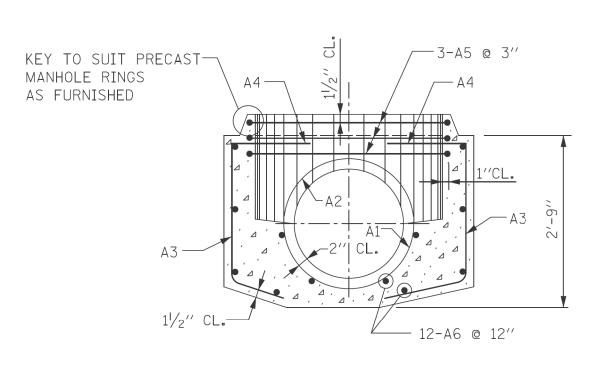

#### SECTION C-C

NOTE: 6" MINIMUM GRANULAR EMBEDMENT UNDER ALL PRECAST MANHOLE BASES

						SC	CHED	ULE	OF	REI	VFOF	RCEM	ENT						
	STUPE	F	REIN	FORCEN	1ENT	BAR					В	ENDING	DIMEN	NSIONS					
STRI		MARK SIZE	TYPE		NO. REQD.	WEIGH <sup>-</sup> EACH	TOTAL	А	В	С	D	E	F	G	Н	J	K	0	R
		21A1 6 21A2 6	9 T3	3'-1'' 8'-8''	6	4.63 13.02	28 52		3′-1′′						111/4''		2'-0''	2'-1''	123/4′′
ST)	DIA.	21A3 5 21A4 5	12	3'-3'' 4'-6''	10	3.39 4.69	34 38		15′′	22'' 22''	17'' 17''				14 1/2"		8 <sup>3</sup> / <sub>4</sub> ''		
CA	21′′	21A5 5	T3	11'-11''	3	12.43	37		15		<u> </u>				14/2		20"	3'-31/4''	
(PRE		21A6 4 TOTAL	STR	3′-8′′	12	2.45	30 219												
ES E	\d_	18A1 6 18A2 6	9 T3	$2'-8\frac{1}{2'}$	6	4.07 11.83	24 47		2'-81/2''							93/4′′	2'-0''	22" 22 / 2"	11 1/4"
	DIA.	18A3 5 18A4 5	12 12	3'-3'' 4'-6''	10	3.39 4.69	34 38		15′′	22'' 22''	17'' 17''					$\frac{14\frac{1}{2}''}{14\frac{1}{2}''}$	8 <sup>3</sup> / <sub>4</sub> ''		
MANHOL	18′′	18A5 5 18A6 4	T3 STR	11'-11'' 3-8''	3 12	12.43 2.45	37 30										2'-0''	3'-31/4''	
		TOTAL					202		071/1/						01///			10//	03/1/
, A ,	DIA.	15A1 6 15A2 6	9 <b>T</b> 3	2'-3 <sup>1</sup> / <sub>2</sub> '' 7'-1''	4	3.44 10.64	21 42		231/2"						81/4′′		2'-0''	19'' 19 <sup>1</sup> / <sub>2</sub> ''	93/4′′
		15A3 5 15A4 5	12 12	3'-3'' 4'-6''	10	3.39 4.69	34 38		15′′	22'' 22''	17'' 17''				14/2"		8 <sup>3</sup> / <sub>4</sub> ''		
<u></u>	15′′	15A5 5 15A6 4	T3 STR	11'-11'' 3'-8''	3 12	12.43	37 30								14/2"		20′′	3'-33/4''	
FOR		TOTAL 12A1 6	9	1'-11''	6	2.88	202 17		23''						63/4′′			16′′	81/4′′
S	DIA.	12A2 6	T3	6'-1''	4	9.14	37		23	22//	17//				141/2"		2'-0''	16 1/2"	
ASE		12A3 5 12A4 5	12 12	3'-3'' 4'-6''	10	3.39 4.69	34			22'' 22''	17'' 17''				$14\frac{7}{2}$		83/4′′		
m	12′′	12A5 5 12A6 4	T3 STR.	11'-11'' 3'-8''	3 12	12.43 2.45	37 30										20′′	3'-31/4''	
		TOTAL					193												

PERCENT COMPLETE	STANDARD REVISIONS						
30	DESCRIPTION	DATE					
60	REVISION	9/5/17					
75							
90							
100							

DATE	CITY OF CHICAGO  DEPARTMENT OF WATER MANAGEMENT BUREAU OF ENGINEERING SERVICES	DRAWN: SBW DESIGNED: CHECKED:	A.6
		REVIEWED:	
			\_
	MANHOLE FOR SEWERS		)F
	21" DIA. AND SMALLER	DNI	
	DATE	DEPARTMENT OF WATER MANAGEMENT BUREAU OF ENGINEERING SERVICES  TYPE "A" PRECAST MANHOLE FOR SEWERS	DEPARTMENT OF WATER MANAGEMENT BUREAU OF ENGINEERING SERVICES  TYPE "A" PRECAST MANHOLE FOR SEWERS  DESIGNED: CHECKED: C


CDWM\_Details.cel 6/25/2020 9:22:16 AM




OF CHICAGO	USER NAME
GCOMMIS	
MITTON OF THE PROPERTY OF THE	PLOT SCALE
	PLOT DATE

1 C A G O	USER NAME = AB	DESIGNED -	REVISED -
		DRAWN -	REVISED -
	PLOT SCALE = 10.0000 ' / in.	CHECKED -	REVISED -
//.	PLOT DATE = 7/1/2025	DATE - 07/01/2025	ISSUED FOR BID - 07/10/2025

	OUC NUMBER	COUNTY	TOTAL SHEETS	SHEET NO.
	OUC IR #122194	COOK	25	19
STA.	TO STA.	SCALE:		

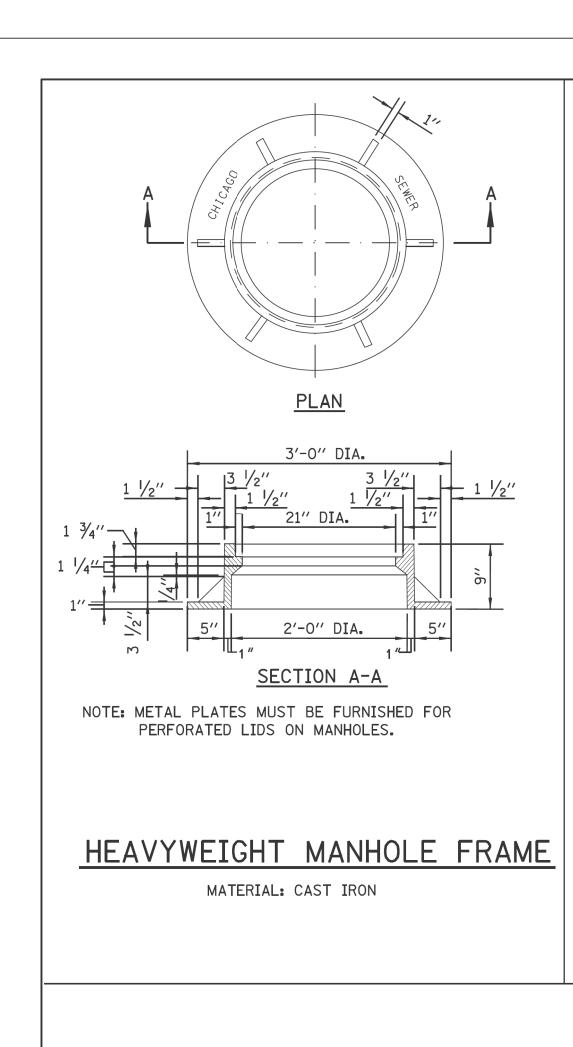

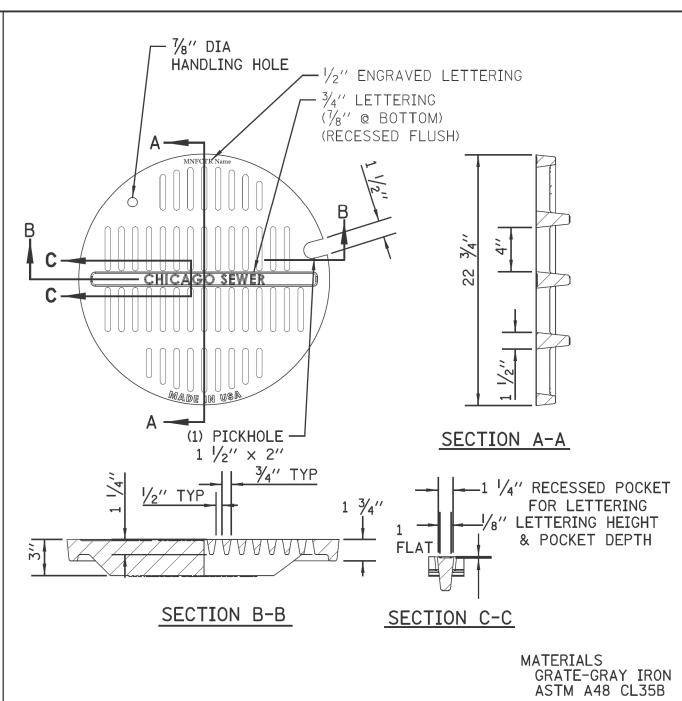

STANDARD CB/MH LID

A 5/8" TIE BARS 1" SMOOTH DOWEL BARS 3/4" PREFORMED EXP.\_ JOINT FILLER -NEW CONCRETE BASE (HIGH EARLY) TYPE B.V-12/TYPE 3\_ CURB AND GUTTER SECTION A-A NOTES:

- HOT POURED JOINT SEALER PROPOSED SURFACE COURSE -SAW CUT 1/2"ROUND TIE BARS, 24"LONG,30"APART TOP OF EXISTING MASONRY UTILITY STRUCTURE 4/2"ROUND TIE BARS,24"LONG,30"APART SEE CONSTRUCTION DETAILS (FOR MISCELLANEOUS STRUCTURES) X = THICKNESS OF PAVEMENT
Y = ONE HALF THE THICKNESS OF CONCRETE PAVEMENT OR
CONCRETE BASE. Z = 10" OR THICKNESS OF PROPOSED PAVEMENT - WHICHEVER IS GREATER

IF THE ADJUSTMENT EXCEEDS AN 8" HEIGHT, THE CONE MUST BE REMOVED AND THE BARREL SECTION MUST BE ADJUSTED.

THE CONTRACTOR IS REQUIRED TO REPLACE ANY BROKEN FRAMES AND LIDS OF SEWER STRUCTURES WITH STANDARD FRAMES AND LIDS OF THE DWM. IN ADJUSTMENT OR RECONSTRUCTION OF SEWER STRUCTURES, ANY NON-STANDARD FRAMES AND LIDS MUST BE REPLACED WITH STANDARD FRAMES AND LIDS. IN ADJUSTMENT OR RECONSTRUCTION OF INLETS, ANY NON-STANDARD INLETS (GUTTER BOXES) MUST BE REPLACED WITH DWM STANDARD INLETS.

THE FRAMES AND LIDS OF SEWER STRUCTURES TO BE ABANDONED, REMOVED, OR FILLED MUST BE SALVAGED AND THE DWM NOTIFIED FOR PICK UP.

MANHOLES, CATCH BASINS AND INLETS MUST BE PROTECTED FROM THE ENTRY OF ASPHALT/DEBRIS INTO THE SEWER SYSTEM DURING CONSTRUCTION. THE CONTRACTOR MUST MARK LOCATIONS OF ALL SEWER STRUCTURES ON THE SIDEWALK BEFORE STARTING PAVEMENT REMOVAL/REPLACEMENT. ADJUSTMENT OF FRAMES AND LIDS OF SEWER STRUCTURES MUST BE COMPLETED PRIOR TO STREET RESURFACING.


PLAN VIEW (BASE TO GRADE)


\*REFER TO CDOT FOR ASPHALT RESTORATION REQUIREMENTS & CRACK SEALING.

CDOT REQUIREMENTS.

\*\* ON NON-MORATORIUM STREETS, FULL-DEPTH PCC BASE COURSE MAY BE UTILIZED. ON MORATORIUM STREETS, PAVEMENT RESTORATION SHALL ADHERE T

DETAIL OF FRAME ADJUSTMENT

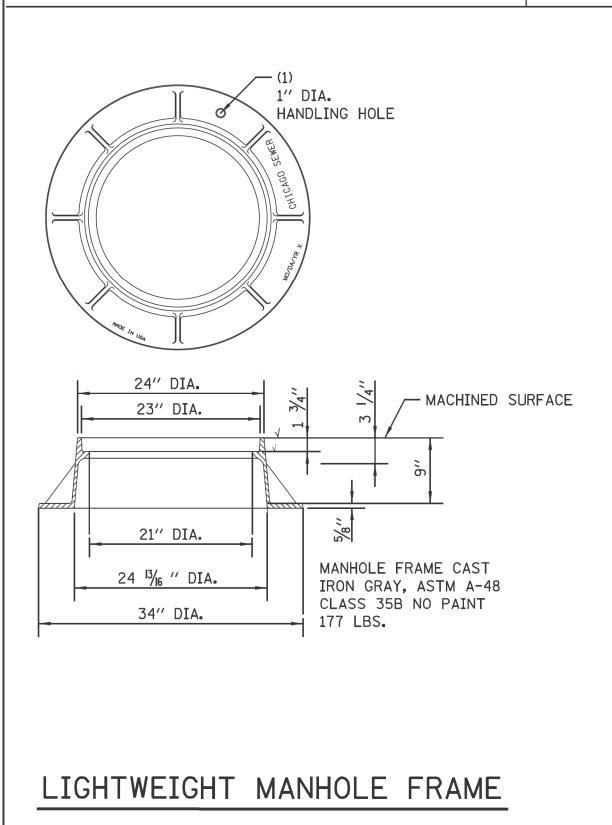

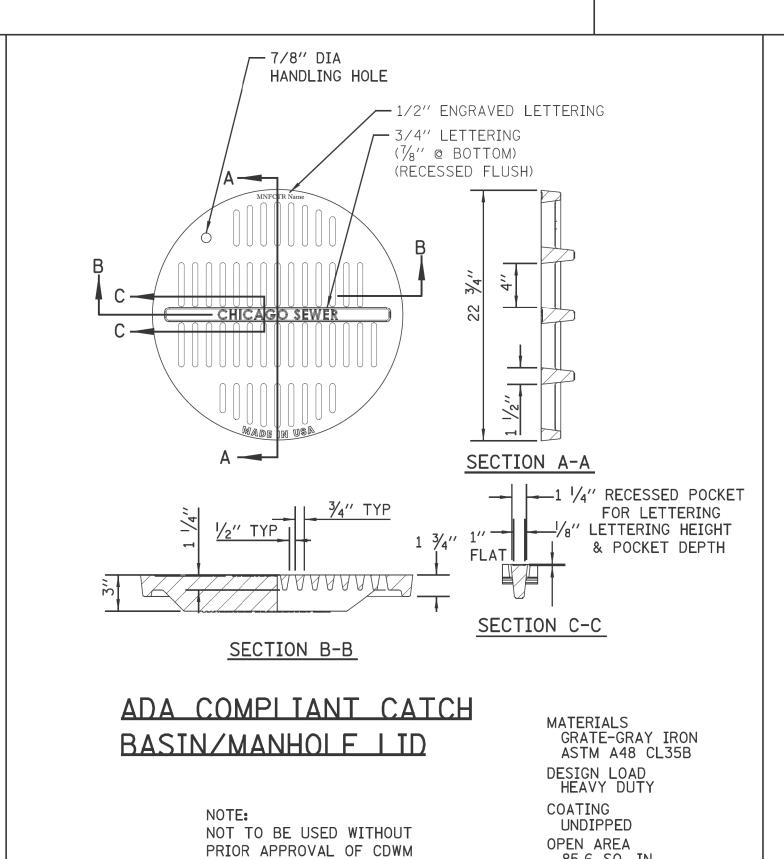


DESIGN LOAD HEAVY DUTY

UNDIPPED

OPEN AREA 85.6 SQ. IN.

COATING

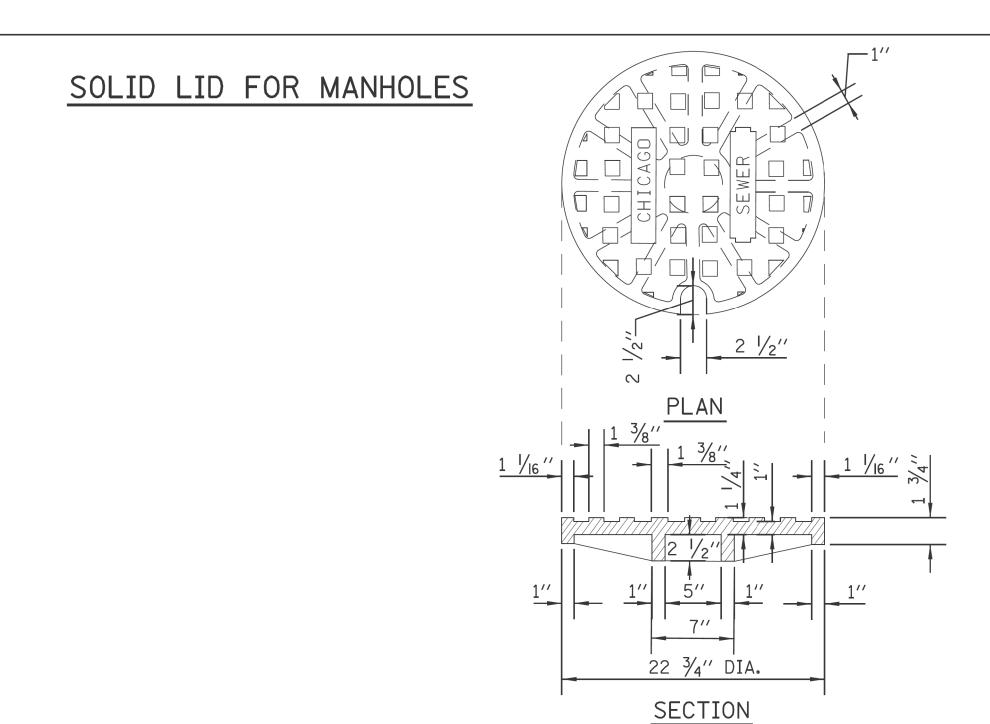

STAND	ARD REVISIONS	PERC
DATE	DESCRIPTION	
2/5/21	Approved	

PERCENT COMPLETE	DATE	CITY OF CHICAGO DEPARTMENT OF WATER MANA
30		BUREAU OF ENGINEERING SERVICE
60		
75		MANHOLE
90		LIDS AND FRAMES
100		

DESIGNED: \_\_\_\_\_ CHECKED: \_\_\_\_ GD, GC, SO A 21 AGEMENT PN



ICAGO	USER NAME = AB	DESIGNED -		REVISED -
		DRAWN -		REVISED -
	PLOT SCALE = 10.0000 ' / in.	CHECKED -		REVISED -
//.	PLOT DATE = 7/1/2025	DATE -	07/01/2025	ISSUED FOR BID - 07/10/2025
	_	•		

CITY OF CHICAGO **DEPARTMENT OF TRANSPORTATION** 40th WARD

85.6 SQ. IN.

CDWM STANDARD CONSTRUCTION DETAILS PBC PROJECT NO # 22925 W. ARGYLE STREET - W. AINSLIE STREET N. HOYNE AVENUE - N. SEELEY AVENUE

TOTAL SHEET NO. OUC NUMBER OUC IR #122194 25 20 COOK TO STA. SCALE:

#### STANDARD DRAINAGE STRUCTURES FOR PUBLIC STREETS #5 DOWEL BAR @ — — TYPE B CURB & GUTTER CONSTRUCTION JOINT TYPE B-V.12 Per CDOT Details CURB AND GUTTER\_ Note: Positive Summit - 1/2" ROUND TIE BARS Per CDOT Details for Drainage 30" LONG, 30" C/C CHICAGO 4" MAXIMUM (TYP) Note: Positive Summit -FRAME & LID CHICAGO for Drainage FRAME & LID 4" MAXIMUM(TYP)-PRECAST 8" MAX CONCRETE 2 RING PRECAST-8" VIT. CLAY, ADJUSTEMNT MAXIMUM CONCRETE 1' VERTICAL RING ADJUSTEMNT HALF TRAP 2" MIN RING 8" MAX 2'-0" DIA. 2 RING 8" VIT. CLAY,-2'-0" DIA. MAXIMUM PRECAST 1' VERTICAL REINF. CONC. HALF TRAP PRECAST OFFSET CONE REINF. CONC. OFFSET CONE -SWIRL CHAMBER VORTEX or ORIFICE VORTEX or ORIFICE - RESTRICTOR RESTRICTOR (SEE MISC DETAILS (SEE MISC DETAILS SHEET A.26) SHEET A.26) 4'-0'' DIA. 3'-0" DIA. PRECAST REINFORCED BASE AND PRECAST REINFORCED BASE AND-RISER WITH MINIMUMN 6" EMBEDMENT RISER WITH MINIMUMN 6" EMBEDMENT STANDARD CATCH BASIN-4' DIA. STANDARD CATCH BASIN-3' DIA. CHICAGO STANDARD MANHOLE FRAME AND —PERFORATED LID CURB & -GUTTER 3" MAXIMUM\* (TYPICAL) \_2′′ R

<u>Zumannannan</u>

2'-0'' DIA.

-8" DUCTILE IRON

PIPE MUST BE

CONNECTION TO

PIPE TO BE LAID

CATCH BASIN.

ON A MINIMUM GRADE OF 1%

USED FOR

#5 @-

12''


REINFORCED CONCRETE —

BASE CAST AS INTEGRAL

PRECAST CONCRETE RING

PART OF 24" DIA.

#### STANDARD DRAINAGE STRUCTURES FOR PUBLIC ALLEYS

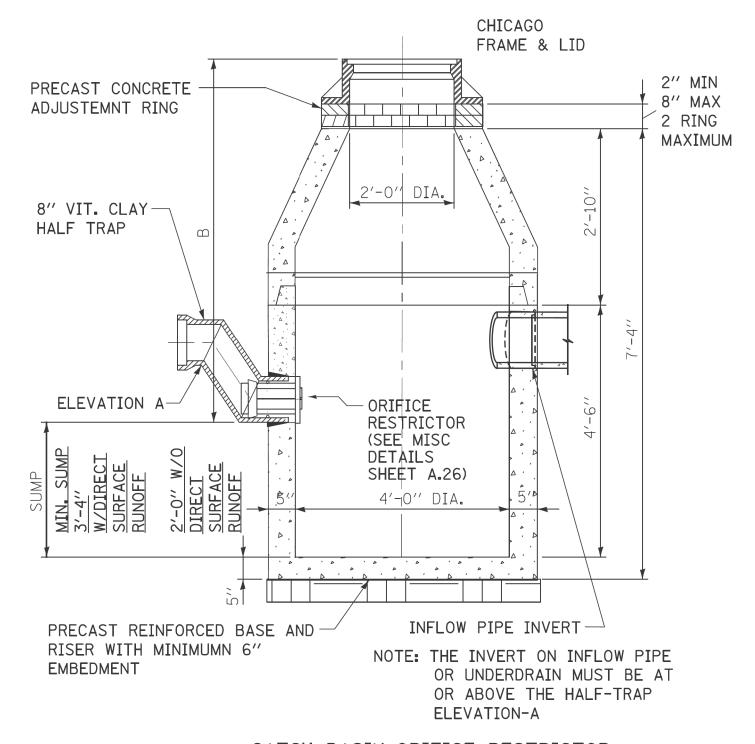

#### CATCH BASIN-ORIFICE RESTRICTOR

N.T.S.

GENERAL NOTES: 1. CATCH BASIN TO CATCH BASIN CONNECTIONS ARE ALLOWED IN PRIVATE SITES & ALLEYS. ONLY THE DOWNSTREAM CATCH BASIN IS REQUIRED TO HAVE A HALF-TRAP.

2. IF B < 4 FEET, THEN USE A FLAT TOP SLAB CATCH BASIN AS NECESSARY.

3. FOR TRENCH BACKFILL, REFER TO IDOT SSRBC, ARTICLE 1003.04.

4. FOR GRANULAR EMBEDMENT, USE CA-11, CRUSHED GRAVEL, CRUSHED STONE, OR CRUSHED CONCRETE.

5. FOR STABILIZATION STONE. 12" OF CA-1 STONE IS ONLY REQUIRED WHEN UNSTABLE MATERIAL IS ENCOUNTERED AT TRENCH BOTTOM.

6. INLETS AND 3' DIAMETER CATCH BASINS ARE TO BE USED ONLY WITH PRIOR APPROVAL OF THE DEPT OF WATER MANAGEMENT- ENGINEERING SERVICES, SEWER SECTION, AND THE DEPT. OF BUILDINGS STORMWATER REVIEWER.

7. IF COVER OVER VCP IS LESS THAN 3', USE 45 DEGREE DIP BENDS WITH 1 FOOT DROP AS HALF TRAPS AS NEEDED FOR IEPA CLEARANCE REQUIREMENTS

STAND	ARD REVISIONS
DATE	DESCRIPTION
2/5/21	APPROVED

PERCENT COMPLETE	DATE	CITY OF CHICAGO Department of water management	DRAWN: SBW DESIGNED: CHECKED:	Δ 22
30		BUREAU OF ENGINEERING SERVICES		/^ • <i>C</i>
60			REVIEWED:	
75		DRAINAGE STRUCTURE DETAILS	_	\_
90				)F
100			PN	
BULLETIN			LIN _	

CHICAGO	USER NAME = AB	DESIGNED -	REVISED -
		DRAWN -	REVISED -
	PLOT SCALE = 10.0000 ' / in.	CHECKED -	REVISED -
	PLOT DATE = $7/1/2025$	DATE - 07/01/2025	ISSUED FOR BID - 07/10/2025

24" DIA. PRECAST

RING

6" MIN. GRANULAR-

EMBEDMENT UNDER

ALL INLETS

DUCTILE

STANDARD INLET-2' DIA.

<u>PLAN</u>

(FRAME & LID NOT SHOWN)

IRON PIPE

CONCRETE A


CITY OF CHICAGO **DEPARTMENT OF TRANSPORTATION** 40th WARD

CDWM STANDARD CONSTRUCTION DETAILS **PBC PROJECT NO # 22925** W. ARGYLE STREET - W. AINSLIE STREET N. HOYNE AVENUE - N. SEELEY AVENUE

	OUC NUMBER		COUNTY	TOTAL SHEETS	SHEET NO.
		OUC IR #122194	COOK	25	21
	STA.	TO STA.	SCALE:		
- 1					


CDWM Details.cel 2/5/2021 2:00:11 PM

#### DRAINAGE STRUCTURES RESTRICTORS

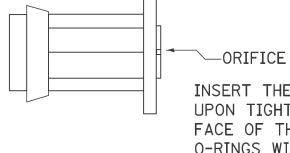

—ORIFICE RESTRICTOR

INSERT THE RESTRICTOR INTO THE HALF-TRAP. UPON TIGHTENING OF THE CENTER NUT ON THE FACE OF THE RESTRICTOR, THE RUBBER O-RINGS WILL EXPAND INSIDE THE HALF TRAP, PROVIDING A WATER- TIGHT SEAL. PULL ON RESTRICTOR TO VERIFY THAT A TIGHT FIT IS MADE.

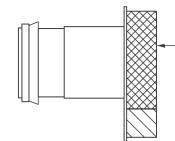

-VORTEX RESTRICTOR

PULL ON RESTRICTOR TO VERIFY THAT A TIGHT FIT IS MADE.

INSERT THE RESTRICTOR WITH THE OPENING DOWN. UPON TIGHTENING OF THE 2 BOLTS ON THE FACE OF THE RESTRICTOR, THE RUBBER O-RINGS WILL PROVIDE A WATER- TIGHT SEAL.

#### GENERAL NOTES:

1. CATCH BASIN TO CATCH BASIN CONNECTIONS ARE ALLOWED IN PRIVATE SITES & ALLEYS. ONLY THE DOWNSTREAM CATCH BASIN IS REQUIRED TO HAVE A HALF-TRAP.

2. IF B < 4 FEET, THEN USE A DUCTILE IRON PIPE HALF TRAP AND FLAT TOP SLAB CATCH BASIN AS NECESSARY.

3. INLETS AND 3' DIAMETER CATCH BASINS ARE TO BE WITH PRIOR APPROVAL OF DWM FIELD INSPECTOR.

#### RESTRICTOR NOTES:


THE DWM'S RAIN BLOCKER RESTRICTOR PROGRAM MUST BE MAINTAINED WITH ANY ROADWAY IMPROVEMENT.

THE DESIGN OF ANY ROADWAY IMPROVEMENT MUST CONSIDER LIMITING THE NUMBER OF CATCH BASINS TO THE EXTENT PRACTICAL. THE NUMBER OF EXISTING STRUCTURES SHOULD NOT BE INCREASED.

THE RESTRICTORS CAN BE OBTAINED FROM DWM CENTRAL DISTRICT AT 3901 S. ASHLAND AVE. THE CONTRACTOR SHOULD ARRANGE FOR PICK UP BY CONTACTING 312-747-8736 (7AM TO 3PM, M-F). CONTRACTOR MUST CALL 48 HOURS IN ADVANCE OF PICK UP DATE AND TIME.

FLOW RESTRICTORS MUST BE INSTALLED IN ALL CATCH BASINS OUTSIDE OF THE CENTRAL BUSINESS DISTRICT(LIMITS: NORTH AVE, CERMAK AVE, HALSTED AVE, LAKE MICHIGAN). RESTRICTORS MUST NOT BE INSTALLED IN CATCH BASINS IN CLOSE PROXIMITY TO VIADUCT AREAS, BUS STOPS, OR EMERGENCY ENTRANCES. THE DWM MUST APPROVE THE NON-INSTALLATION OR REMOVAL OF ANY RESTRICTOR. REQUIREMENTS FOR RESTRICTOR INSTALLATION ARE AS FOLLOWS:

\*ARTERIAL STREETS: 3-INCH ORIFICE RESTRICTOR \*BUS ROUTES: 3-INCH ORIFICE RESTRICTOR \*RESIDENTIAL STREETS: 3-INCH VORTEX RESTRICTOR \*ALLEYS: 3-INCH ORIFICE RESTRICTOR IN THE LAST CB. \*CLOSED LIDS ARE REQUIRED ON ALL MANHOLES EXCEPT AT INTERSECTIONS WHERE A PERFORATED LID SHALL BE

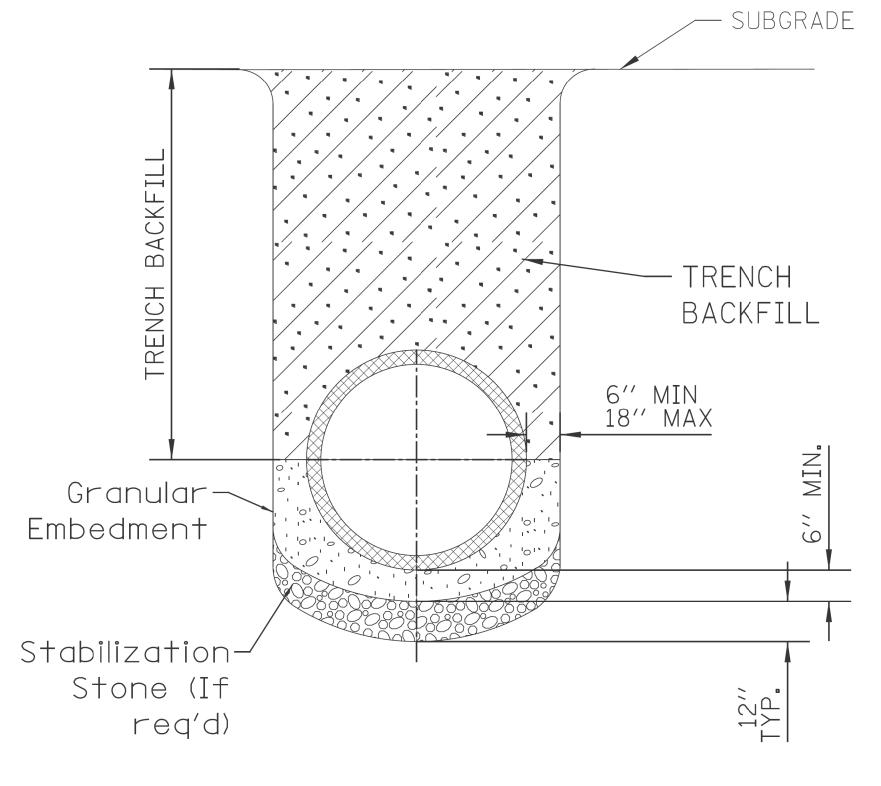

NOTE: 1. FOR TRENCH BACKFILL, REFER TO IDOT SSRBC, ARTICLE 1003.04.


2. FOR GRANULAR EMBEDMENT, USE CA-11, CRUSHED GRAVEL, CRUSHED STONE, OR CRUSHED CONCRETE.

3. FOR STABILIZATION STONE, 12" OF CA-1 STONE IS ONLY REQUIRED WHEN UNSTABLE MATERIAL IS ENCOUNTERED AT TRENCH BOTTOM.

4. AGGREGATE PLACED FOR TEMPORARY SURFACE RESTORATION WILL NOT BE PAID SEPARATELY AND SHALL BE INCIDENTAL TO THE CONTRACT.

SEWER TRENCH DETAIL

PLUG TO BE COATED WITH MORTAR AND DRIVEN INTO PLACE WITH A WOODEN MALLET AND THEN SEALED WITH MORTAR.

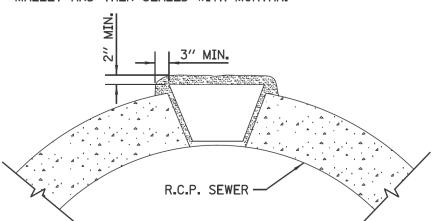

#### LIFTING HOLE PLUG DETAIL FOR CONCRETE PIPE

1. ALL PLUG MATERIALS MUST COMPLY WITH 1042.16 OF THE IDOT SSRBC.

2. LIFT HOLES ON COMBINED SEWERS ARE PROHIBITED WHEN THE WATER TABLE IS WITHIN 2 FEET OF THE PIPE INVERT, OR IF THE PIPE IS FULLY SUBMERGED UNDER NORMAL CONDITIONS.

	<u> </u>
STAND	ARD REVISIONS
DATE	DESCRIPTION
2/5/21	APPROVED PLAN

PERCENT COMPLETE	DATE	CITY OF CHICAGO Department of water management	
30		BUREAU OF ENGINEERING SERVICES	
60			L
75		MISCELLANEOUS	l
90		DETAILS	
100		DETAILS	
OLU LETTL			

DRAWN: SBW DESIGNED: \_\_\_\_ CHECKED: GD. GC. SO REVIEWED: \_\_\_\_ OF \_\_\_ PN \_\_\_\_\_

CDWM Details.cel 2/5/2021 2:07:40 PM




SION •	OF CHICAGO
PUBLIC BUILDING COMMISSION •	
CBUILDIN	
PUBLIC	<i>W///</i> .

USER NAME = AB	DESIGNED -		REVISED -
	DRAWN -		REVISED -
PLOT SCALE = 10.0000 ' / in.	CHECKED -		REVISED -
PLOT DATE = 7/1/2025	DATE -	07/01/2025	ISSUED FOR BID - 07/10/2025

**CITY OF CHICAGO DEPARTMENT OF TRANSPORTATION** 40th WARD

CDWM STANDARD CONSTRUCTION DETAILS **PBC PROJECT NO # 22925** W. ARGYLE STREET - W. AINSLIE STREET N. HOYNE AVENUE - N. SEELEY AVENUE

TOTAL SHEET NO. OUC NUMBER COUNTY OUC IR #122194 25 22 COOK TO STA. SCALE:

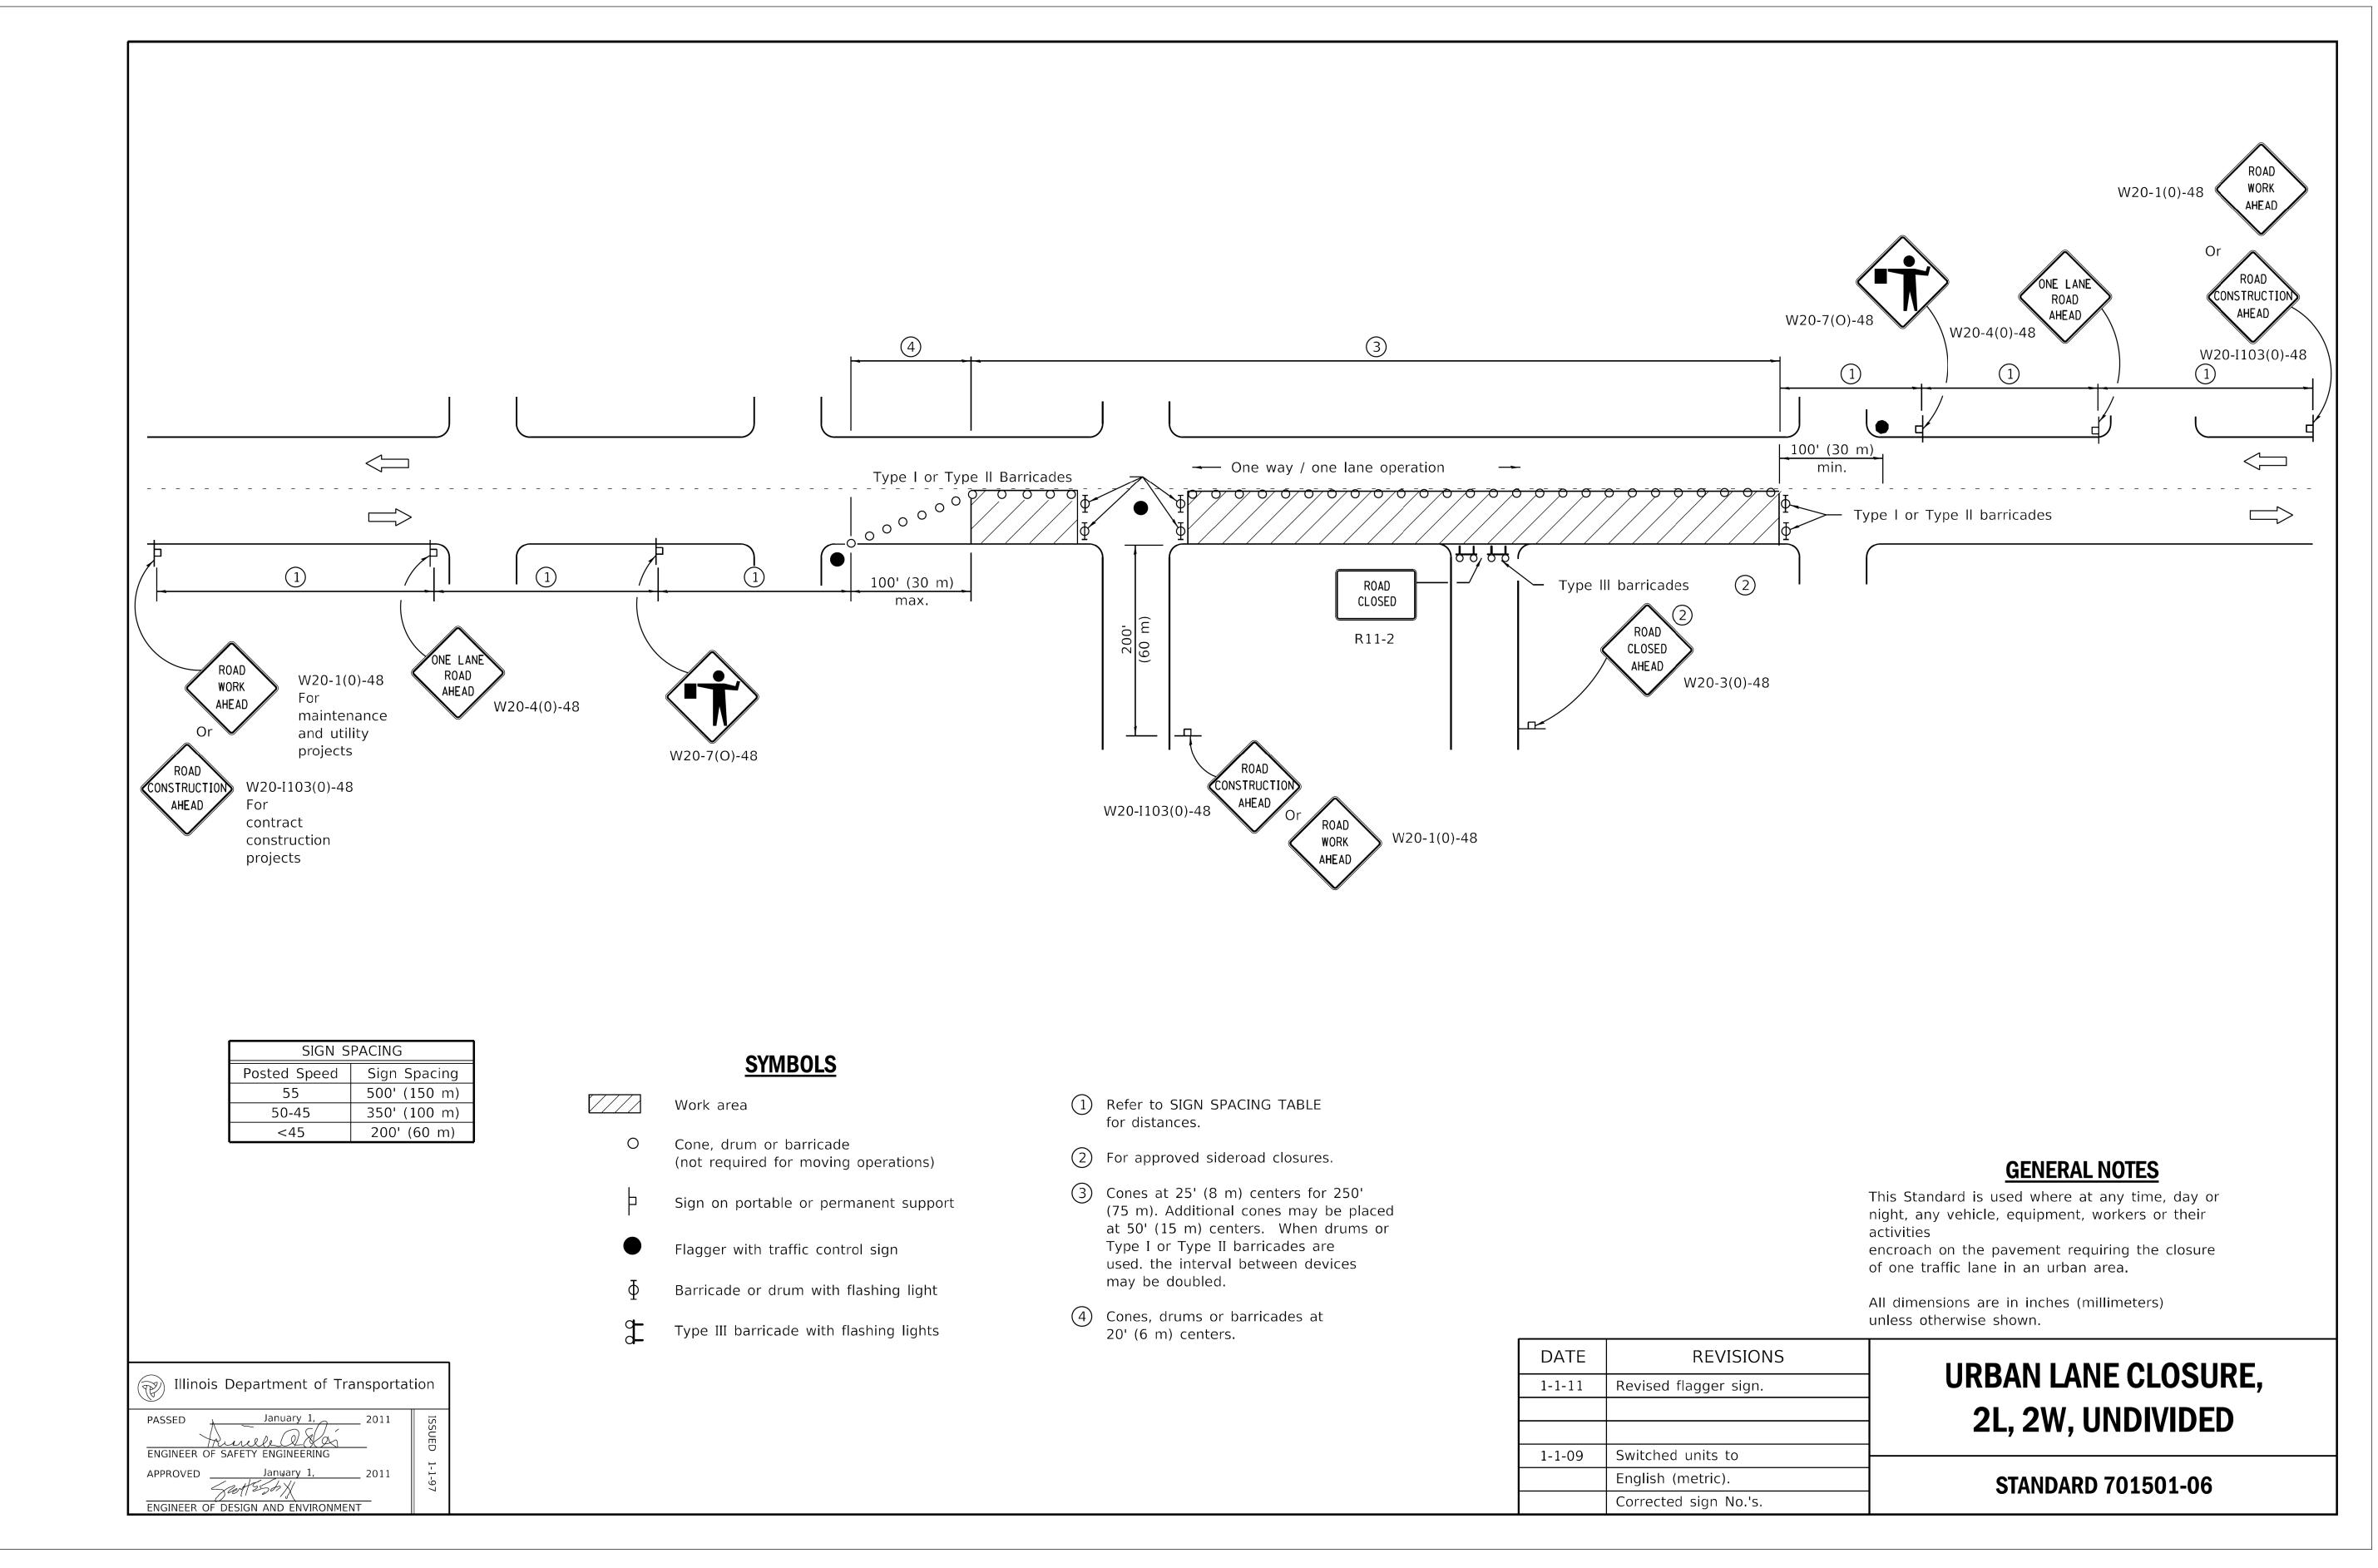

\*CDOT

 USER NAME
 = AB
 DESIGNED
 REVISED

 DRAWN
 REVISED

 PLOT SCALE
 = 10.0000 ' / in.
 CHECKED
 REVISED

 PLOT DATE
 = 7/1/2025
 DATE
 07/01/2025
 ISSUED FOR BID - 07/10/2025


CITY OF CHICAGO
DEPARTMENT OF TRANSPORTATION
40th WARD

IDOT STANDARD DETAILS
PBC PROJECT NO # 22925
W. ARGYLE STREET - W. AINSLIE STREET
N. HOYNE AVENUE - N. SEELEY AVENUE

OUC NUMBER
COUNTY
SHEETS
NO.


OUC IR #122194
COOK
25
23

STA.
TO STA.
SCALE:

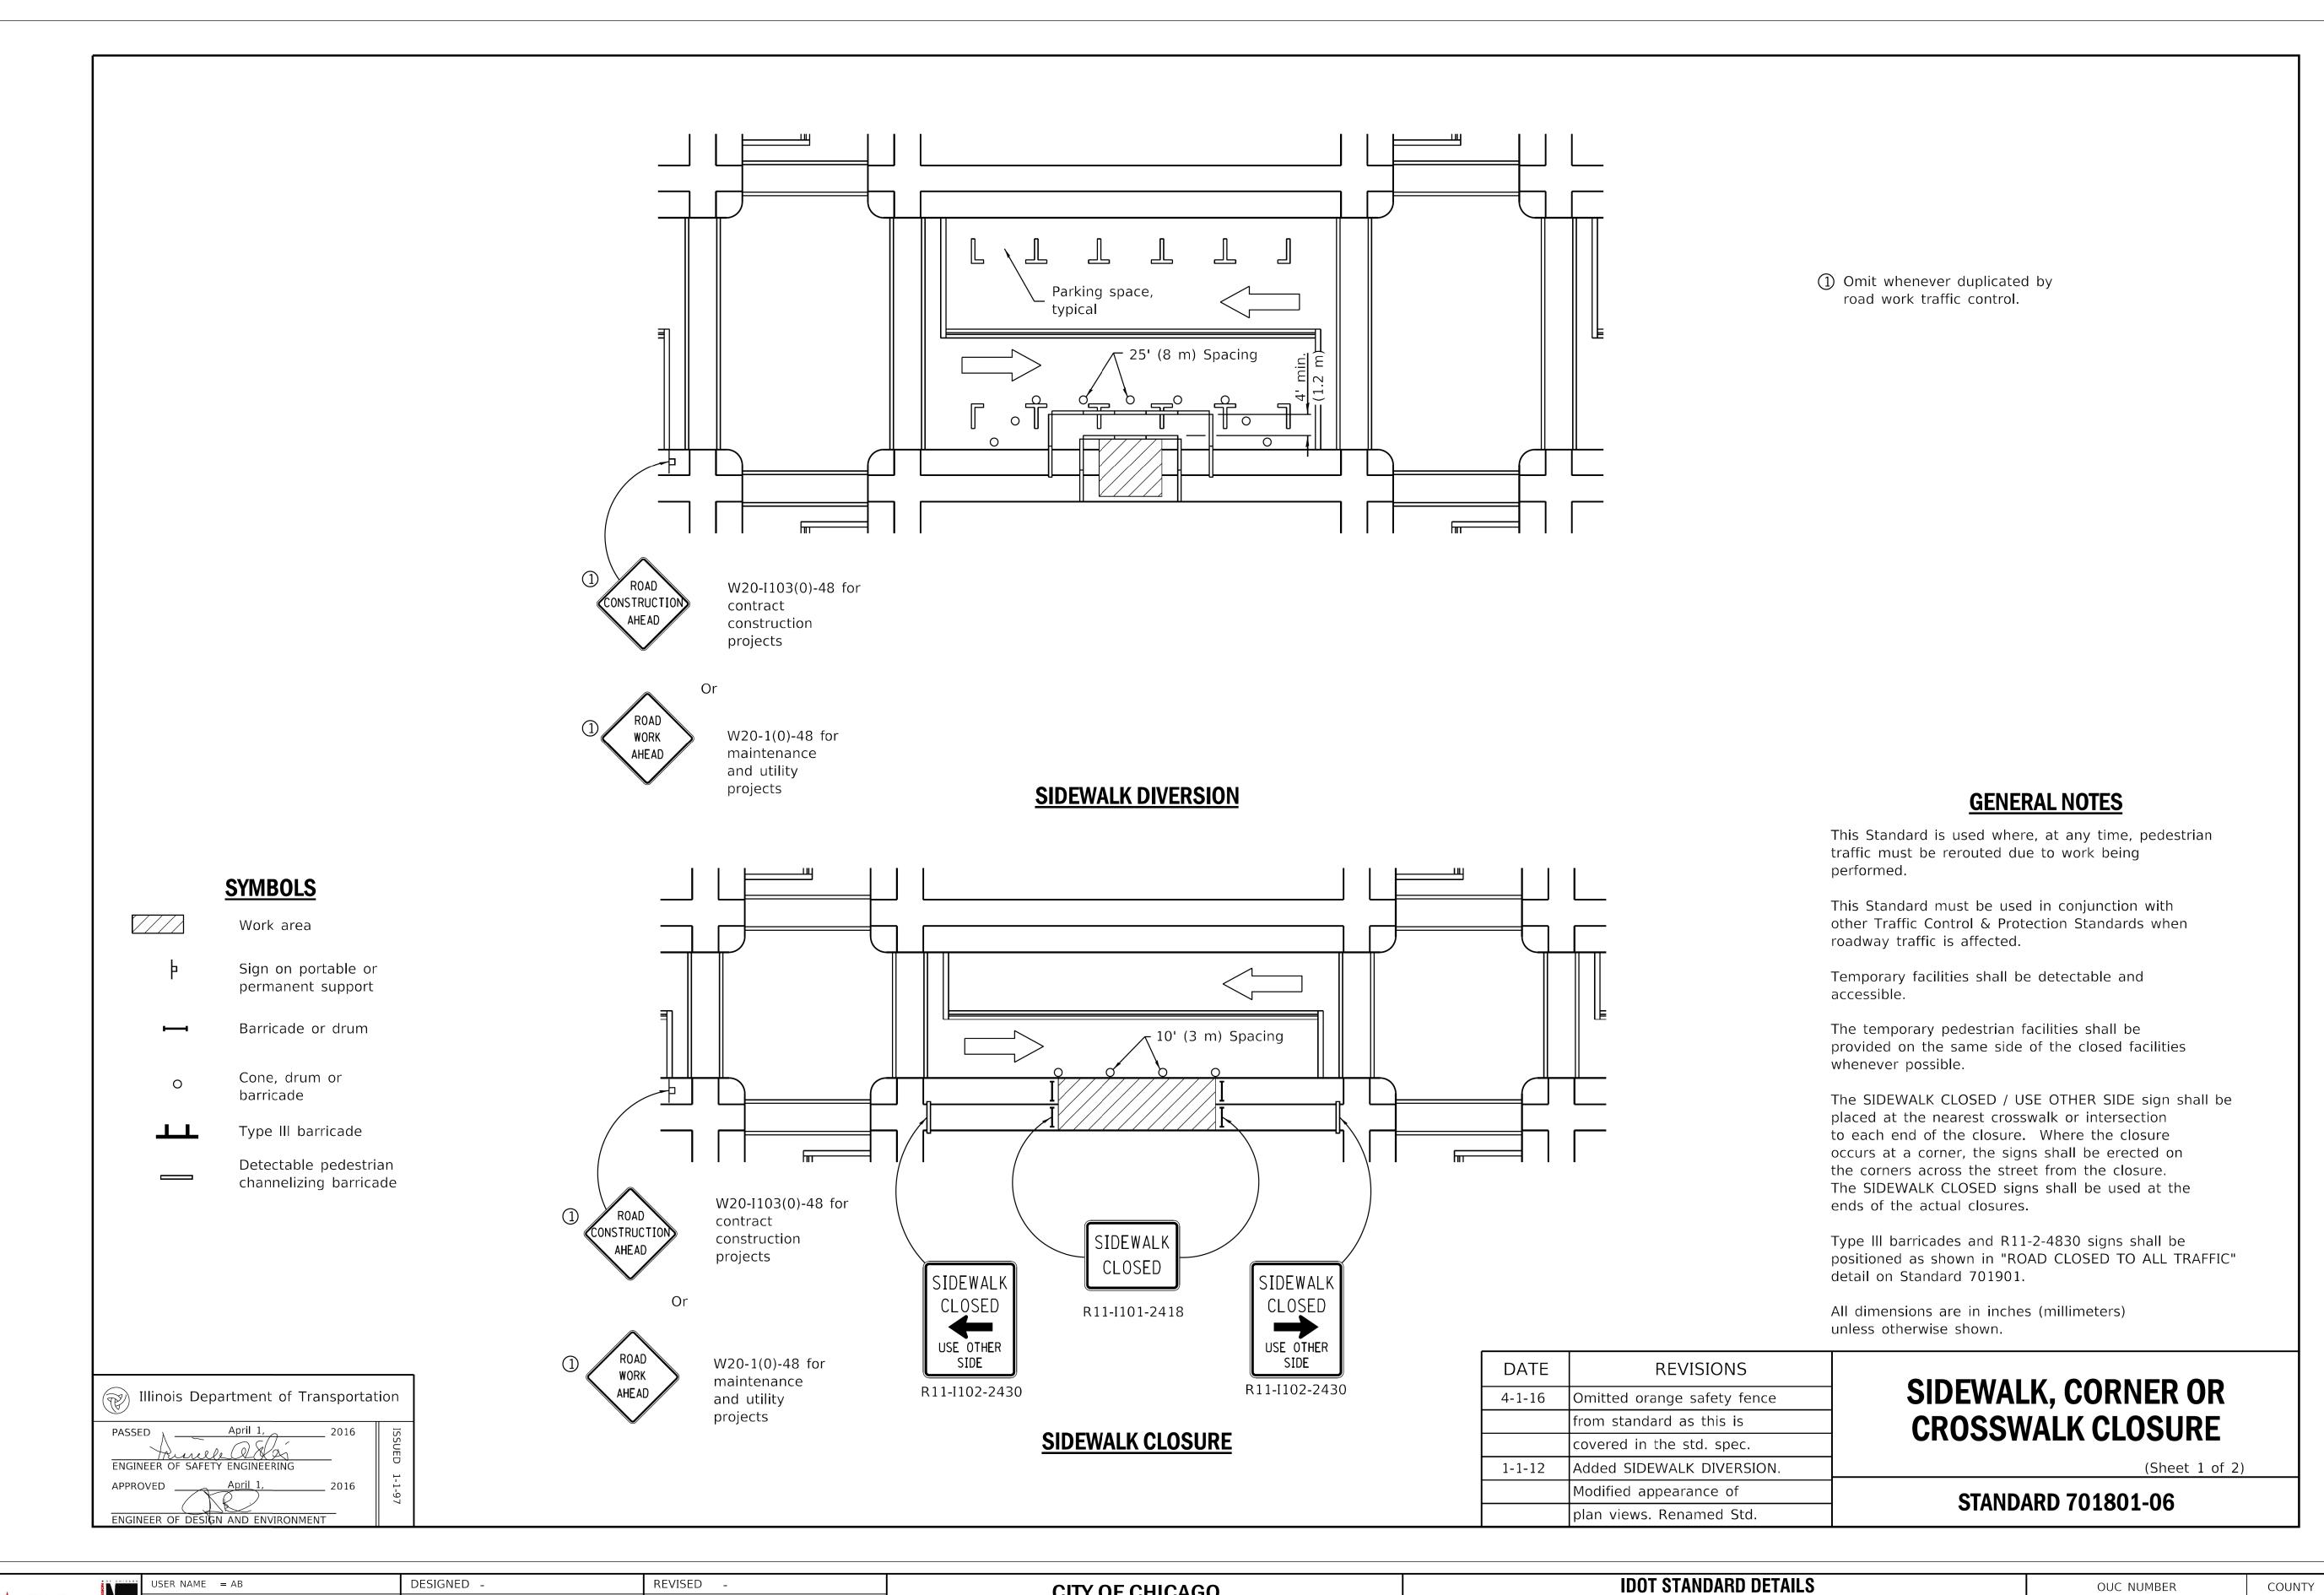


CHICA STATE OF THE PARTY OF THE



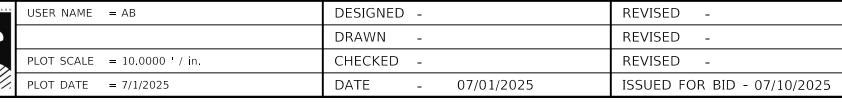

CITY OF CHICAGO DEPARTMENT OF TRANSPORTATION 40th WARD IDOT STANDARD DETAILS
PBC PROJECT NO # 22925
W. ARGYLE STREET - W. AINSLIE STREET
N. HOYNE AVENUE - N. SEELEY AVENUE

OUC NUMBER
COUNTY
TOTAL SHEET NO.
OUC IR #122194
COOK
25
24
STA. TO STA.
SCALE:

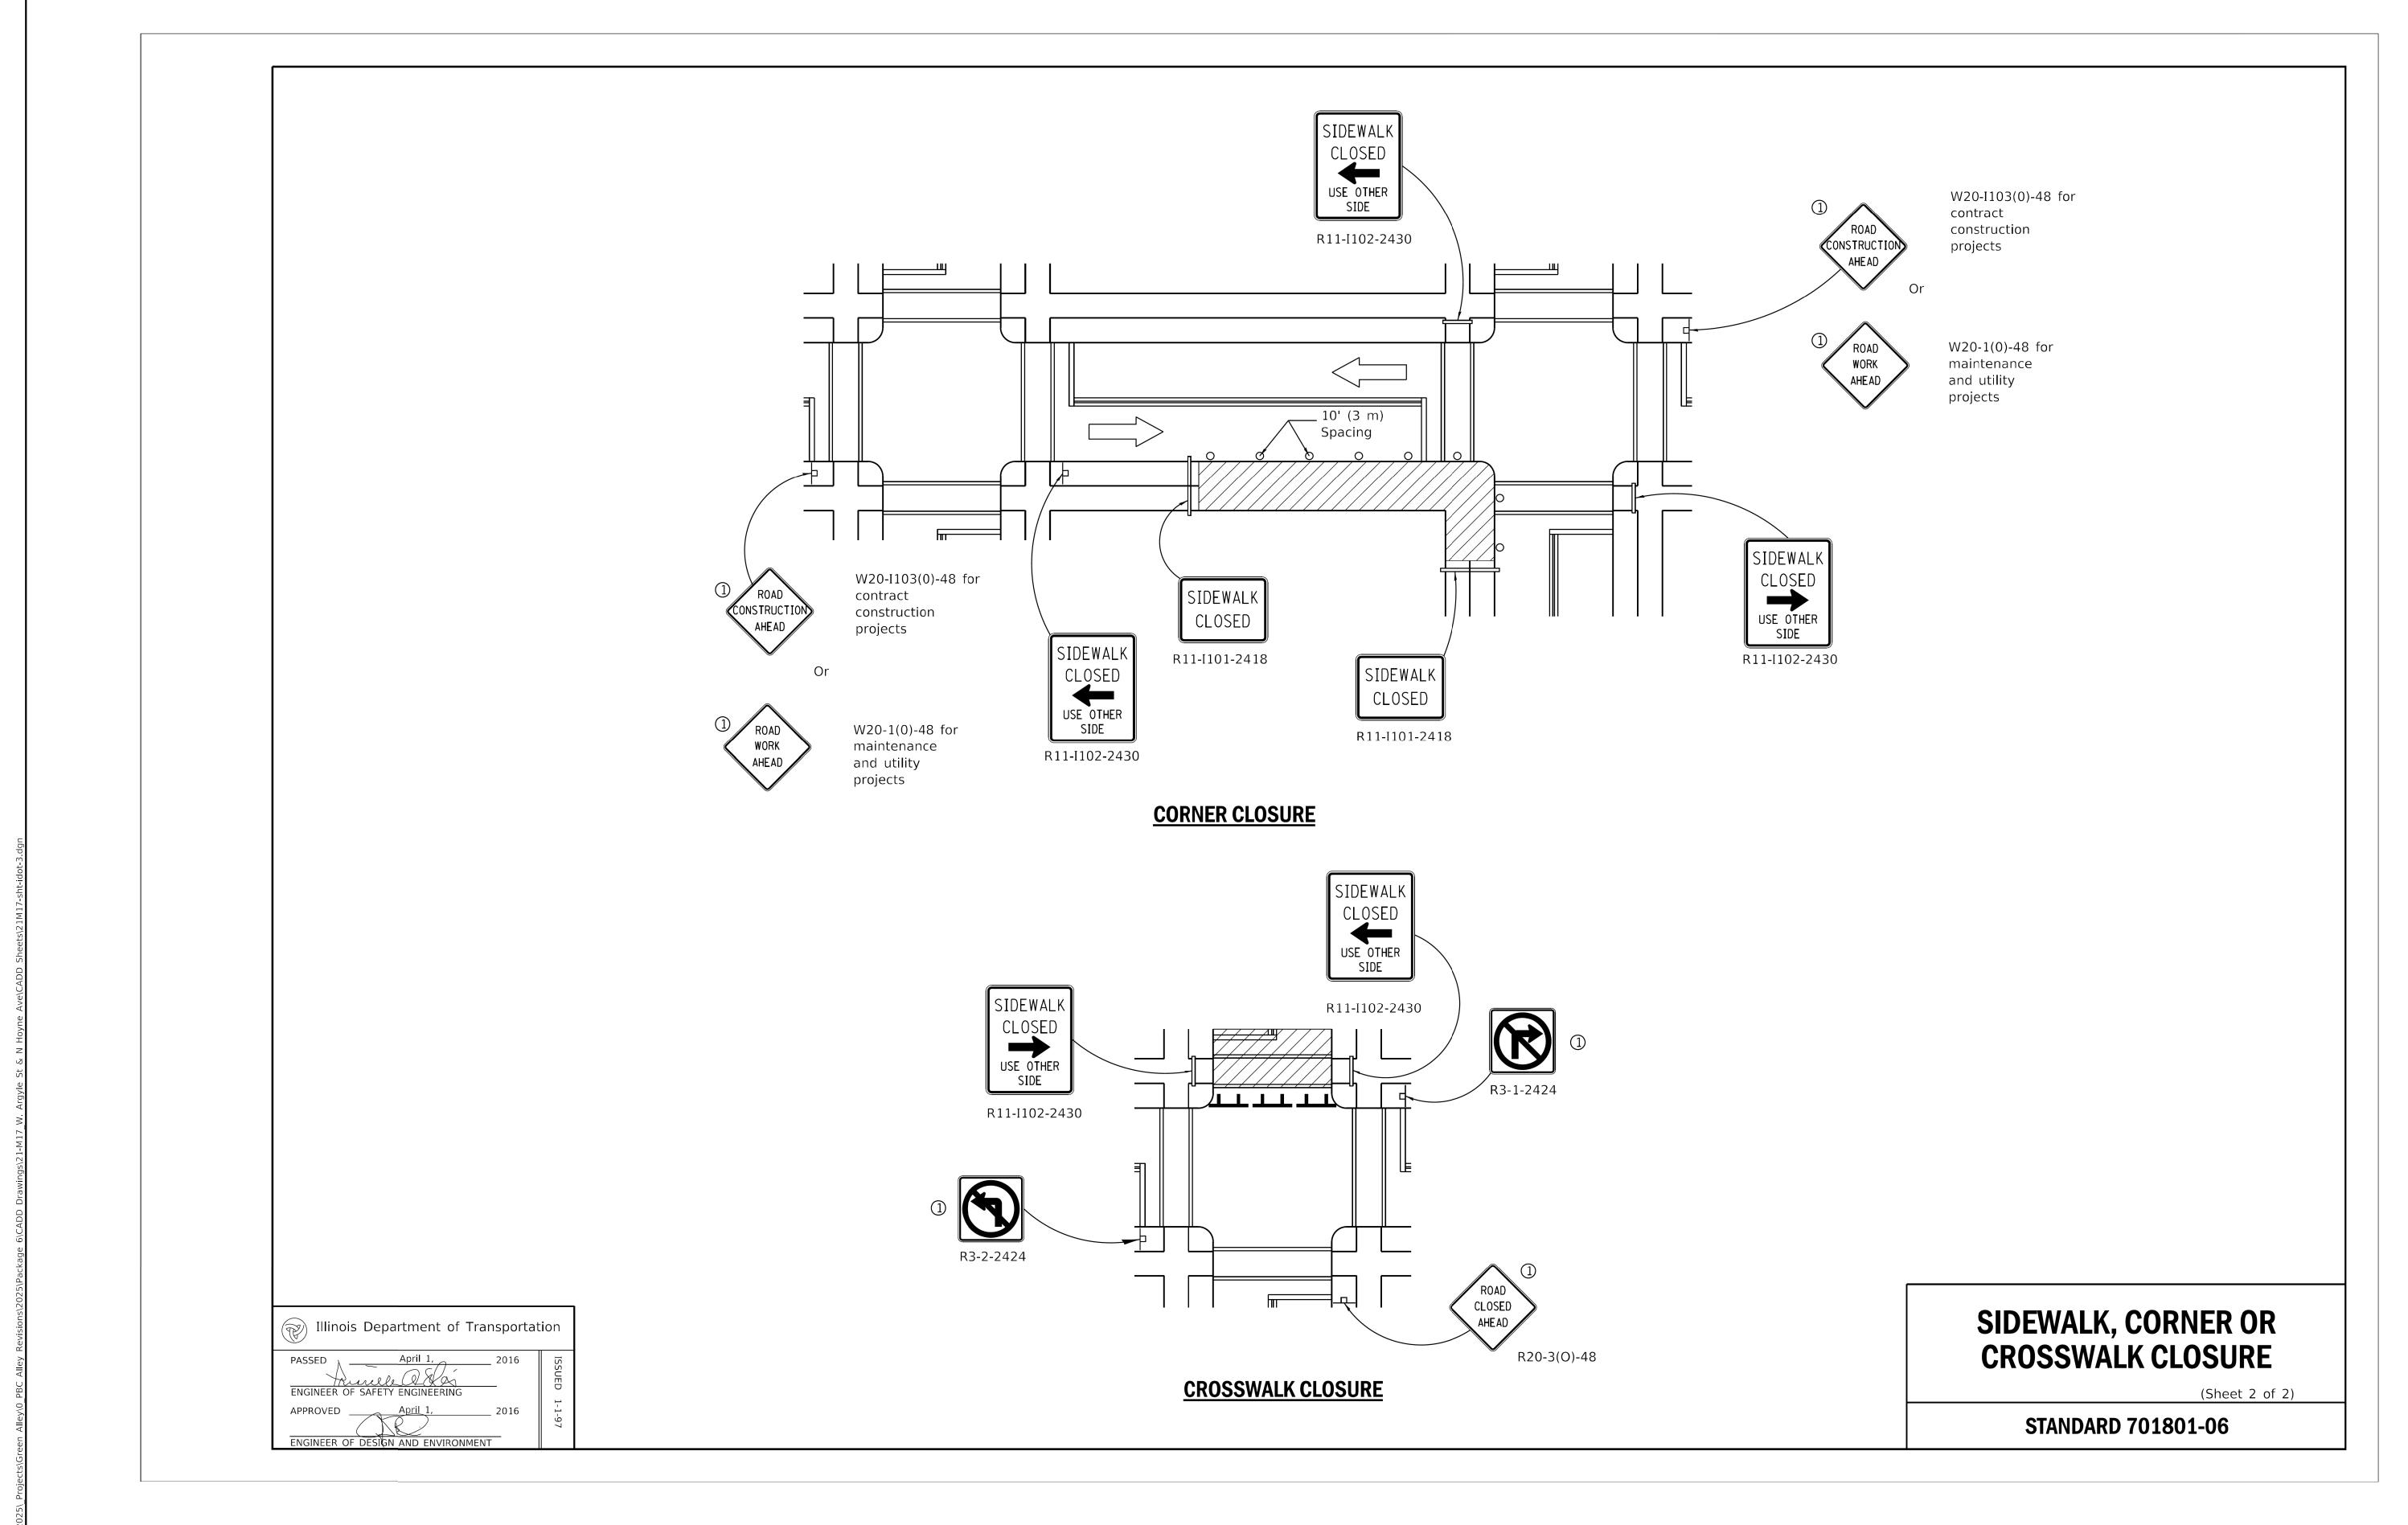

	OUC NUMBER	COUNTY	SHEETS	NO.
	OUC IR #122194	COOK	25	25
STA.	TO STA.	SCALE:		