# STANDARD SYMBOLS

<u>EXISTING</u>	<u>PROPOSED</u>	NAME
$\bigcirc$		CATCH BASIN
	$\odot$	MANHOLE
	_	INLET
-0-	-	UTILITY POLE
¤	<b>-</b>	LIGHT POLE
6" 💮		EXISTING TREES WITH DIAMETER
	6" 💥	EXISTING TREES TO BE REMOVED
$(X_{\bullet}XX)$	x_xx	ELEVATION
		MATCH EXISTING ELEVATIONS
		PROPERTY LINE
		RIGHT OF WAY LINE
		CENTER LINE
=====		CURB OR CURB AND GUTTER
	· · · · · · · · · · · · · · · · · · ·	WATER LINE
G		GAS LINE
└── <b>/</b> G		ABANDONED GAS
F0	—— F0 ——	FIBER OPTIC CABLE
——— Е———	E	COMMONWEALTH EDISON
		CITY ELECTRIC
т	т	TELEPHONE
<del></del>		COMBINED STORM SEWER
<del></del>		REMOVAL LINEAR ITEMS
	<del></del>	STORM SEWER
стv	сту	CABLE TV
A	A	AERIAL WIRE
<u> </u>	Δ Δ	PORTLAND CEMENT CONCRETE SIDEWALK
/ <u> </u>	Δ	PORTLAND CEMENT CONCRETE DRIVEWAY
		PORTLAND CEMENT CONCRETE GARAGE APRON
<u> </u>		PORTLAND CEMENT CONCRETE ENTRANCE


HOT MIX ASPHALT RESTORATION

DEPRESSED CURB AND GUTTER

## **STANDARD ABBREVIATIONS**

<u>ABBREVIATION</u>

ASH	ASPHALT SPEED HUMP
СВ	CATCH BASIN
DIP	DUCTILE IRON PIPE
HP	HIGH POINT
МН	MANHOLE
RCP	REINFORCED CONCRETE PIPE
ROW	RIGHT OF WAY
RSH	RUBBERIZED SPEED HUMP
TBM	TEMPORARY BENCHMARK
VCP	VITRIFIED CLAY PIPE

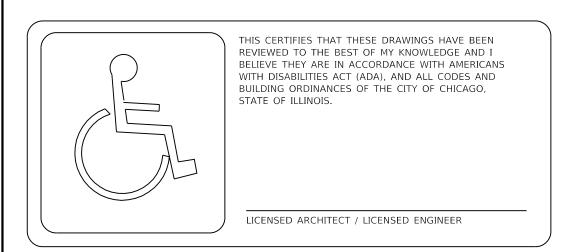

PRIOR TO CONSTRUCTION, THE CONTRACTOR IS REQUIRED TO CALL THE CHICAGO UTILITY ALERT NETWORK (DIGGER/CHICAGO811) AT 312-744-7000 FOR UNDERGROUND UTILITY LOCATIONS.

# STATE OF ILLINOIS CITY OF CHICAGO

BRANDON JOHNSON, MAYOR

# PUBLIC BUILDING COMMISSION

RAY GIDEROF, EXECUTIVE DIRECTOR

# DEPARTMENT OF TRANSPORTATION

CRAIG TURNER, ACTING COMMISSIONER

# **CONTRACT PLANS**

**FOR** 

# PROPOSED IMPROVEMENTS

W. 16TH STREET/W. OGDEN AVENUE


S. CENTRAL PARK AVENUE/S. DRAKE AVENUE

PBC CONTRACT NO.: C1627 U-5-241 CDOT PROJECT NO.: PBC PROJECT NO.: 22922

07/10/2025 **ISSUED FOR BID:** 

> 2307164201 CSR NO.:

> > WARD 24

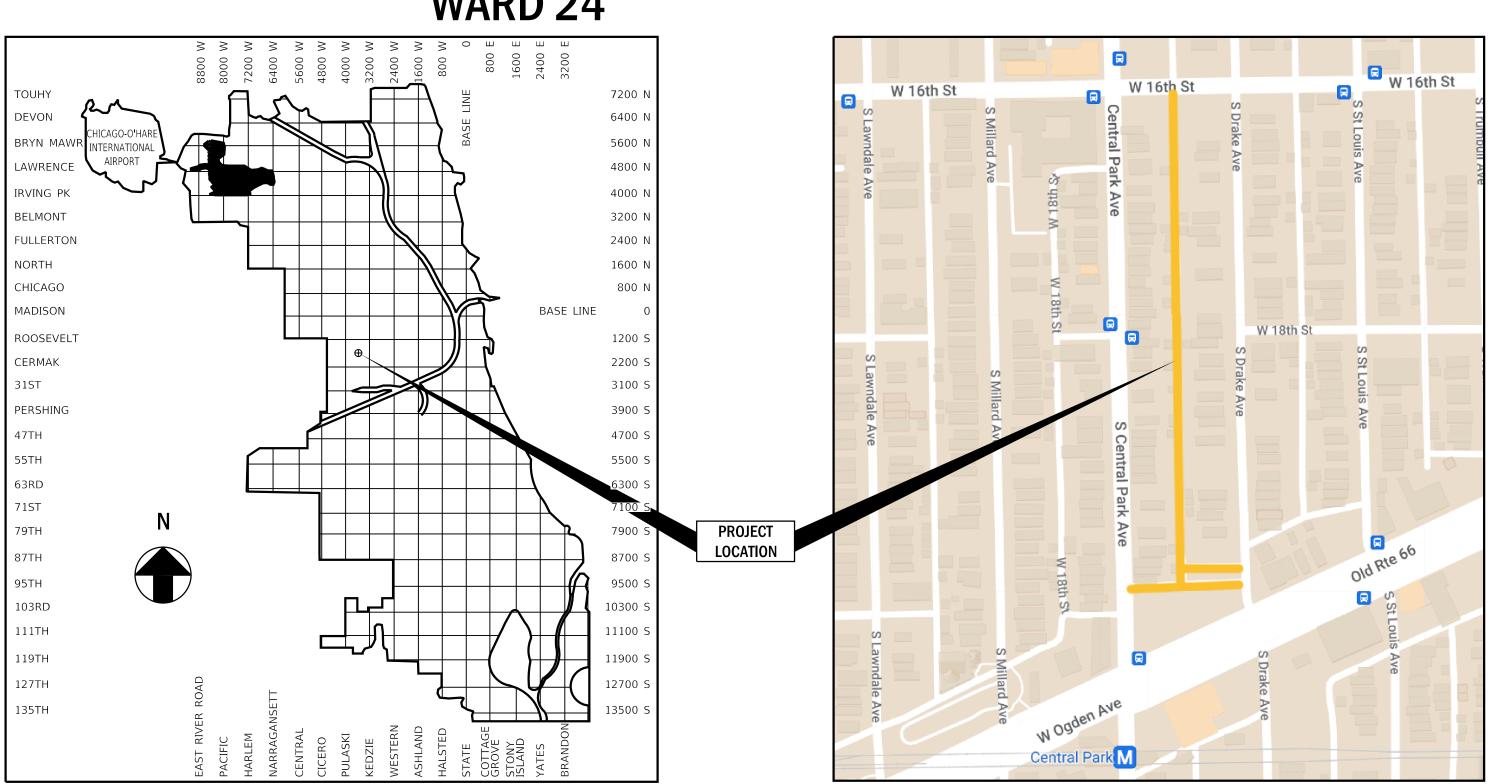



<u>SHEET</u>

1	COVER SHEET
2	ALIGNMENT TIES AND BENCHMARKS
3	GENERAL NOTES
4	SUMMARY OF QUANTITIES
5	PROPOSED CONDITIONS PLAN VIEW
6-9	PLAN AND PROFILE
10	ALLEY APRON DETAILS
11	TYPICAL SECTIONS
12	STRIPING PLAN
13-17	CDOT STANDARD CONSTRUCTION DETAILS
18-23	CDWM STANDARD CONSTRUCTION DETAILS
24-26	IDOT STANDARD DETAILS






**LOCATION MAP** 

**INDEX MAP** 

LENGTH OF IMPROVEMENT = 1583.1 L.F. (0.30 MILES)

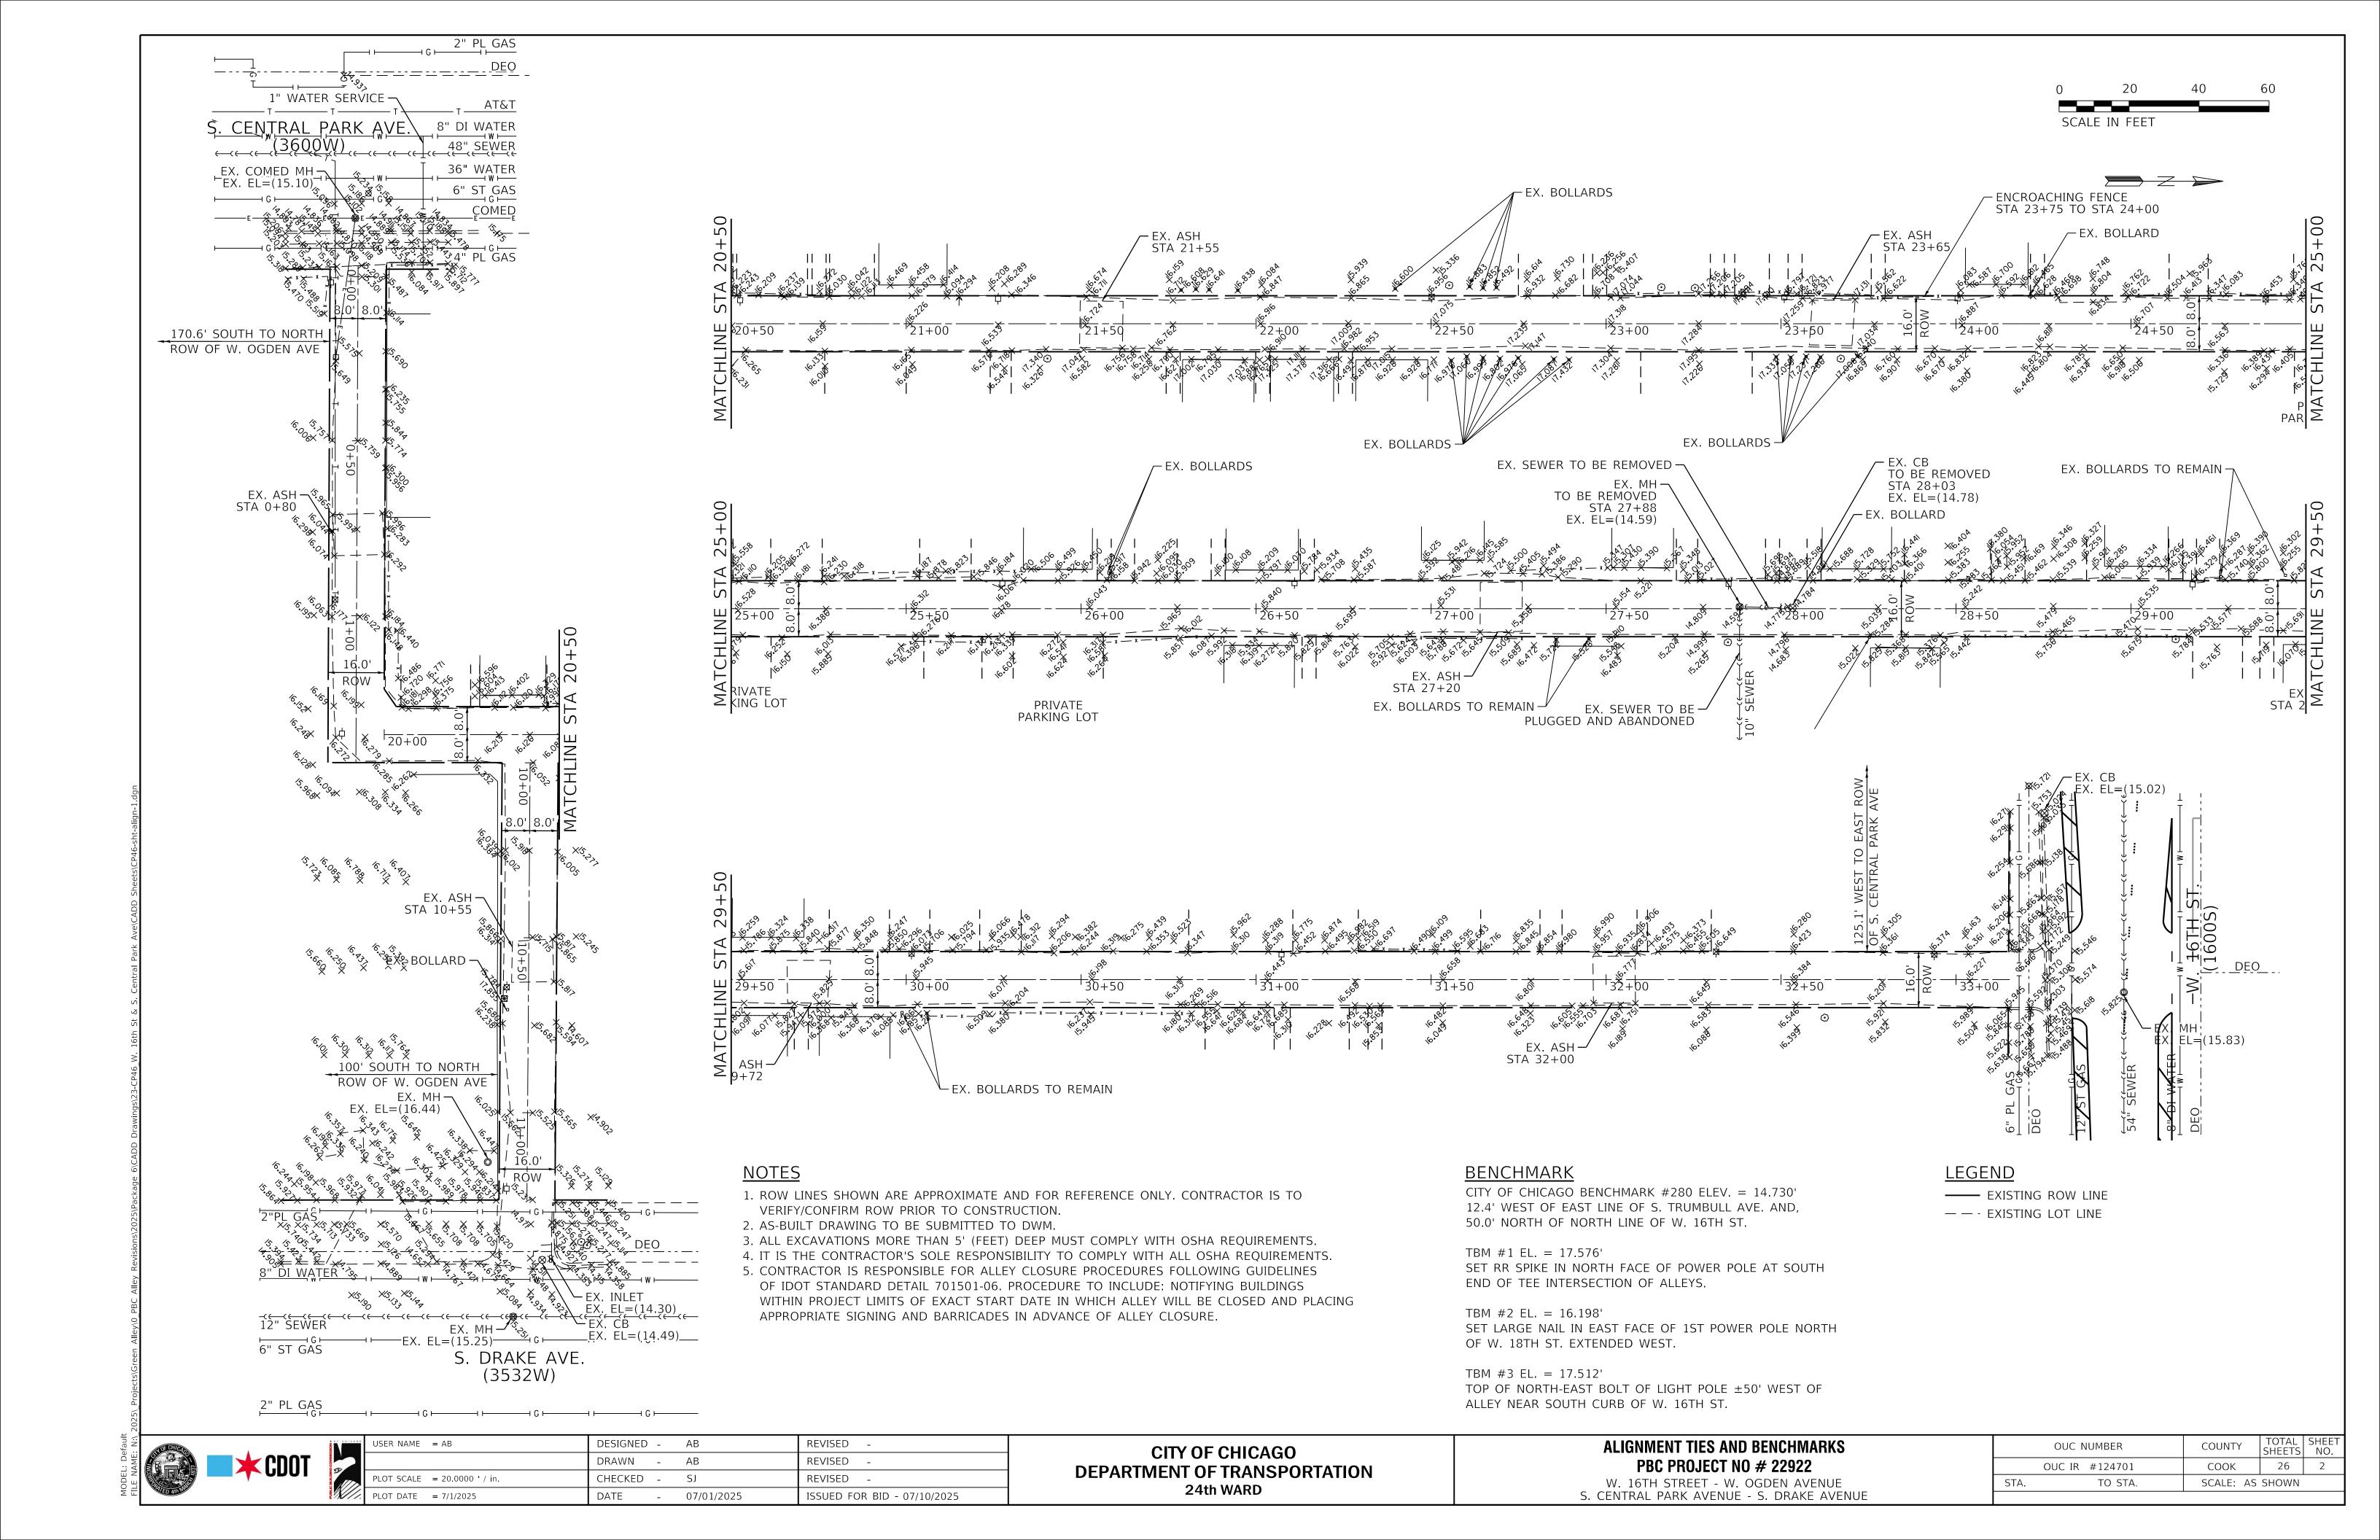

# GENERAL NOTES

- 1. CONTRACTOR WILL BE REQUIRED TO PREPARE A PHASING AND LOGISTICS PLAN WITHIN 30 DAYS OF NTP FOR REVIEW AND APPROVAL BY CDOT AND PBC, PRIOR TO MOBILIZATION AND COMMENCEMENT OF ANY WORK.
- 2. CONTRACTOR SHALL PROVIDE CRITICAL SUBMITTALS, INCLUDING SEWER AND DRAINAGE STRUCTURES, WITHIN 30 DAYS OF ISSUANCE OF THE NTP.
- 3. ON-SITE CONSTRUCTION WORK AT EACH ALLEY LOCATION MUST BE COMPLETED WITHIN 45 CALENDAR DAYS FROM COMMENCEMENT.

z	OF CHIO	
FILE NAME:		<b>CDOT</b>


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		DRAWN -	AB	REVISED -
	PLOT SCALE = 20.0000 ' / in.	CHECKED -	SJ	REVISED -
<i>[]</i>	PLOT DATE = 7/1/2025	DATE -	07/01/2025	ISSUED FOR BID - 07/10/2025


# SUMMARY OF QUANTITIES


Line	Code Number	Description	Unit	Estimated Quantity	Unit Price	Cost
1	*****	EARTH EXCAVATION (SOIL TO CCDD FACILITY)	CU YD	0.0	\$0.00	\$0.00
2	******	EARTH EXCAVATION (SOIL TO LANDFILL)	CU YD	1328.0	\$0.00	\$0.00
3	******	PAVEMENT REMOVAL	SQ YD	32.0	\$0.00	\$0.00
4	*****	DRIVEWAY AND ALLEY RETURN PAVEMENT REMOVAL	SQ YD	253.0	\$0.00	\$0.00
5	44000300	CURB REMOVAL	LIN FT	73.0	\$0.00	\$0.00
6	44000500	COMBINATION CURB AND GUTTER REMOVAL	LIN FT	141.0	\$0.00	\$0.00
7	44000600	SIDEWALK REMOVAL	SQ FT	850.0	\$0.00	\$0.00
8	******	ALLEY PAVEMENT REMOVAL	SQ YD	2816.0	\$0.00	\$0.00
9	******	GARAGE APRON REMOVAL	SQ FT	1083.0	\$0.00	\$0.00
10	******	HOT-MIX ASPHALT SURFACE REMOVAL, VARIABLE DEPTH	SQ YD	58.0	\$0.00	\$0.00
11	31101100	SUB-BASE GRANULAR MATERIAL, TYPE B	CU YD	643.0	\$0.00	\$0.00
12	*****	CONCRETE ALLEY FILL, CA-1	CU YD	0.0	\$0.00	
13		TRENCH BACKFILL	CU YD	631.0	\$0.00	•
14		PERVIOUS AGGREGATE SUBBASE	CU YD	0.0	\$0.00	
15		BEDDING AND VOID OPENING AGGREGATES FOR PERMEABLE PAVERS	CU YD	0.0	\$0.00	•
16		CRUSHED STONE (TEMPORARY USE)	TON	50.0	\$0.00	· ·
17		PORTLAND CEMENT CONCRETE BASE COURSE, 8 IN	SQ YD	20.0		
18		PORTLAND CEMENT CONCRETE BASE COURSE, 10 IN	SQ YD	13.0		
19		HIGH EARLY STRENGTH PORTLAND CEMENT CONCRETE ALLEY PAVEMENT, 8 IN	SQ YD	2840.0		<u> </u>
20		HIGH EARLY STRENGTH PORTLAND CEMENT CONCRETE DRIVEWAY AND ALLEY RETURN PAVEMENT, 8 IN	SQ YD	28.0		
21		HIGH EARLY STRENGTH PORTLAND CEMENT CONCRETE GARAGE APRON, 8 IN	SQ FT	1083.0	·	
22		HIGH EARLY STRENGTH PORTLAND CEMENT CONCRETE SIDEWALK, 8 IN	SQ FT	1812.0		
23		HIGH EARLY STRENGTH PORTLAND CEMENT CONCRETE BASE COURSE, 8 IN	SQ YD	20.0		
24		HIGH EARLY STRENGTH PORTLAND CEMENT CONCRETE BASE COURSE, 10 IN	SQ YD	13.0		•
25		PORTLAND CEMENT CONCRETE SIDEWALK, 5 IN	SQ FT	726.0	· · · · · · · · · · · · · · · · · · ·	<del> </del>
26		PORTLAND CEMENT CONCRETE ADA CURB RAMP, 5 IN	SQ FT	124.0		•
27		HIGH EARLY STRENGTH PORTLAND CEMENT CONCRETE ADA CURB RAMP, 8 IN	SQ FT	0.0	·	
28		DRILL AND GROUT DOWEL AND TIE BARS	EACH	399.0	·	
29		PERMEABLE CONCRETE BLOCK PAVERS	SQ FT	0.0	\$0.00	
30		BITUMINOUS MATERIALS (TACK COAT)	POUND	488.0	·	•
31	1	HOT-MIX ASPHALT SURFACE COURSE, IL-9.5LH, MIX "C", N30 (CDOT)	TON	115.0	·	•
31			TON	<u> </u>	\$0.00	
		HOT-MIX ASPHALT SURFACE COURSE, PATCH, N30 (6 FT OR LESS)	TON	3.0		· ·
33		HOT-MIX ASPHALT SURFACE COURSE, PATCH, N70 (6 FT OR LESS)  CONCRETE CURB, TYPE B		73.0		
35		HIGH EARLY STRENGTH PORTLAND CEMENT CONCRETE COMBINATION CURB AND GUTTER, TYPE B-V.12	LIN FT	73.0	<u> </u>	•
36		COMBINATION CONCRETE CURB AND GUTTER, TYPE B-V.12	LIN FT	68.0	\$0.00	•
37		MANHOLE, 3 FT DIAMETER, TYPE B, FRAME AND CLOSED LID (CITY OF CHICAGO)	EACH	0.0		<u> </u>
					\$0.00	
38		MANHOLE, 3 FT DIAMETER, TYPE A, FRAME AND CLOSED LID (CITY OF CHICAGO)	EACH	2.0		
39	And And And And And	CATCH BASIN, TYPE A, 4 FT DIAMETER, TYPE 1 FRAME, OPEN LID (CITY OF CHICAGO)	EACH	5.0	<u> </u>	•
40		INLETS, TYPE A, TYPE 1 FRAME, OPEN LID (CITY OF CHICAGO)	EACH	1.0	\$0.00	
41		DRAINAGE AND UTILITY STRUCTURES TO BE ADJUSTED	EACH	0.0		
42		VORTEX RESTRICTOR	EACH	1.0	\$0.00	•
43		STORM SEWERS, EXTRA STRENGTH VITRIFIED CLAY PIPE, 8 IN	LIN FT	0.0		
44		STORM SEWERS, DUCTILE IRON PIPE, 8 IN	LIN FT	0.0	·	
45		STORM SEWERS, EXTRA STRENGTH VITRIFIED CLAY PIPE, 10 IN	LIN FT	0.0		
46		STORM SEWERS, EXTRA STRENGTH VITRIFIED CLAY PIPE, 12 IN	LIN FT	1101.0		
47		STORM SEWERS, DUCTILE IRON PIPE, 12 IN	LIN FT	152.0		
48		STORM SEWERS, REINFORCED CONCRETE PIPE, 30 IN.	LIN FT	0.0	\$0.00	
49	' <u> </u>	CIP OR PRECAST CONCRETE REDUCER	EACH	0.0	·	
50	CDOT SP 550-3	ABANDON AND FILL EXISTING COMBINED SEWER	LIN FT	166.0	\$0.00	\$0.00


51	*****	EXISTING SEWER TO BE REMOVED	LIN FT	14.0	\$0.00	\$0.00
52	*****	REMOVING MANHOLES	EACH	1.0	\$0.00	\$0.00
53	*****	REMOVING CATCH BASINS	EACH	2.0	\$0.00	\$0.00
54	*****	REMOVING INLETS	EACH	1.0	\$0.00	\$0.00
55	*****	SEWER CLEANING AND TELEVISING (24 IN DIAMETER OR LESS)	LIN FT	0.0	\$0.00	\$0.00
56	60100085	GEOTECHNICAL FABRIC	SQ YD	0.0	\$0.00	\$0.00
57	*****	PULVERIZED TOPSOIL MIX	CU YD	4.8	\$0.00	\$0.00
58	*****	HYDRAULIC SEEDING, CLASS 1A	SQ YD	9.0	\$0.00	\$0.00
59	78000200	THERMOPLASTIC PAVEMENT MARKING, LINE 4 IN	LIN FT	49.0	\$0.00	\$0.00
60	*****	CONSTRUCTION SIGNS	SQ FT	64.0	\$0.00	\$0.00
61	*****	PREMOLDED RUBBER SPEED HUMPS	EACH	6.0	\$0.00	\$0.00
62	*****	REMOVE AND SALVAGE SIGN PANEL AND POLE ASSEMBLY	EACH	0.0	\$0.00	\$0.00
63	*****	CURB PAINTING	LIN FT	0.0	\$0.00	\$0.00
64	CDOT SP 905-1	MEMBRANE WATERPROOFING SYSTEM	SQ FT	0.0	\$0.00	\$0.00
	·			·		


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PLOT DATE = 7/1/2025	DATE -	07/01/2025	ISSUED FOR BID - 07/10/2025

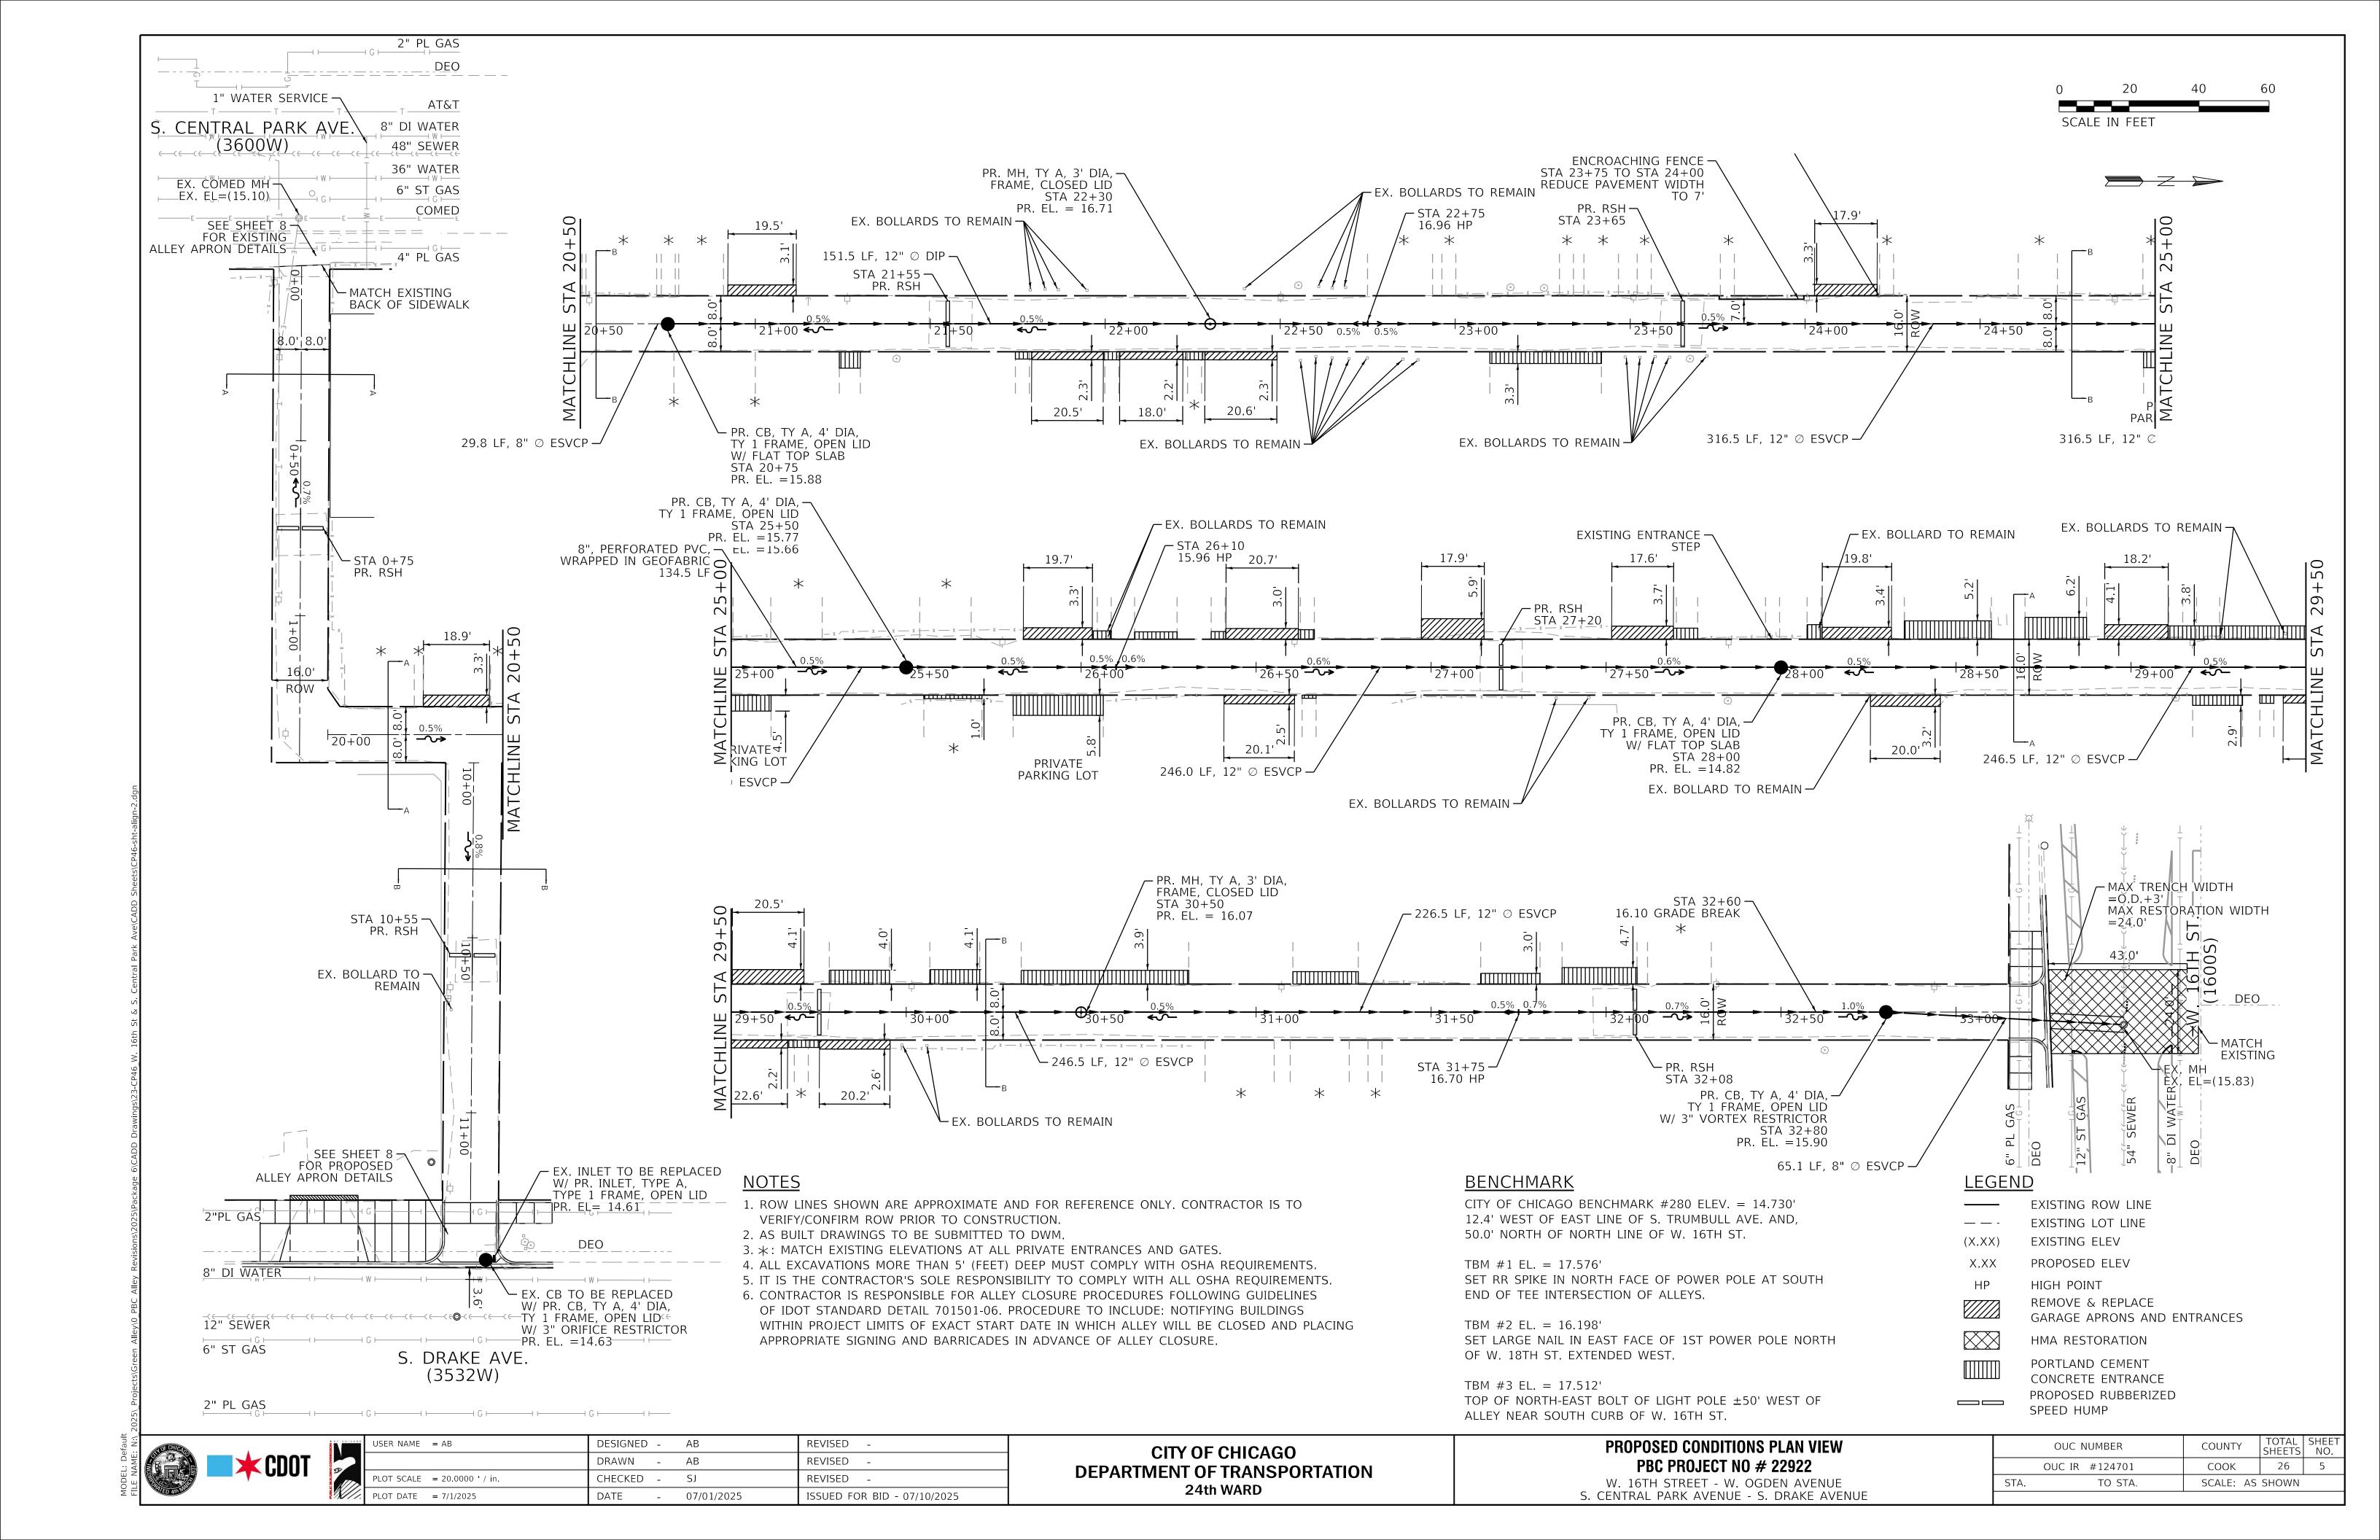


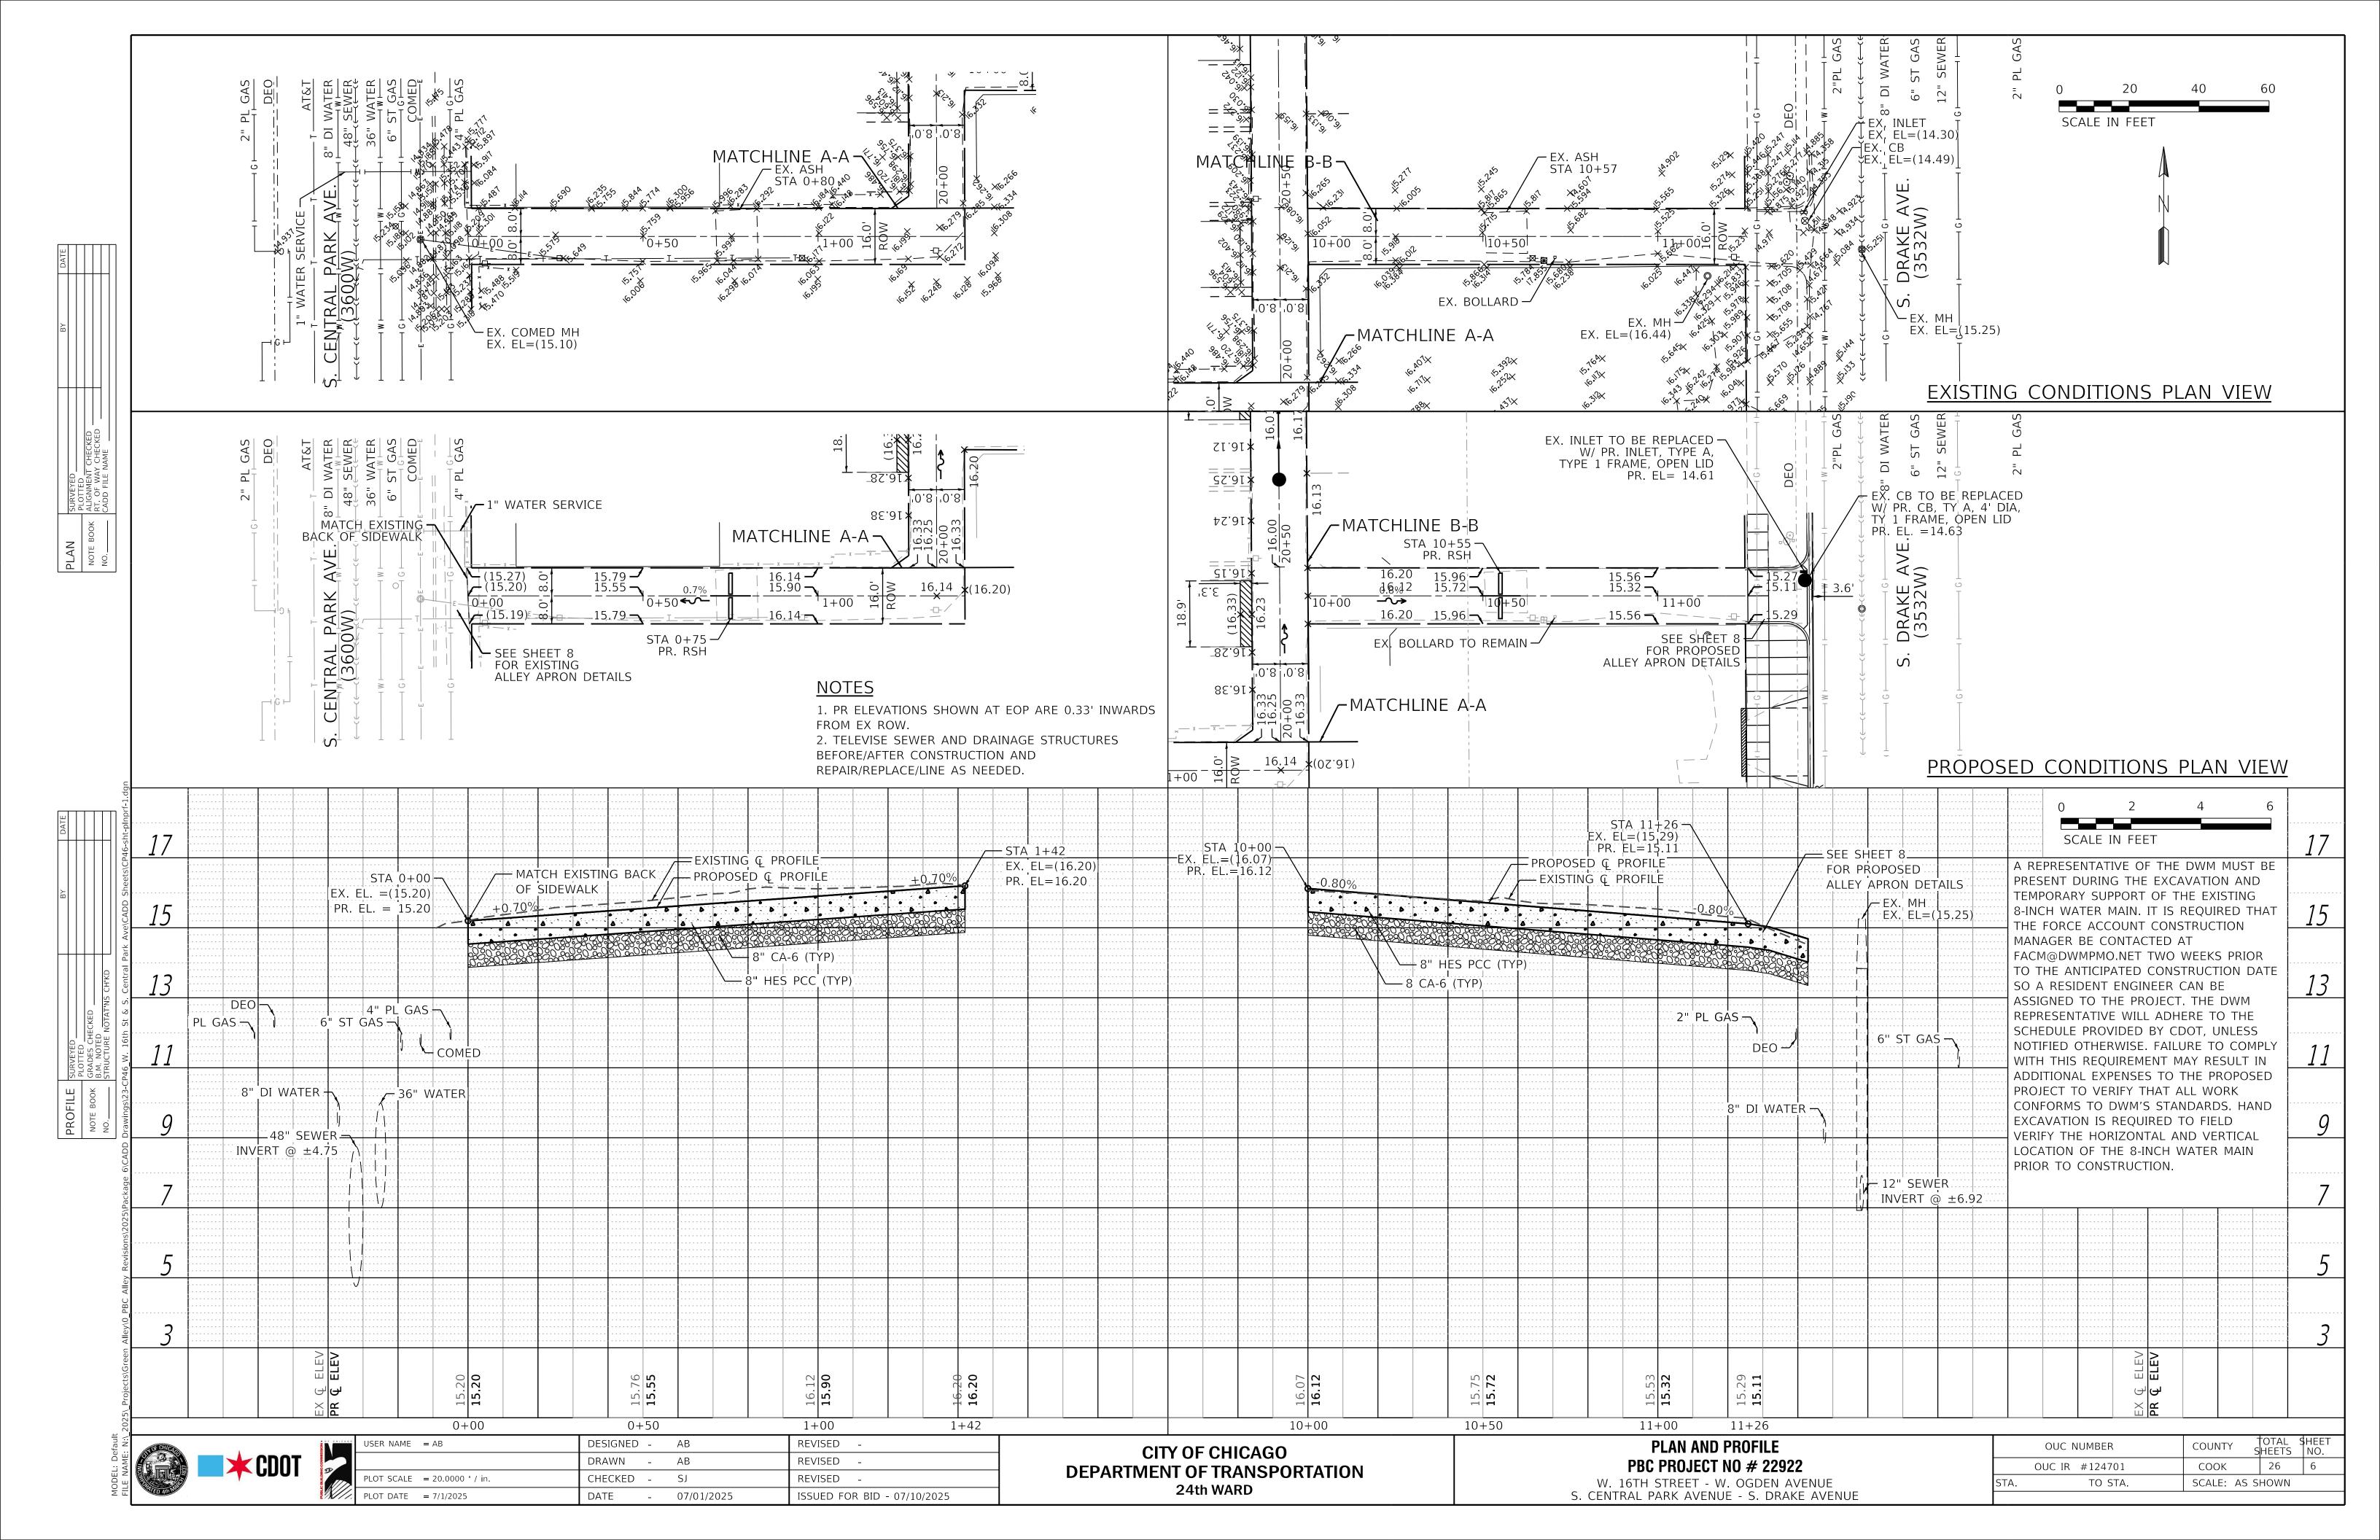


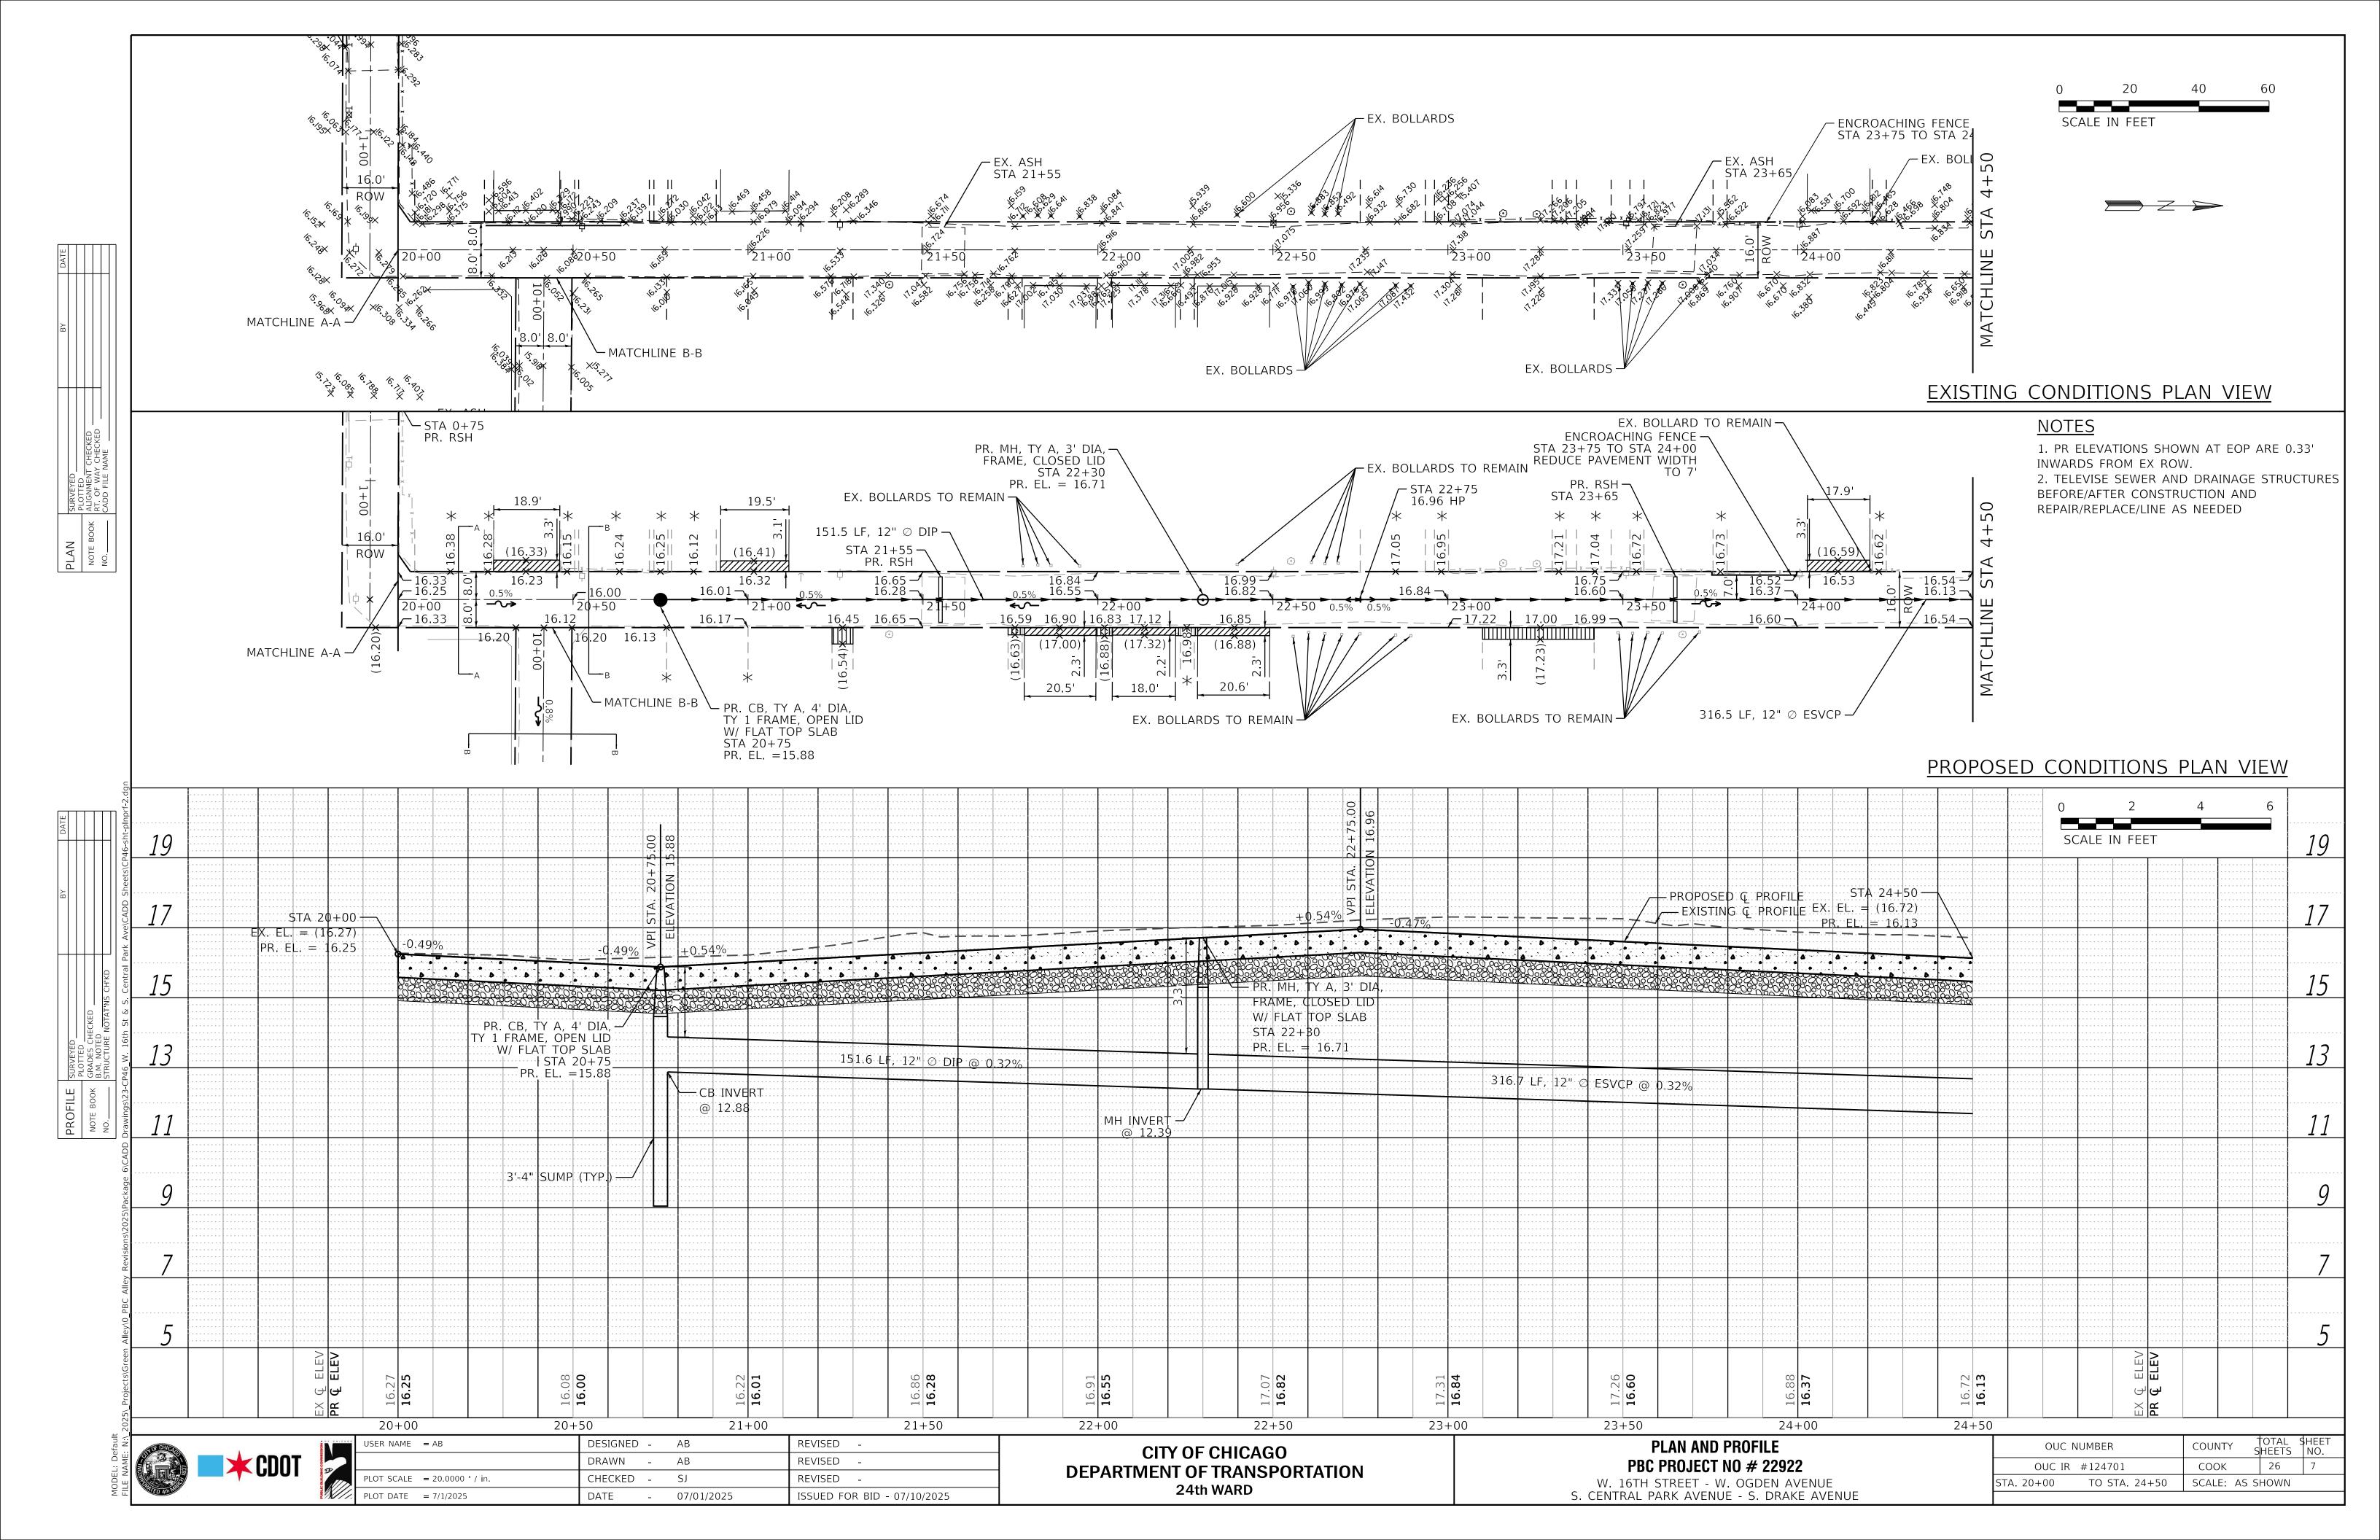

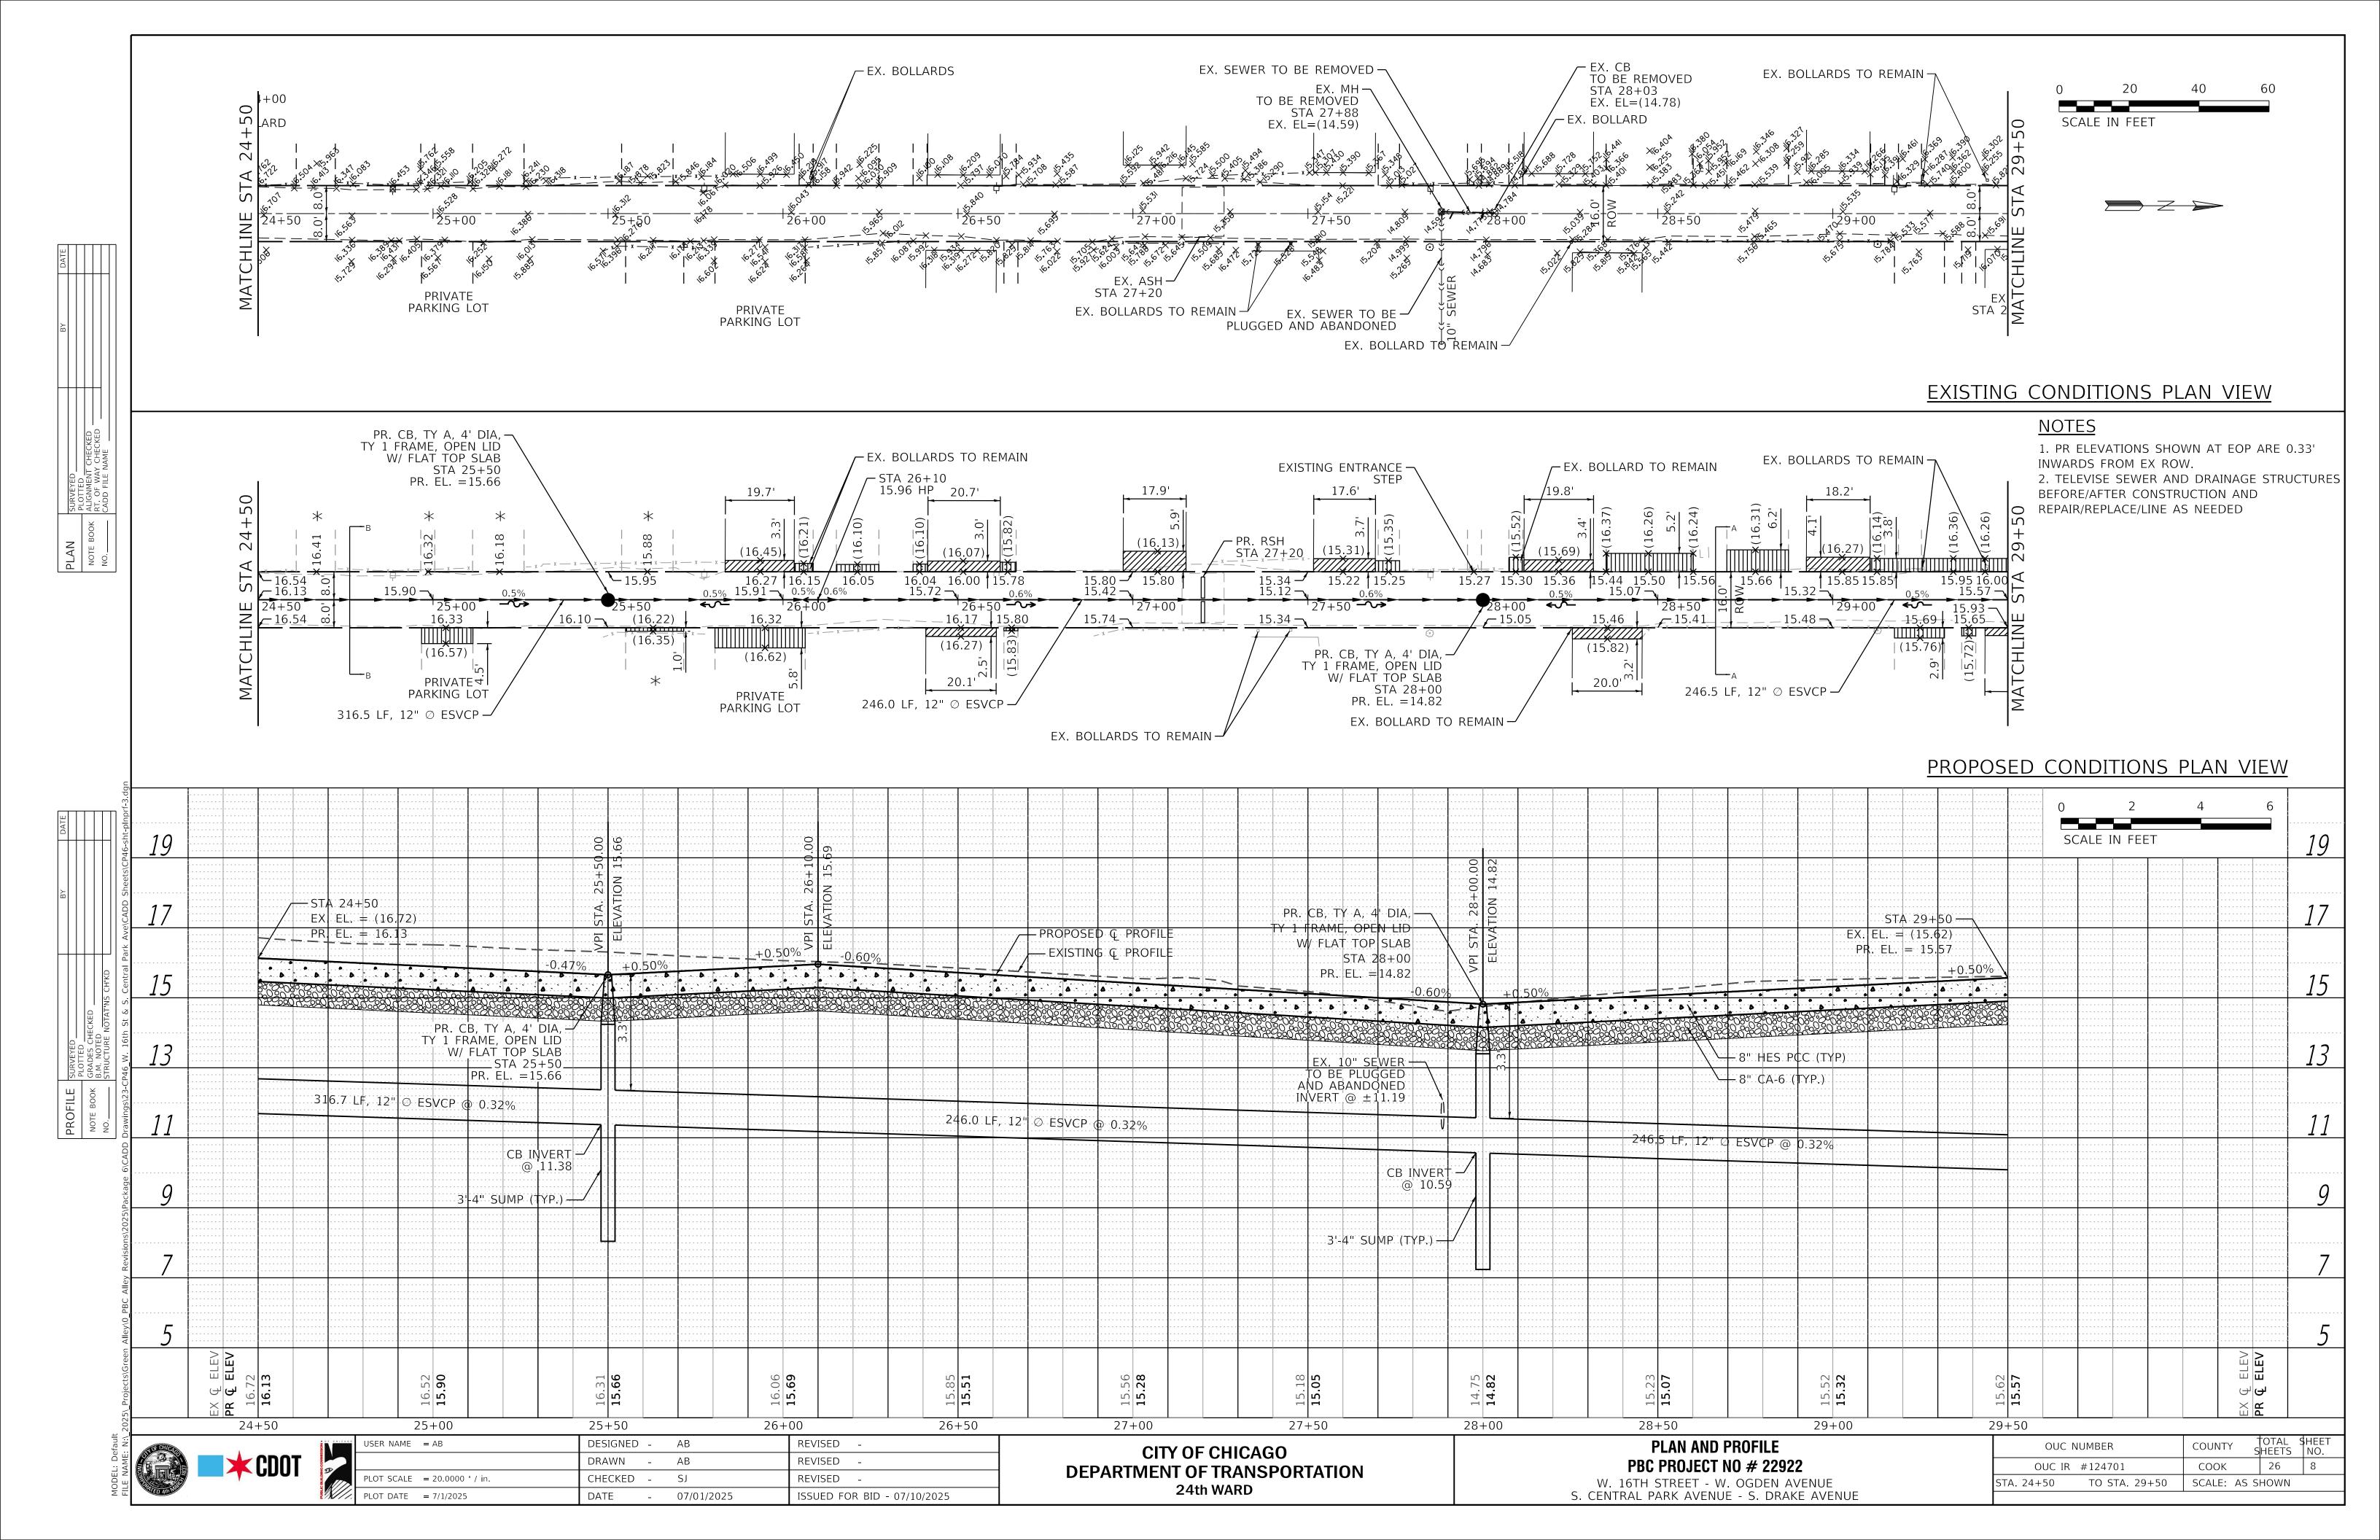


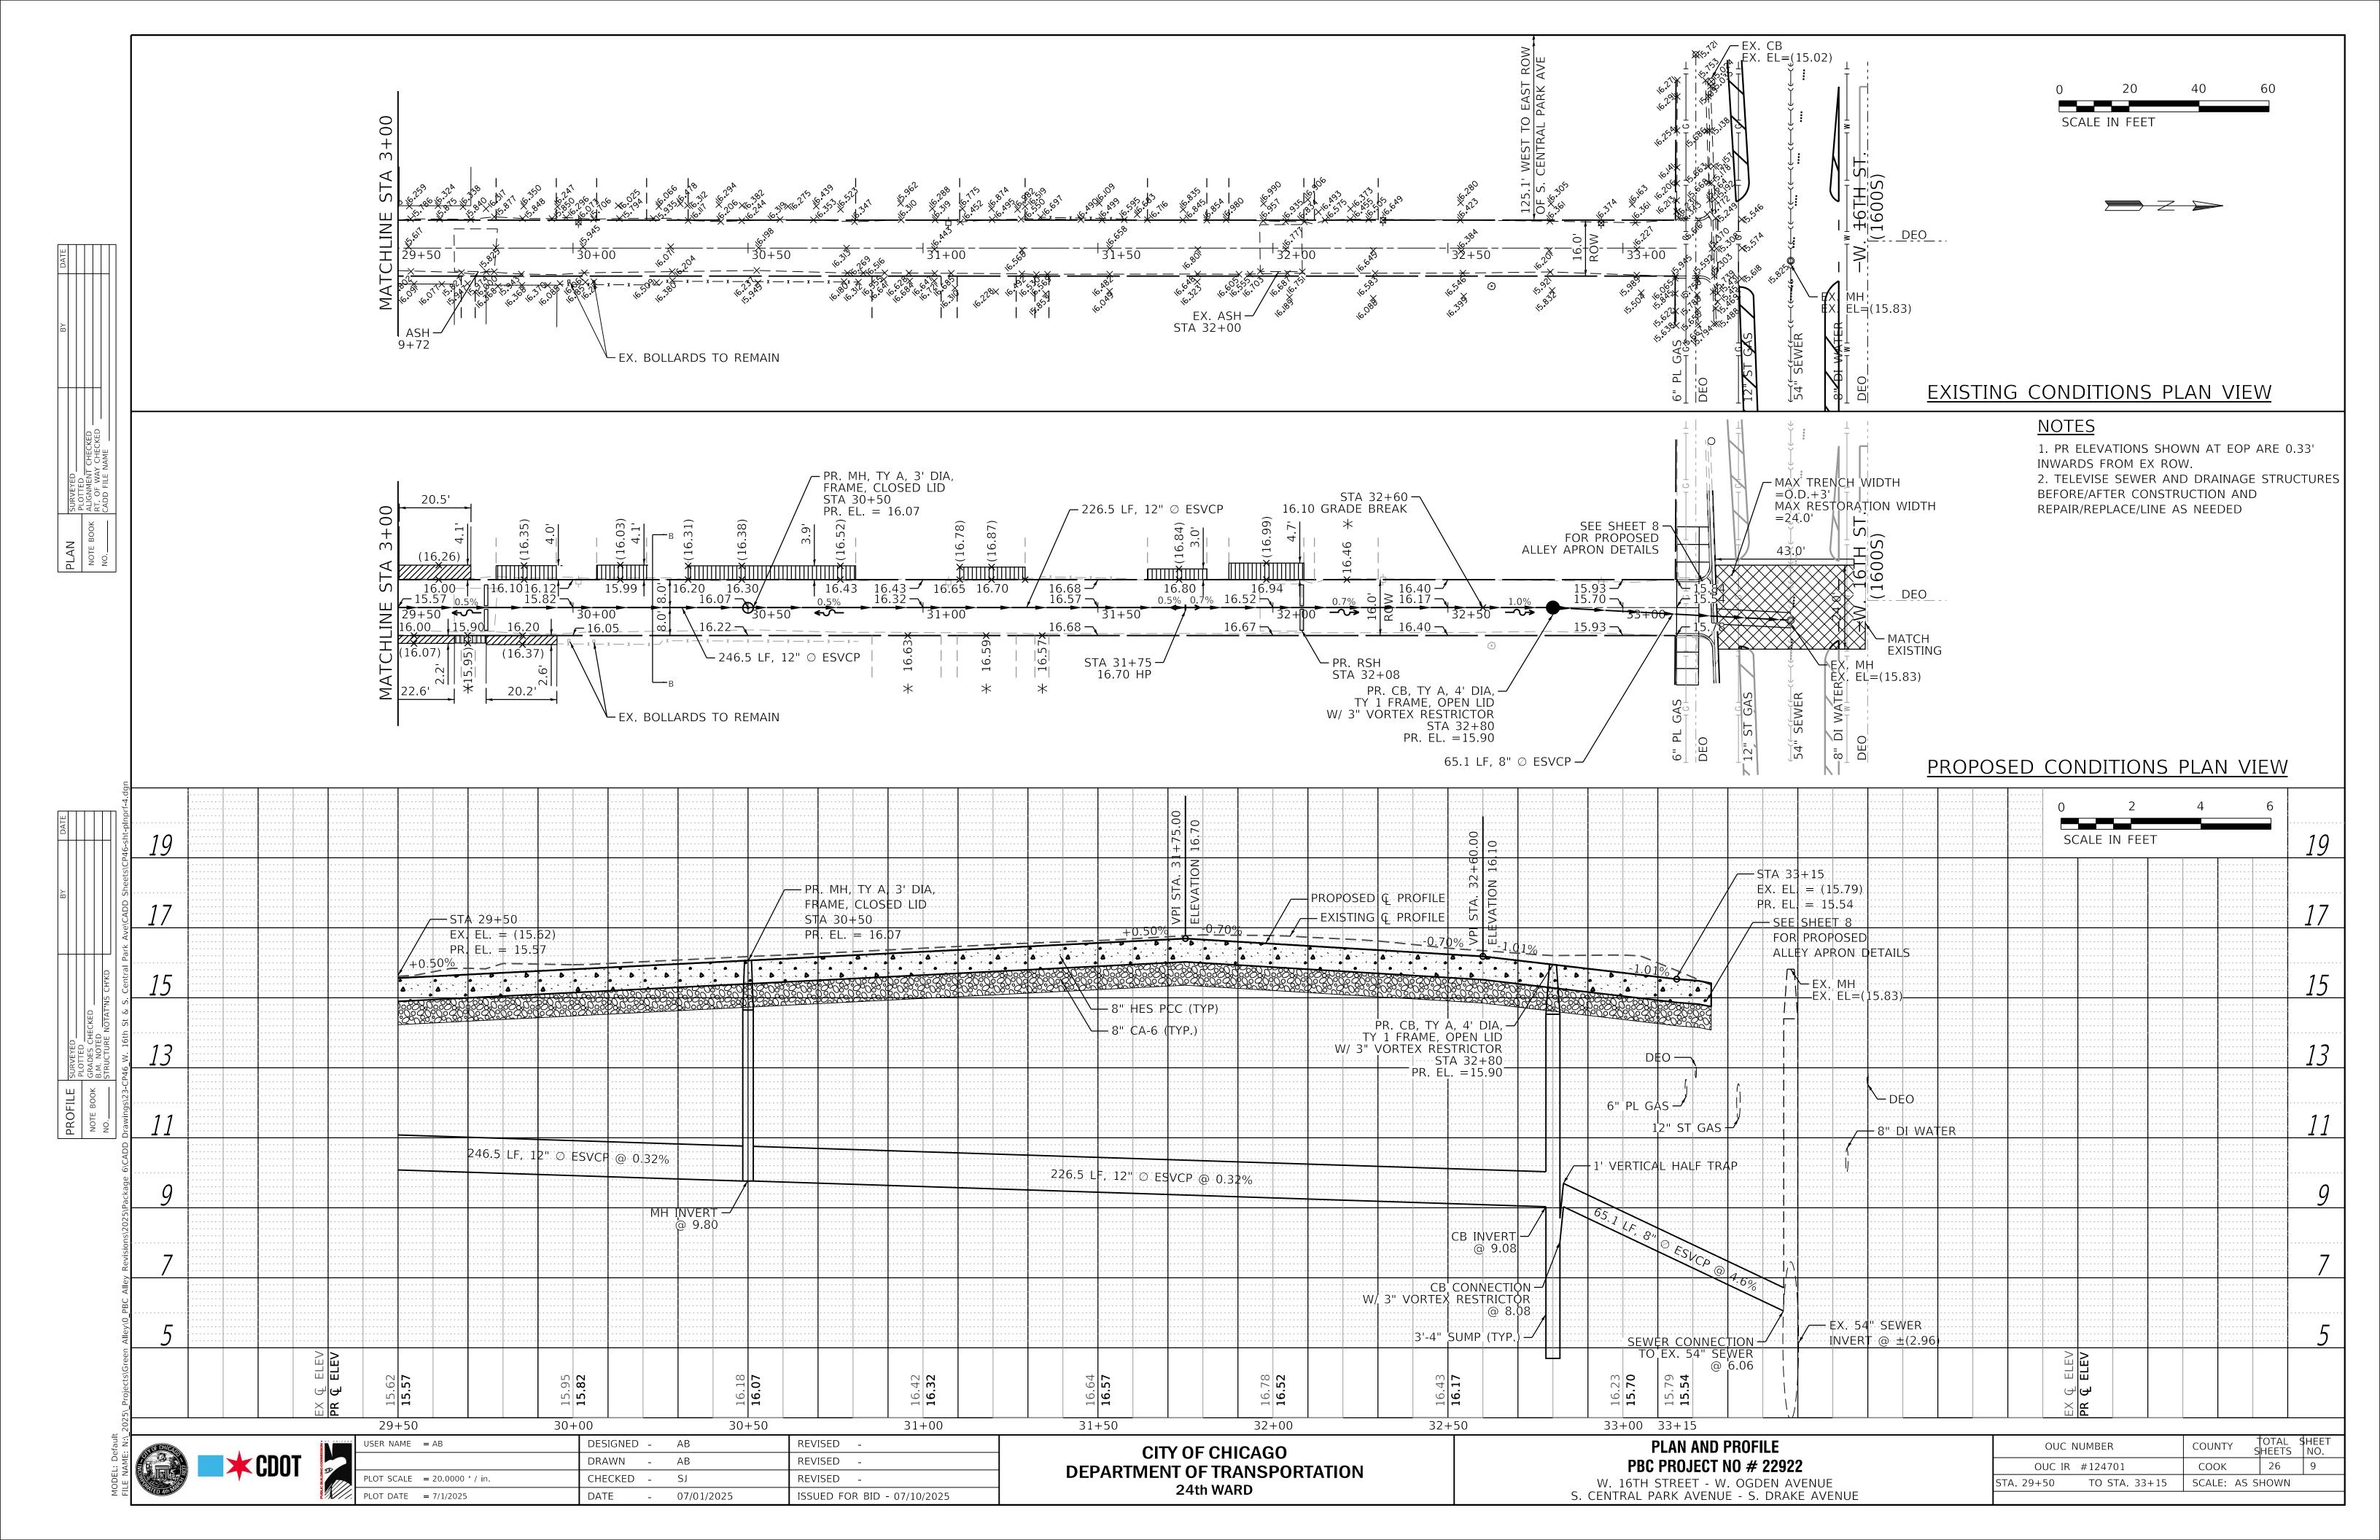

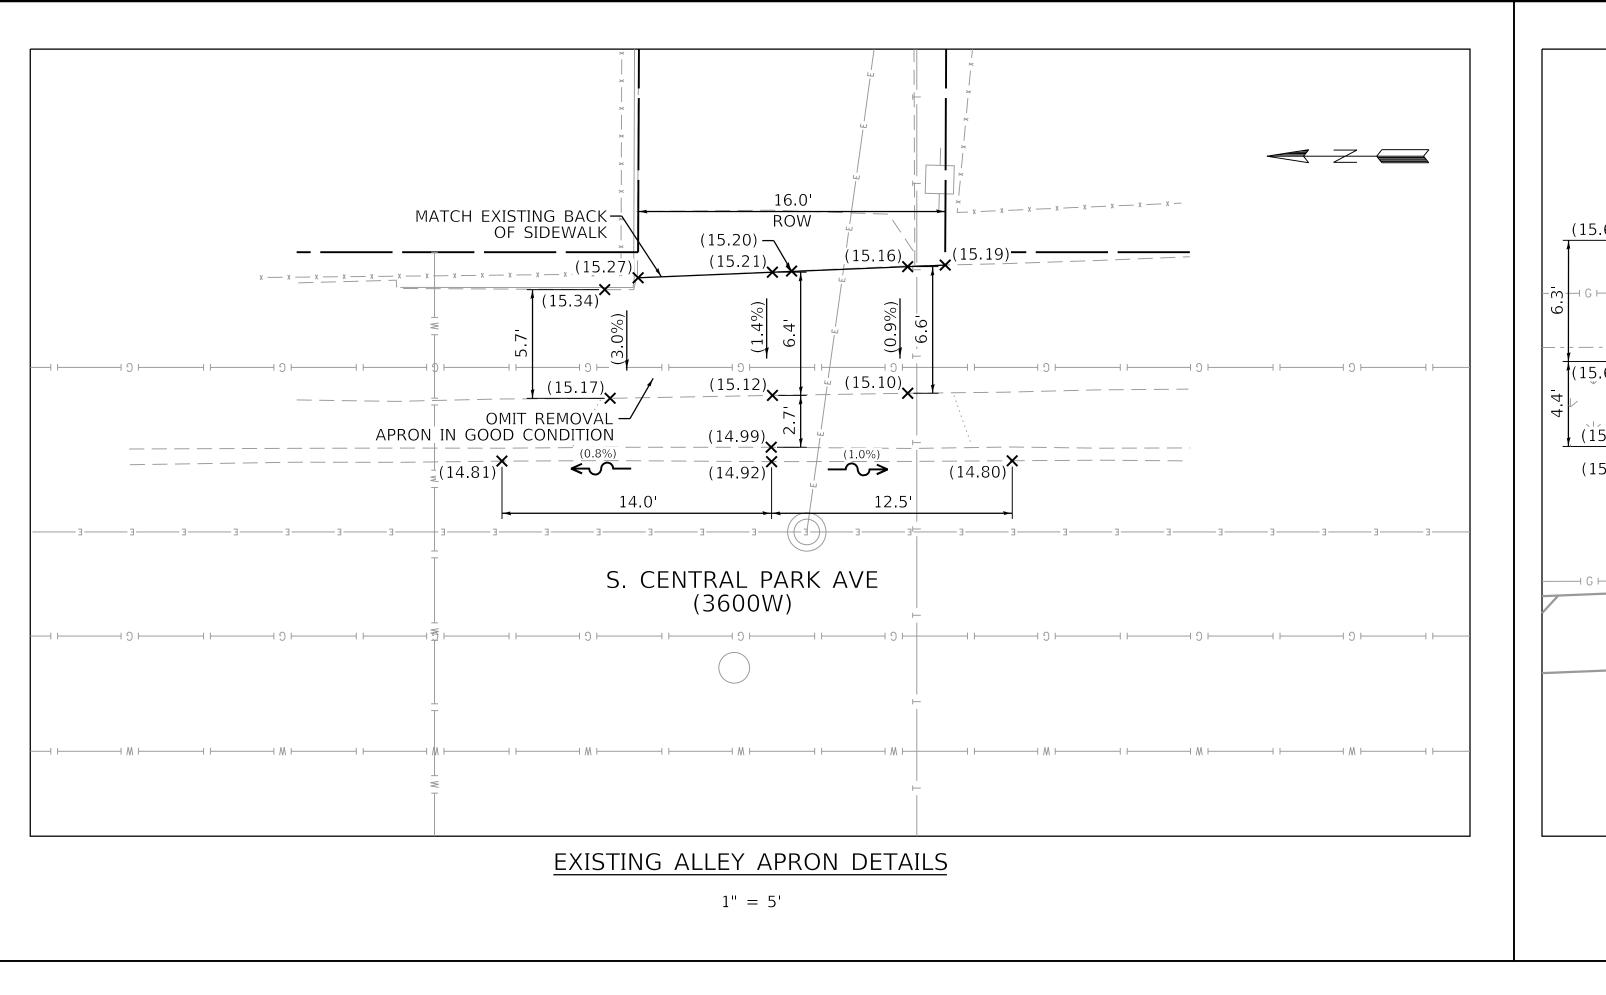

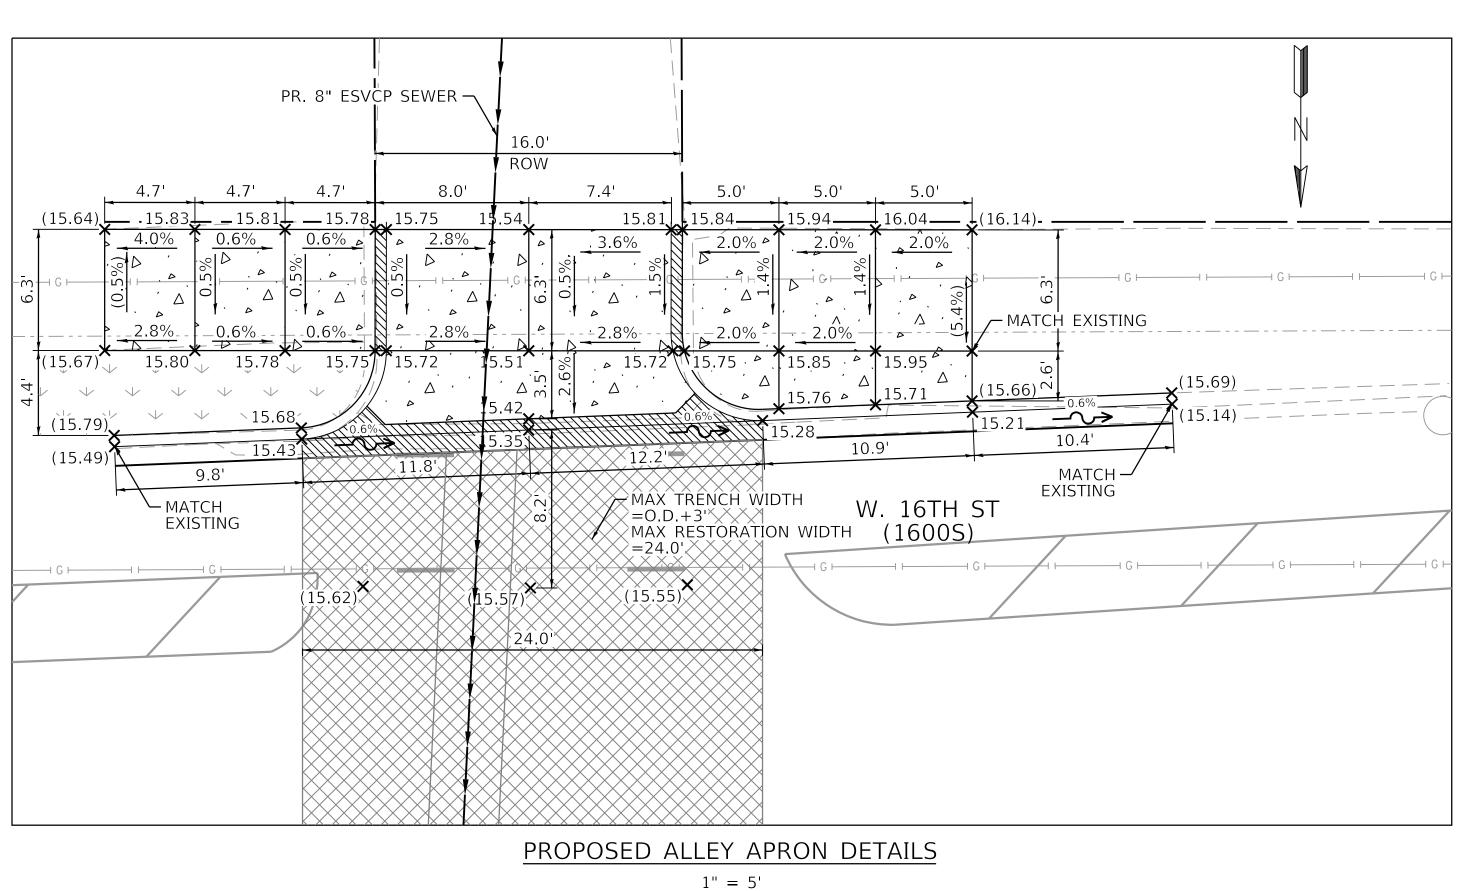

NOTE: ALLEY RETURN WILL BE CONSTRUCTED IN PCC PAVEMENT. USE HES PCC BASE COURSE AT T3 ALLEYS/DRIVEWAYS.

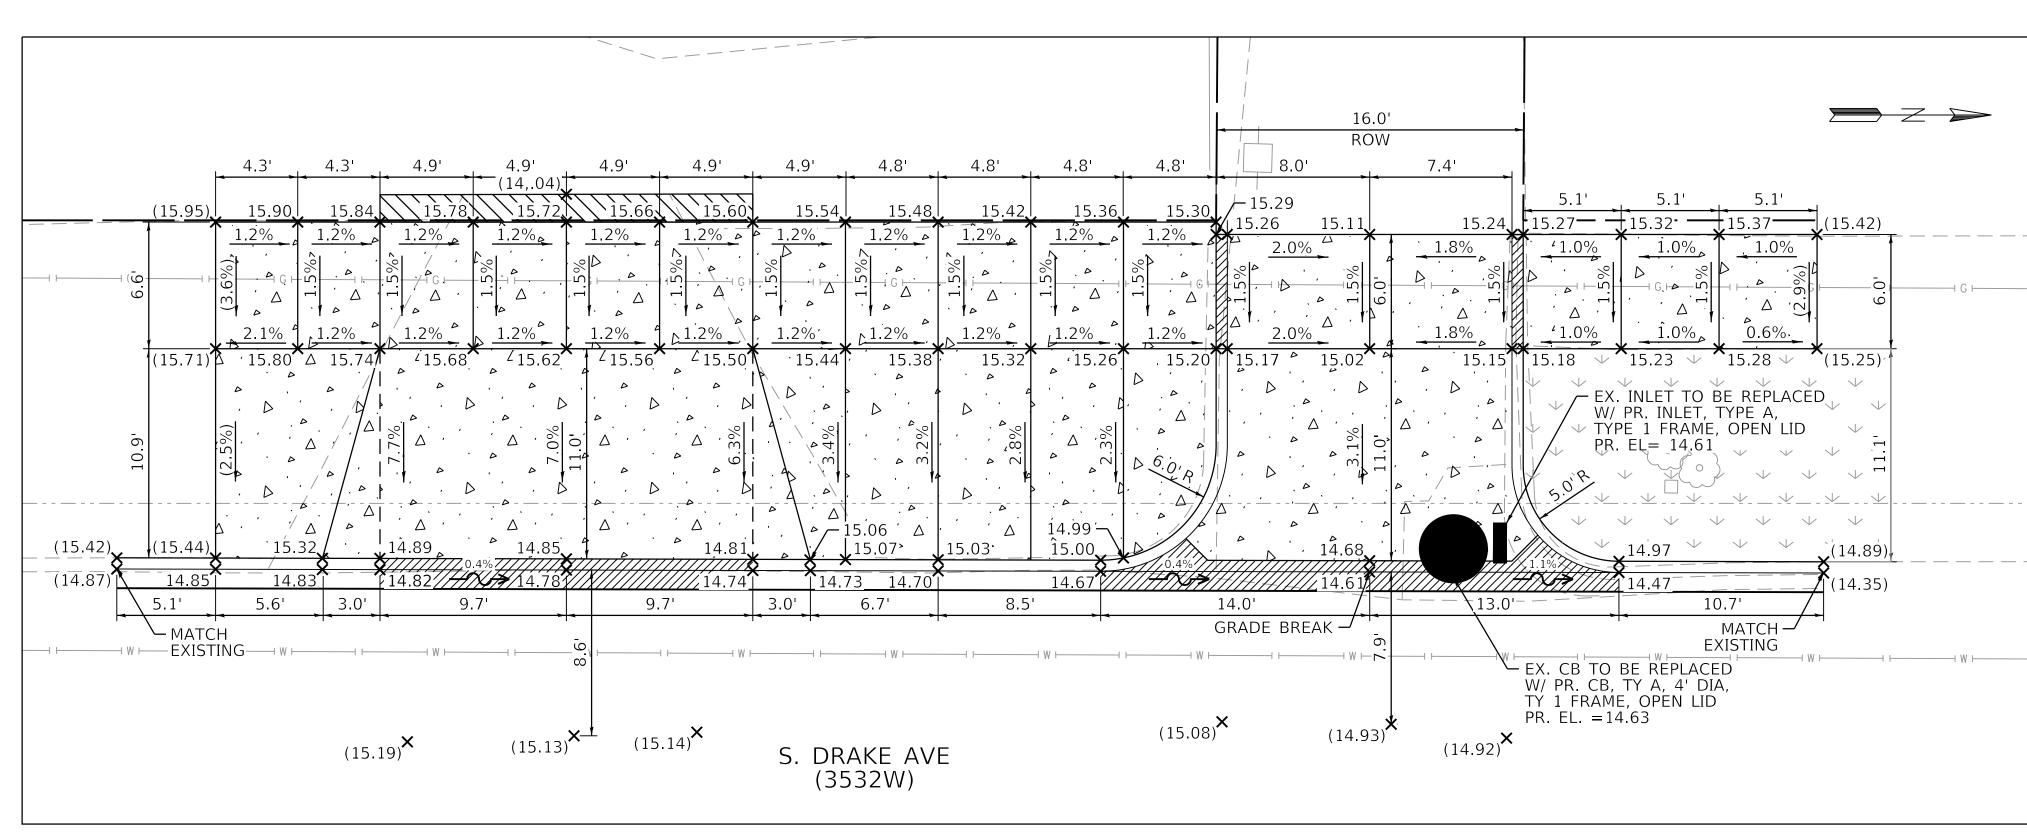

# PROPOSED ALLEY APRON DETAILS 1" = 5'

NOTE: ALLEY RETURN WILL BE CONSTRUCTED IN PCC PAVEMENT. USE HES PCC BASE COURSE AT T3 ALLEYS/DRIVEWAYS.




CHICAGO	USER NAME = AB	DESIGNED -	AB	REVISED -
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	PLOT SCALE = 5.0000 ' / in.	CHECKED -	SJ	REVISED -
	PLOT DATE = 7/1/2025	DATE -	07/01/2025	ISSUED FOR BID - 07/10/2025

## CITY OF CHICAGO DEPARTMENT OF TRANSPORTATION 24th WARD


ALLEY APRON DETAILS  PBC PROJECT NO # 22922			
W. 16TH STREET - W. OGDEN AVENUE S. CENTRAL PARK AVENUE - S. DRAKE AVENUE			

OUC NUMBER		COUNTY	SHEETS	NO.
	OUC IR #124701	COOK	26	10
STA.	TO STA.	SCALE: AS	SHOWN	

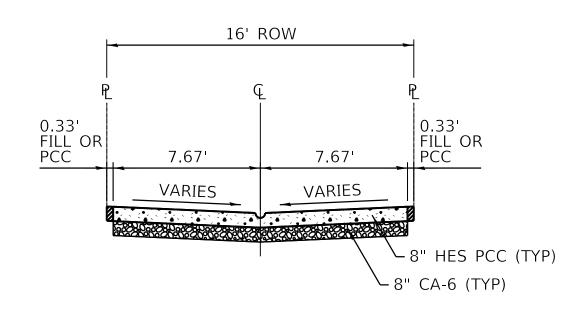

## PROPOSED TYPICAL CROSS SECTION A-A


STA. 0+00 TO STA. 1+42 STA. 10+00 TO STA. 11+26 STA. 20+00 TO STA. 20+75

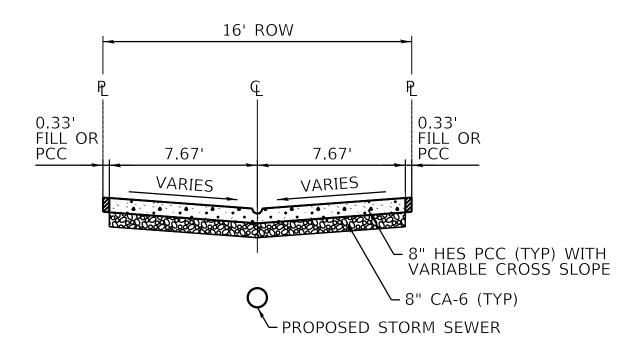


## PROPOSED TYPICAL CROSS SECTION B-B

STA. 20+75 TO STA. 33+15


NOTE: 0.33' FILL OR PCC WILL BE PAID FOR AS CONCRETE ALLEY FILL, CA-1 OR 8" HES PCC ALLEY PAVEMENT.

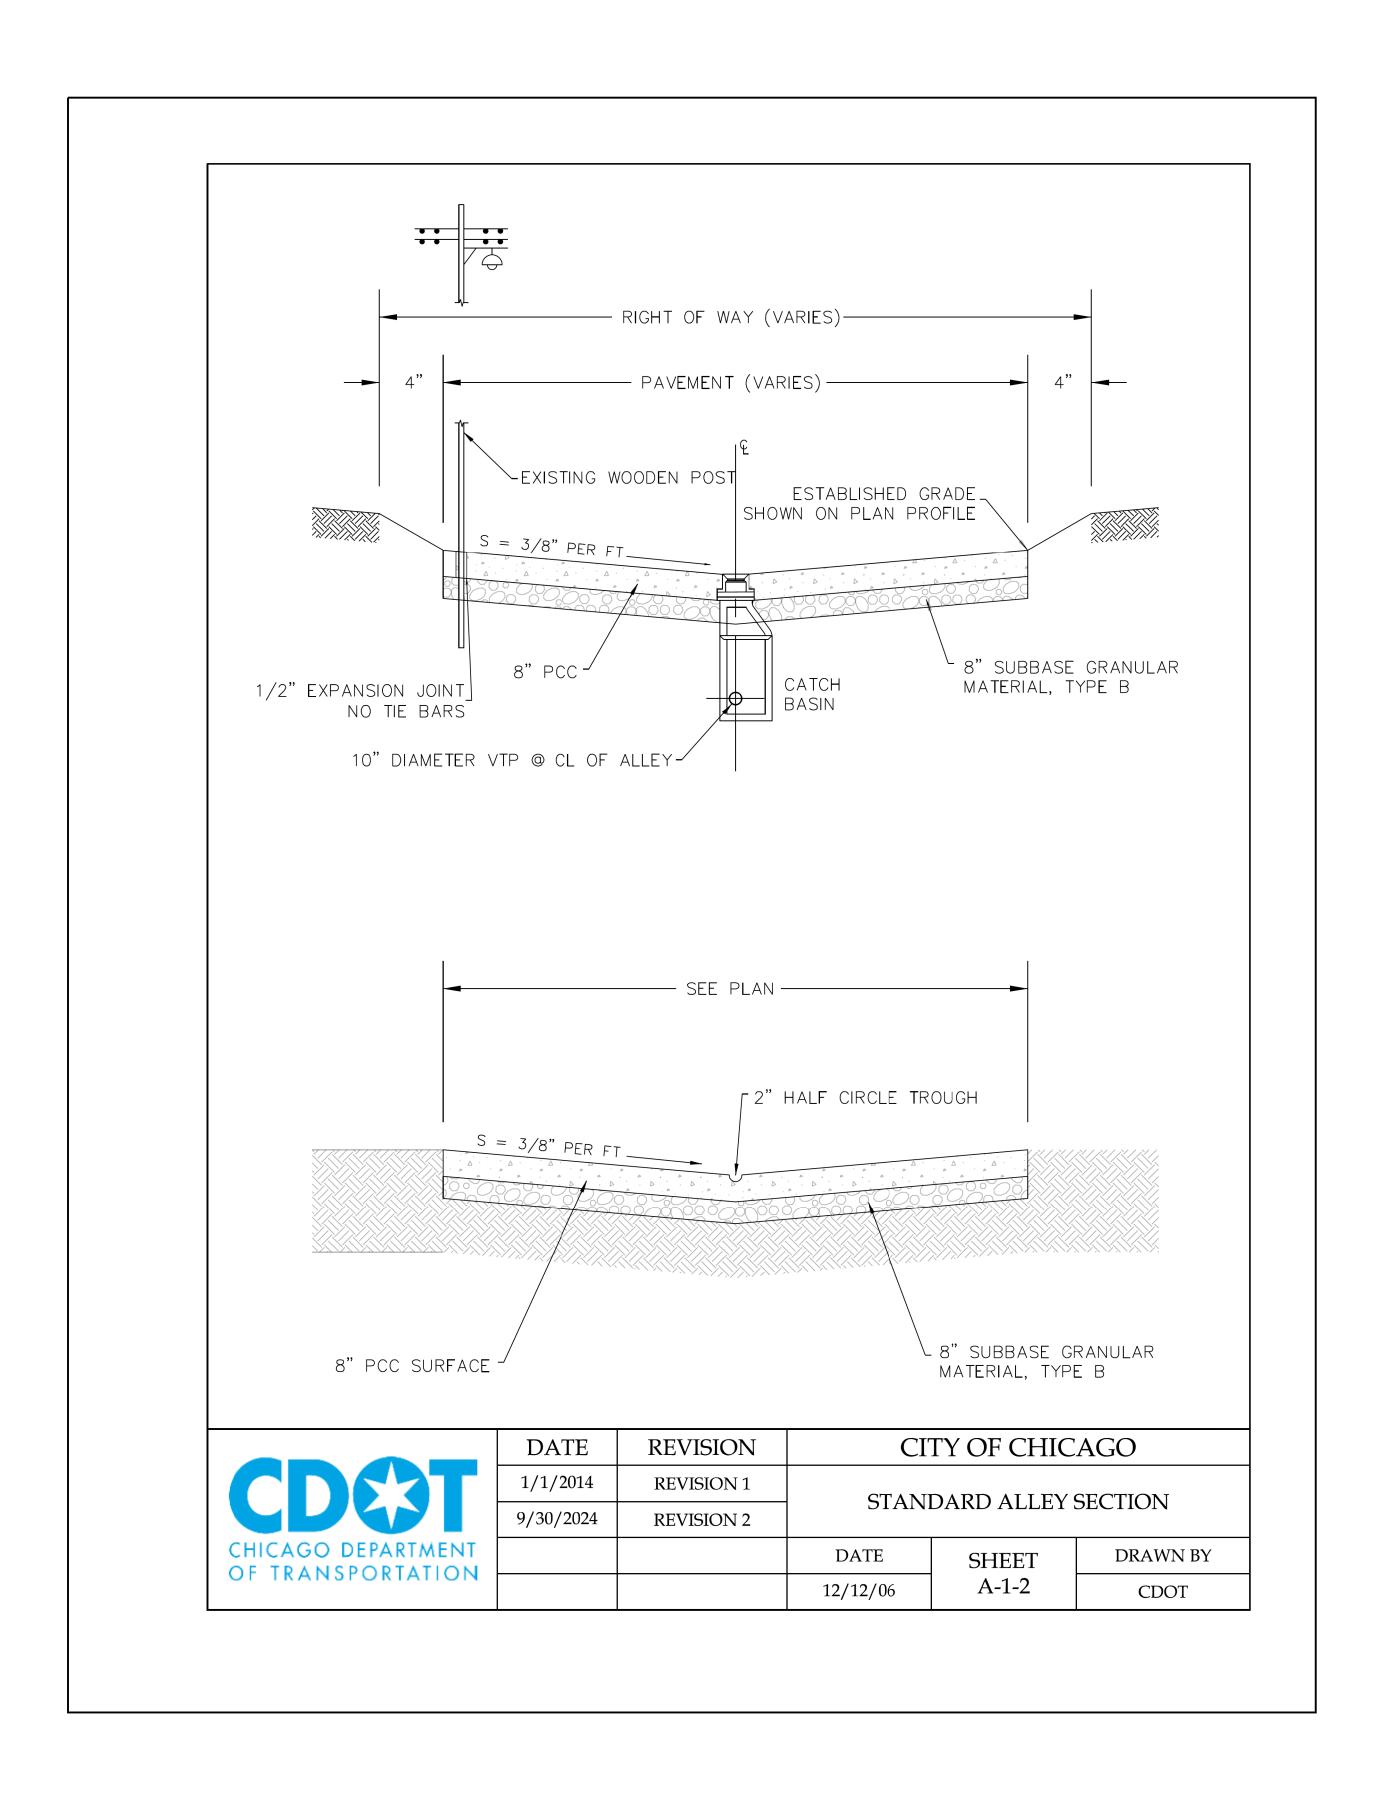

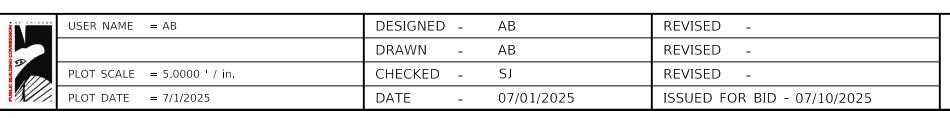


TOTAL SHEET SHEETS NO.

26 11

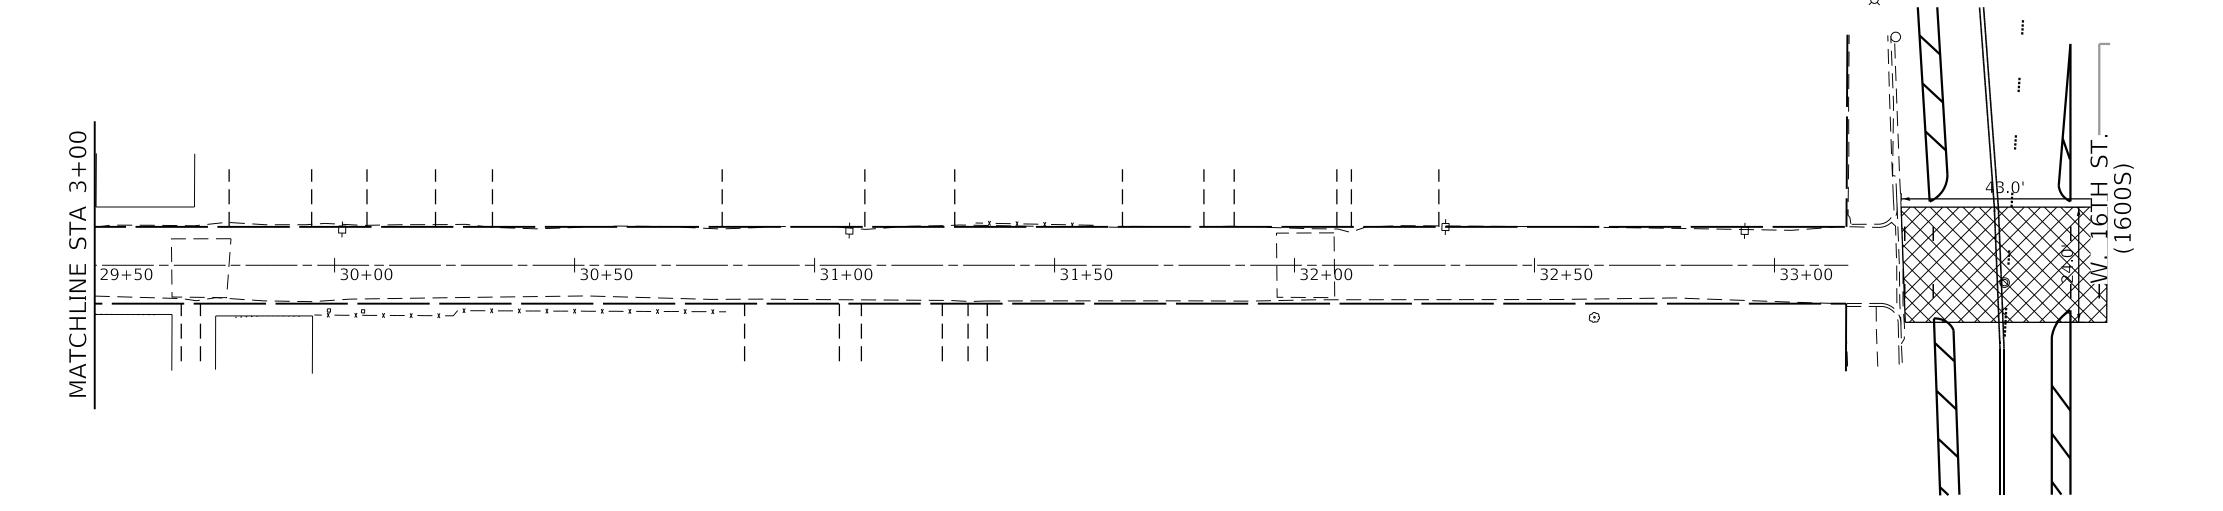

# EXISTING CONDITIONS PLAN VIEW

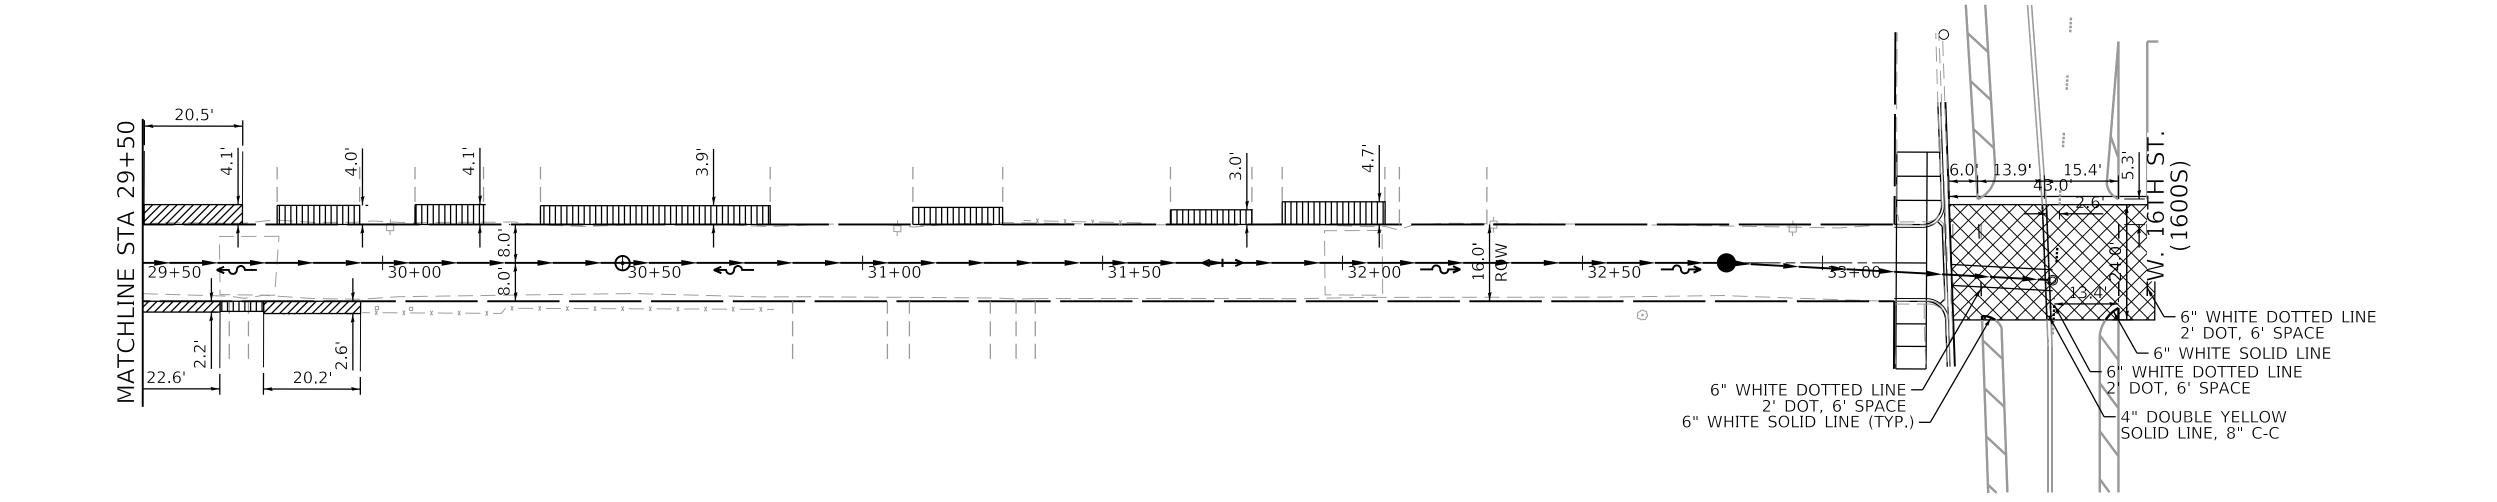


## PROPOSED CONDITIONS PLAN VIEW



CHICAGO	USER NAME = AB	DESIGNED -	АВ	REVISED -
ED		DRAWN -	АВ	REVISED -
	PLOT SCALE = 20.0000 ' / in.	CHECKED -	SJ	REVISED -
	PLOT DATE = 7/1/2025	DATE -	07/01/2025	ISSUED FOR BID - 07/10/2025


	OUC NUMBER	COUNTY	SHEETS	SHEET NO.
	OUC IR #124701	COOK	26	12
STA.	TO STA.	SCALE: NT	S	

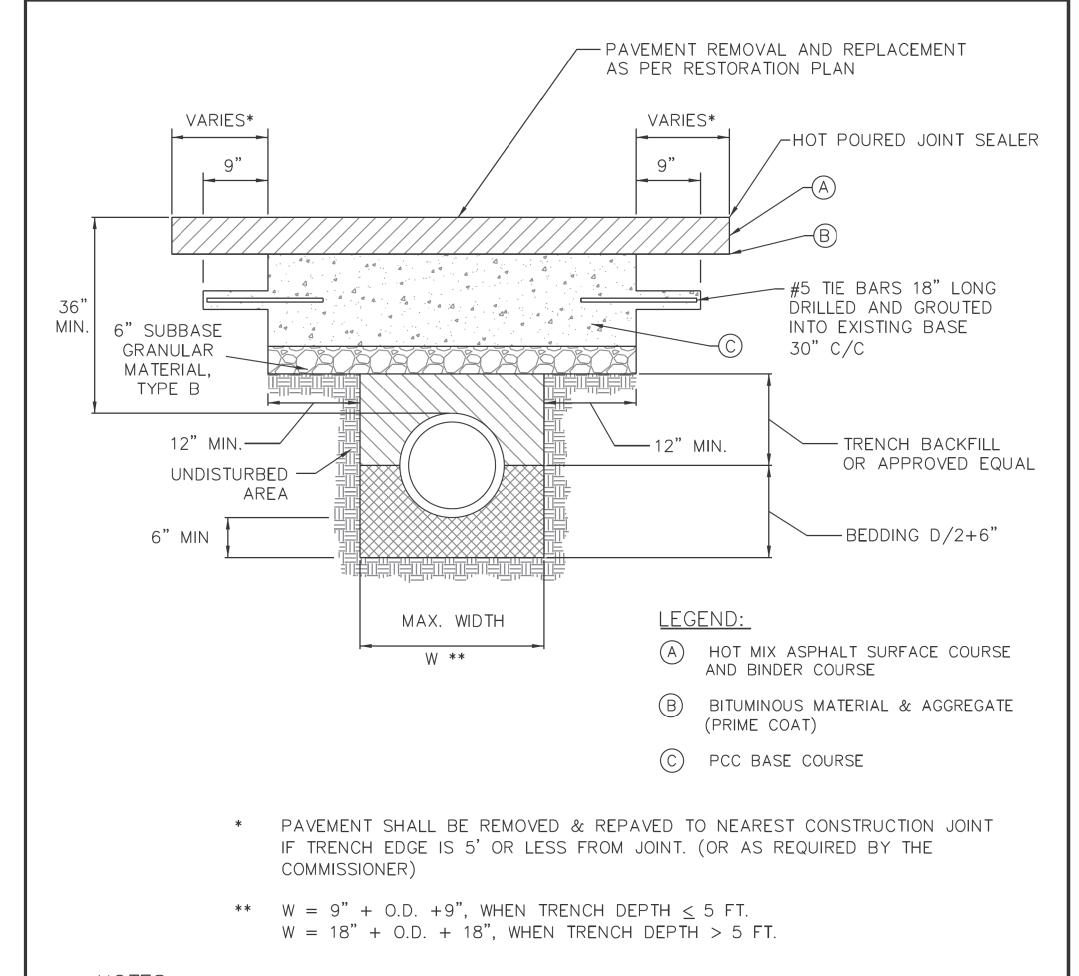

## NOTES:

- 1. THE PORTLAND CEMENT CONCRETE BASE SHALL BE 8" OR MORE (SEE SECTION 4.2b FOR REQUIRED THICKNESS). FOR CONCRETE STREETS THE CONCRETE SHALL BE BROUGHT TO GRADE (INCLUDING 1'-0" OVERLAP) AND FINISHED AS REQUIRED IN THE IDOT SSRBC.
- 2. ALL EXISTING PAVEMENTS SHALL BE SAW CUT 1'-0" ON BOTH SIDES OF THE TRENCH OR PAVEMENT OPENING. UNDER NO CIRCUMSTANCES SHOULD EXISTING PAVEMENT, WHICH HAS BEEN UNDERMINED OR OTHERWISE DISTURBED, BE LEFT IN PLACE AND NOT RESTORED.
- 3. ALL STREET PAVEMENT WILL REQUIRE PLACEMENT OF #5 TIE BARS, 18 INCHES LONG DRILLED AND GROUTED (NON SHRINK) AT 30" CENTERS ON ALL SIDES. A MINIMUM OF TWO TIE BARS WILL BE REQUIRED ON EACH SIDE OF SAW CUT BOUNDARIES.
- 4. ALL TIE BARS AND DOWEL BARS ARE TO BE EPOXY COATED (INCIDENTAL).

	DATE	REVISION	CITY OF CHICAGO			
CDCT	1/1/2014	REVISION 1	STREET PAVEMENT RESTORATION DETAIL WITH TRENCH BACKFILL			
	1/27/2016	REVISION 2				
CHICAGO DEPARTMENT OF TRANSPORTATION			DATE	SHEET	DRAWN BY	
			12/12/06	A-2-2A	CDOT	

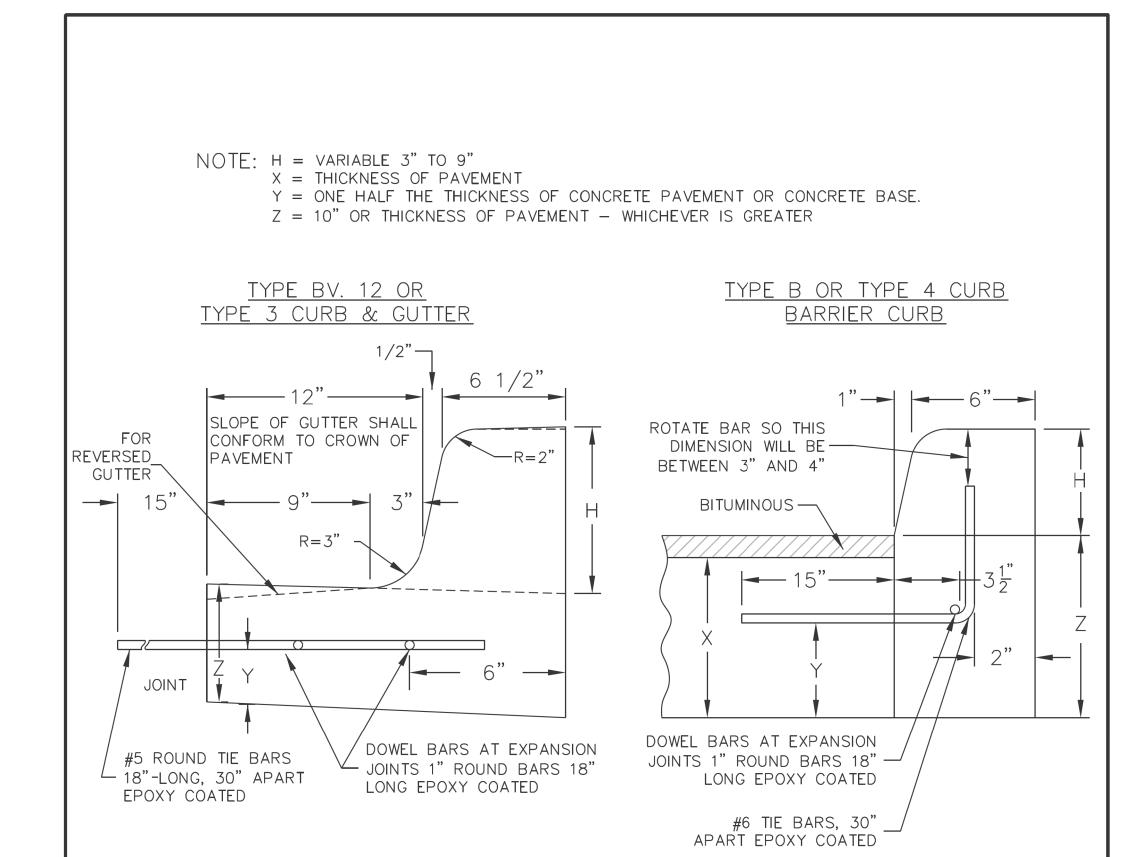


#### JOINTS IN CURB, COMBINED CURB & GUTTER

TRANSVERSE JOINTS OF A TYPE SIMILAR TO THAT USED IN THE ADJACENT PAVEMENT SHALL BE INSTALLED IN THE CURB, GUTTER AND COMBINED CURB & GUTTER IN PROLONGATION WITH THE JOINTS IN THE PAVEMENT. THE DETAILS OF THE TRANSVERSE JOINTS IN THE CURB, GUTTER AND COMBINED CURB & GUTTER SHALL BE APPROVED BY THE COMMISSIONER. CURB, GUTTER OR COMBINED CURB & GUTTER IS CONSTRUCTED ADJACENT TO A FLEXIBLE BASE PAVEMENT, 1" THICK EXPANSION JOINTS COMPOSED OF BITUMINOUS PERFORMED JOINT FILLER SHALL BE INSTALLED IN THE CURB AND/OR GUTTER AT POINTS OF CURVATURE AND AT CONSTRUCTION JOINTS. CONTRACTION JOINTS SHALL ALSO BE PLACED BETWEEN THESE EXPANSION JOINTS AT DISTANCES NOT EXCEEDING 20 FEET. ALL TIE BARS SHALL BE DEFORMED—ALL DOWEL BARS SHALL BE SMOOTH.


NOTE: ALL TIE BARS AND DOWEL BARS TO BE EPOXY COATED.


\*AT LOCATIONS REQUIRING DEPRESSED CURBS SEE THE ADA STANDARDS FOR CONSTRUCTION DETAILS

	DATE	REVISION	CITY OF CHICAGO				
CDST	1/1/2014	REVISION 1	CONCRETE CURB & GUTTER				
	D			DETAIL			
CHICAGO DEPARTMENT OF TRANSPORTATION			DATE	SHEET	DRAWN BY		
			12/12/06	A-2-6	CDOT		

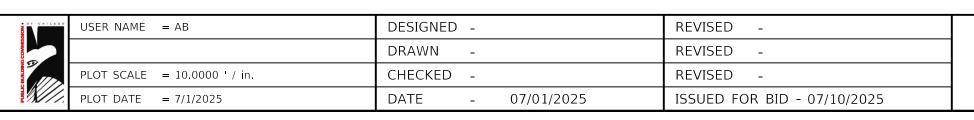

	OUC NUMBER	COUNTY	TOTAL SHEETS	SHEET NO.
	OUC IR #124701	COOK	26	13
STA.	TO STA.	SCALE: NTS	5	

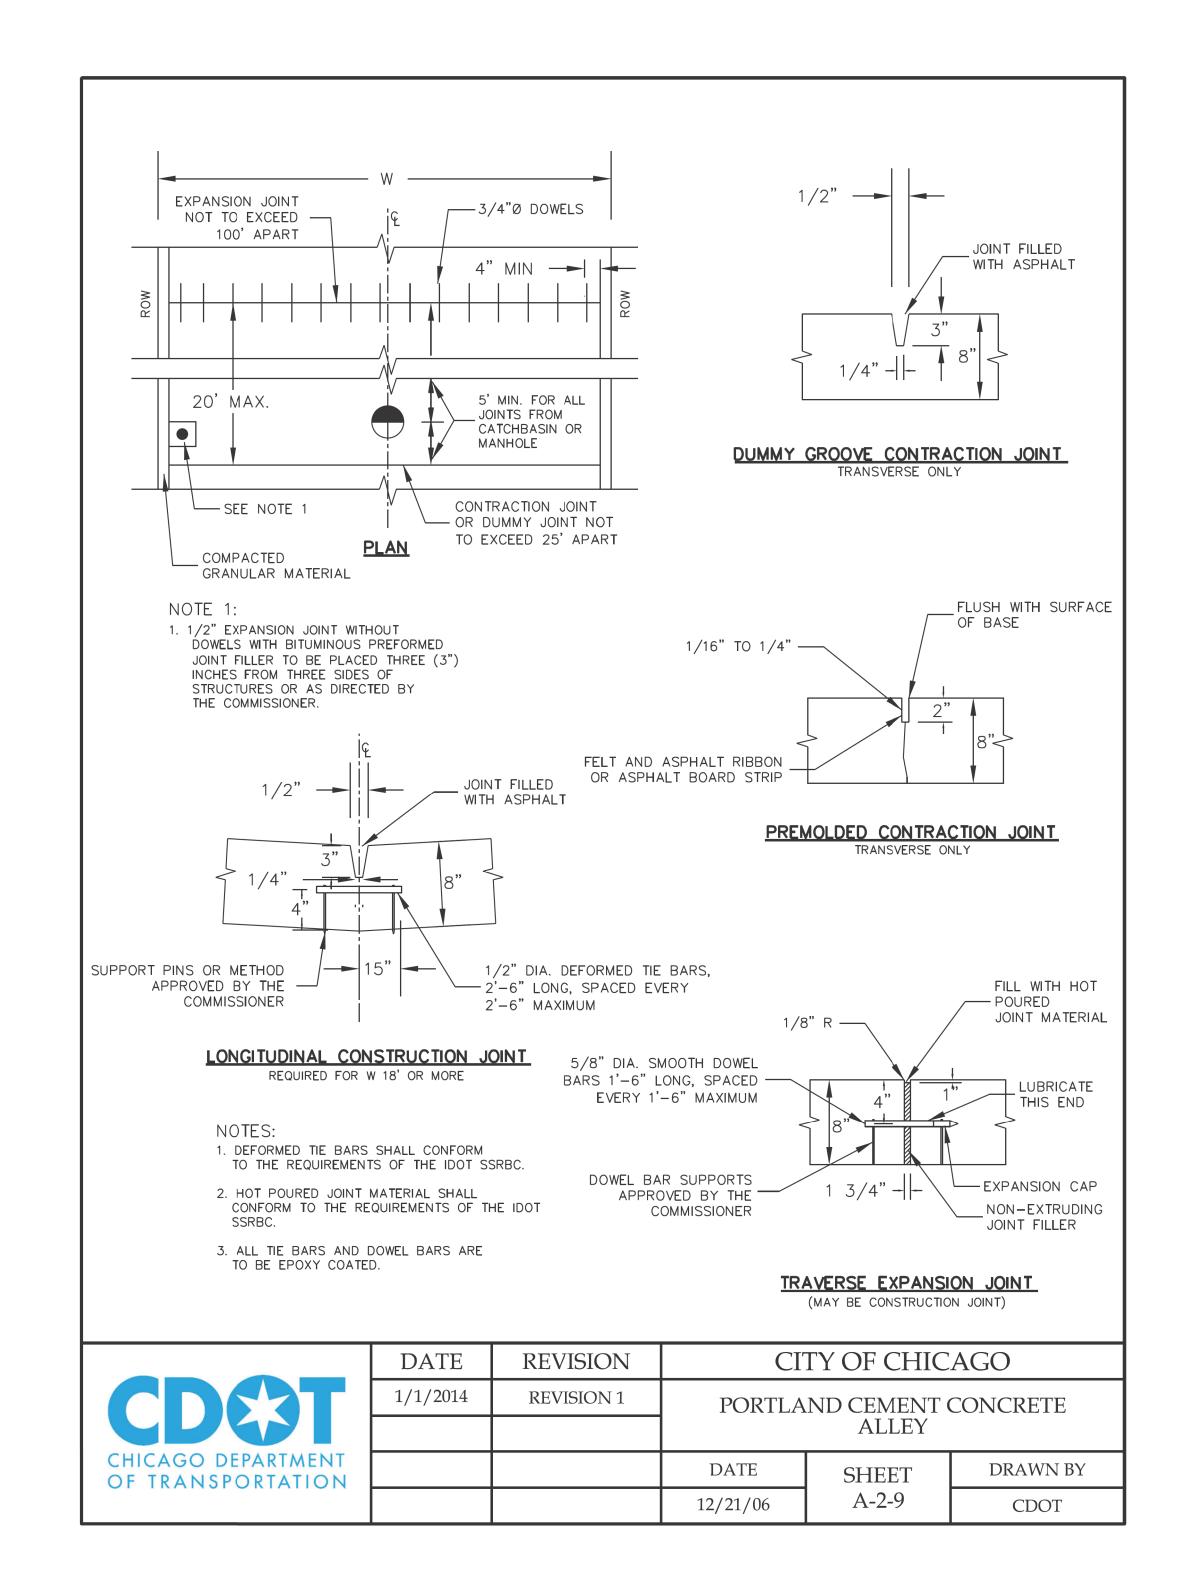

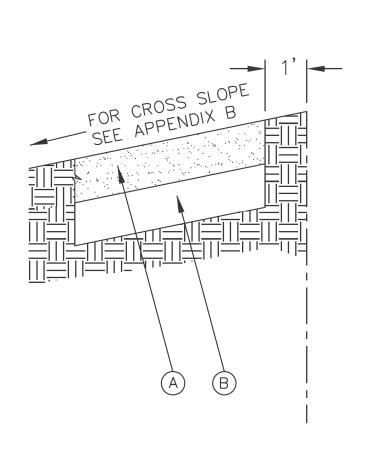

## LEGEND:


- A PROPOSED 5" P.C.C. SIDEWALK \*
- B SUBBASE GRANULAR MATERIAL, TYPE B OR C, 4"
  - \* CURB RAMP & KEYSTONE 8" P.C.C. AT SIGNALIZED AND INDUSTRIAL STREET INTERSECTIONS





	DATE	REVISION	CI	AGO		
	1/1/2014	REVISION 1	ADA COMPLIANT SIDEWALK CONSTRUCTION DETAILS			
7			DATE	SHEET	DRAWN BY	
			12/20/06	A-3-1	CDOT	




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		DRAWN -	REVISED -
	PLOT SCALE = 10.0000 ' / in.	CHECKED -	REVISED -
	PLOT DATE = 7/1/2025	DATE - 07/01/2025	ISSUED FOR BID - 07/10/2025

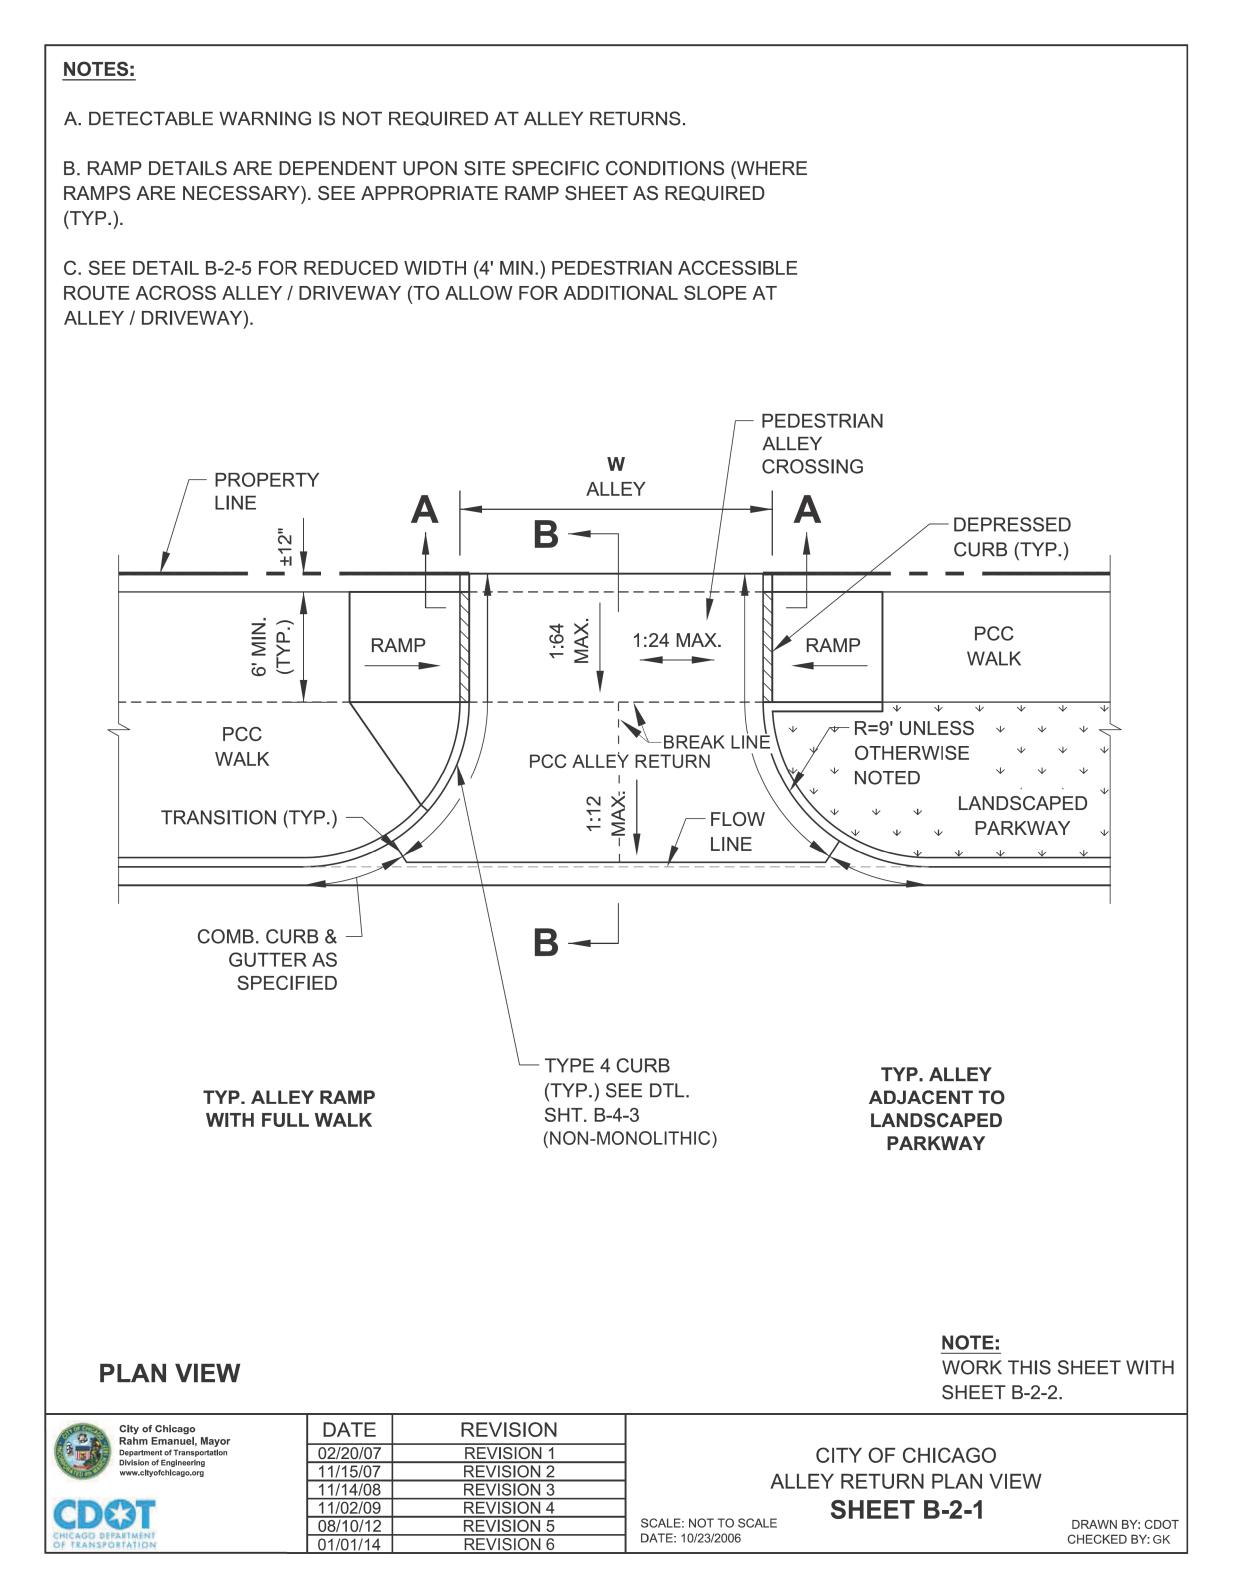

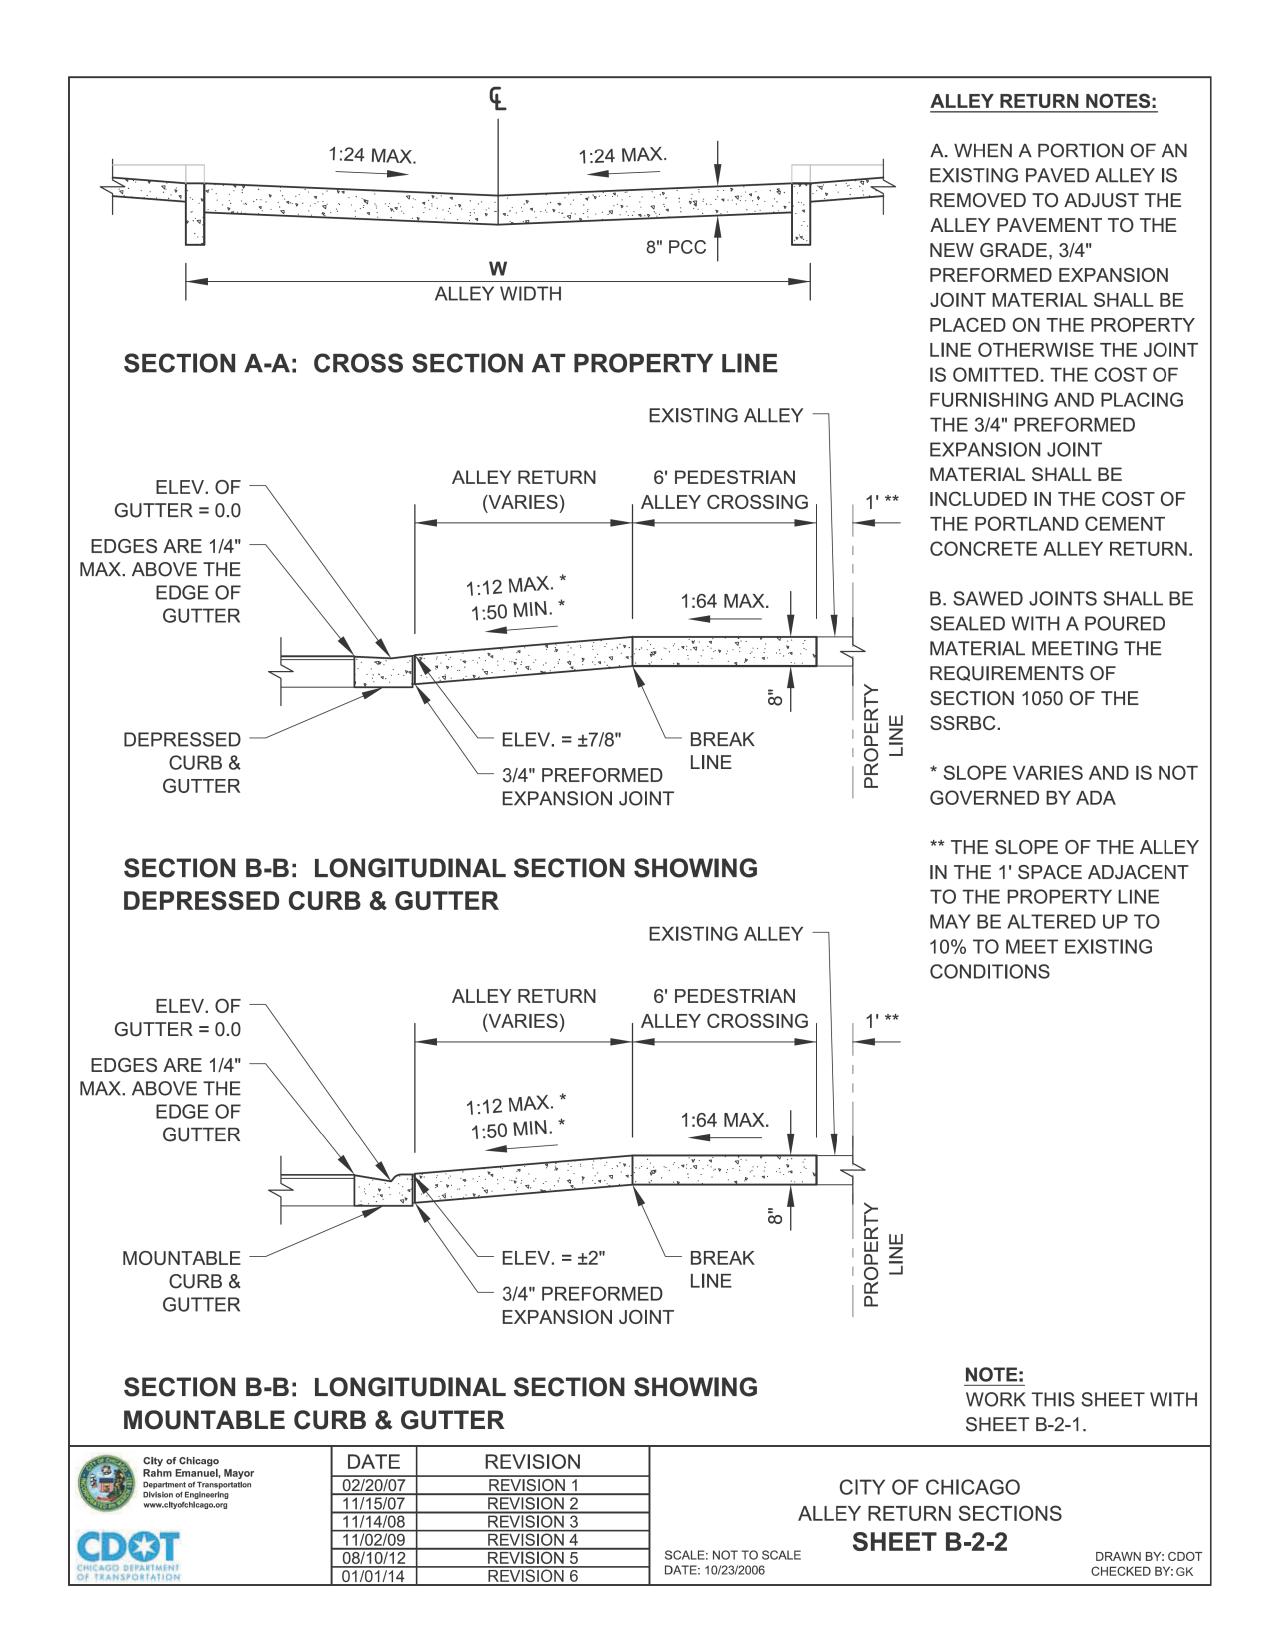

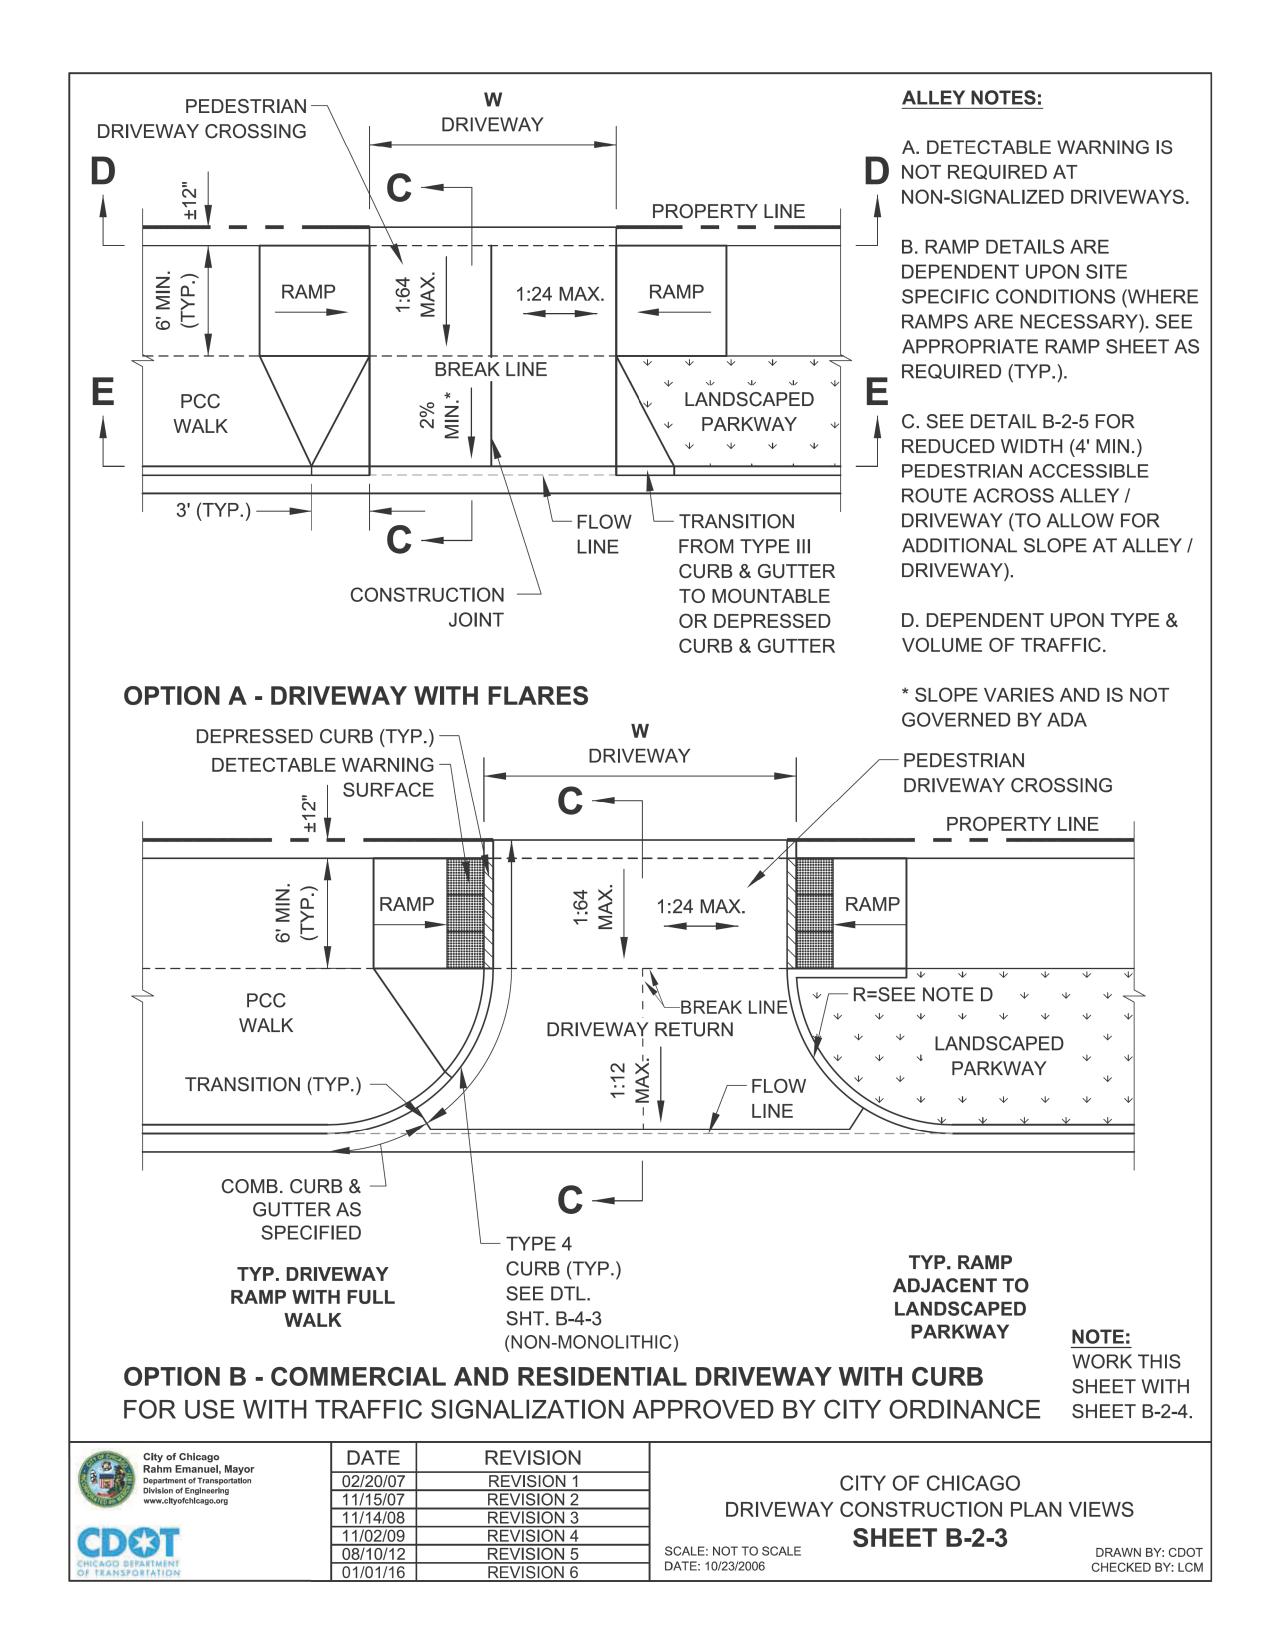

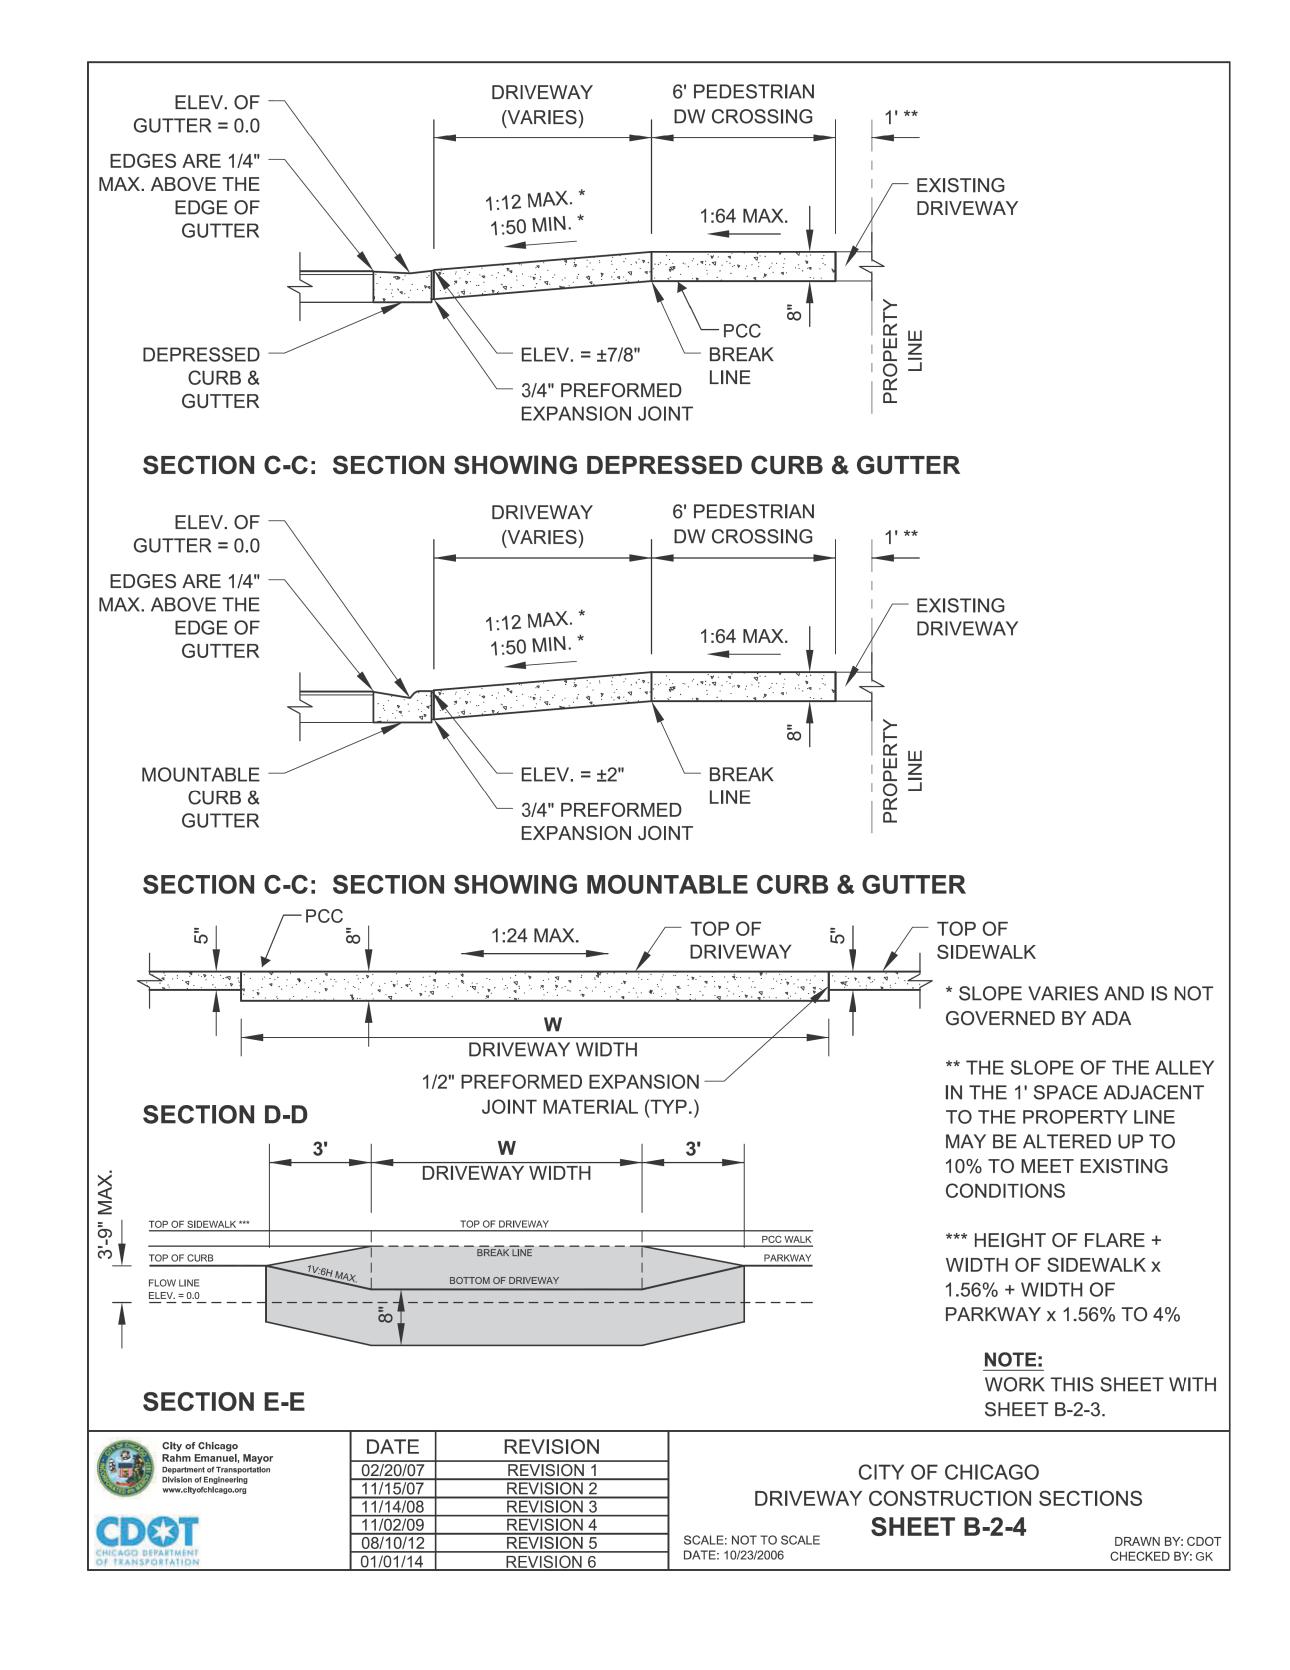

POLICY STATEMENT: ANY ALTERATION OF THE PUBLIC WAY MUST BE RESTORED IN AN ADA COMPLIANT MANNER

#### I. STREET/ALLEY RESTORATION

FOR ANY PROJECT WHERE, WITHIN THE PROJECT LIMITS, A CROSSWALK IS ENCOUNTERED OR WHERE THE PROJECT LIMITS TERMINATE WITHIN 4' OR LESS OF A CROSSWALK, THOSE CROSSWALKS AND THE ASSOCIATED CURB RAMPS MUST BE IMPROVED TO CURRENT ADA STANDARDS IF THEY ARE NOT COMPLIANT (SEE APPENDIX A.)

WHEN A PROJECT CALLS FOR ONLY AN INTERSECTION TO BE REPAVED, THE INTERSECTION LIMITS AS DEFINED BY THE AREA OUTLINED BY OUTERMOST CROSSWALK LINES AND ADJACENT CURB FACES AND ALL ADJOINING CROSSWALKS AND CURB RAMPS MUST BE IMPROVED TO CURRENT ADA STANDARDS IF THEY ARE NOT COMPLIANT (SEE APPENDIX A).

WHEN WORK IS LIMITED TO A SINGLE CORNER OF AN INTERSECTION, THE CURB RAMP MUST BE IMPROVED TO CURRENT ADA STANDARDS AND THE ADJACENT PAVEMENT MUST BE RESURFACED, AS NECESSARY TO PROVIDE FOR A FLUSH TRANSITION (SEE APPENDIX A).

WHEN ADA WORK IS LIMITED TO A SINGLE CORNER OF AN INTERSECTION, THE ADJACENT PAVEMENT MUST BE RESTORED (SEE APPENDIX A).

FOR ANY CONSTRUCTION WHERE, WITHIN THE PROJECT LIMITS, AN ALLEY APRON IS ENCOUNTERED, THE ASSOCIATED CURB RAMPS, ALLEY APRON, AND SIDEWALKS MUST BE IMPROVED TO CURRENT ADA STANDARDS IF THEY ARE NOT COMPLIANT (SEE APPENDIX A).

#### II. SIDEWALK INSTALLATION / REPAIRS / RECONSTRUCTION

THE LIMITS OF ANY MAINLINE SIDEWALK REPLACEMENT, GREATER THAN TEN FEET (10') IN LENGTH, THAT ABUT AN EXISTING RAMP, KEYSTONE, TRANSITION PANEL, AND/OR LANDING AREA (THIS TOTAL LENGTH INCLUDES THE PRIOR ELEMENTS), SHALL BE EXTENDED TO INCLUDE THE AFFECTED RAMPS AND THESE RAMPS SHALL BE RECONSTRUCTED TO CURRENT ADA STANDARDS. IN ADDITION, ALL NEWLY PLACED SIDEWALK TEN FEET (10') OR MORE IN LENGTH SHALL BE CONSTRUCTED IN ACCORDANCE WITH ALL CURRENT APPLICABLE STANDARDS WHICH INCLUDE PROVIDING A MINIMUM FOUR FEET (4') WIDTH ACCESSIBLE PATHWAY WITH A CROSS SLOPE NOT TO EXCEED 1:64 (SEE APPENDIX A).

#### III. GUIDELINES FOR TRANSITIONING TO EXISTING NON-COMPLIANT CONDITION

NEW SIDEWALK PLACEMENTS GREATER THAN TEN FEET IN CONTIGUOUS LENGTH:

THE LIMITS OF ANY MAINLINE SIDEWALK REPLACEMENT, GREATER THAN TEN FEET (10') IN LENGTH, MUST BE EXTENDED FOR A MINIMUM FIVE ADDITIONAL FEET (5') EITHER SIDE IN ORDER TO PROVIDE A TRANSITION TO MATCH THE EXISTING SIDEWALK. THE LENGTH OF TRANSITION SHALL BE LENGTHENED AS NECESSARY TO ENSURE THAT THE RUNNING SLOPE OF THE TRANSITION DOES NOT EXCEED A SLOPE OF 1:24 (PREFERRED) OR 1:14 (MAXIMUM) AT ANY POINT.

#### NEW SIDEWALK REPLACEMENTS TEN FEET OR LESS IN CONTIGUOUS LENGTH (REPAIRS):

IT IS ACCEPTABLE PRACTICE TO MATCH ADJACENT SIDEWALKS AT THE EXISTING SLOPE.

#### **CURB RAMP REPLACEMENTS**

WHEN REPLACING AN ADA RAMP, THE SIDEWALK REPLACEMENT MUST EXTEND BEYOND THE LIMITS OF THE LANDING AREA AND/OR THE "KEYSTONE" A MINIMUM OF AN ADDITIONAL FIVE FEET (5') ON EITHER SIDE IN ORDER TO PROVIDE A TRANSITION TO MATCH THE EXISTING SIDEWALK. THE TRANSITION PANEL SHALL BE LENGTHENED AS NECESSARY TO ENSURE THAT THE RUNNING SLOPE OF THE TRANSITION PANEL DOES NOT EXCEED A SLOPE OF 1:24 (PREFERRED) OR 1:14 (MAXIMUM) AT ANY POINT.

NO EXCEPTIONS TO THE ABOVE WILL BE ALLOWED WITHOUT WRITTEN APPROVAL FROM THE COMMISSIONER.

City of Chicago
Rahm Emanuel, Mayor
Department of Transportation
Division of Engineering
www.cityofchicago.org

CDET

ADA COI

CITY OF CHICAGO

ADA COMPLIANCE AND TRANSITION GUIDELINES

SHEET B-3-4


DRAWN BY: CDOT

CHECKED BY: GK

SCALE: NOT TO SCALE
DATE: 10/23/2006

VARIABLE - 3" MIN. - PROVIDE REINFORCING STEEL IF REQUIRED

#### **SIDE CURB - SECTION**

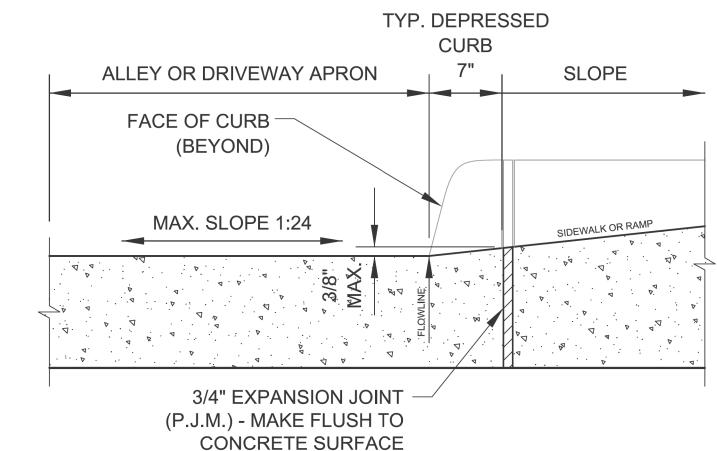

## **DEPRESSED CURB & GUTTER**

AT ALLEY/DRIVEWAY APRON (TYPE 4 OR B CURB)

# C. REFER TO REGULATIONS FOR OPENINGS, CONSTRUCTION AND REPAIR IN THE PUBLIC WAY (CDOT) FOR ADDITIONAL REQUIREMENTS FOR CURB AND GUTTER INSTALLATION.

NOTES FOR CURB & GUTTER

DEPRESSED CURB & GUTTER

B. DETECTABLE WARNING

SURFACE AT DRIVEWAYS

DRIVEWAYS WITH TRAFFIC

**DETAILS THIS SHEET:** 

A. CROSS SLOPE AT

NOT TO EXCEED 1:64.


REQUIRED ONLY FOR

COMMERCIAL

CONTROL

D. RAMP SIDE FLARES SHALL
BE INSTALLED AT ANY
LOCATION WHERE THE
SURFACE ADJACENT TO THE
RAMP SURFACE IS INTENDED
FOR PEDESTRIAN USE.
TRIPPING HAZARDS, INCLUDING
STEPS, DROP-OFFS, OR SIDE
CURBS SHALL NOT BE LOCATED
WITHIN THE LIMITS OF THE
SIDEWALK.

E. 'P.J.M.' THIS SHEET REFERS TO PREFORMED JOINT MATERIAL.

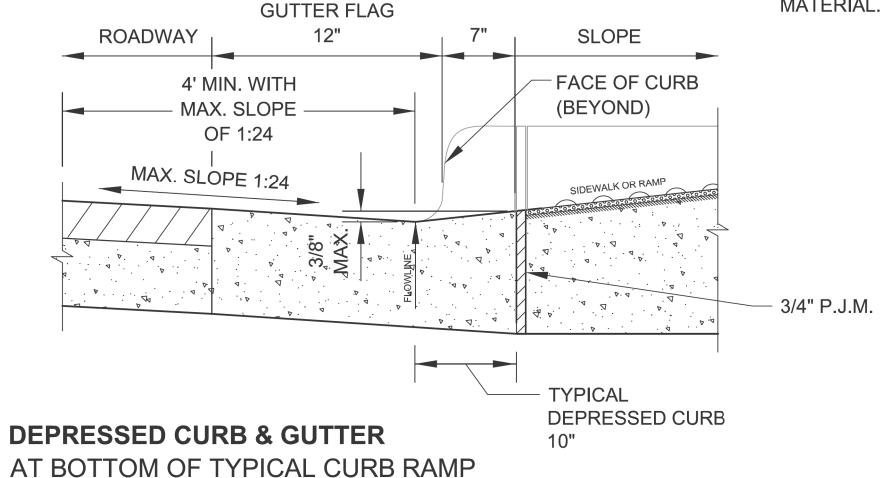

City of Chicago
Rahm Emanuel, Mayor
Department of Transportation
Division of Engineering
www.cityofchicago.org

 DATE
 REVISION

 02/20/07
 REVISION 1

 11/15/07
 REVISION 2

 11/14/08
 REVISION 3

 11/02/09
 REVISION 4

 08/10/12
 REVISION 5

 SCALE: NOT TO SDATE: 10/23/2006

CITY OF CHICAGO CURB & GUTTER DETAILS

SCALE: NOT TO SCALE

SHEET B-4-3

DRAWN BY: CDOT CHECKED BY: LCM

\*CDOT

CITY OF CHICAGO DEPARTMENT OF TRANSPORTATION 24th WARD CDOT STANDARD CONSTRUCTION DETAILS
PBC PROJECT NO # 22922
W. 16TH STREET - W. OGDEN AVENUE
S. CENTRAL PARK AVENUE - S. DRAKE AVENUE


OUC NUMBER

COUNTY
TOTAL SHEETS NO.

OUC IR #124701

COOK
26
17

STA.
TO STA.
SCALE: NTS

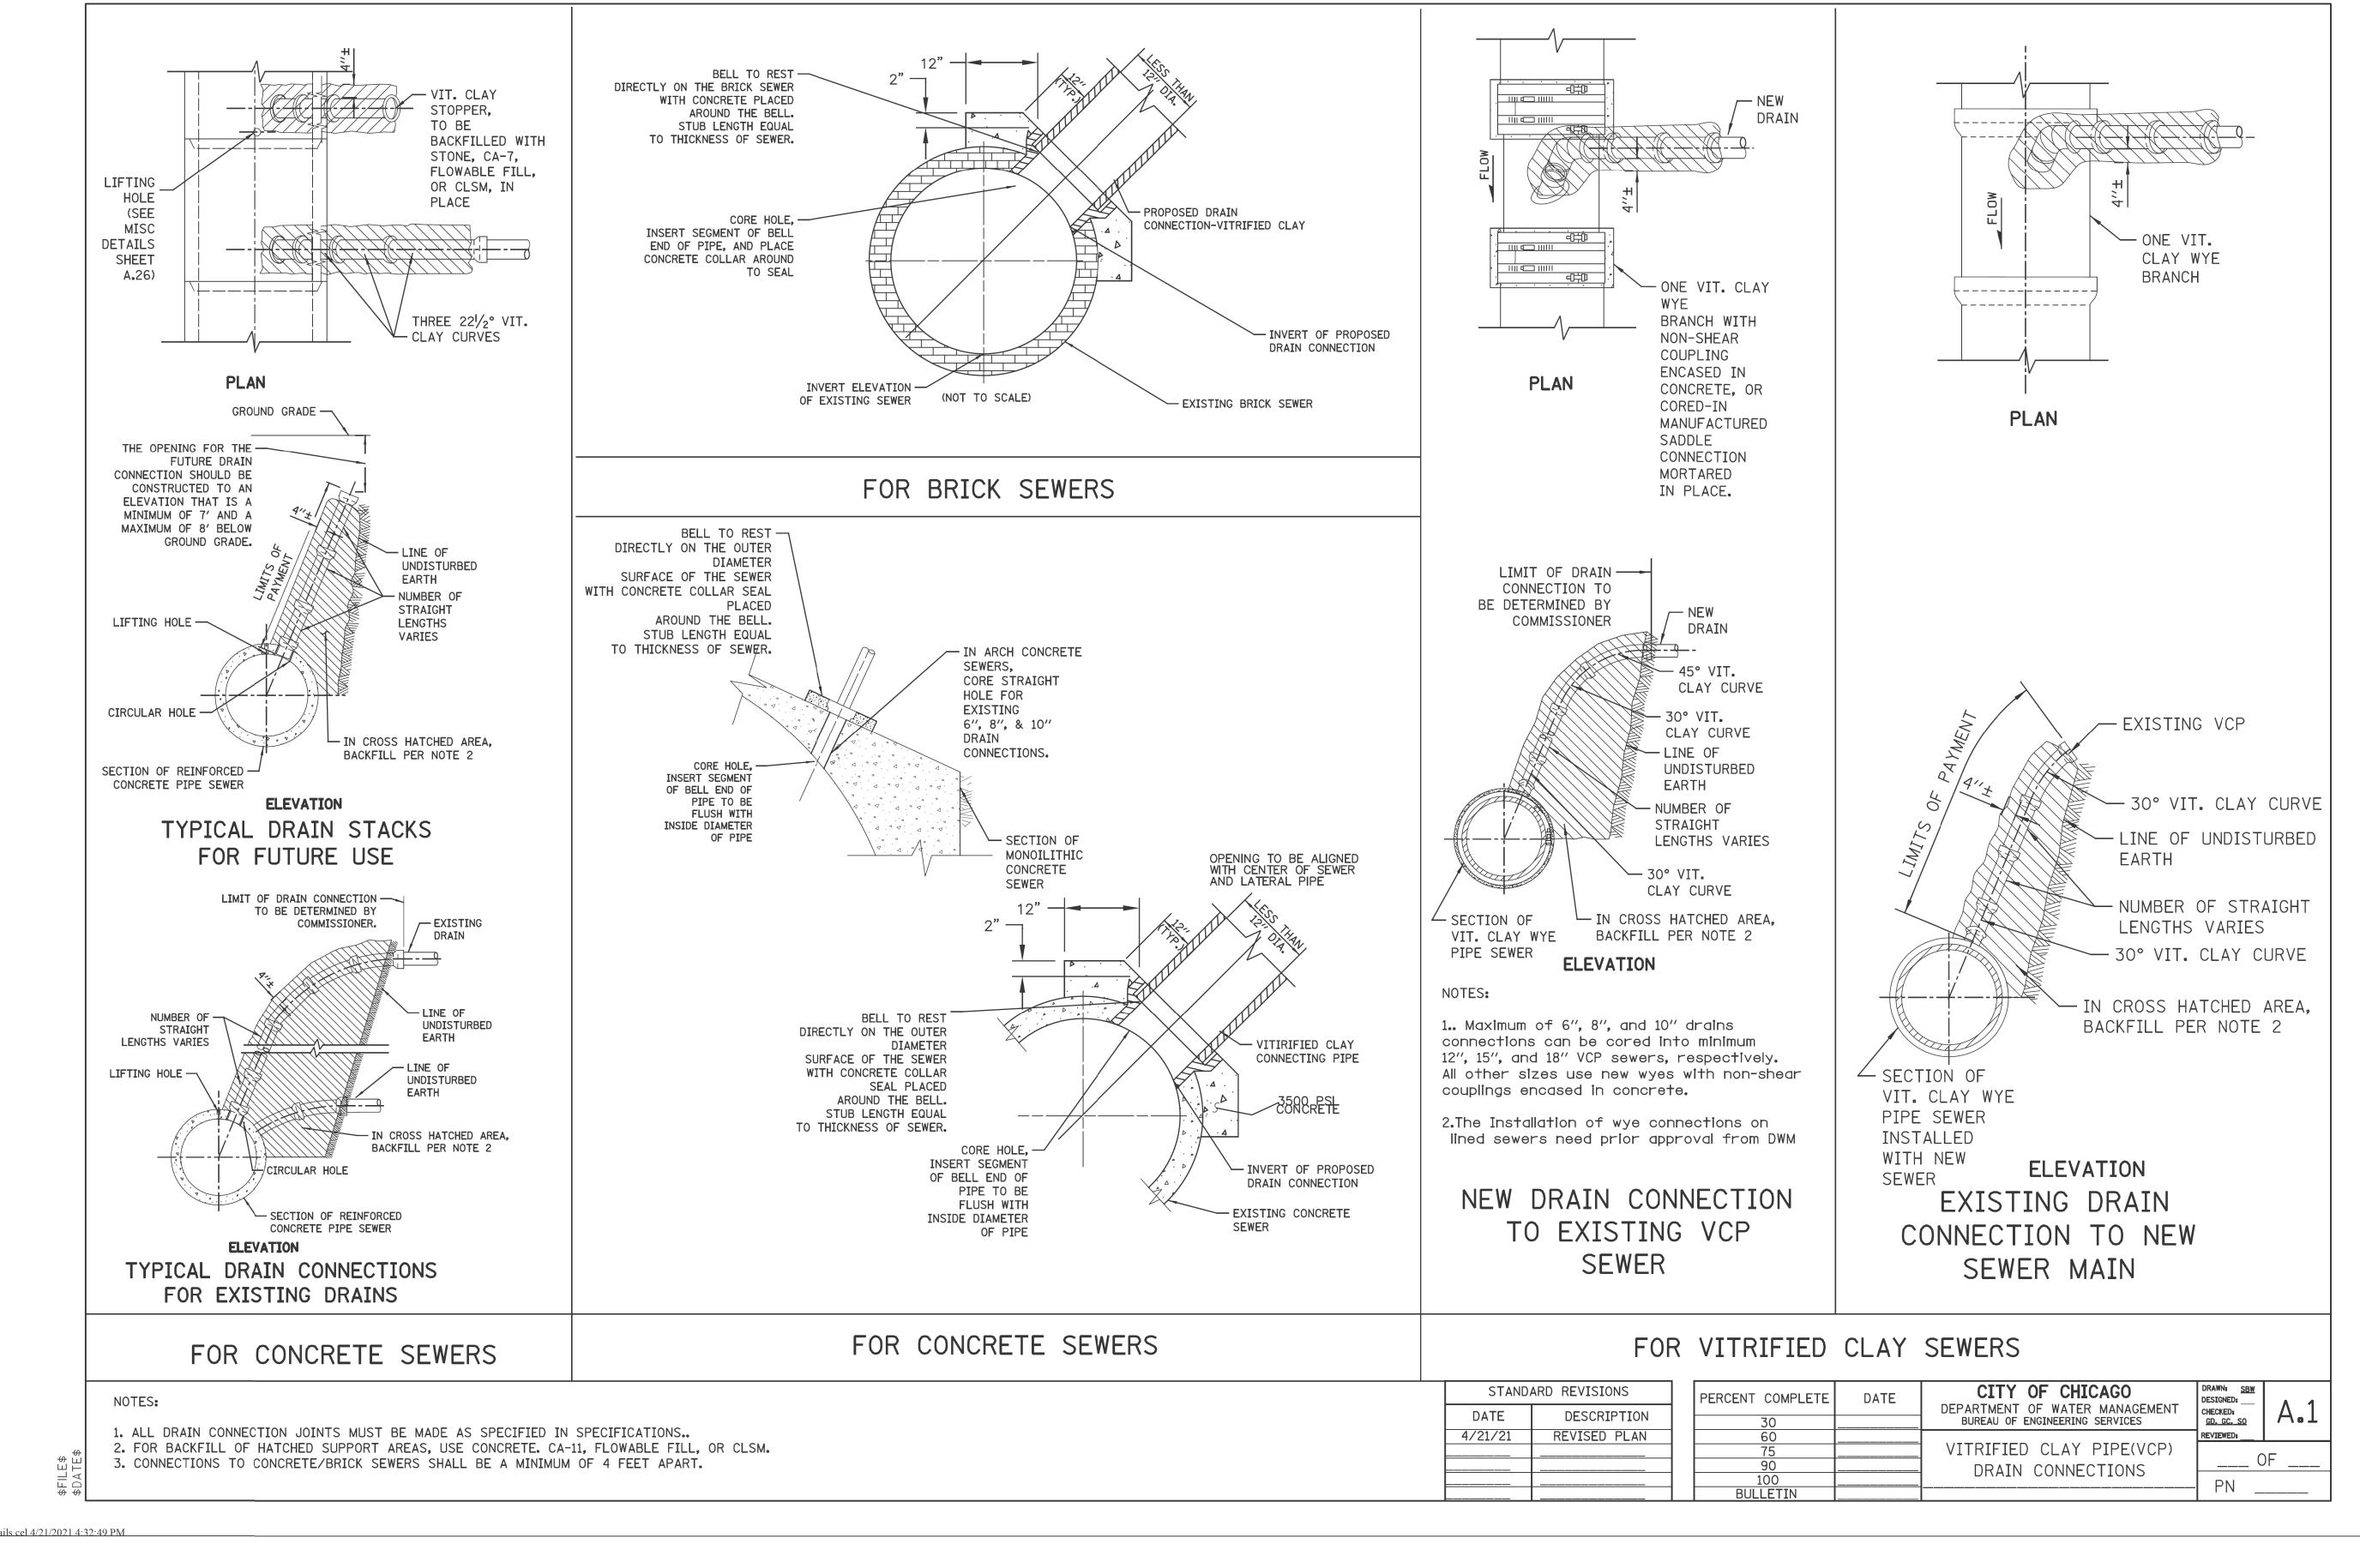

CDOT CDOT

 USER NAME
 = AB
 DESIGNED
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 DRAWN
 REVISED


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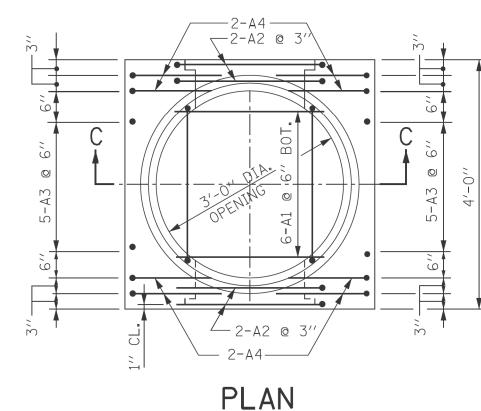
 PLOT DATE
 = 7/1/2025
 DATE
 07/01/2025
 ISSUED FOR BID - 07/10/2025

CITY OF CHICAGO DEPARTMENT OF TRANSPORTATION 24th WARD CDWM STANDARD CONSTRUCTION DETAILS
PBC PROJECT NO # 22922
W. 16TH STREET - W. OGDEN AVENUE


S. CENTRAL PARK AVENUE - S. DRAKE AVENUE

	OUC NUMBER	COUNTY	TOTAL SHEETS	SHEET NO.	
	OUC IR #124701	COOK	26	18	
STA.	TO STA.	SCALE: NTS	5		



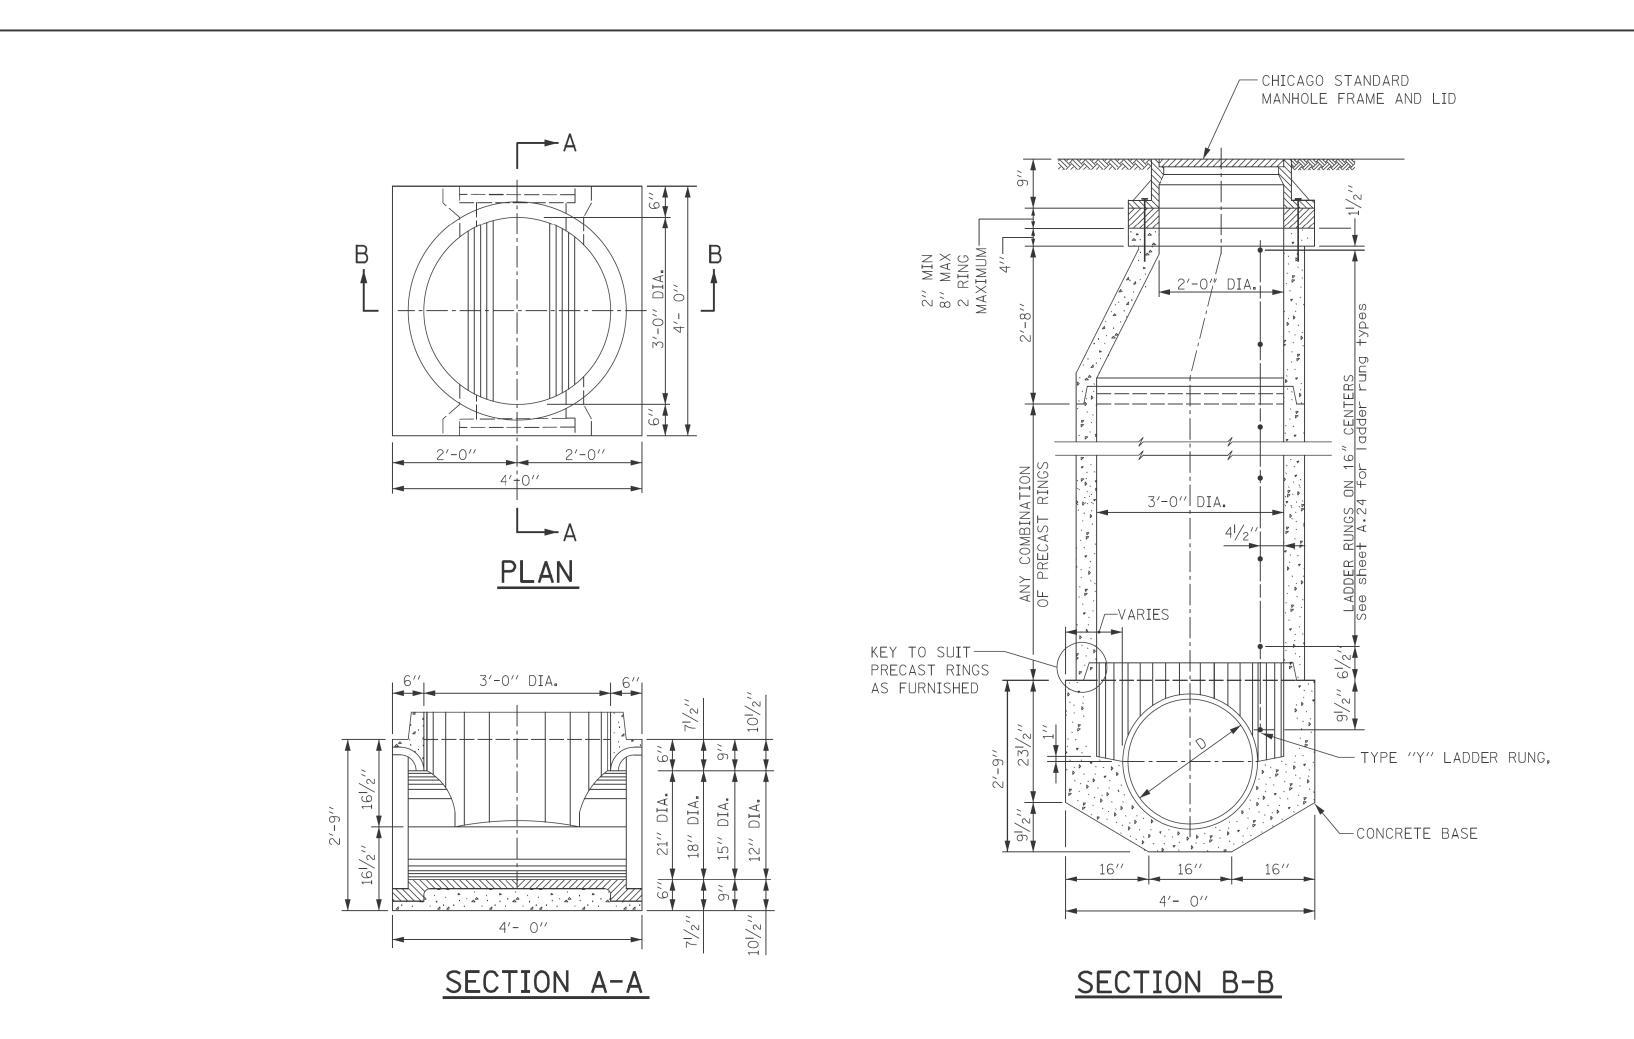

# PLAN PRECAST BASE

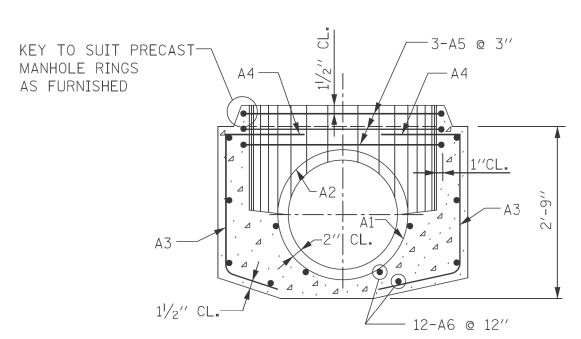

# SECTION C-C

NOTE: 6" MINIMUM GRANULAR EMBEDMENT UNDER ALL PRECAST MANHOLE BASES

		SCHED	ULE	OF	REI	VFOF	RCEM	IENT						
	Z JRE	REINFORCEMENT BAR				В	ENDING	DIMEN	NSIONS					
STRI		MARK SIZE TYPE LENGTH NO. WEIGHT - LBS	А	В	С	D	E	F	G	Н	J	K	0	R
		21A1 6 9 3'-1" 6 4.63 28		3′-1′′						111/4''			2'-1''	123/4′′
	∢	21A2 6 T3 8'-8" 4 13.02 52										2'-0''	2'-1/2"	
<u></u>		21A3 5 12 3'-3" 10 3.39 34			22''	17′′				141/2"		83/4′′		
(V)		21A4 5   12   4'-6''   8   4.69   38		15′′	22′′	17′′				$14\frac{1}{2}''$		83/4′′		
(A)	21′′	21A5 5 T3 11'-11'' 3 12.43 37										20''	3'-31/4''	
	$\sim$	21A6 4 STR 3'-8" 12 2.45 30												
(PREC		TOTAL 219												
S		18A1 6 9 2'-8 <sup>1</sup> / <sub>2</sub> '' 6 4.07 24		2'-81/2"							93/4′′		22''	111/4′′
	DIA.	$18A2 \ 6 \ T3 \ 7'-10\frac{1}{2}' \ 4 \ 11.83 \ 47$										2'-0''	221/2"	
MANHOLE		18A3 5 12 3'-3" 10 3.39 34			22′′	17′′					141/2"	83/4′′		
1 9		18A4 5 12 4'-6" 8 4.69 38		15′′	22′′	17′′					$14\frac{1}{2}''$	83/4′′		
	`	18A5 5 T3 11'-11'' 3 12.43 37										2'-0''	3'-31/4''	
$\leq$	<u> </u>	18A6 4 STR 3-8" 12 2.45 30												
		TOTAL 202												
	_	15A1 6 9 2'-3 <sup>1</sup> / <sub>2</sub> '' 6 3.44 21		231/2"						81/4"			19''	93/4′′
\A'\	⋖	15A2 6 T3 7'-1" 4 10.64 42										2'-0''	191/2"	
ш	DIA	15A3 5 12 3'-3" 10 3.39 34			22′′	17′′						83/4′′		
	_	15A4 5 12 4'-6'' 8 4.69 38		15′′	22′′	17′′				141/2"		83/4′′		
1 L	.2′	15A5 5 T3 11'-11'' 3 12.43 37								14/2"		20''	3'-33/4''	
		15A6 4 STR 3'-8" 12 2.45 30												
0 R		TOTAL 202												
		12A1 6 9 1'-11'' 6 2.88 17		23′′						63/4′′			16′′	81/4′′
S	√	12A2 6 T3 6'-1" 4 9.14 37										2'-0''	161/2"	
SES	DIA	12A3 5 12 3'-3" 10 3.39 34			22''	17′′				141/2"		83/4′′		
AS		12A4 5 12 4'-6'' 8 4.69 38			22′′	17′′				141/2"		83/4′′		
B/	2/	12A5 5 T3 11'-11'' 3 12.43 37										20''	3'-31/4''	
	10	12A6 4 STR. 3'-8" 12 2.45 30												
		TOTAL 193												

PER	ARD REVISIONS	STANDARD REVISIONS					
$\vdash$	DESCRIPTION	DATE					
	REVISION	9/5/17					

PERCENT COMPLETE	DATE	CITY OF CHICAGO Department of water management	DRAWN: DESIGNED
30		BUREAU OF ENGINEERING SERVICES	
60			REVIEWE
75		TYPE "A" PRECAST	
90		MANHOLE FOR SEWERS	
100		21" DIA. AND SMALLER	PN
BULLETIN			FI

.NT	DRAWN: SBW DESIGNED: CHECKED:	A.6
	REVIEWED:	
	C	)F
	PN _	

\$FILE\$ \$DATE\$


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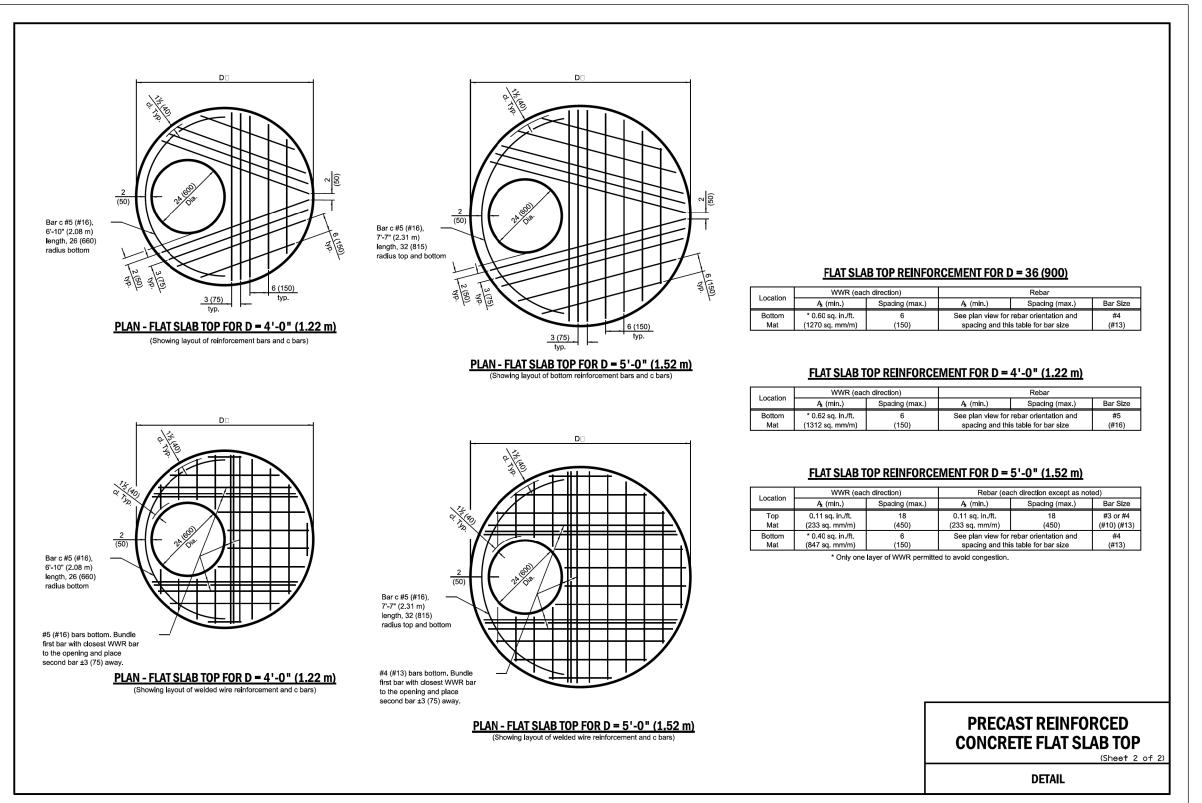


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	PLOT DATE = 7/1/2025	DATE - 07/01/2025	ISSUED FOR BID - 07/10/2025

	OUC NUMBER	COUNTY	TOTAL SHEETS	SHEET NO.
	OUC IR #124701	COOK	26	19
STA.	TO STA.	SCALE: NTS	5	

# STANDARD FLAT TOP SLAB FOR CATCH BASINS



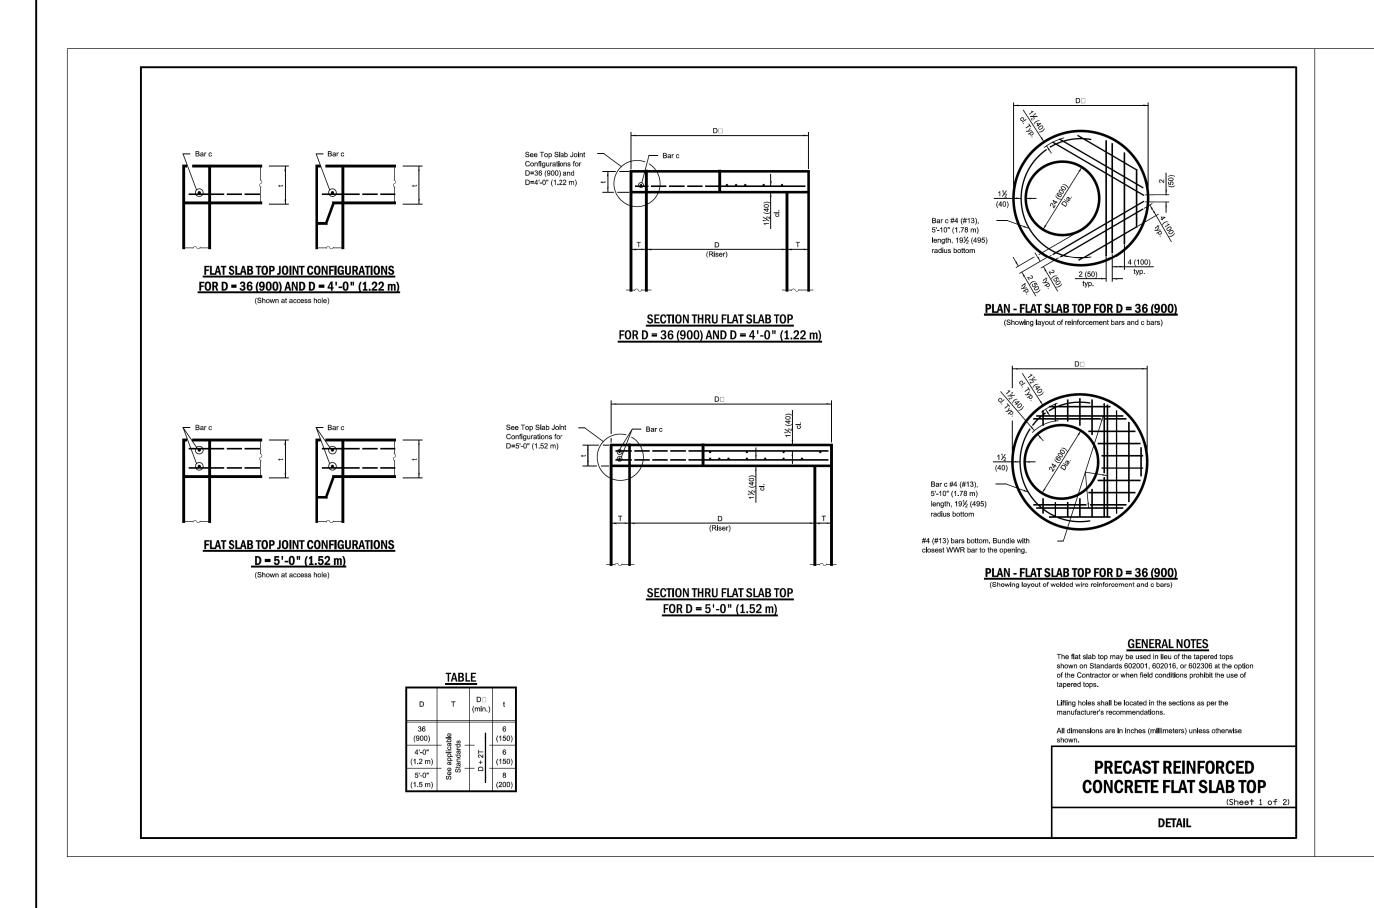

NOTES:
FLAT TOP SLAB AAPLICATION CAN ONLY BE USED WITH WRITTEN PERMISSION FROM CDWM.
USE LATEST IDOT DETAIL, #602601-06,
AS REFERENCED ON THE IDOT WEBSITE.

STANDARD REVISIONS			PERCE
DATE	DESCRIPTION		
4/22/21	LAST REVISED		
_12/6/24	PUBLISHED_	4	
		$\dashv$	
			В


PERCENT COMPLETE	DATE	CITY OF CHICAGO Department of water management	DRAWN: SBW DESIGNED:  CHECKED:   A 2
30		BUREAU OF ENGINEERING SERVICES	
60			REVIEWED:
75		FLAT TOP SLAB DETAILS	٥٦
90			UF
100			PN
BULLETIN			FIN


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	PLOT DATE = 7/1/2025	DATE - 07/01/2025	ISSUED FOR BID - 07/10/2025

	OUC NUMBER	COUNTY	TOTAL SHEETS	SHEET NO.
	OUC IR #124701	COOK	26	20
STA.	TO STA.	SCALE: NTS	5	




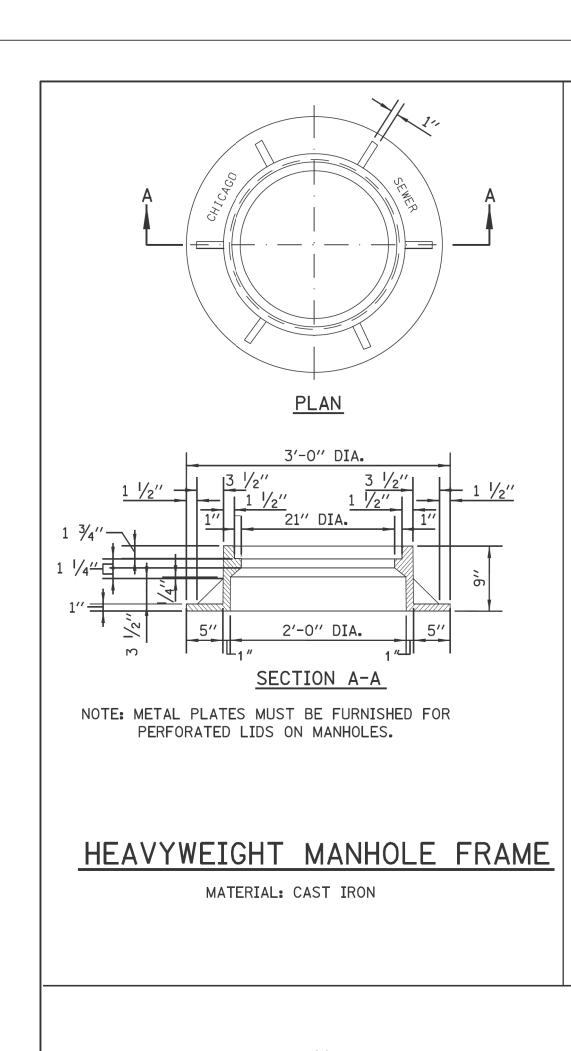

STANDARD CB/MH LID

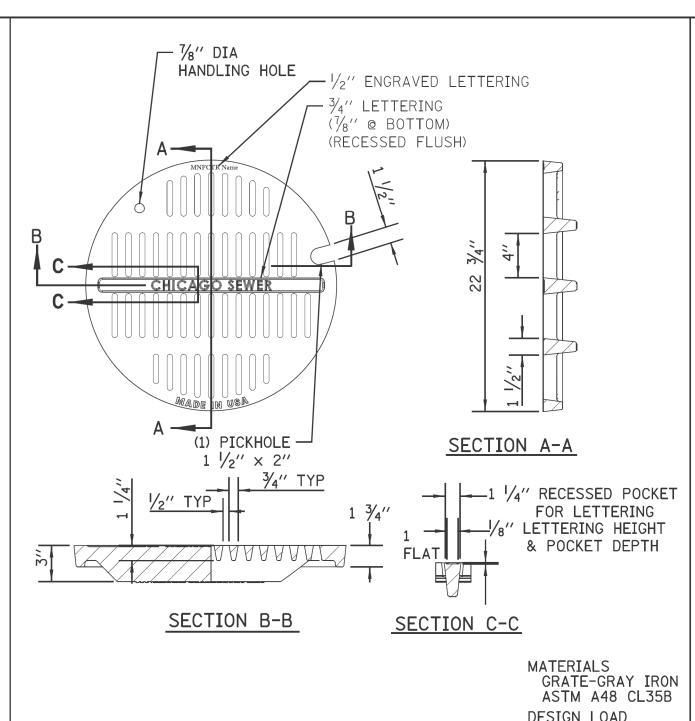DESIGN LOAD HEAVY DUTY COATING UNDIPPED OPEN AREA

85.6 SQ. IN.

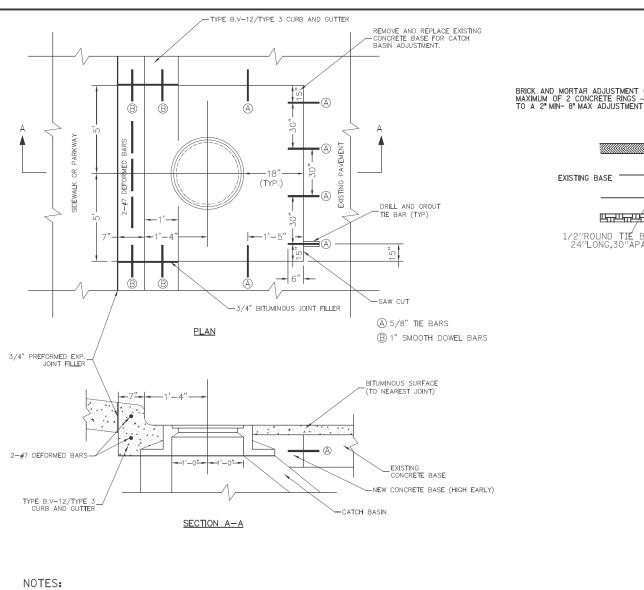

FRAMES AND LIDS OF THE DWM. IN ADJUSTMENT OR RECONSTRUCTION OF SEWER STRUCTURES, ANY NON-STANDARD FRAMES AND LIDS MUST BE REPLACED WITH STANDARD FRAMES AND LIDS. IN ADJUSTMENT OR RECONSTRUCTION OF INLETS, ANY NON-STANDARD INLETS (GUTTER BOXES) MUST BE

MANHOLES, CATCH BASINS AND INLETS MUST BE PROTECTED FROM THE ENTRY OF ASPHALT/DEBRIS

INTO THE SEWER SYSTEM DURING CONSTRUCTION. THE CONTRACTOR MUST MARK LOCATIONS OF ALL

SEWER STRUCTURES ON THE SIDEWALK BEFORE STARTING PAVEMENT REMOVAL/REPLACEMENT.


ADJUSTMENT OF FRAMES AND LIDS OF SEWER STRUCTURES MUST BE COMPLETED PRIOR TO STREET RESURFACING.

THE CONTRACTOR IS REQUIRED TO REPLACE ANY BROKEN FRAMES AND LIDS OF SEWER STRUCTURES WITH STANDARD

THE FRAMES AND LIDS OF SEWER STRUCTURES TO BE

ABANDONED, REMOVED, OR FILLED MUST BE SALVAGED AND THE DWM NOTIFIED FOR PICK UP.

REPLACED WITH DWM STANDARD INLETS.

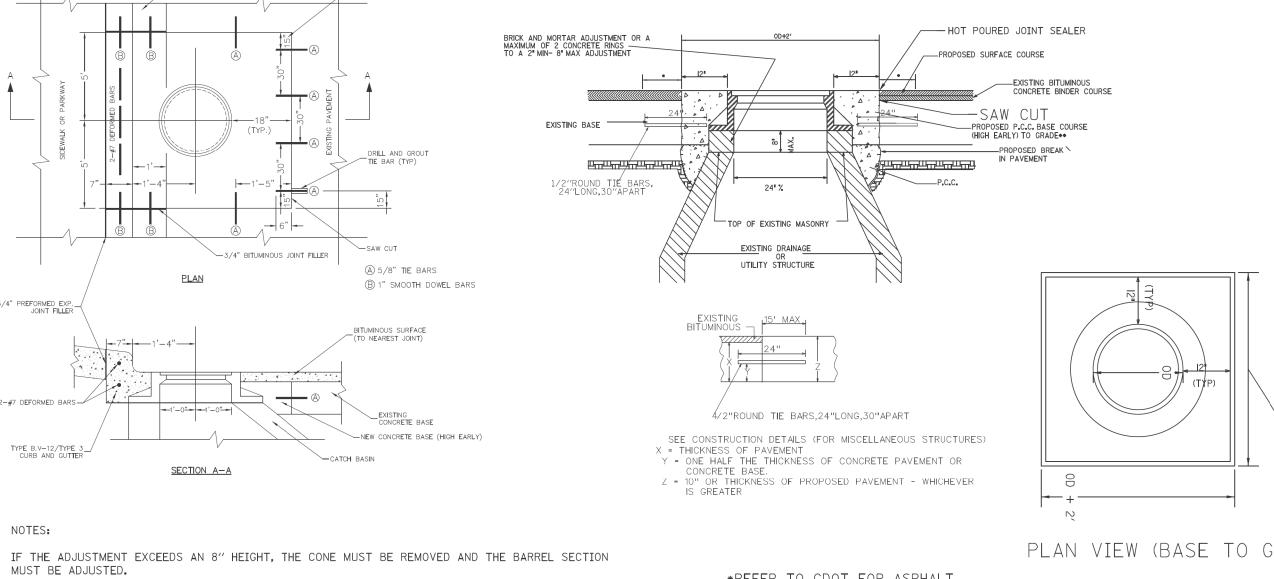


PLAN VIEW (BASE TO GRADE)


\*REFER TO CDOT FOR ASPHALT RESTORATION REQUIREMENTS & CRACK SEALING.


\*\* ON NON-MORATORIUM STREETS, FULL-DEPTH PCC BASE COURSE MAY BE UTILIZED. ON MORATORIUM

STREETS, PAVEMENT RESTORATION SHALL ADHERE T CDOT REQUIREMENTS.

DETAIL OF FRAME ADJUSTMENT

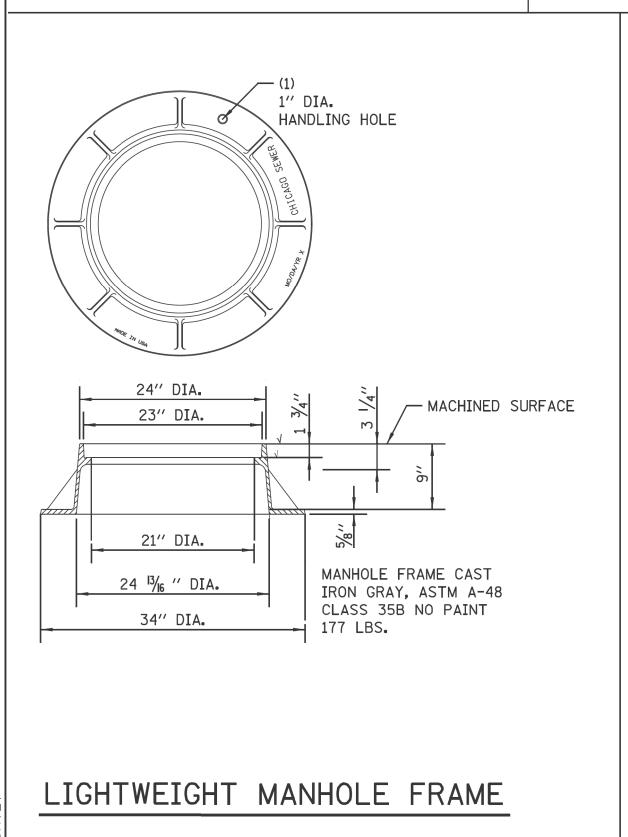

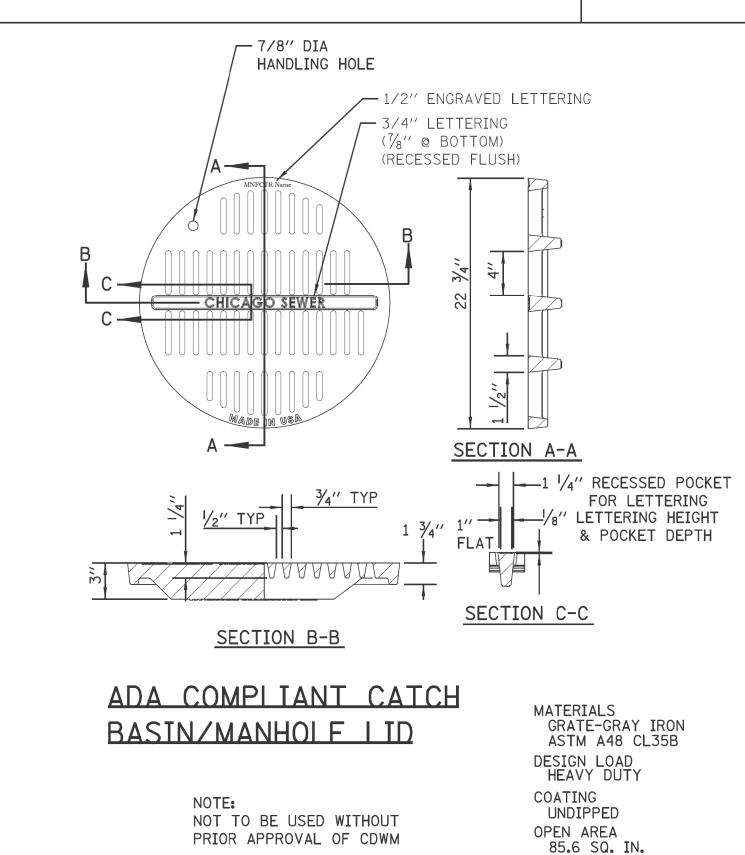

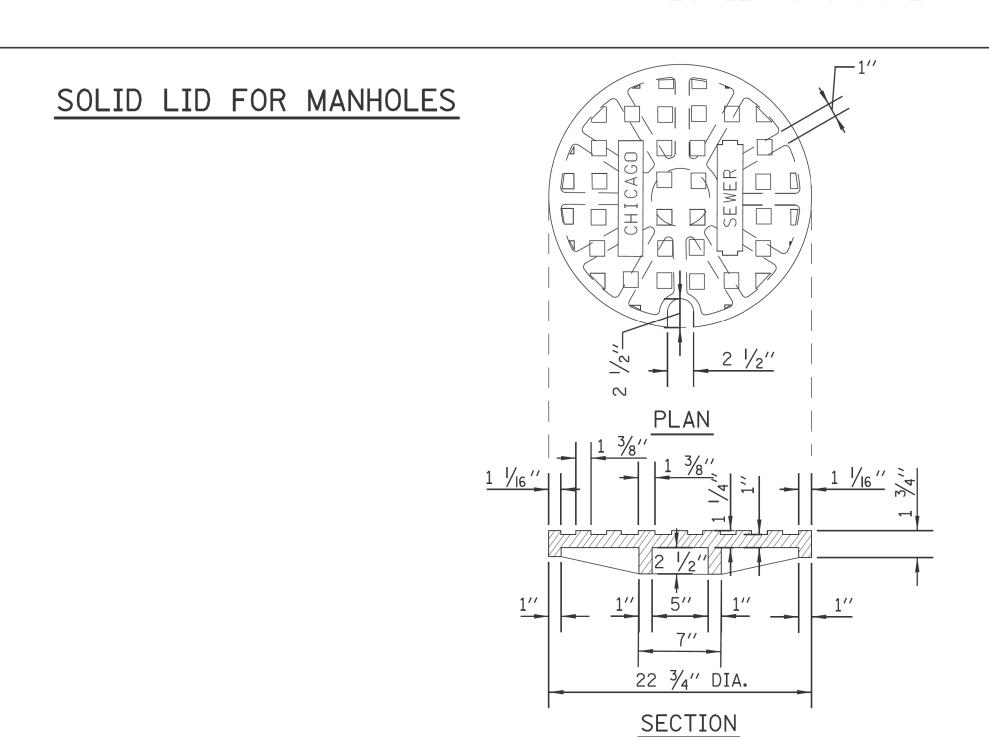

		_
STANDA	ARD REVISIONS	PERCENT
DATE	DESCRIPTION	<b>│                                    </b>
2/5/21	Approved	
		+ $-$

PERCENT COMPLETE	DATE	CITY OF CHICAG DEPARTMENT OF WATER MA
30		BUREAU OF ENGINEERING SERV
60		
75		MANHOLE
90		LIDS AND FRAM
100		
BULLETIN		

DRAWN: SBW DESIGNED: CHECKED: GD, GC, SO A 21 IANAGEMENT RVICES REVIEWED: 1ES PN



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		OUC NUMBER	COUNTY	TOTAL SHEETS	SHEET NO.
		OUC IR #124701	COOK	26	21
	STA.	TO STA.	SCALE: NTS	5	
Ī					

S. CENTRAL PARK AVENUE - S. DRAKE AVENUE

#### STANDARD DRAINAGE STRUCTURES FOR PUBLIC STREETS #5 DOWEL BAR @ — — TYPE B CURB & GUTTER CONSTRUCTION JOINT TYPE B-V.12 Per CDOT Details CURB AND GUTTER\_ Note: Positive Summit - 1/2" ROUND TIE BARS Per CDOT Details for Drainage 30" LONG, 30" C/C CHICAGO 4" MAXIMUM (TYP) Note: Positive Summit -FRAME & LID CHICAGO for Drainage FRAME & LID 4" MAXIMUM(TYP)-PRECAST 8" MAX CONCRETE 2 RING PRECAST-8" VIT. CLAY, ADJUSTEMNT MAXIMUM CONCRETE 1' VERTICAL RING ADJUSTEMNT HALF TRAP 2" MIN RING 8" MAX 2'-0'' DIA. 2 RING 8" VIT. CLAY,-2'-0" DIA. MAXIMUM PRECAST 1' VERTICAL REINF. CONC. HALF TRAP PRECAST OFFSET CONE REINF. CONC. OFFSET CONE -SWIRL CHAMBER VORTEX or ORIFICE VORTEX or ORIFICE RESTRICTOR RESTRICTOR (SEE MISC DETAILS (SEE MISC DETAILS SHEET A.26) SHEET A.26) 4'-0'' DIA. 3'-0" DIA. PRECAST REINFORCED BASE AND PRECAST REINFORCED BASE AND-RISER WITH MINIMUMN 6" EMBEDMENT RISER WITH MINIMUMN 6" EMBEDMENT STANDARD CATCH BASIN-4' DIA. STANDARD CATCH BASIN-3' DIA. CHICAGO STANDARD MANHOLE FRAME AND

CURB & -

GUTTER

24" DIA-PRECAST

RING

6" MIN. GRANULAR-

EMBEDMENT UNDER

ALL INLETS

CONCRETE A

\_2′′ R

STANDARD INLET-2' DIA.

<u>PLAN</u>

(FRAME & LID NOT SHOWN)

DUCTILE

IRON PIPE

—PERFORATED LID

<u>Zumannannan</u>

2'-0'' DIA.

#5 @-

12''

REINFORCED CONCRETE —

BASE CAST AS INTEGRAL

PRECAST CONCRETE RING

PART OF 24" DIA.

3" MAXIMUM\* (TYPICAL)

-8" DUCTILE IRON

PIPE MUST BE

CONNECTION TO


PIPE TO BE LAID

CATCH BASIN.

ON A MINIMUM GRADE OF 1%

USED FOR

## STANDARD DRAINAGE STRUCTURES FOR PUBLIC ALLEYS

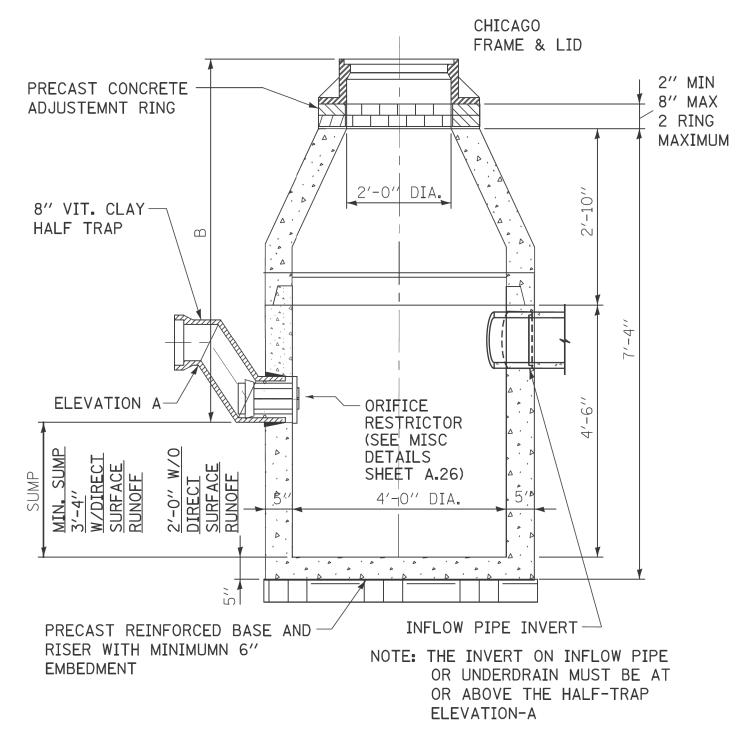

#### CATCH BASIN-ORIFICE RESTRICTOR

N.T.S.

GENERAL NOTES: 1. CATCH BASIN TO CATCH BASIN CONNECTIONS ARE ALLOWED IN PRIVATE SITES & ALLEYS. ONLY THE DOWNSTREAM CATCH BASIN IS REQUIRED TO HAVE A HALF-TRAP.

2. IF B < 4 FEET, THEN USE A FLAT TOP SLAB CATCH BASIN AS NECESSARY.

3. FOR TRENCH BACKFILL, REFER TO IDOT SSRBC, ARTICLE 1003.04.

4. FOR GRANULAR EMBEDMENT, USE CA-11, CRUSHED GRAVEL, CRUSHED STONE, OR CRUSHED CONCRETE.

5. FOR STABILIZATION STONE. 12" OF CA-1 STONE IS ONLY REQUIRED WHEN UNSTABLE MATERIAL IS ENCOUNTERED AT TRENCH BOTTOM.

6. INLETS AND 3' DIAMETER CATCH BASINS ARE TO BE USED ONLY WITH PRIOR APPROVAL OF THE DEPT OF WATER MANAGEMENT- ENGINEERING SERVICES, SEWER SECTION, AND THE DEPT. OF BUILDINGS STORMWATER REVIEWER.

7. IF COVER OVER VCP IS LESS THAN 3', USE 45 DEGREE DIP BENDS WITH 1 FOOT DROP AS HALF TRAPS AS NEEDED FOR IEPA CLEARANCE REQUIREMENTS

STAND	ARD REVISIONS
DATE	DESCRIPTION
2/5/21	APPROVED

PERCENT COMPLETE	DATE	CITY OF CHICAGO Department of water management	DRAWN: <u>SBW</u> DESIGNED: CHECKED:	Δ 22
30		BUREAU OF ENGINEERING SERVICES	ļ	abla $ abla$ $ abla$
60			REVIEWED:	
75		DRAINAGE STRUCTURE DETAILS	ے ا	\_
90				<u> </u>
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BULLETIN				

**CDOT** 

CHICAGO	USER NAME = AB	DESIGNED -	REVISED -
ED		DRAWN -	REVISED -
	PLOT SCALE = 10.0000 ' / in.	CHECKED -	REVISED -
<i>X///</i> .	PLOT DATE = 7/1/2025	DATE - 07/01/2025	ISSUED FOR BID - 07/10/2025

CITY OF CHICAGO **DEPARTMENT OF TRANSPORTATION** 24th WARD


CDWM STANDARD CONSTRUCTION DETAILS PBC PROJECT NO # 22922 W. 16TH STREET - W. OGDEN AVENUE

S. CENTRAL PARK AVENUE - S. DRAKE AVENUE

TOTAL SHEET NO. OUC NUMBER COUNTY 26 22 OUC IR #124701 COOK STA. TO STA. SCALE: NTS


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# DRAINAGE STRUCTURES RESTRICTORS

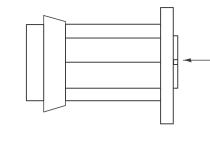

—ORIFICE RESTRICTOR

INSERT THE RESTRICTOR INTO THE HALF-TRAP. UPON TIGHTENING OF THE CENTER NUT ON THE FACE OF THE RESTRICTOR, THE RUBBER O-RINGS WILL EXPAND INSIDE THE HALF TRAP, PROVIDING A WATER- TIGHT SEAL. PULL ON RESTRICTOR TO VERIFY THAT A TIGHT FIT IS MADE.

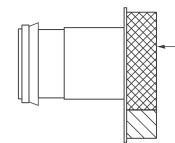

-VORTEX RESTRICTOR

PULL ON RESTRICTOR TO VERIFY THAT A TIGHT FIT IS MADE.

INSERT THE RESTRICTOR WITH THE OPENING DOWN. UPON TIGHTENING OF THE 2 BOLTS ON THE FACE OF THE RESTRICTOR, THE RUBBER O-RINGS WILL PROVIDE A WATER- TIGHT SEAL.

#### GENERAL NOTES:

1. CATCH BASIN TO CATCH BASIN CONNECTIONS ARE ALLOWED IN PRIVATE SITES & ALLEYS. ONLY THE DOWNSTREAM CATCH BASIN IS REQUIRED TO HAVE A HALF-TRAP.

2. IF B < 4 FEET, THEN USE A DUCTILE IRON PIPE HALF TRAP AND FLAT TOP SLAB CATCH BASIN AS NECESSARY.

3. INLETS AND 3' DIAMETER CATCH BASINS ARE TO BE WITH PRIOR APPROVAL OF DWM FIELD INSPECTOR.

#### RESTRICTOR NOTES:


THE DWM'S RAIN BLOCKER RESTRICTOR PROGRAM MUST BE MAINTAINED WITH ANY ROADWAY IMPROVEMENT.

THE DESIGN OF ANY ROADWAY IMPROVEMENT MUST CONSIDER LIMITING THE NUMBER OF CATCH BASINS TO THE EXTENT PRACTICAL. THE NUMBER OF EXISTING STRUCTURES SHOULD NOT BE INCREASED.

THE RESTRICTORS CAN BE OBTAINED FROM DWM CENTRAL DISTRICT AT 3901 S. ASHLAND AVE. THE CONTRACTOR SHOULD ARRANGE FOR PICK UP BY CONTACTING 312-747-8736 (7AM TO 3PM, M-F). CONTRACTOR MUST CALL 48 HOURS IN ADVANCE OF PICK UP DATE AND TIME.

FLOW RESTRICTORS MUST BE INSTALLED IN ALL CATCH BASINS OUTSIDE OF THE CENTRAL BUSINESS DISTRICT(LIMITS: NORTH AVE, CERMAK AVE, HALSTED AVE, LAKE MICHIGAN). RESTRICTORS MUST NOT BE INSTALLED IN CATCH BASINS IN CLOSE PROXIMITY TO VIADUCT AREAS, BUS STOPS, OR EMERGENCY ENTRANCES. THE DWM MUST APPROVE THE NON-INSTALLATION OR REMOVAL OF ANY RESTRICTOR. REQUIREMENTS FOR RESTRICTOR INSTALLATION ARE AS FOLLOWS:

\*ARTERIAL STREETS: 3-INCH ORIFICE RESTRICTOR \*BUS ROUTES: 3-INCH ORIFICE RESTRICTOR \*RESIDENTIAL STREETS: 3-INCH VORTEX RESTRICTOR \*ALLEYS: 3-INCH ORIFICE RESTRICTOR IN THE LAST CB. \*CLOSED LIDS ARE REQUIRED ON ALL MANHOLES EXCEPT AT INTERSECTIONS WHERE A PERFORATED LID SHALL BE

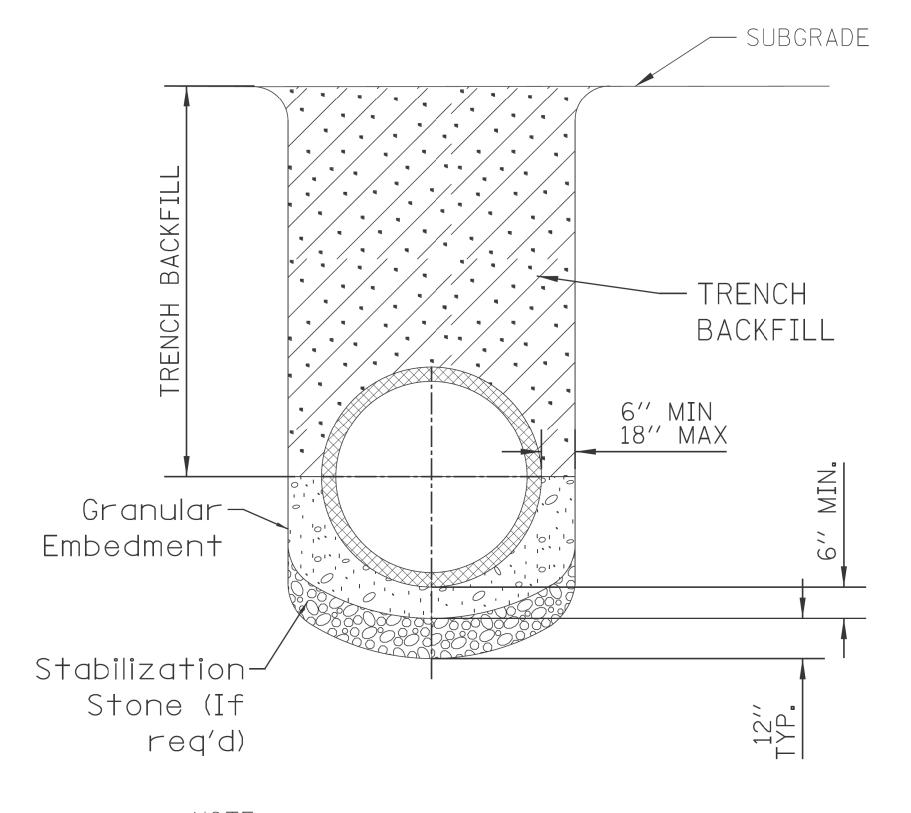


NOTE: 1. FOR TRENCH BACKFILL, REFER TO IDOT SSRBC, ARTICLE 1003.04.


2. FOR GRANULAR EMBEDMENT, USE CA-11, CRUSHED GRAVEL, CRUSHED STONE, OR CRUSHED CONCRETE.

3. FOR STABILIZATION STONE, 12" OF CA-1 STONE IS ONLY REQUIRED WHEN UNSTABLE MATERIAL IS ENCOUNTERED AT TRENCH BOTTOM.

4. AGGREGATE PLACED FOR TEMPORARY SURFACE RESTORATION WILL NOT BE PAID SEPARATELY AND SHALL BE INCIDENTAL TO THE CONTRACT.

SEWER TRENCH DETAIL

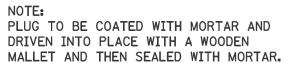

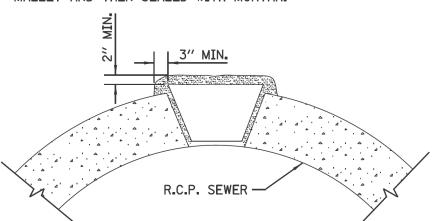

## LIFTING HOLE PLUG DETAIL FOR CONCRETE PIPE

1. ALL PLUG MATERIALS MUST COMPLY WITH 1042.16 OF THE IDOT SSRBC.

2. LIFT HOLES ON COMBINED SEWERS ARE PROHIBITED WHEN THE WATER TABLE IS WITHIN 2 FEET OF THE PIPE INVERT, OR IF THE PIPE IS FULLY SUBMERGED UNDER NORMAL CONDITIONS.

	·		
STANDARD REVISIONS			
DATE	DESCRIPTION		
2/5/21	APPROVED PLAN		

1		PERCENT COMPLETE	DATE	CITY OF CHICAGO Department of water management	DRAWN: SBW DESIGNED: CHECKED:	1 26
		30		BUREAU OF ENGINEERING SERVICES	GD. GC. SO	7.2 Y
		60			REVIEWED:	
	75			MISCELLANEOUS	OF	
		90		DETAILS		
		100		DETAILS	DNI	
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**CDOT** 


USER NAME = AB DESIGNED REVISED DRAWN REVISED CHECKED REVISED PLOT SCALE = 10.0000 ' / in. PLOT DATE = 7/1/2025DATE - 07/01/2025 ISSUED FOR BID - 07/10/2025

CITY OF CHICAGO **DEPARTMENT OF TRANSPORTATION** 24th WARD


CDWM STANDARD CONSTRUCTION DETAILS PBC PROJECT NO # 22922 W. 16TH STREET - W. OGDEN AVENUE S. CENTRAL PARK AVENUE - S. DRAKE AVENUE

TOTAL SHEET NO. OUC NUMBER COUNTY 26 23 OUC IR #124701 COOK TO STA. SCALE: NTS

PN \_\_\_\_\_

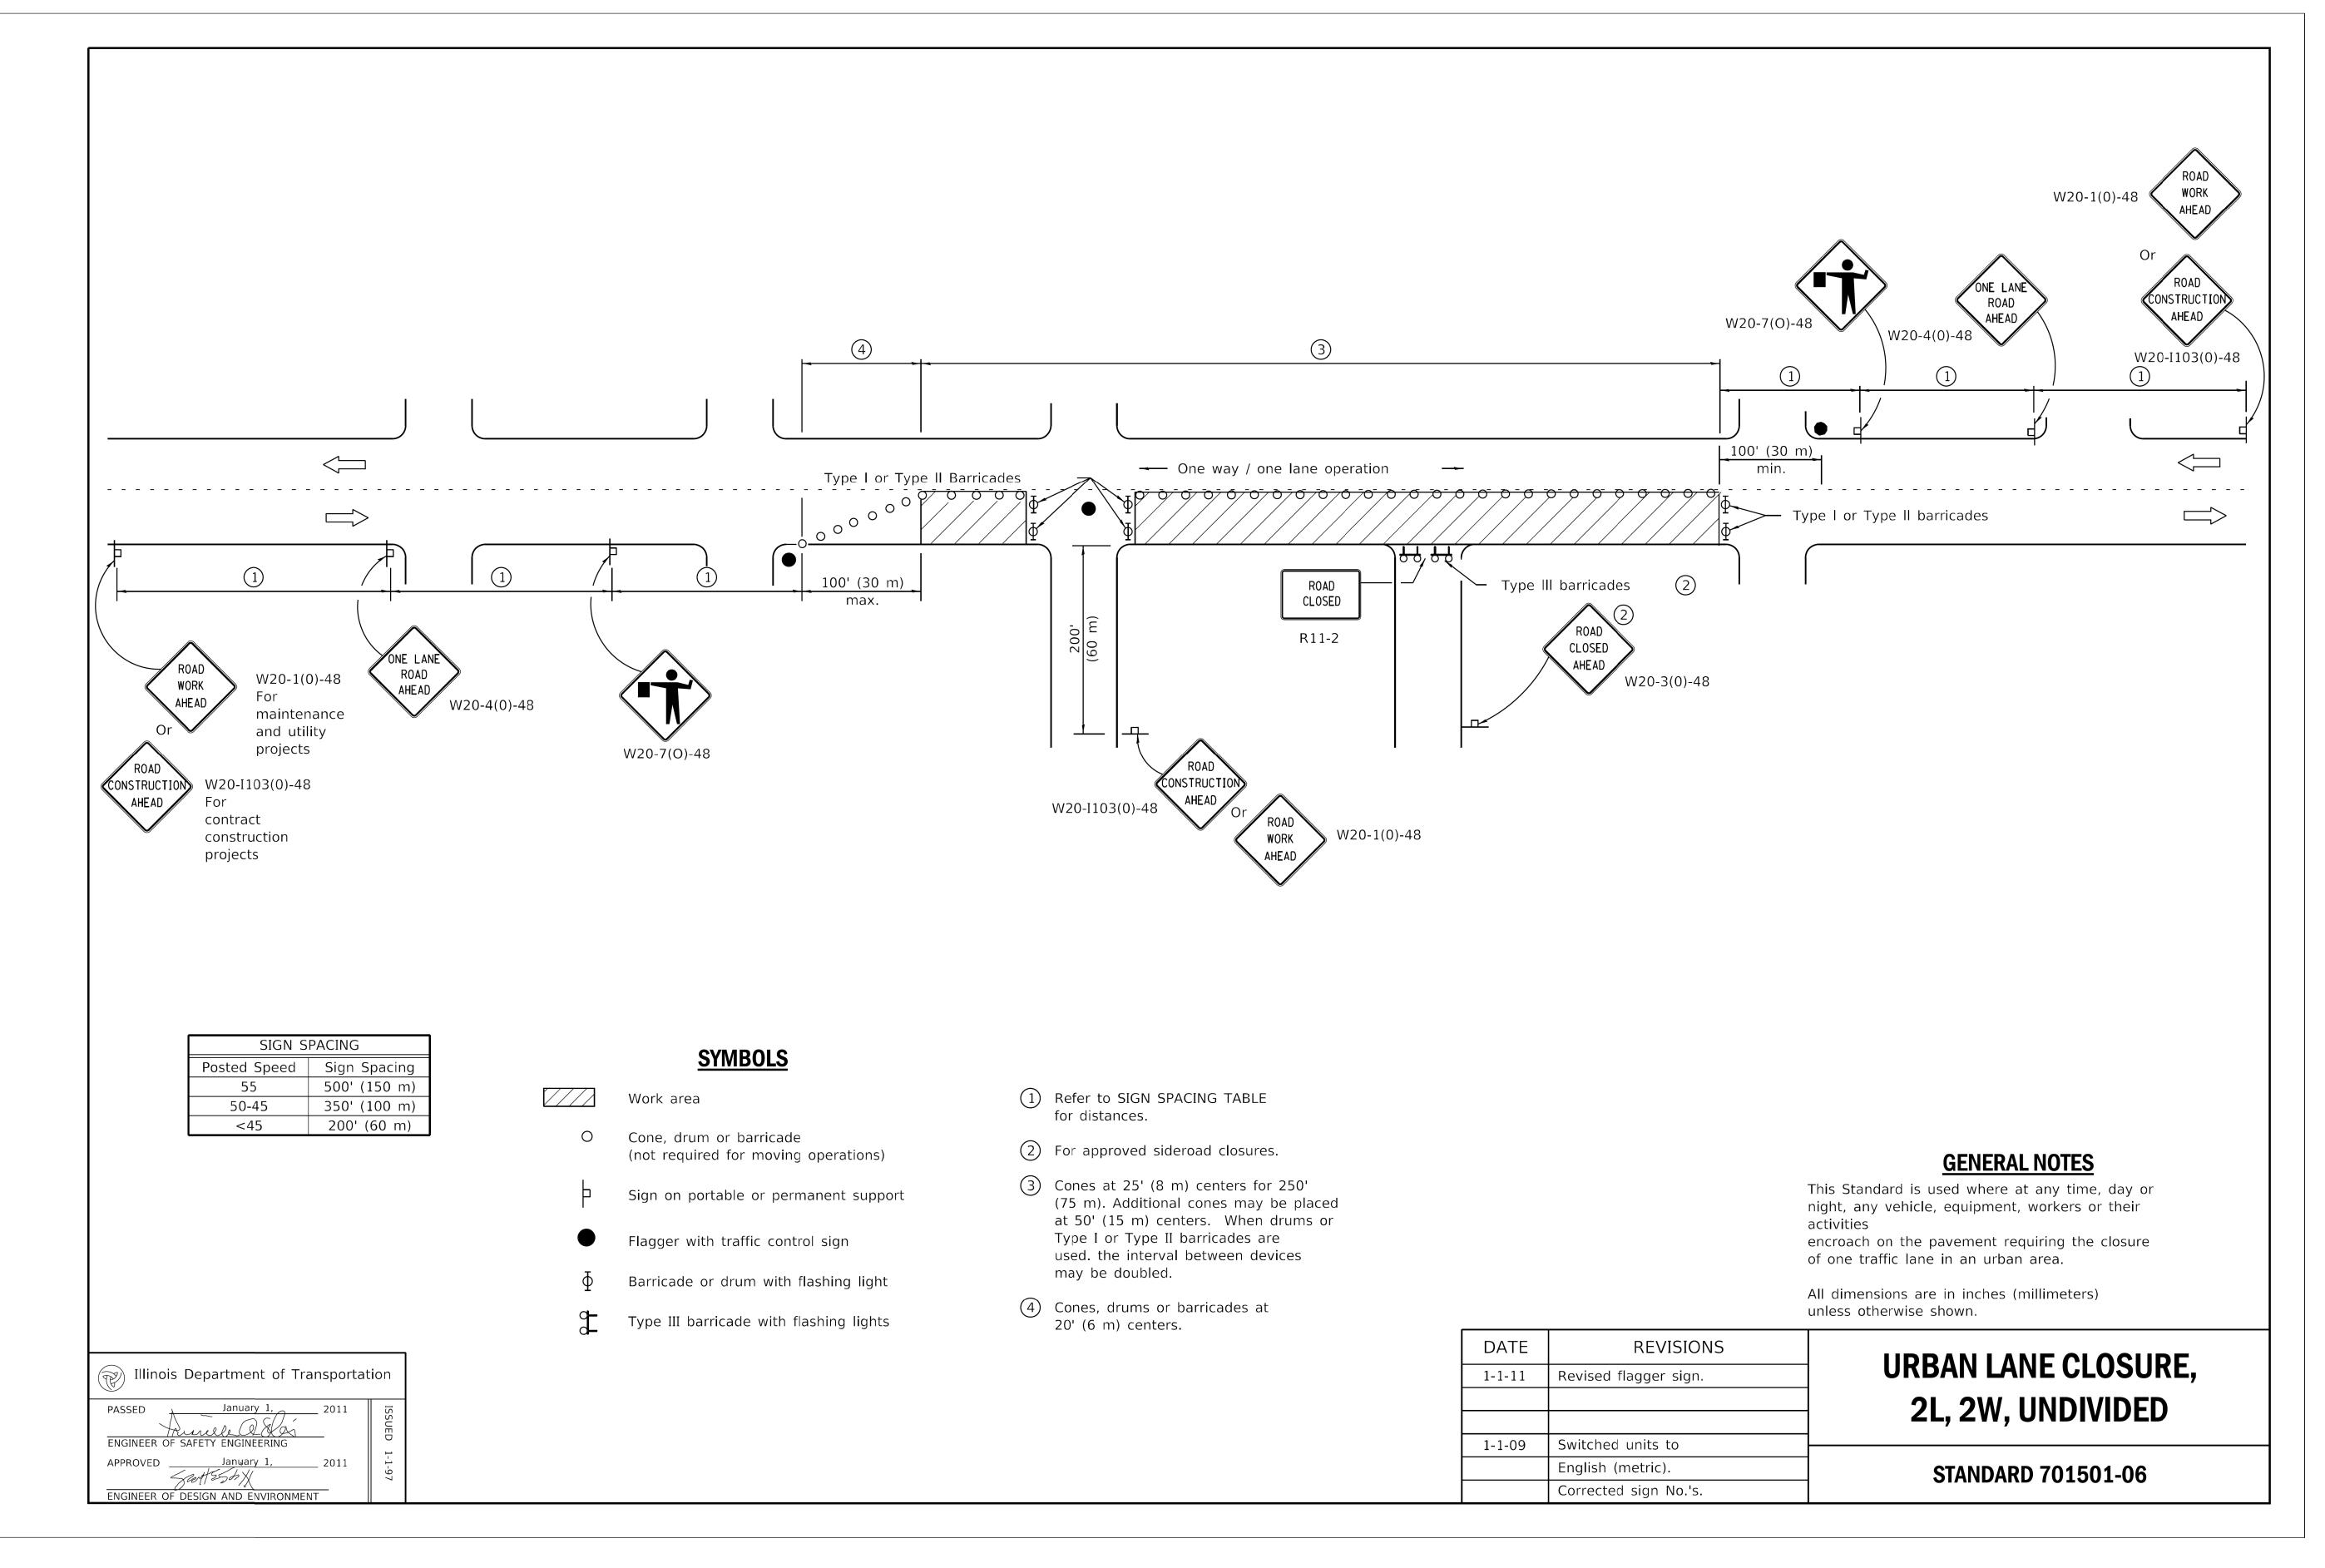




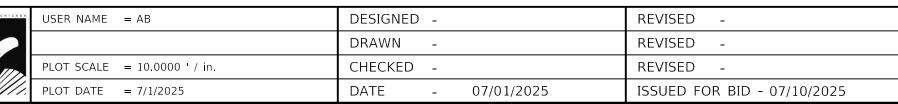


CITY OF CHICAGO
DEPARTMENT OF TRANSPORTATION
24th WARD

IDOT STANDARD DETAILS
PBC PROJECT NO # 22922
W. 16TH STREET - W. OGDEN AVENUE
S. CENTRAL PARK AVENUE - S. DRAKE AVENUE

	OUC NUMBER	COUNTY	TOTAL SHEETS	SHEET NO.
	OUC IR #124701	COOK	26	24
STA.	TO STA.	SCALE: NT	S	

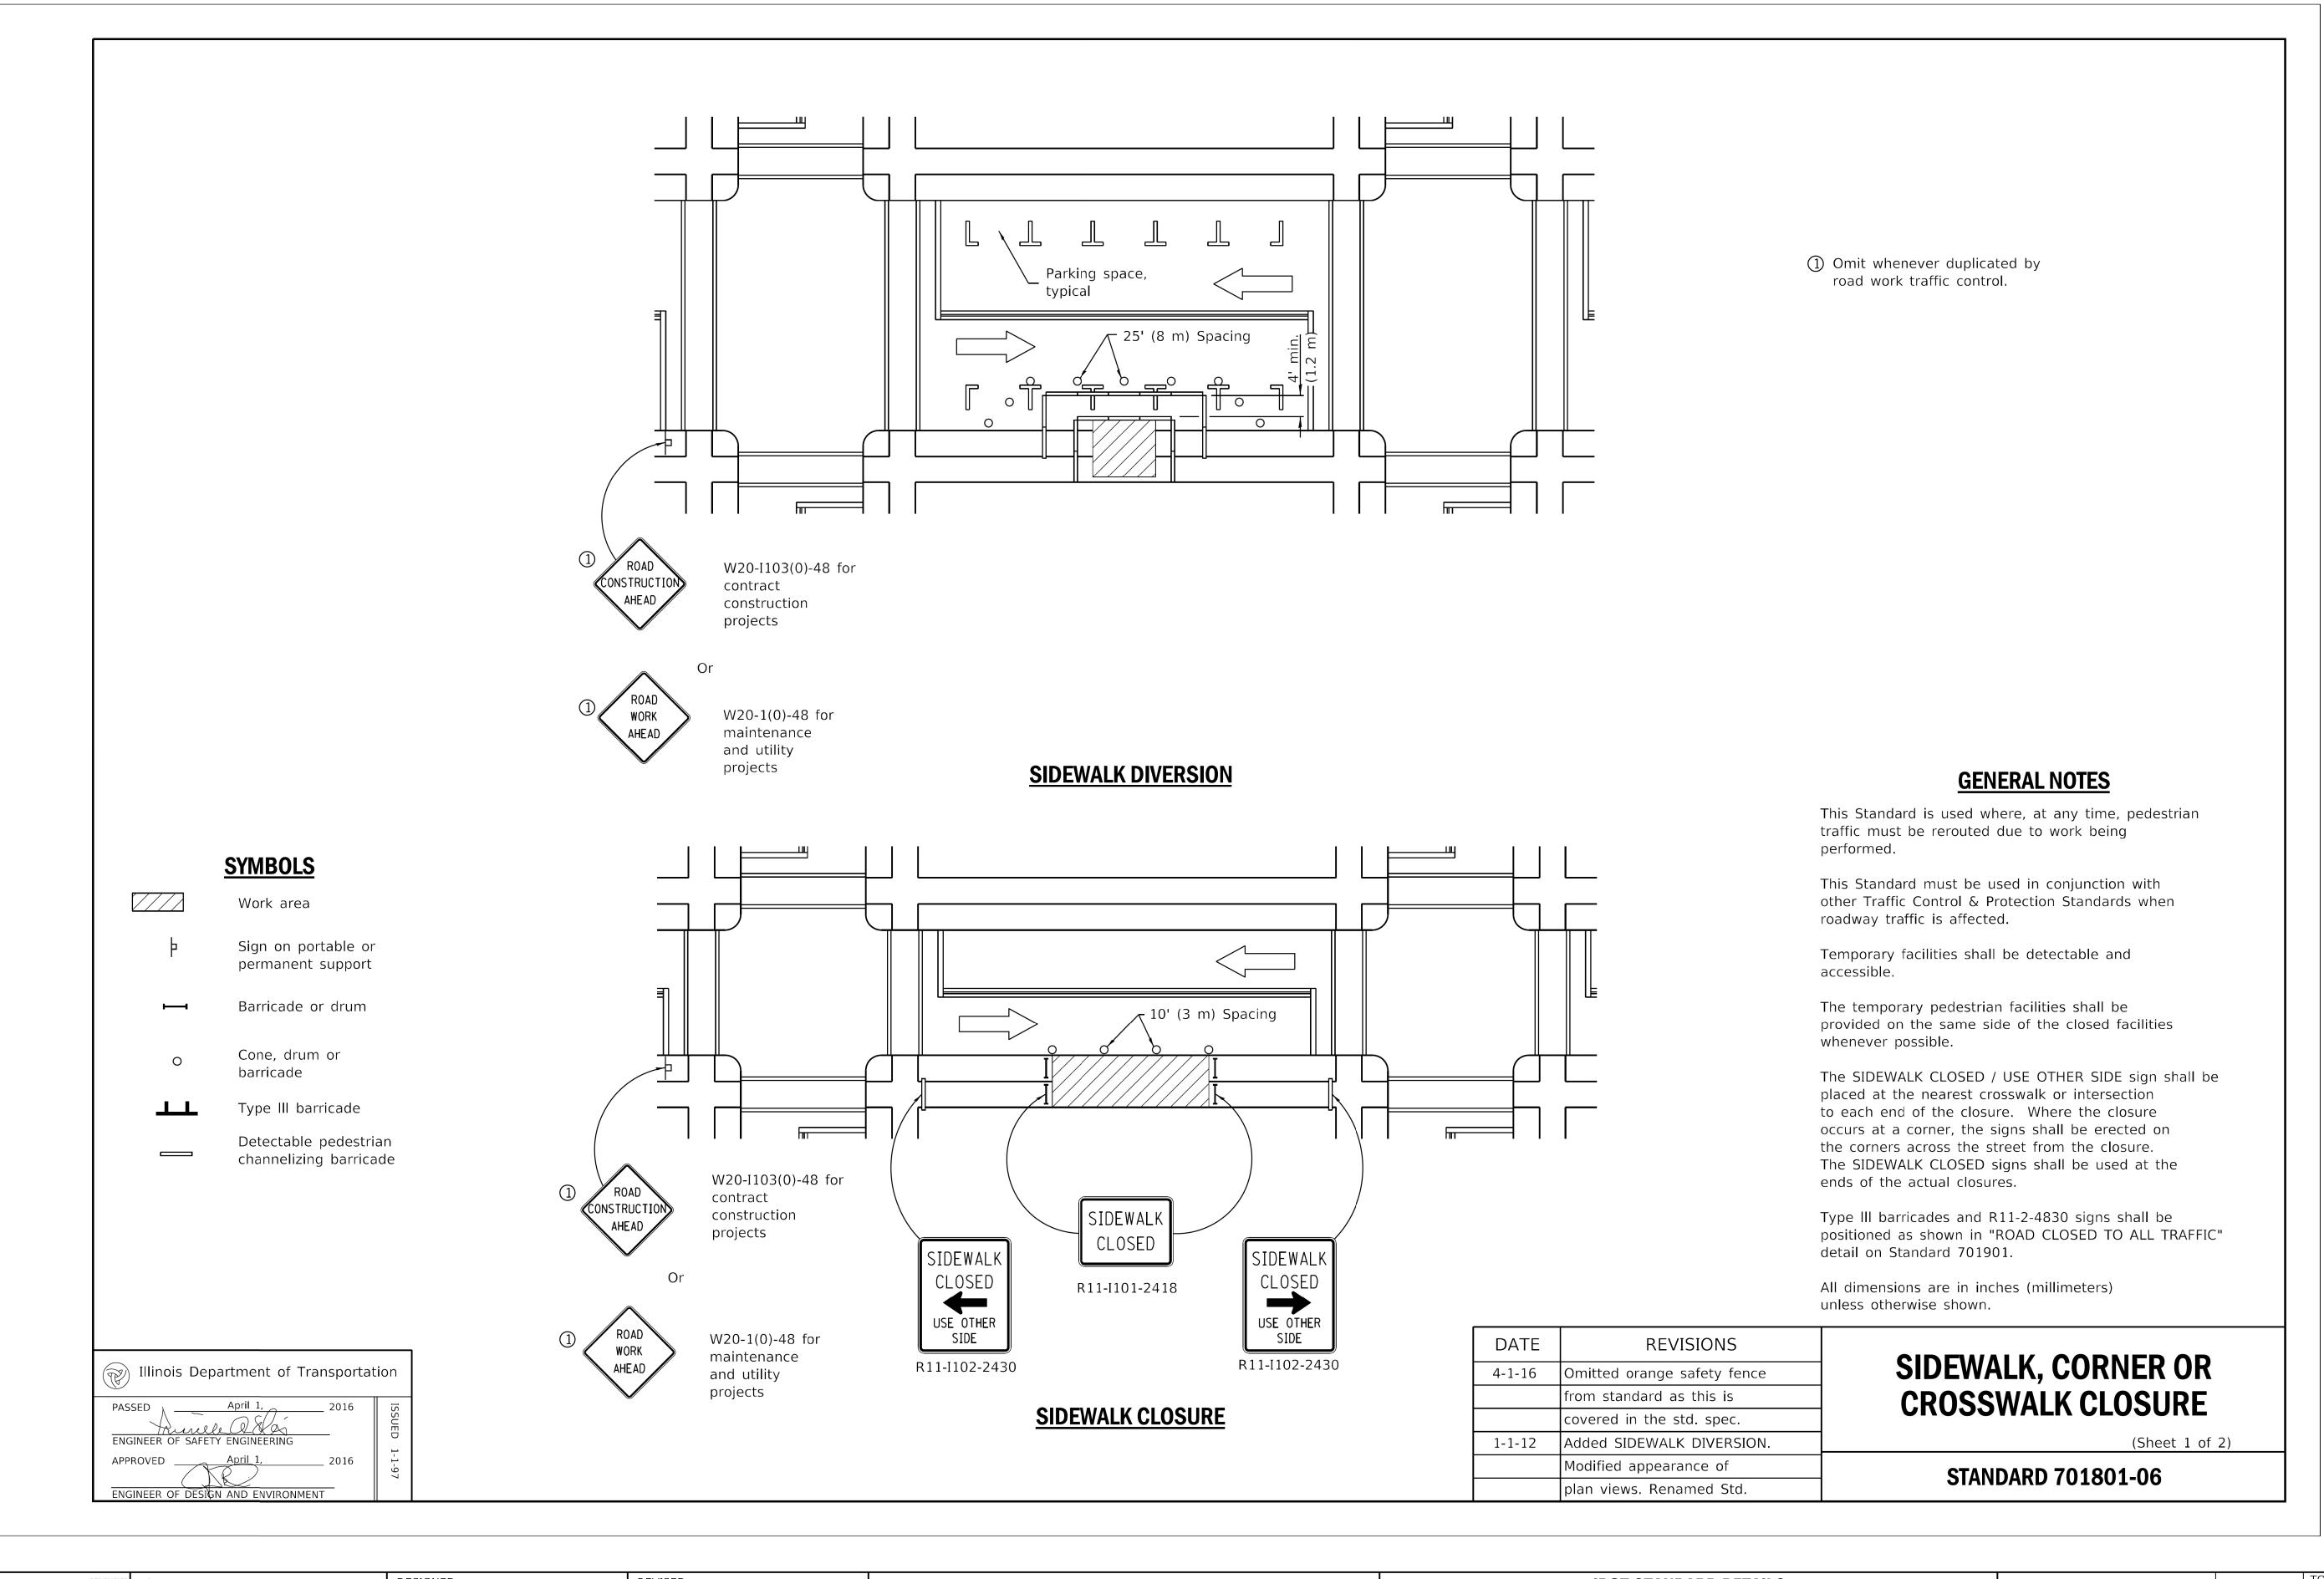




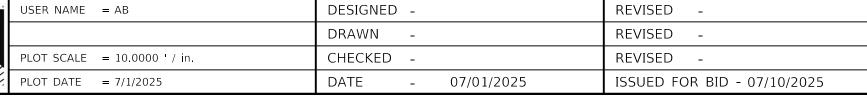

CITY OF CHICAGO
DEPARTMENT OF TRANSPORTATION
24th WARD

IDOT STANDARD DETAILS
PBC PROJECT NO # 22922
W. 16TH STREET - W. OGDEN AVENUE
S. CENTRAL PARK AVENUE - S. DRAKE AVENUE

OUC NUMBER		COUNTY	TOTAL SHEETS	SHEET NO.
	OUC IR #124701	COOK	26	25
STA.	TO STA.	SCALE: NT	NTS	

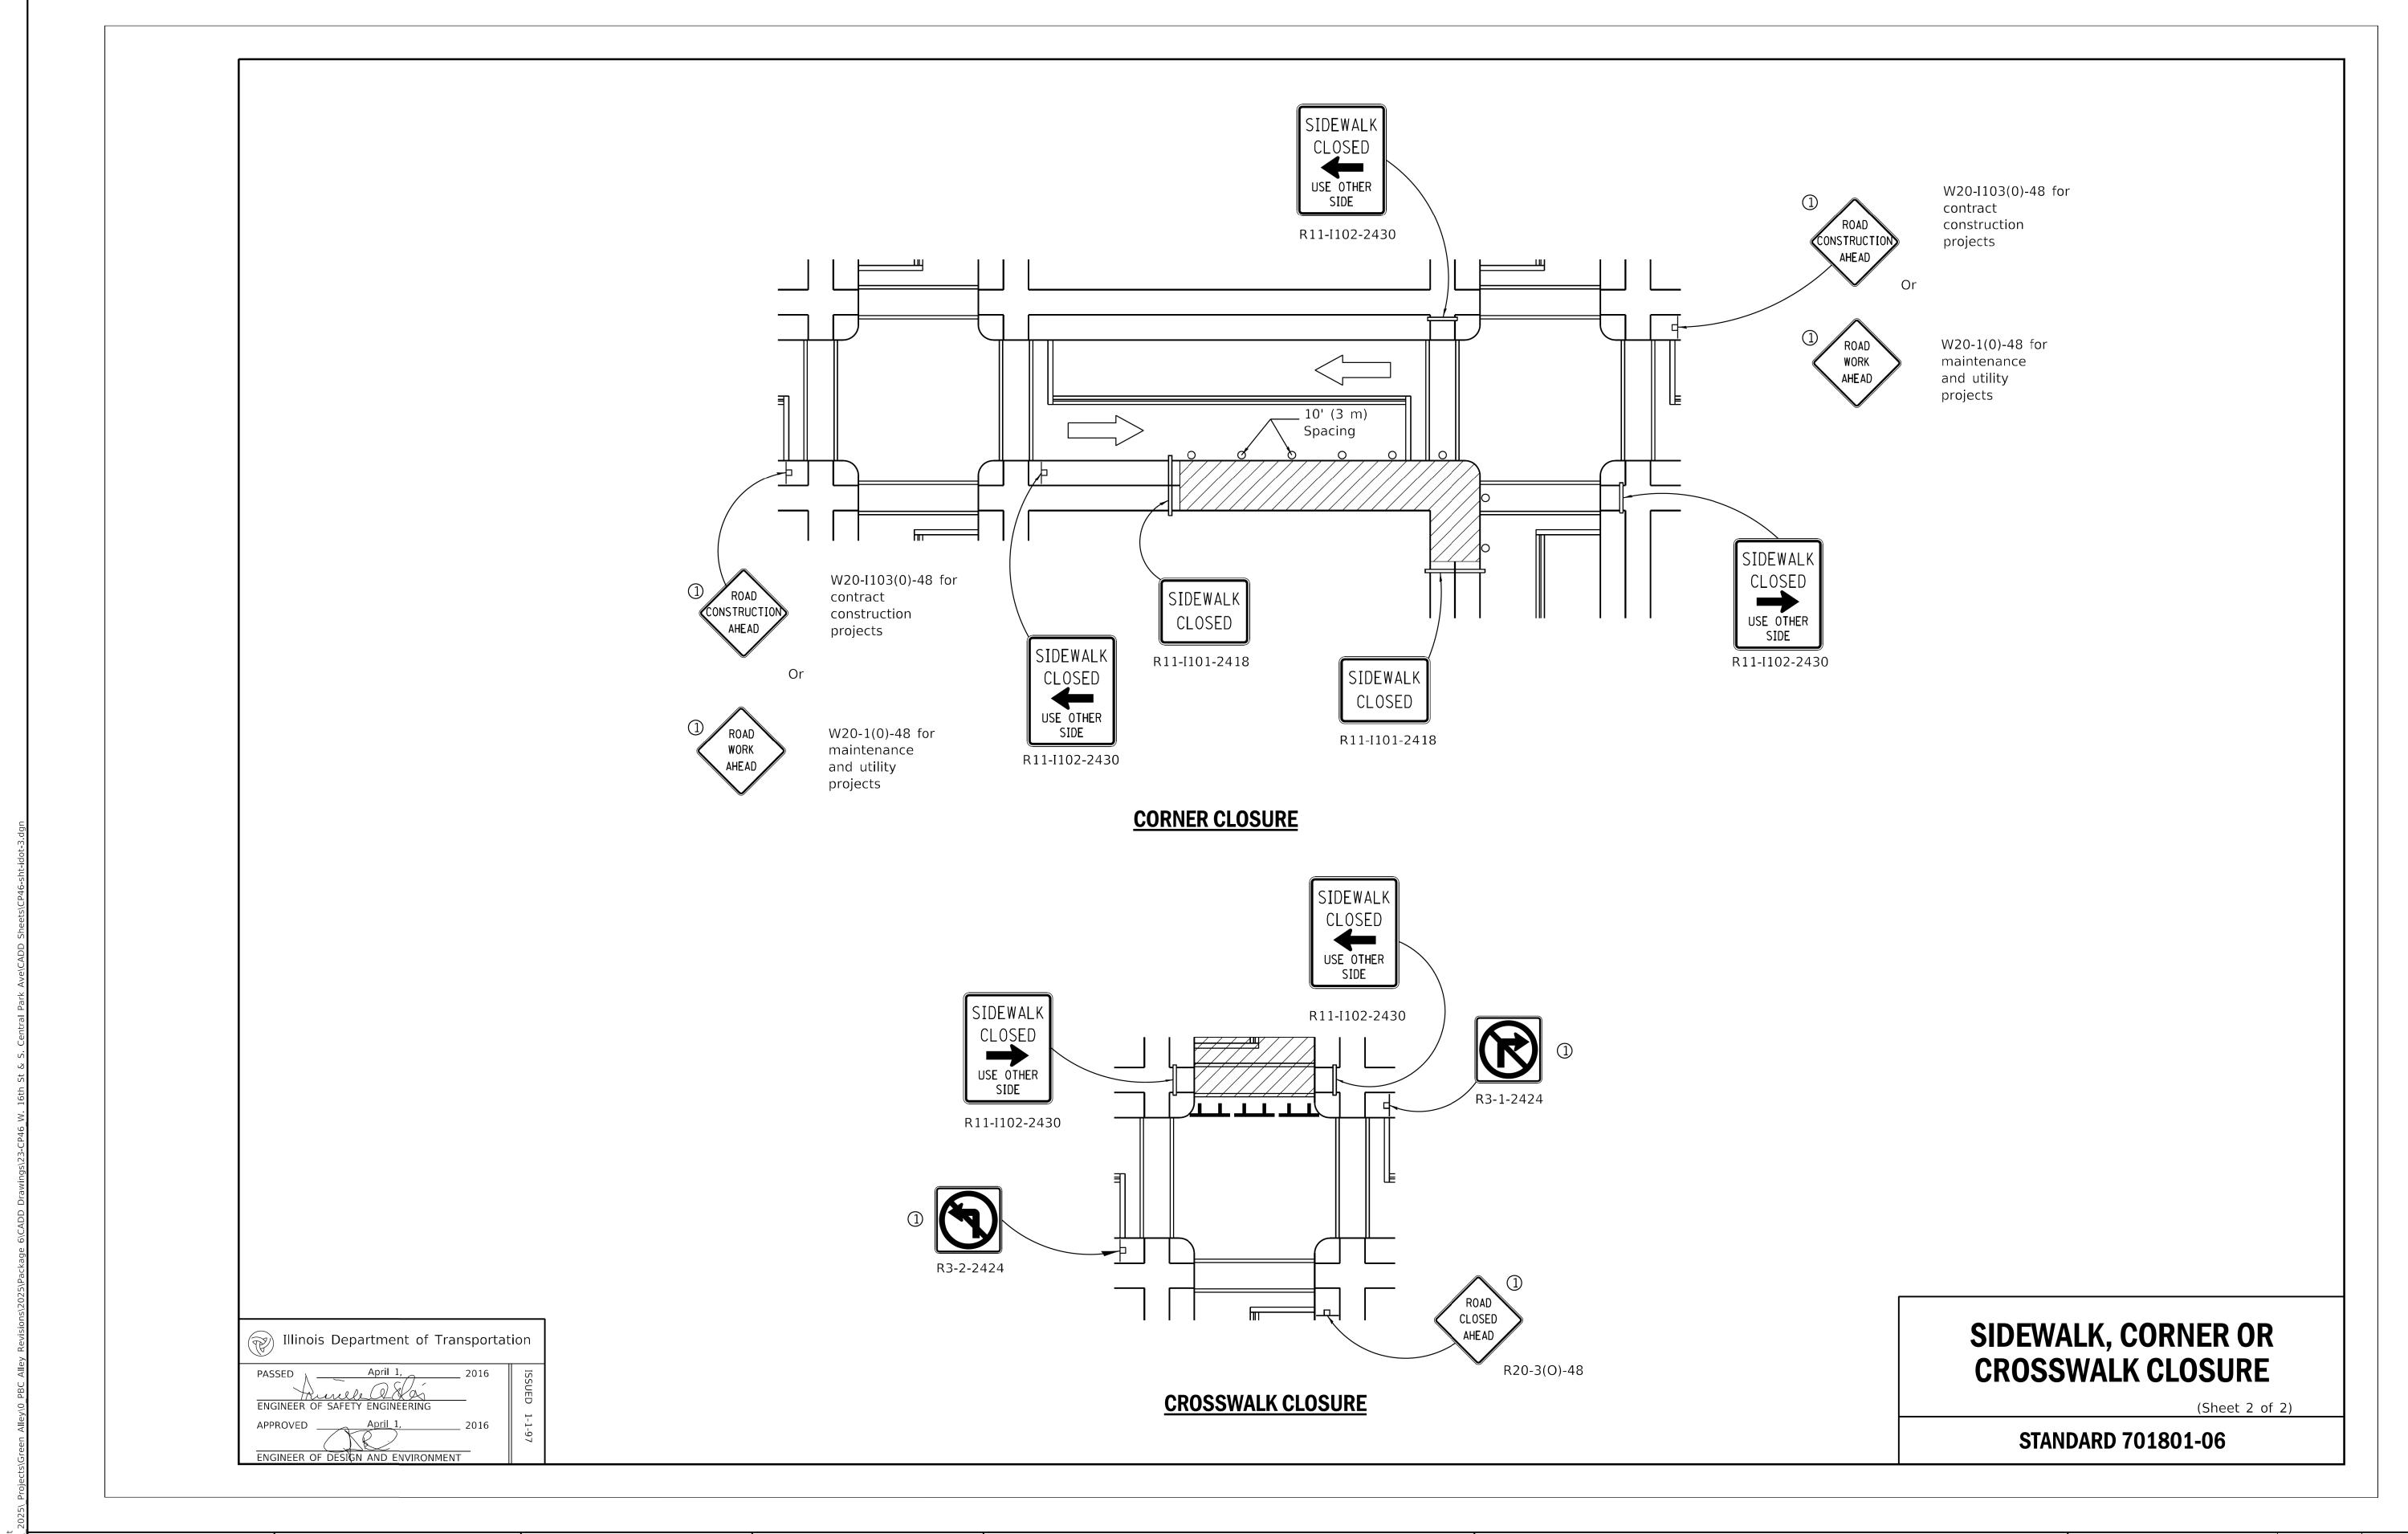

\*CDOT

 USER NAME
 = AB
 DESIGNED
 REVISED

 PLOT SCALE
 = 10.0000 ' / in.
 CHECKED
 REVISED

 PLOT DATE
 = 7/1/2025
 DATE
 07/01/2025
 ISSUED FOR BID - 07/10/2025

CITY OF CHICAGO DEPARTMENT OF TRANSPORTATION 24th WARD IDOT STANDARD DETAILS
PBC PROJECT NO # 22922
W. 16TH STREET - W. OGDEN AVENUE
S. CENTRAL PARK AVENUE - S. DRAKE AVENUE

OUC NUMBER

COUNTY

TOTAL SHEET NO.

OUC IR #124701

COOK

26

STA.

TO STA.

SCALE: NTS